

ARCHITECTURE SANTA BARBARA To: Mountain Village Design Review Board and Planning Staff Date: 10/05/2021

Thank you so much for reviewing our application for Lot 7 Stonegate Drive. We are excited about the coming project and have outlined compliance below. The house is a two and a half story residence with a total of 4,285SQ FT livable area and a 584 SQ FT garage.

17.3.12 Building Height Limits- The total height of the highest roof ridge is 32'-3"" as shown on A3.0 Detail 3_North Elevation. The allowable offset of 40' for gable roofs is shown on each elevation for reference.

17.3.13 Maximum Lot Coverage- The Gross Area of the Lot is 15,289.62 SQ FT. Our proposed lot coverage is 3,952 SQ FT which equates to 25.8%. Allowable is 40% making our proposal 14.2% below the allowable coverage.

17.3.14 General Easements Setbacks- The lot has a 16' General Easement/Setback line offset from the property line. Our proposed setbacks are 16'-7 1/4" from the Western property line, 37'-10" from the Northern property line, 16'-10 3/4" from the Eastern property line and 31'-1 1/2" from the Southern property line.

17.3.21 Deviation from Zoning and Land Use Regulations- Due to the step nature of the lot and the house having to abut the road we are forced into shorter driveway out to our access drive. We have accommodated a hammerhead turnaround that is shared between all lots on the access road but we do not have enough room for the two exterior parking spaces in addition to the garage. We are requesting to eliminate the (2) exterior parking spaces outside of the garage on the site. Parking is limited but we do have approx. 15'-10" on our "garage bridge" to accommodate cars on a temporary basis.

17.5.4 Town Design Theme

Our proposed design is Mountain Modern in intent and nature. The siding will be a combination of stained wood to match the

Mountain Village design aesthetic with exposed timber and mill scale steel accents. The mid level of the project will be wrapped in bonderized metal shingle and bonderized corrugated siding. Stone surrounds the entire base of the house and clearly differentiates foundation from wall plane. This grounds the house into the topography of the site and allows for a mix of materials and compliance with the exterior stone requirement. The garage doors will be herringbone wood with windows above. The roofs will be a combination of corrugated metal and standing seam metal. Please see sheet A3.3 for exterior material sheet with all finishes and intended colors called out.

17.5.5 Building Siting Design- The house is located on a steep lot that is downhill from the existing access road. The step nature of the lot dictates a horizontal configuration that steps down the slope. The East/West long axis of the lot provides the access to the garage, entry door and living/dining level.

17.5.6 Building Design- Our design is a simple configuration of gable roofs that step down the slope side following the natural topography of the site. We have not created any complicated roof forms or valleys that will require maintenance. This is an elegant composition of forms and elevations that fit in well with the Town of Mountain Village and similar step lot designs.

17.5.7 Grading and Drainage Design- Please see the Civil Sheets in the set C1-C4. David Ballode with Uncompanying Engineering has created our drainage and grading plan. You will note that we are staying appropriately away from the existing retaining wall that currently supports the existing road. We are providing drainage around the base of the house between the existing wall and the new foundation with a swale routed to the East and West easement areas.

17.5.8 Parking Regulations- The house has a compliant two car garage. There is an existing hammerhead to the East of the house that spans both Lot 7 and Lot 8. See above 17.3.21 for our request to eliminate the (2) on site exterior parking spaces. Due to the step nature of the lot and the narrow access road we cannot accommodate the two exterior parking spaces.

17.5.9 Landscape Regulations- Please see sheet A1.3. The landscape area outside of Zone 1 is very limited. There are several existing aspen and spruce that we would like to keep on site. Within Zone 1 on the step slope landscaping will be mostly grasses and the one planter area located to the North of the lower viewing deck. The intent is to re-seed and re-vegetate with Telski Wildflower Grass Seed Mix with a combination of Native Grass Seed mix and a Wetlands Buffer mix. See the description of the grass mix on our landscape plan for details of the mix design.

17.5.10 Trash, Recycling and General Storage Areas- Trash Cans will be located in the trash/mech room at the front of the lot adjacent to the entry and taken out to the curb on a weekly basis. All storage will be contained within the house.

17.5.11 Utilities- See sheet C3 for all utility locations on the site and existing electrical, water, gas and sewer lines. The intent is to have all utility connections come into the house at the road side mechanical room where it will be distributed within the house.

17.5.12 Lighting Regulations- Please see sheet A1.4 for our exterior lighting plan. Each fixture is dark sky compliant and simple and minimal on the house. There are (3) sconce lights at the garage, (2) step lights at entry, (1) sconce at entry, (4) baluster lights at living room deck, (4) step lights at upper living room deck, (3) recessed cans at the guest bedroom deck, (4) step lights on the guest bedroom deck, (2) step lights at the ski room deck, (1) sconce at the hot tub lower deck, and (3) step lights at the lower hot tub deck.

Please let me know any questions and we really appreciate your time in reviewing our drawings and application.

Dylan Henderson CO Lic#: ARC.0402941 970.708.4795











VERTICAL STAINED CEDAR SIDING



EXTERIOR TIMBERS AT ROOFLINE AND TRUSS







EXTERIOR DECK RAIL- COLOR TBD







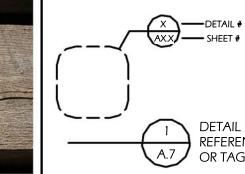


SHEET #	4
DETAIL REFERENCE OR TAG	Ref -

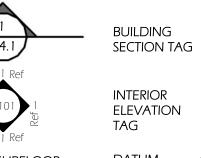

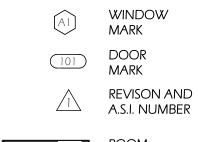


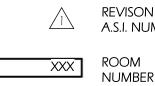



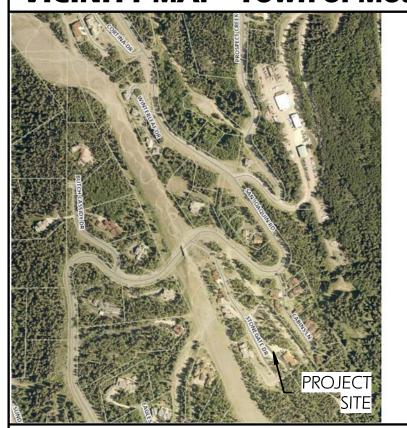

EXISTING SITE IMAGES

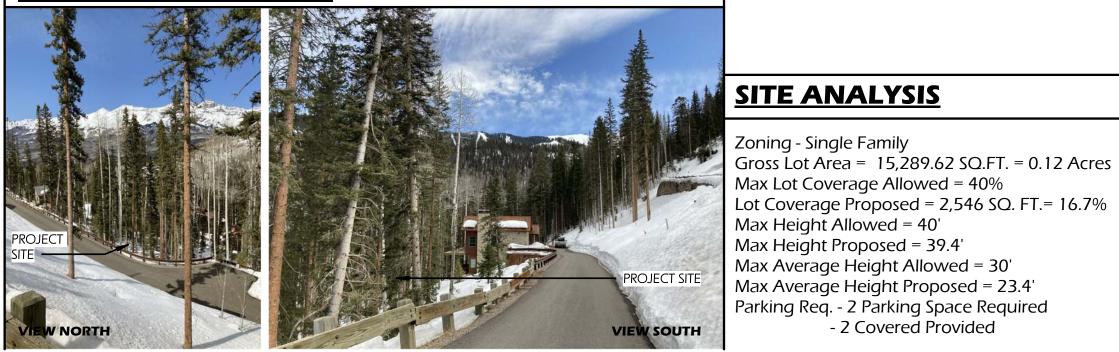

Sheet Number	Sheet Name	Sheet Issue Date
A 0.0	Cover Sheet & Plan Set Information	10/08/2021
A 0.1	Building Perspectives	10/08/2021
A 1.1	Survey	10/08/2021
A 1.2	Site Plan	10/08/2021
A 1.3	Landscape	10/08/2021
A 1.4	Exterior Lighting Plan	10/08/2021
A 2.1	Entry Level Floor Plan	10/08/2021
A 2.2	Master Level & Ski Level Floor Plan	10/08/2021
A 2.3	Roof Plan	10/08/2021
A 3.0	Average Height & Exterior Material Compliance	10/08/2021
A 3.1	Elevations	10/08/2021
A 3.2	Elevations	10/08/2021
A 3.3	Exterior Materials Board	10/11/21
A 8.1	Door & Window Schedule	10/08/2021
C1	Notes	08/11/2021
C2	Grading & Drainage Plan	08/11/2021
C3	Utilities	08/11/2021
C4	Construction Mitigation Plan	08/11/2021

- 2 Covered Provided

GENERAL NOTES & BEST MANAGEMENT PRACTICES:

Revision

SCOPE OF WORK

ROPOSAL TO CONSTRUCT A 4,285 SQ FT SINGLE

AMILY HOME WITH AN ATTACHED 584.33 SQ FT

GARAGE AT THE ENTRY LEVEL ON A 15,289.62 SQ

T LOT. THE HOME TO CONTAIN 3 BEDROOMS, 1

BUNK ROOM, 1 MEDIA ROOM, 4 1/2 BATHS AND 1

KI/MUD ROOM. THREE LOWER DECKS (341 SQ FT

87 SO FT, 151 SO FT) AND 397 SO FT LOWER PATIO

O BE INCLUDED IN THE APPLICATION. A 462 SQ FT

NTRY BRIDGE AND DRIVEWAY BRIDGE TO BE

INCLUDED TO BE USED FOR ACCESS OVER THE Existing retaining wall. Total site coverage

IS 3,952 SQ FT (ALLOWABLE = 6,115.9 SQ FT)

Sheet Issue Current

urrent	GENERAL NOTES
evision	CONTRACT DOCU
Date	CONTRACT DOCU CONTRACT DOCU

CT DOCUMENTS:

CT DOCUMENTS CONSIST OF THE AGREEMENT, GENERAL CONDITIONS, SPECIFICATIONS, AND DRAWINGS, WHICH ARE COOPERATIVE AND CONTINUOUS. WORK INDICATED OR REASONABLY IMPLIED IN ANY ONE OF THE DOCUMENTS SHALL BE SUPPLIED AS THOUGH FULLY COVERED IN ALL. ANY DISCREPANCIES BETWEEN THE PARTS SHALL BE REPORTED TO THE ARCHITECT PRIOR TO COMMENCEMENT OF WORK.

THESE DRAWINGS ARE PART OF THE CONTRACT DOCUMENTS FOR THIS PROJECT. THESE DRAWINGS ARE THE GRAPHIC ILLUSTRATION OF THE WORK TO BE ACCOMPLISHED.

ORGANIZATION:

THE DRAWINGS FOLLOW A LOGICAL, INTERDISCIPLINARY FORMAT: ARCHITECTURAL DRAWINGS (A SHEETS), INTERIOR DRAWINGS (A10 SHEETS), STRUCTURAL DRAWINGS (S SHEETS), MECHANICAL AND PLUMBING DRAWINGS (M & P SHEETS), & ELECTRICAL (E SHEETS). THESE DRAWINGS ARE ORGANIZED BY BUILDING UNIT.

CODE COMPLIANCE:

ALL WORK, MATERIALS, AND ASSEMBLIES SHALL COMPLY WITH APPLICABLE STATE AND LOCAL CODES, ORDINANCES, AND REGULATIONS. THE CONTRACTOR, SUBCONTRACTORS AND JOURNEYMEN OF THE APPROPRIATE TRADES SHALL PERFORM WORK TO THE HIGHEST STANDARDS OF CRAFTSMANSHIP.

INTENT:

THESE DOCUMENTS ARE INTENDED TO INCLUDE ALL LABOR, MATERIALS, EQUIPMENT AND SERVICES REQUIRED TO COMPLETE THE WORK DESCRIBED HEREIN.

COORDINATION:

THE CONTRACTOR SHALL CAREFULLY STUDY AND COMPARE THE DOCUMENTS, VERIFY THE ACTUAL CONDITIONS, AND REPORT ANY DISCREPANCIES, ERRORS, OR OMISSIONS TO THE ARCHITECT IN A TIMELY MANNER. THE ARCHITECT SHALL CLARIFY OR PROVIDE REASONABLE ADDITIONAL INFORMATION REQUIRED FOR SUCCESSFUL EXECUTION. THE CONTRACTOR SHALL VERIFY AND COORDINATE ALL OPENINGS THROUGH FLOORS, CEILINGS AND WALLS WITH ALL Architectural, interior, structural, mechanical and plumbing, electrical, and lighting drawings.

SHOWER COMPARTMENT WALLS:

SHOWER COMPARTMENTS AND WALLS ABOVE BATHTUBS WITH INSTALLED SHOWER HEADS SHALL BE FINISHED WITH A SMOOTH, NONABSORBENT SURFACE TO A HEIGHT NOT LESS THAN 70 INCHES ABOVE THE DRAIN INLET. BUILT-IN TUBS WITH SHOWERS SHALL HAVE WATERPROOF JOINTS BETWEEN THE TUB AND ADJACENT WALL.

WALL AND CEILING FINISHES:

INTERIOR WALL AND CEILING FINISHES SHALL BE CLASSIFIED IN ACCORDANCE WITH ASTM E 84. SUCH INTERIOR FINISH MATERIALS SHALL BE GROUPED IN THE FOLLOWING CLASSES IN ACCORDANCE WITH THEIR FLAME SPREAD AND SMOKE-DEVELOPED INDEXES:

· CLASS A: FLAME SPREAD 0-25; SMOKE-DEVELOPED 0-450.

CLASS B: FLAME SPREAD 26-75; SMOKE-DEVELOPED 0-450. · CLASS C: FLAME SPREAD 76-200; SMOKE-DEVELOPED 0-450.

ALL INTERIOR FINISH MATERIALS OTHER THAN TEXTILES SHALL HAVE A CLASS C RATING.

TEXTILE WALL COVERINGS SHALL HAVE A CLASS A FLAME SPREAD INDEX IN ACCORDANCE WITH ASTM E 84 AND BE PROTECTED BY AUTOMATIC SPRINKLERS.)

SEE RCP SERIES FOR CEILING, SOFFIT, BEAM AND COFFER HEIGHTS.

ABBREVIATIONS USED IN SET: =Above Finish Flooring U.N.O. =Unless Noted Otherwise

=Top Of Finish Flooring T.O.F.F. =To Be Determined / To Be Designed

=Existing

PROJECT TEAM

SALT ARCHITECTURE SANTA BARBARA, CA

701 ANACAPASTREET 805.729.4276

PROPERTY OWNER

13520 Hesby Street Sherman Oaks, CA 91423

ARCHITECT

Architect: Dylan Henderson Associate Architect: Brian Flatley 701 Anacapa Street Santa Barbara, CA 93101 Office: 805.729.4276 Cell: 970.708.4795 e-mail: dylan@saltarchitect.co

SURVEYOR

102 Society Drive Telluride, CO 81435 Office: 970-728-1128

STRUCTURAL ENG.

MECHANICAL ENG.

PROJECT DESCRIPTION

4 Level - 4 Bedroom, 4 Full Bath, 1 Powder

PROJECT ZONING

Zoning District - Single Family Residence - 2018 IRC Occ. Class R-3

PROJECT LEGAL DESCRIPTION

Town of Mountain Village, CO 81435

Lot 166AR2-7 Stonegate 6 Stonegate Drive

No.	Drawing Set Description	Issued Date
1	IASR Review	10/08/2021
ż		
3		


Date Description

Lot 7

STONEGATE

Cover Sheet & Plan Set Information

Date:	10/08/2021
Drawn by:	DH/BF
Checked by:	DH / BE

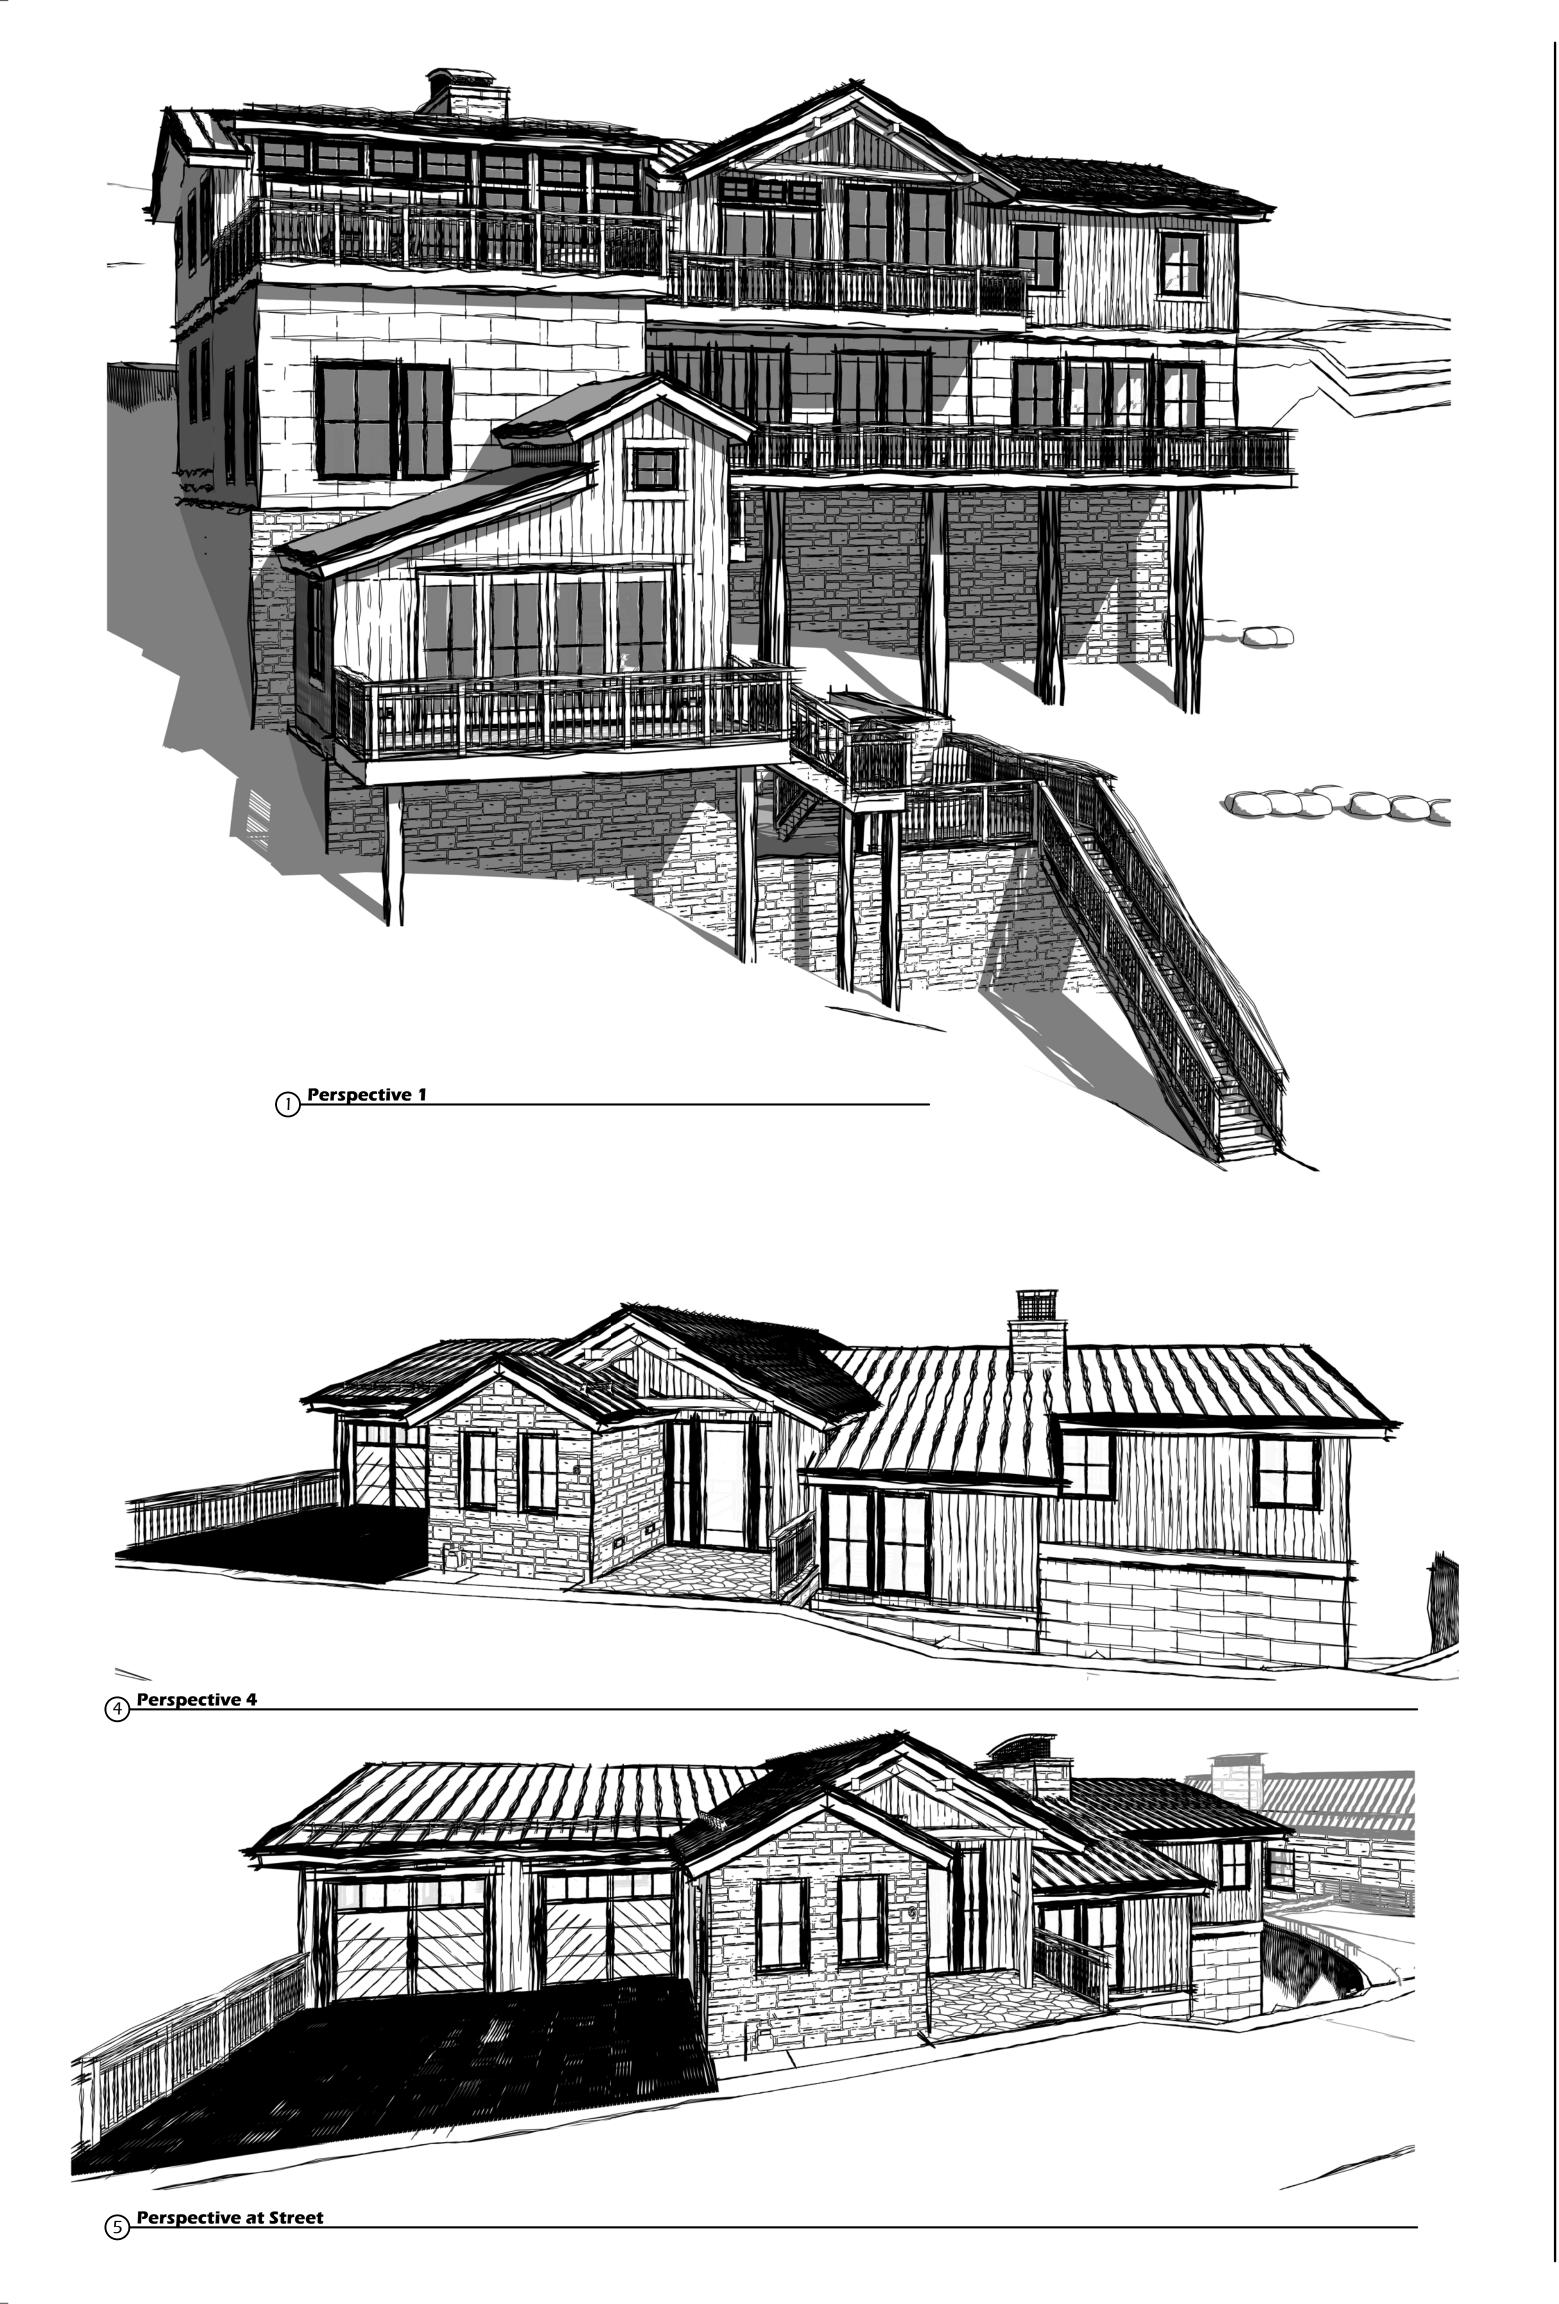







PROJECT TEAM

PROPERTY OWNER

Steven Rosenberg 13520 Hesby Street Sherman Oaks, CA 91423

ARCHITECT

Architect: Dylan Henderson Associate Architect: Brian Flatley 701 Anacapa Street Santa Barbara, CA 93101 Office: 805.729.4276 Cell: 970.708.4795 e-mail: dylan@saltarchitect.com

SURVEYOR San Juan Surveying 102 Society Drive Telluride, CO 81435 Office: 970-728-1128

STRUCTURAL ENG.

MECHANICAL ENG.

PROJECT DESCRIPTION

4 Level - 4 Bedroom, 4 Full Bath, 1 Powder

PROJECT ZONING

Zoning District - Single Family Residence - 2018 IRC Occ. Class R-3

PROJECT LEGAL DESCRIPTION

Lot 166AR2-7 Stonegate 6 Stonegate Drive Town of Mountain Village, CO 81435

1	Description	Date
	IASR Review	10/08/2021

Date Description


Lot 7


STONEGATE

Building Perspectives

Date:	10/08/2021
Drawn by:	DH / BF
Checked by:	DH / BF

A0.1

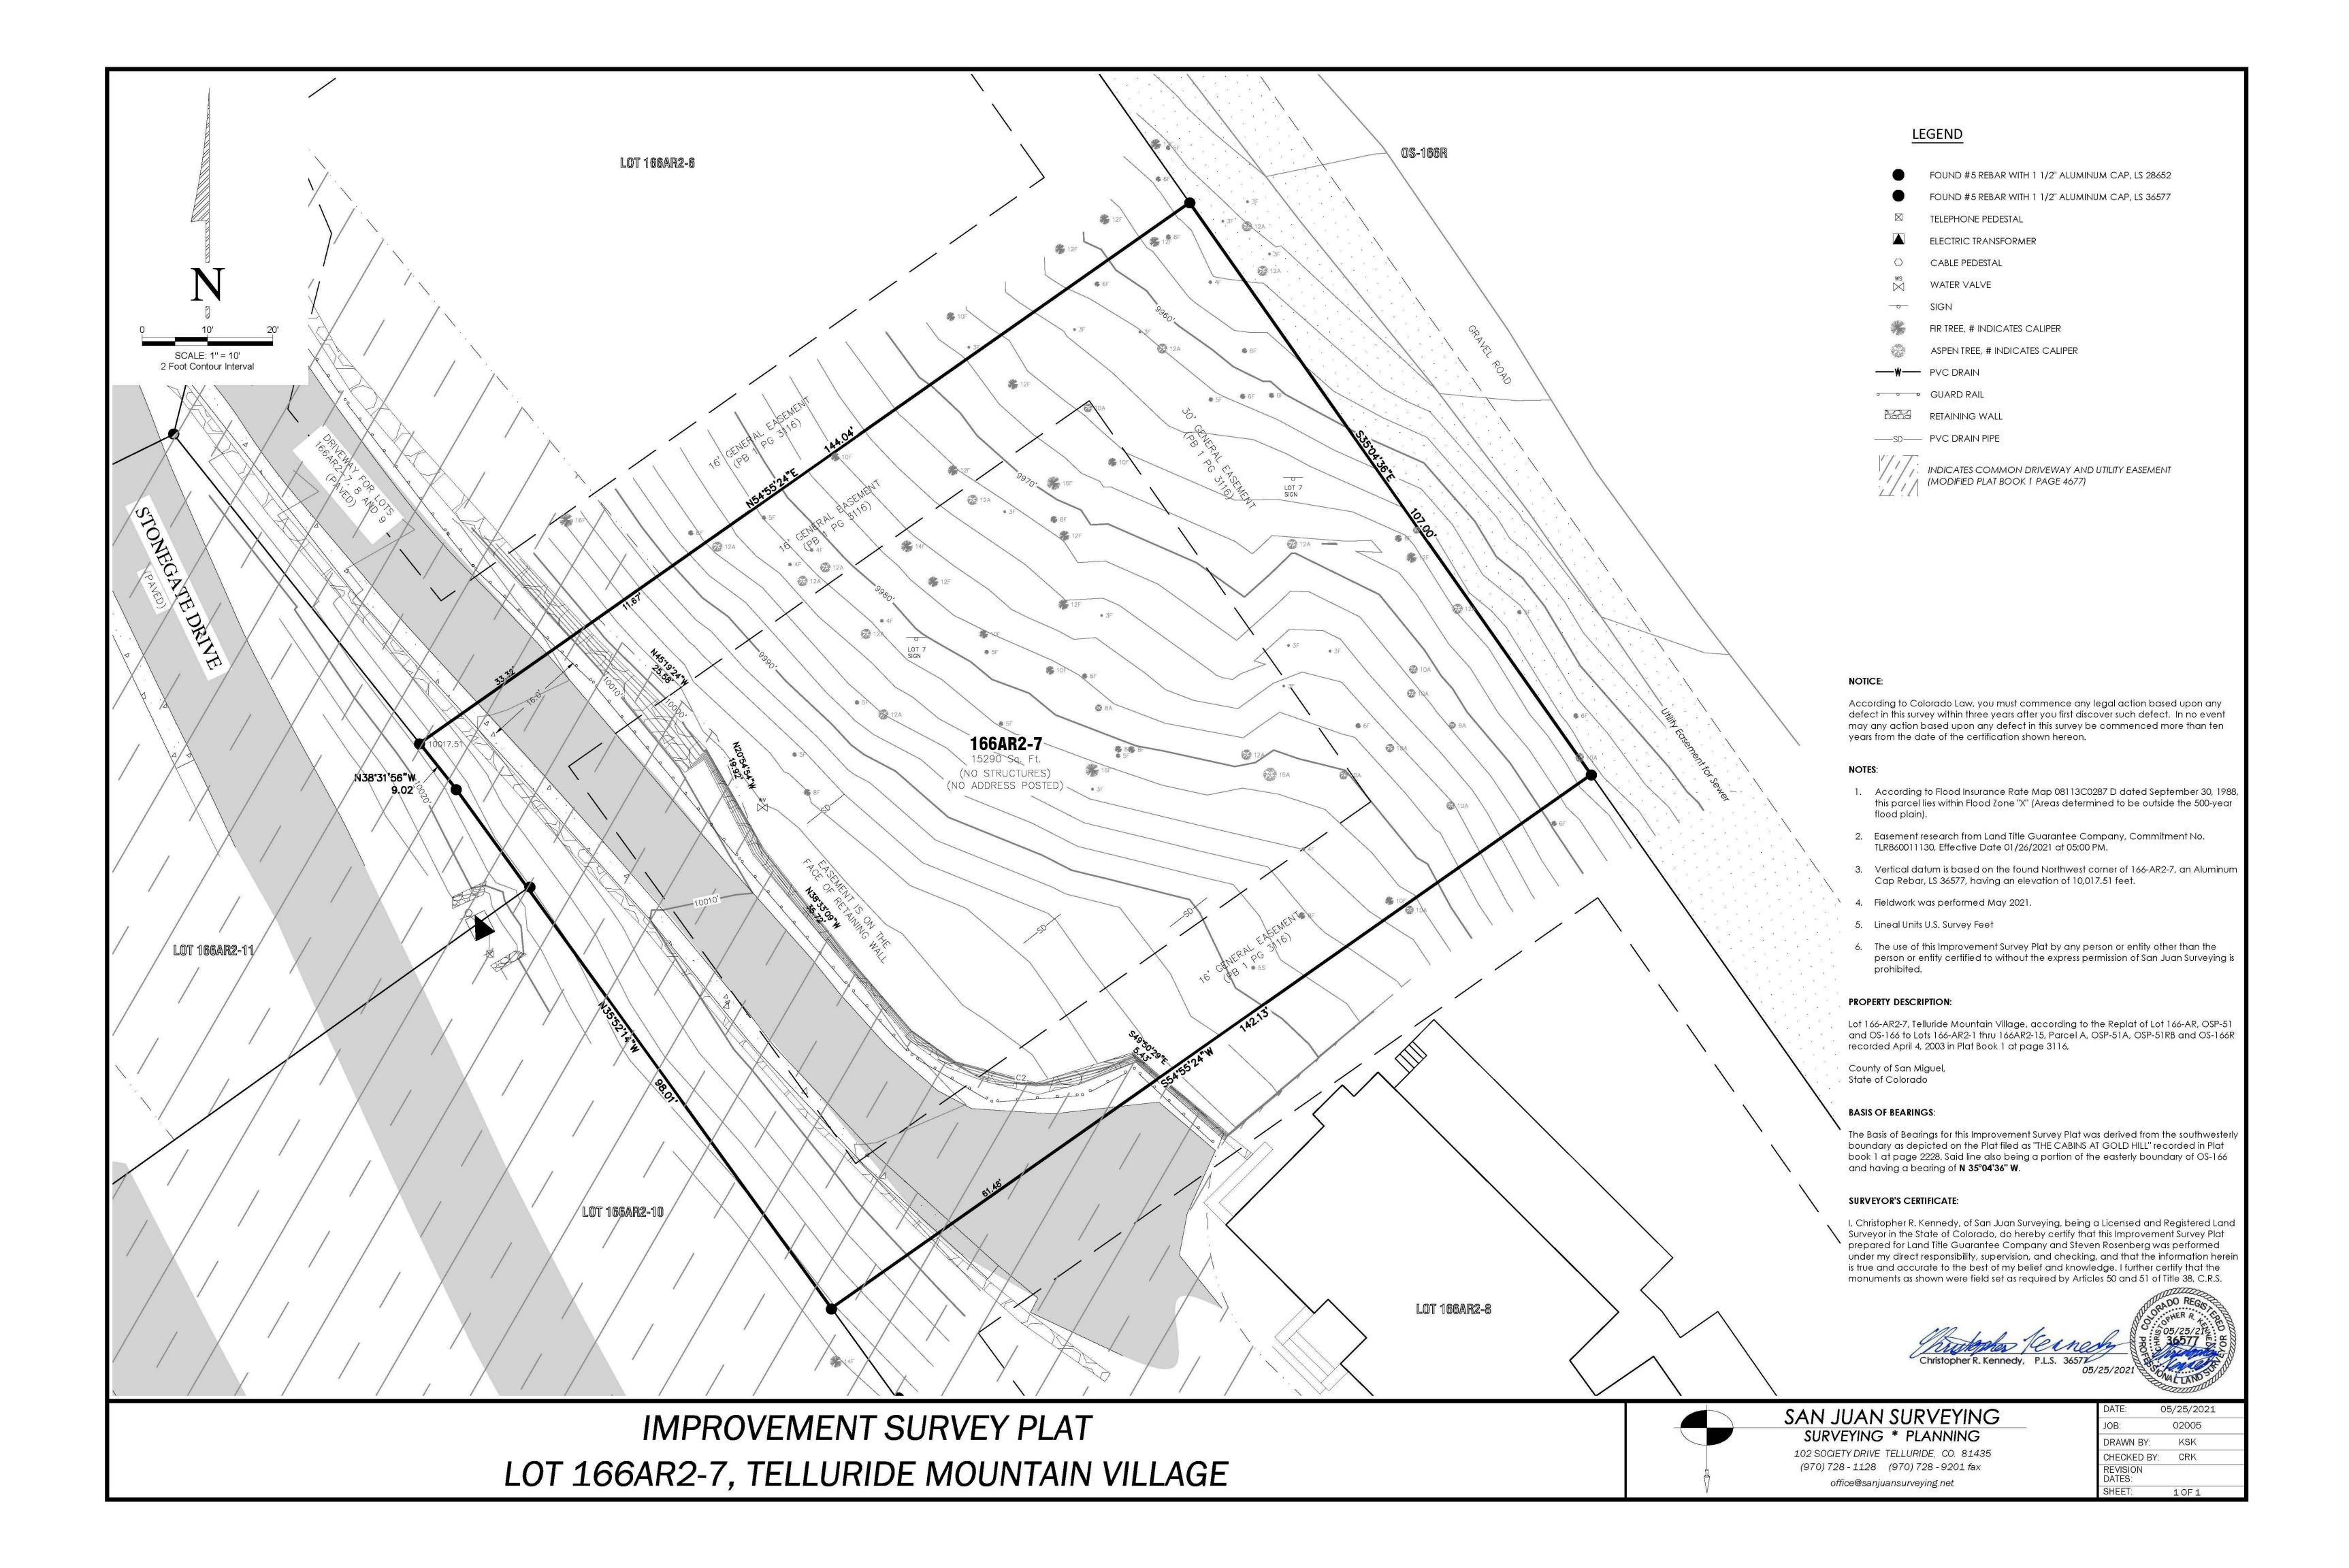

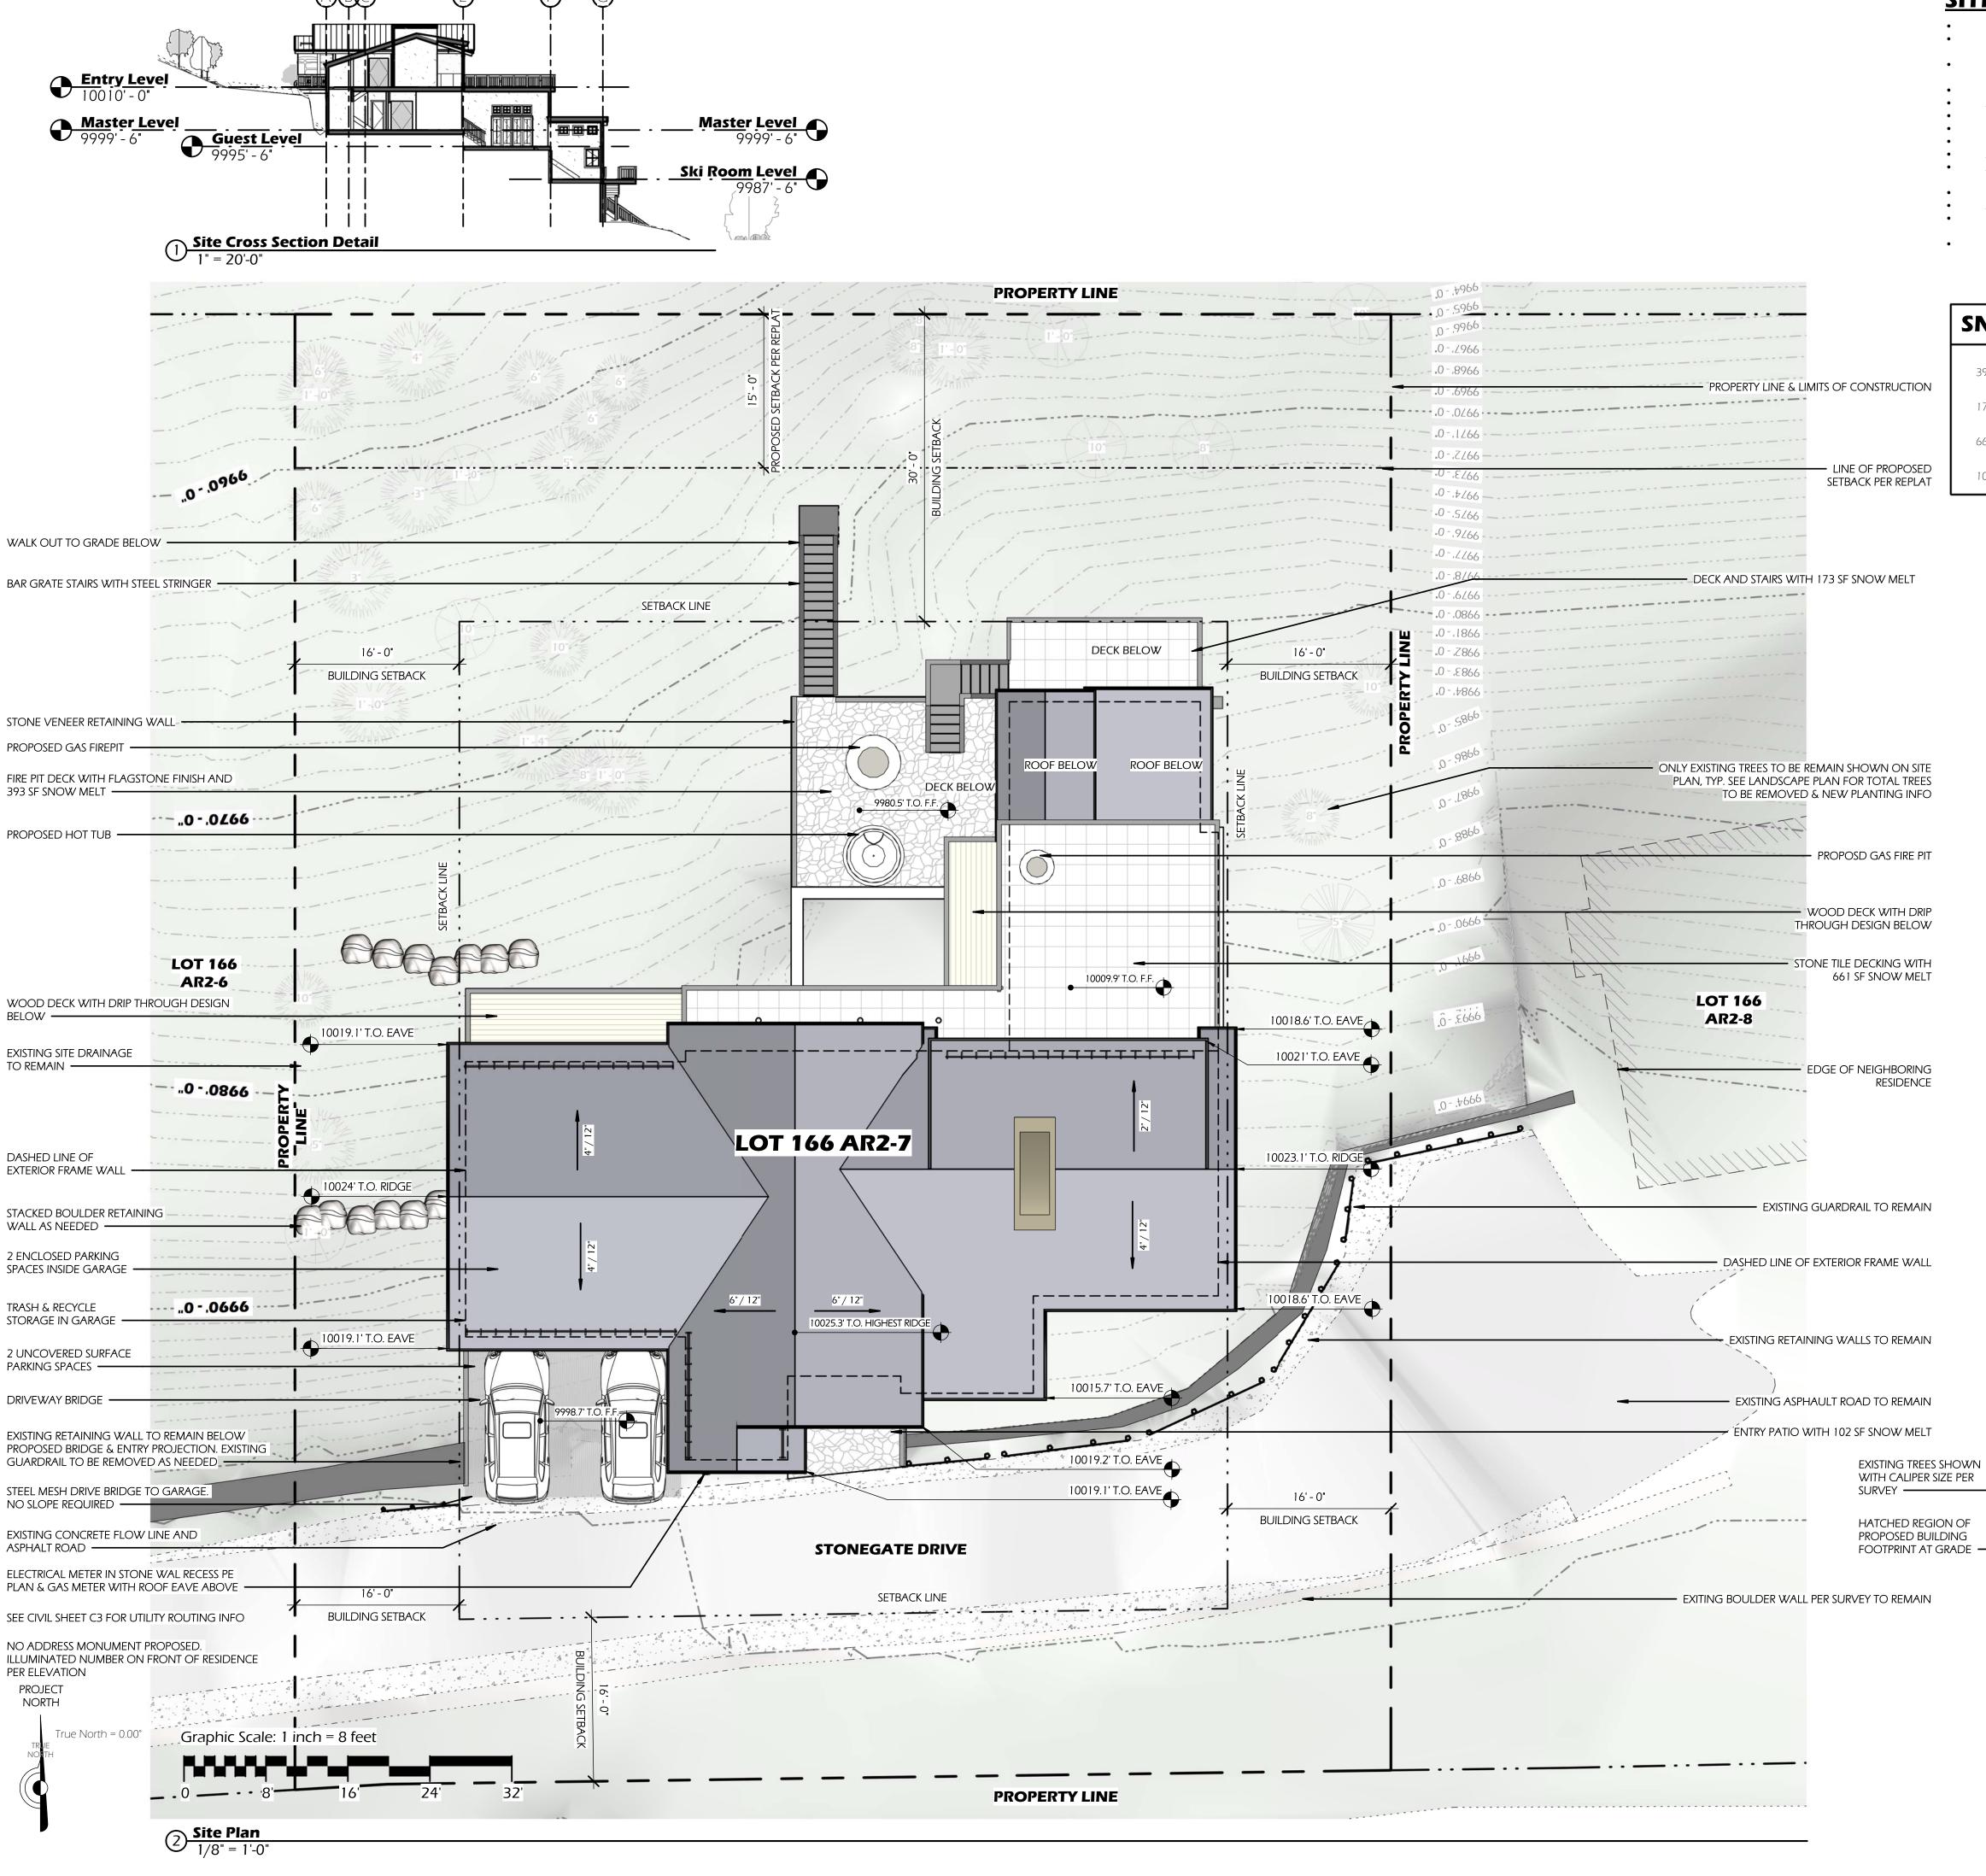

SITE PLAN NOTES:

- ONLY EXISTING TREES SHOWN. SEE LANDSCAPE PLAN FOR NEW PLANTINGS
- SITE IS NOT LOCATED WITHIN THE SPECIAL FLOOD HAZARD AREA; SITE HAS NO ROCK OUT CROPPING OR WETLANDS
- CONTRACTOR RESPONSIBLE FOR LOCATING AND ROUTING EXISTING UTILITIES TO PROPOSED LOCATIONS, INSTALLATION TO BE REVIEWED AND APPROVED BY UTILITY COMPANY
- EXISTING UTILITY SUPPLY TO REMAI
- ANY EXISTING OVERHEAD UTILITIES TO BE BURIED SEE LIGHTING PLAN FOR ALL EXTERIOR LIGHTING INFORMATION
- SEE LANDSCAPE PLAN FOR ALL PLANTING DETAILS
- NO ROOF TOP EQUIPMENT SHOWN, AS NONE WILL BE INSTALLED ALL DRAINAGE TO COMPLY WITH PUBLIC WORKS REQUIREMENTS
- ALL EGRESS WINDOW WELLS TO DRAIN INTO DRY WELLS BELOW SLAB, DRY WELLS TO BE LOOSE GRAVEL 24" MINIMUM BELOW SLAB
- EGRESS LADDER TO BE PROVIDED AT ALL WINDOW WELL LOCATIONS UNLESS WALKOUT TO GRADE PROVIDED ALL RETAINING WALLS 4' ABOVE GRADE AND TALLER SHALL BE ENGINEERED BY A LICENSED ENGINEER
- ALL RETAINING WALLS 4' ABOVE GRADE AND TALLER SHALL BE ENGINEERED BY A LICENSED ENGINEER FINISH GRADE AROUND THE ADDITION SHALL SLOPE AWAY FROM THE FOUNDATION A MINIMUM OF 2 % FOR THE
- SOILS PREPARATION SHALL BE PERFORMED UNDER THE DIRECT SUPERVISION OF THE GEOTECHNICAL ENGINEER.

SNOW MELT TOTALS

FIRST 4 FEET PER LOCAL POLICY.

393 FIRE PIT DECK

173 SKI LEVEL DECK & STAIRS

3 Lot Coverage Plan
1/16" = 1'-0"

661 ENTRY LEVEL DECK

102 ENTRY PATIO

PLANTING SYMBOLS EXISTING PLANTING TO REMAIN (SYMBOL SHOWN GRAYTONE)

EXISTING PLANTING TO BE REMOVED
(SYMBOL SHOWN GRAYTONE WITH DASHED
LINES)

NEW PROPOSEDPLANTING

(SYMBOL SHOWN BLACK WITH COLORED FILL)

LINETYPES LEGEND

SEWER

WATER VALVE

EXISTING MAJOR CONTOUR

NEW CONTOUR## GRADE ELEVATION TAG

PROPERTY LINE

OHE—OHE OVERHEAD ELECTRICAL

———— EASEMENT / SETBACK

-OC-OC-OVERHEAD CABLE

-G-G-G- GAS LINE

—S—S—S— SEWER LINE

-W-W-W- WATER LINE

PROJECT DESCRIPTION

4 Level - 4 Bedroom, 4 Full Bath, 1 Powder

SALT ARCHITECTURE

SANTA BARBARA, CA

PROJECT TEAM

PROPERTY OWNER

Sherman Oaks, CA 91423

Architect: Dylan Henderson

701 Anacapa Street

Office: 805.729.4276 Cell: 970.708.4795

SURVEYOR

San Juan Surveying 102 Society Drive

Telluride, ĆO 81435 Office: 970-728-1128

STRUCTURAL ENG.

MECHANICAL ENG.

Santa Barbara, CA 93101

Associate Architect: Brian Flatley

e-mail: dylan@saltarchitect.com

Steven Rosenberg 13520 Hesby Street

ARCHITECT

701 ANACAPASTREET 805.729.4276

PROJECT ZONING

Zoning District - Single Family Residence - 2018

PROJECT LEGAL DESCRIPTION

Lot 166AR2-7 Stonegate
6 Stonegate Drive

IRC Occ. Class R-3

Town of Mountain Village, CO 81435

Drawing Set Issued Description Date

IASR Review

10/08/2021

Description Date

Lot 7

STONEGATE


Site Plan

Date: 10/08/2021

Drawn by: DH / BF

Checked by: DH / BF

Scale: As indicated

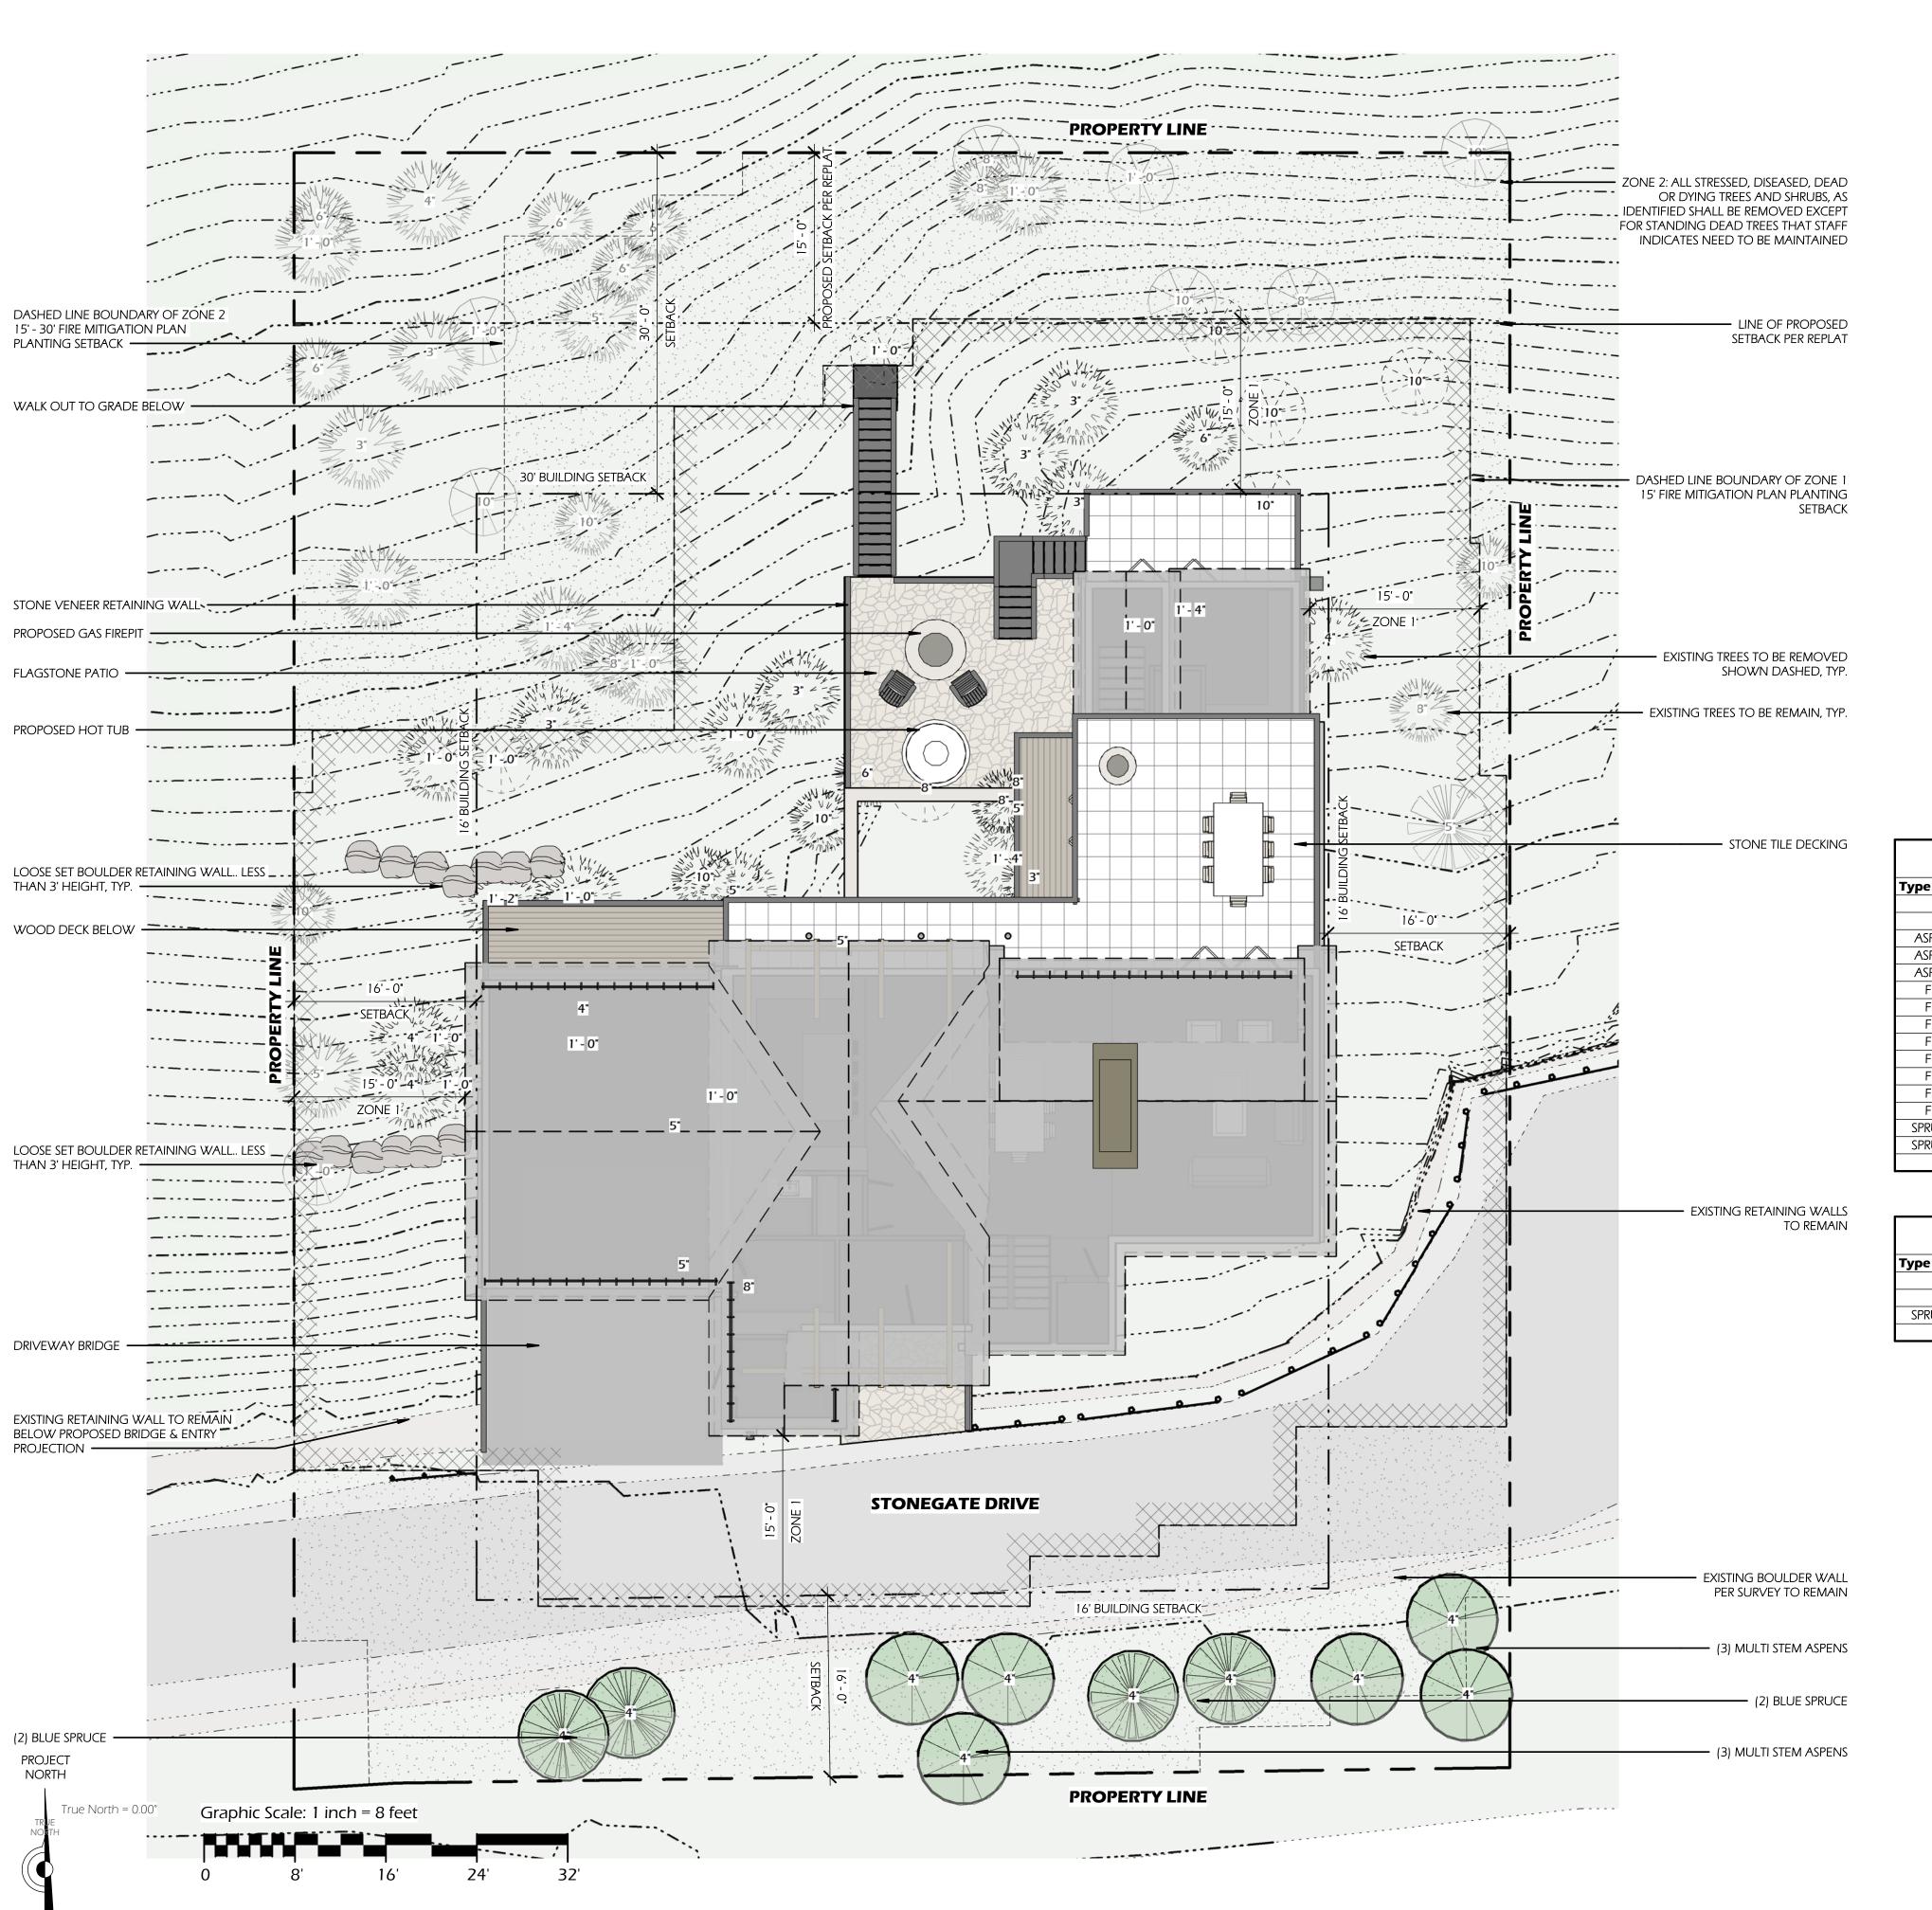

LANDSCAPE NOTES:

- SUBSOIL SURFACE SHALL BE TILLED TO A 4" DEPTH ON NON FILL AREAS. TOPSOIL SHALL BE SPREAD AT A MINIMUM DEPTH OF 4" OVER ALL AREAS TO BE REVEGETATED (EXCEPT ON SLOPES GREATER THAN 3:1) AND AMENDMENTS ROTOTILLED AT A RATE OF THREE CUBIC YARDS PER THOUSAND SQUARE
- BROADCASTING OF SEED SHALL BE DONE IMMEDIATELY AFTER TOPSOIL IS APPLIED (WITHIN TEN DAYS) TO MINIMIZE EROSION AND WEEDS.
 - AREAS WHICH HAVE BEEN COMPACTED, OR ARE RELATIVELY UNDISTURBED, NEEDING SEEDING, SHALL BE
 - SCARIFIED BEFORE BROADCASTING OF SEED. BROADCAST WITH SPECIFIED SEED MIX AND FOLLOW WITH DRY MULCHING.
 - STRAW OR HAY SHALL BE UNIFORMLY APPLIED OVER SEEDED AREA AT A RATE OF 1.5 TONS PER ACRE FOR HAY
 - AND 2 TONS PER ACRE FOR STRAW, CRIMP IN. ON SLOPES GREATER THAT 3:1 EROSION CONTROL BLANKET SHALL BE APPLIED IN PLACE OF STRAW MULCH AND
 - ALL UTILITY CUTS SHALL BE REVEGETATED WITHIN TWO WEEKS AFTER INSTALLATION OF UTILITIES TO PREVENT
 - SEED ALL AREAS LABELED AS REVEG/RESEED WITH TELSKI WILDFLOWER GRASS AND SEED MIX OF A RATE AS

FOLLOWS:

i. Seeding with the native grass seed mix or the wetland buffer mix, if applicable, is required in all disturbed areas on the perimeter of the building site and at utility and road cuts. (a) Native Grass Seed Mix (General Revegetation)

Western Yarrow 5%

Tall Fescue 10% Arizona Fescue 5%

Hard Fescue 5% Creeping Red Fescue 10%

Alpine Bluegrass 15% Canada Bluegrass 10%

Perennial Ryegrass 15%

Slender Wheatgrass 10% Mountain Brome 15% (b) Wetlands Buffer Mix

To be planted within twenty feet (20') of wetland areas Arizona Fescue 14%

Alpine Bluegrass 14% Slender Wheatgrass 35%

Mountain Brome 36%

LANDSCAPE GENERAL NOTES

ALL TREES AND SHRUBS SHALL BE FIELD LOCATED BY PROJECT ARCHITECT.

- ALL TREES AND SHRUBS SHALL BE BACK FILLED WITH A TOPSOIL / ORGANIC FERTILIZER MIXTURE AT A 2:1 RATIO. NECESSARY TREES SHALL BE STAKED WITH 4 FOOT METAL POSTS. TREES SHALL BE GUYED WITH 12 GAUGE GALVANIZED WIRE AND POLYPROPYLENE TREE RACE STRAPS.
- PERENNIAL PLANTING BEDS SHALL BE TILLED TO A 6" DEPTH AND AMENDED WITH TOPSOIL AND ORGANIC
- FERTILIZER AT A 2:1 RATIO. SEE PLANTING DETAILS FOR ALL DECIDUOUS AND EVERGREEN TREES. MULCH ALL PERENNIAL BEDS WITH A PINE
- BARK SOIL CONDITIONER; SHREDDED BARK.
- ALL PLANT MATERIAL TO MEET THE AMERICAN STANDARD FOR NURSERY STOCK. ALL PLANTED MATERIALS SHALL BE A NON-NOXIOUS SPECIES AS SPECIFIED WITHIN THE SAN MIGUEL COUNTY
- NOXIOUS WEED LIST. LANDSCAPING SHOWN ON THE LANDSCAPE PLAN SHALL COMPLY WITH SECTION 9-109 OF THE DESIGN REGULATIONS REGARDING NOXIOUS WEEDS.

ALL NEW PLANTED ASPEN TREES TO BE MULTI-STEM TREES.

T TAP WITH RAINBIRD PVB-075 BACKFLOW PREVENTER

- RAINBIRD RCM-12 ELECTROMECHANICAL CONTROLLER 1 1/2" WILKINS MODEL 500 PRESSURE REGULATOR
- RAINBIRD 150 ELECTRIC REMOTE CONTROL VALVE 1" CLASS 200 PVC MAINLINE
- 1" NSF POLYLATERAL LINE
- WATER SENSOR
- RAINBIRD POP-UP DRIP LINE
- TREES AND SHRUBS TO BE DRIP ONLY-DRIP ZONES TO BE SHUT OFF (2) FULL GROWING SEASONS AFTER PLANT
- TEMPORARY IRRIGATION OF REVEGETATED AREAS LONG TERM WATERING TO BE ASSESSED TOT AUTHORITY

Planting - Symbols Legend

NOTE: PLANTINGS ARE LABELED WITH CALIPER SIZE. REFER TO SURVEY &

SITE PLAN SHEETS FOR EXISTING TREE SIZE INFORMATION

HATCHED AREA OF REVEG / RESEED

EXISTING PLANTING TO REMAIN (SYMBOL SHOWN GRAYTONE)

EXISTING PLANTING TO BE REMOVED

NEW PROPOSEDPLANTING

DWARF EVERGREEN


(SYMBOL SHOWN GRAYTONE WITH DASHED LINES)

(SYMBOL SHOWN BLACK WITH COLORED FILL)

ASPEN WITH CALIPER SIZE SHOWN

Planting - Existing To Remain		Plan	ting - Exi	istin	g To Be	Remove			
Type Mark	Type Comments	Count	Phase Created	Phase Demolished	Type Mark	Type Comments	Count	Phase Created	Phase Demoli
	4 in Caliper	6	New Construction	None	ASPEN	8 in Caliper	1	Existing	New Constructi
ASPEN	8 in Caliper	2	Existing	None	ASPEN	10 in Caliper	4	Existing	New Constructi
ASPEN	10 in Caliper	3	Existing	None	ASPEN	12 in Caliper	7	Existing	New Constructi
ASPEN	12 in Caliper	3	Existing	None	ASPEN	16 in Caliper	1	Existing	New Constructi
FIR	3 in Caliper	2	Existing	None	FIR	3 in Caliper	6	Existing	New Constructi
FIR	4 in Caliper	1	Existing	None	FIR	4 in Caliper	4	Existing	New Constructi
FIR	5 in Caliper	2	Existing	None	FIR	5 in Caliper	5	Existing	New Constructi
FIR	6 in Caliper	5	Existing	None	FIR	6 in Caliper	2	Existing	New Constructi
FIR	8 in Caliper	3	Existing	None	FIR	8 in Caliper	3	Existing	New Constructi
FIR	10 in Caliper	3	Existing	None	FIR	10 in Caliper	2	Existing	New Construction
FIR	12 in Caliper	4	Existing	None	FIR	12 in Caliper	3	Existing	New Constructi
FIR	16 in Caliper	1	Existing	None	FIR	14 in Caliper	1	Existing	New Constructi
SPRUCE	4 in Caliper	4	New Construction	None	FIR	16 in Caliper	1	Existing	New Construction
SPRUCE	5 in Caliper	1	Existing	None			40		

Planting - New Proposed				
Type Mark	Type Comments	Count	Phase Created	Phase Demolished
	4 in Caliper	6	New Construction	None
SPRUCE	4 in Caliper	4	New Construction	None
		10		

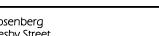

PROJECT TEAM

SALT ARCHITECTURE

SANTA BARBARA, CA

701 ANACAPASTREET 805.729.4276

Steven Rosenberg 13520 Hesby Street Sherman Oaks, CA 91423

PROPERTY OWNER

ARCHITECT

Architect: Dylan Henderson Associate Architect: Brian Flatley 701 Anacapa Street Santa Barbara, CA 93101 Office: 805.729.4276 Cell: 970.708.4795 e-mail: dylan@saltarchitect.com

SURVEYOR

Office: 970-728-1128

San Juan Surveying 102 Society Drive Telluride, CO 81435

STRUCTURAL ENG.

MECHANICAL ENG.

PROJECT DESCRIPTION

4 Level - 4 Bedroom, 4 Full Bath, 1 Powder

PROJECT ZONING

Zoning District - Single Family Residence - 2018 IRC Occ. Class R-3

PROJECT LEGAL DESCRIPTION

Lot 166AR2-7 Stonegate 6 Stonegate Drive Town of Mountain Village, CO 81435

10.	Description	Date
1	IASR Review	10/08/2021
Ž		
3		
4		
5		
6		
7		
8		
9		


Description

Lot 7

STONEGATE

Landscape

10/08/2021 DH / BF Drawn by: hecked by DH / BF

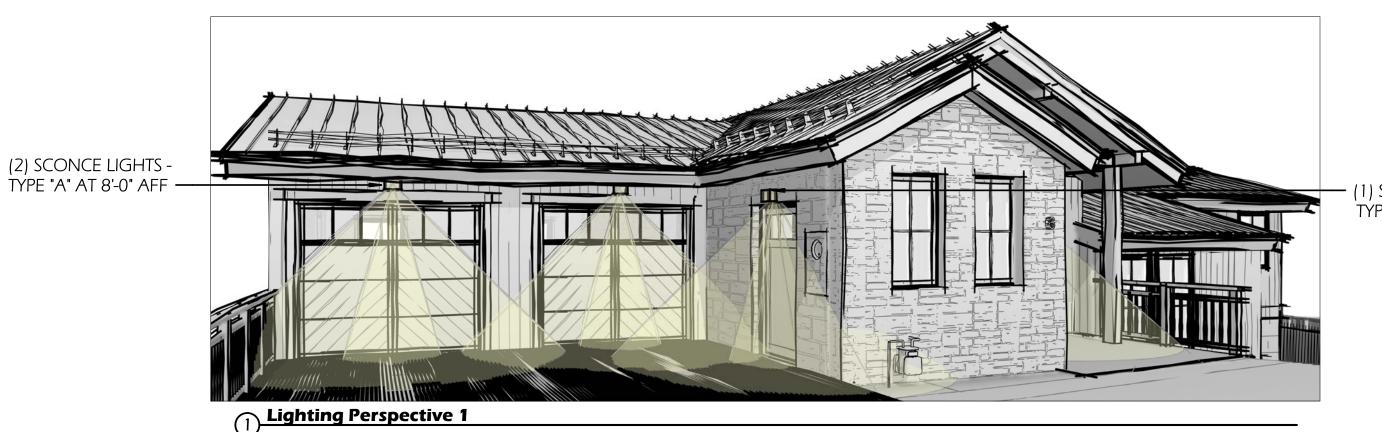


(1) SCONCE LIGHTS -TYPE "A" AT 7'-6" AFF


(2) SIDEWAL STEP LIGHTS AT 1'-6" AFF TYP.

(2) SIDEWAL

STEP LIGHTS ·

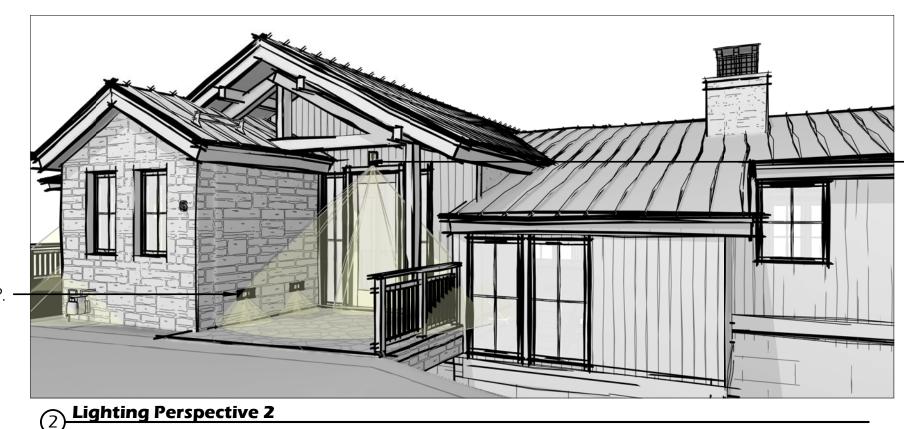



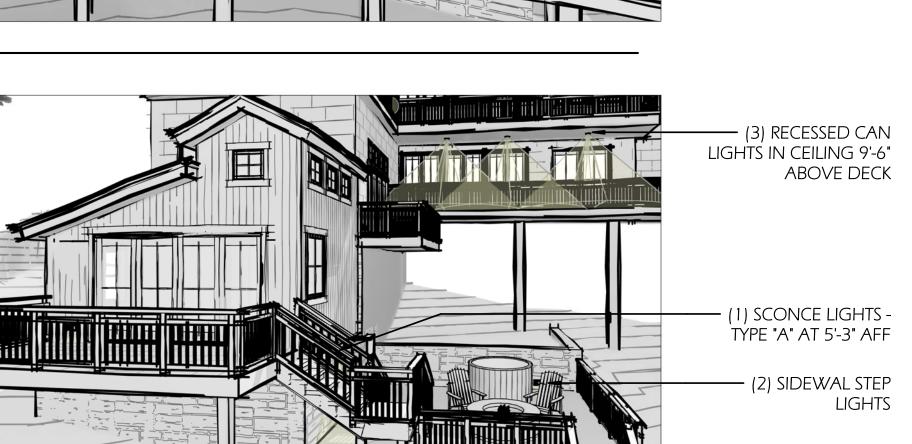

Lighting Fixture Schedule Type Mark | Type Comments | Count | Description Recessed Can Light Balluster Light TYPE E Side Wall Step Light

(2) SCONCE LIGHTS -TYPE "A" AT 8'-0" AFF -(1) SCONCE LIGHTS -TYPE "A" AT 7'-6" AFF

(1) SCONCE LIGHTS -TYPE "A" AT 5'-3" AFF -(4) BALLUSTER LIGHTS · (3) RECESSED CAN LIGHTS IN CEILING 9'-6" (4) Lighting Perspective 4 ABOVE DECK -

PROJECT ZONING Zoning District - Single Family Residence - 2018 IRC Occ. Class R-3 PROJECT LEGAL DESCRIPTION Lot 166AR2-7 Stonegate 6 Stonegate Drive Town of Mountain Village, CO 81435 **Drawing Set** Description IASR Review

> (1) SCONCE LIGHT -TYPE "B" AT 8'-6" AFF

(1) SCONCE LIGHT -

TYPE "B" AT 8'-6" AFF

6 Lighting Key Plan

TYPE: A

(2) SCONCE LIGHTS -

 ILLUM TYPE: 300 SOURCE LUMENS: TEMP: 3000K CRI: BEAM VIEW ANGLE:

FIXTURE HEIGHTS VARY LUMINOUS AREA AT 8'-0" AFF: 27.42 LUX SPREAD (M): COVERAGE AREA (M2): LUMINOUS AREA AT 7'-6" AFF:

31.19LUX SPREAD (M): COVERAGE AREA (M2): LUMINOUS AREA AT 5'-3" AFF: 63.66LUX COVERAGÉ AREA (M2): 8.04m²

Alume AWL.61 Wall Sconce

Simple and refined are the best ways to describe the Alume AWL.61 Wall Sconce by LumenArt. The Opal Acrylic lenses pair well with the variety of models and finishes this fixture has to offer. Suitable for indoor and outdoor use.

Material: Aluminum Shade Material: Frosted White Opal Glass

- Dimmable when used with a ELV or TRIAC or 0-10V Dimmer (Not Included)
- 1 Light Option Fixture: Width 9", Height 4.75", Depth 1.62" 1 DOWN light
- 11w LED

TYPE: B

ILLUM TYPE: LED 300 SOURCE LUMENS: 3000K TEMP: LUMINOUS AREA AT 9'-6" AFF: 19.44 LUX SPREAD (M): 5.79m

(5) Lighting Perspective 5

COVERAGE AREA (M2):

BEAM VIEW ANGLE:



Hinkley - Kore Bronze Square Dark Sky LED Outdoor Wall Light

26.3m²


Simple and refined are the best ways to describe the Alume AWL.61 Wall Sconce by LumenArt. The Opal Acrylic lenses pair well with the variety of models and finishes this fixture has to offer. Suitable for indoor and outdoor use.

7 1/2" high x 5 1/4" wide. Extends 4" from the wall. Backplate is 5 1/4" wide. Weighs 2 lbs.

- Built-in dimmable 5 watt LED module Kore square cylinder ADA compliant dark sky compliant energy-efficient
- Bronze finished aluminum construction with Etched glass lens.

TYPE: C

LED ILLUM TYPE: 660 SOURCE LUMENS: TEMP: CRI: BEAM VIEW ANGLE:

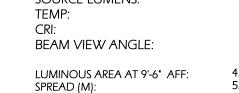


3000K 80 42.77 LUX COVERAGÉ AREA (M2):

ELKO: ELD44ICA 4" LED New Construction IC Airtight Housing


Lamp: 13W LED module, 350mA DC Driver: 120V AC, 0.14A high quality driver Dimmable with most incandescent and electronic dimmers. Trim Ring: Polycarbonate trim ring designed to conceal ceiling cutout.


ELD44ICA: 3000°K, 660 lm Note: Battery backup driver available upon request.

- Housing includes LED module and driver unit. Double wall construction, for use in insulated ceilings.
- 7 1/4" height allows for use in 2 x 8 construction. Adjustable housing accommodates up to 1 1/4" ceiling thickness.
- Advanced heat sink design for best heat dissipation to maintain maximum LED module life.
- Over 660 lumens effective light output (with baffle trim).
- High CRI (>80), warm white (3000°K), high lumen maintenance. Housing meets restricted air flow requirement (per ASTM E-283).
- CA Title 24 compliant. Meets ENERGY STAR requirements. Trims sold separately.

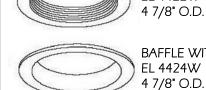

EL 4422W BAFFLE WITH FROSTED TRIM

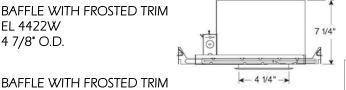

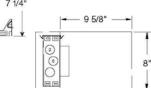

12 1/2" ----

TYPE: D

ILLUM TYPE: LED 150 SOURCE LUMENS: 2700K

LUMINOUS AREA AT 10" AFF: 1263LUX SPREAD (M): 0.508m 0.254m² COVERAGE AREA (M2): BEAM VIEW ANGLE:

Hardy Island Matte Bronze Landscape Deck Sconce

Hinkley 16801MZ-LL - Hardy Island products are impeccably designed to defy the harshest environments. The Hardy Island Collection, named for the ruggedly beautiful island off the coast of British Columbia, defies the harshest environments in style with landscape lighting that features fully enclosed lamps and a rich weathered brass finish that will mature naturally over time.

SKU: 16801MZ-LED Safety Rating: C-US Wet Rated

- Material: Cast Brass Finish: Matte Bronze
- Category: Deck/Step Lighting Dimensions and Weight: Length: 2.00 in. Width: 3.50 in.

Extension/Depth: 2.00 in.

Height: 3.50 in.

Weight: 1.10 lb.

TYPE: E

ILLUM TYPE: SOURCE LUMENS: SPREAD (M):

LUMINOUS AREA AT 1'-6" AFF: 397.7 LUX 0.61m COVERAGÉ AREA (M2): 0.292m² BEAM VIEW ANGLE:

LED

68

2700K

WL-LED100 Step And Wall Light

Construction: Die-cast corrosion resistant aluminum alloy Low profile, flush to wall aesthetics with no visible hardware Balanced lighting, free of shadows with minimum glare

Lot 7

Description

SALT ARCHITECTURE SANTA BARBARA, CA

PROJECT TEAM

PROPERTY OWNER

13520 Hesby Street Sherman Oaks, CA 91423

Architect: Dylan Henderson Associate Architect: Brian Flatley

e-mail: dylan@saltarchitect.com

ARCHITECT

SURVEYOR

San Juan Surveying

Telluride, CO 81435

Office: 970-728-1128

STRUCTURAL ENG.

MECHANICAL ENG.

PROJECT DESCRIPTION

4 Level - 4 Bedroom, 4 Full Bath, 1 Powder

Date

10/08/2021

Date

102 Society Drive


701 Anacapa Street Santa Barbara, CA 93101 Office: 805.729.4276 Cell: 970.708.4795

701 ANACAPASTREET 805.729.4276

STONEGATE

Exterior Lighting Plan

Date:	10/08/2021
Drawn by:	DH / BF
Checked by:	DH / BF

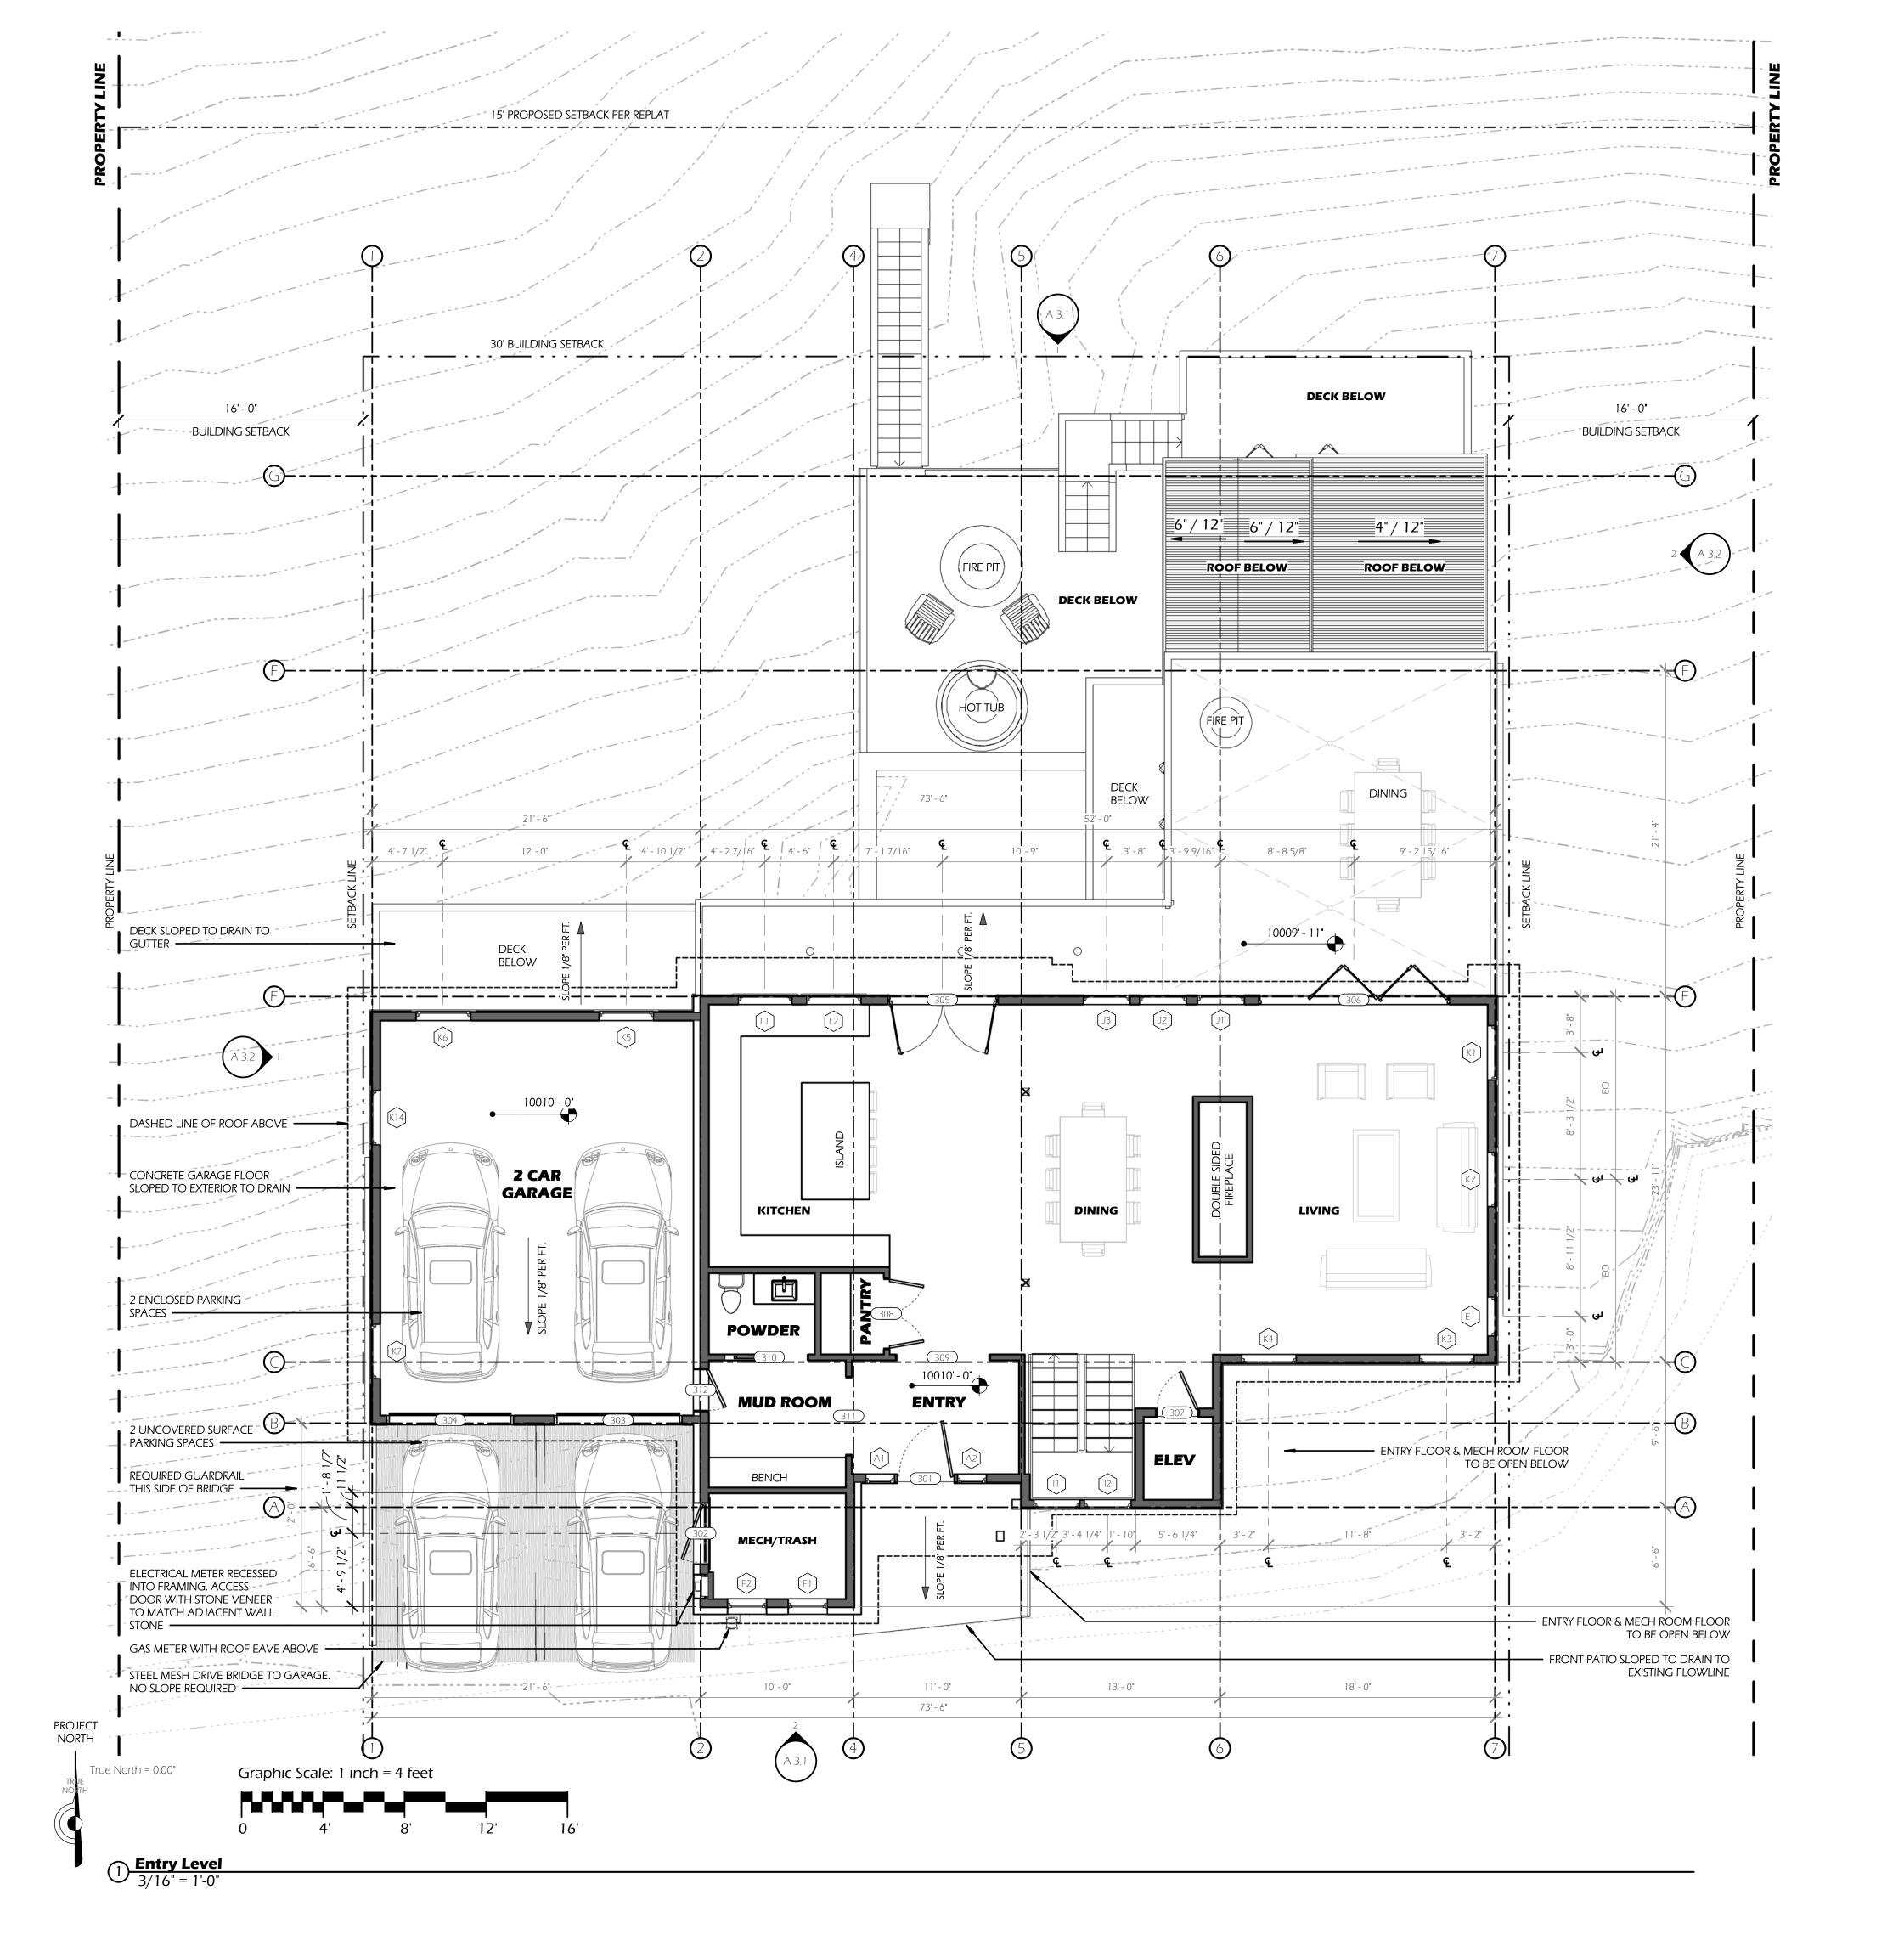


FRAMING NOTES:

- DO NOT SCALE DIMENSIONS FROM PLANS. ANY MISSING OR UNCLEAR DIMENSIONS ARE TO BE CONFIRMED WITH
- FRAMING PLANS DIMENSIONS SHOWN TO FACE OF STUD OR OBJECTS CENTER, TYPICALLY U.N.O.
- SOUND BATT INSULATION AT ALL INTERIOR WALLS & FLOOR, TYP.
- SEE A5 SERIES FOR STAIR DETAILS SEE A7 FOR ALL ASSEMBLY DETAILS
- ALL FURRING ON CONCRETE WALLS SHOWN @ 2" DEEP, U.N.O.
- ALL EXTERIOR FLOORS TO BE 1" BELOW ADJACENT INTERIOR FINISH FLOOR ELEVATION ALL EXTERIOR SLABS AND SURFACES TO BE SLOPED TO DRAIN PER PLANS
- MINIMUM BELOW SLAB
- LADDER OR RUNGS ARE TO HAVE AN INSIDE WIDTH OF NOT LESS THAN 12", SHALL PROJECT AT LEAST 3" FROM THE


- SAFETY GLAZING TO BE PROVIDED AS REQUIRED BY LOCAL CODES, (R308.4). REFER TO A8.1 FOR SPECIFIC WINDOWS & DOORS LOCATIONS THAT REQUIRE SAFETY GLAZING




Area Schedule					
Area	Comments	Level			
	1				
238 SF	Living Area	Ski Room Level			
436 SF	Living Area	Guest Level			
1952 SF	Living Area	Master Level			
652 SF	Garage Area	Entry Level			
1539 SF	Living Area	Entry Level			

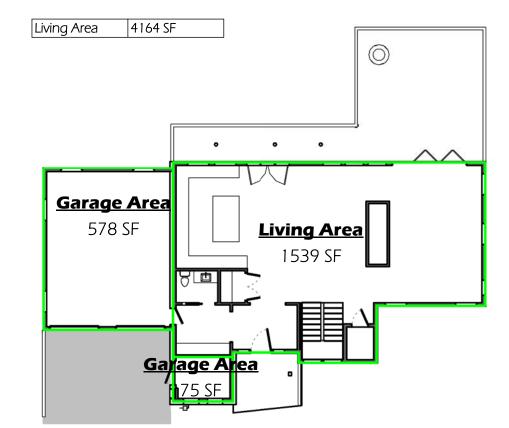

3 Entry Level
1/16" = 1'-0"

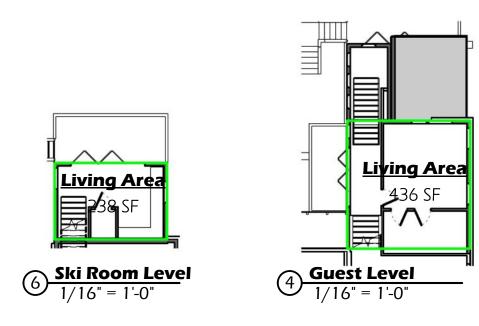

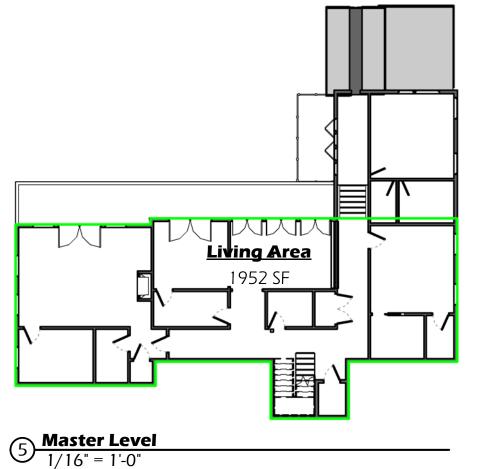

SALT ARCHITECTURE SANTA BARBARA, CA

701 ANACAPASTREET 805.729.4276

PROJECT TEAM

PROPERTY OWNER

Steven Rosenberg 13520 Hesby Street Sherman Oaks, CA 91423

ARCHITECT

Architect: Dylan Henderson Associate Architect: Brian Flatley 701 Anacapa Street Santa Barbara, CA 93101 Office: 805.729.4276 Cell: 970.708.4795 e-mail: dylan@saltarchitect.com

SURVEYOR

San Juan Surveying 102 Society Drive Telluride, CO 81435 Office: 970-728-1128

STRUCTURAL ENG.

MECHANICAL ENG.

PROJECT DESCRIPTION

4 Level - 4 Bedroom, 4 Full Bath, 1 Powder

PROJECT ZONING

Zoning District - Single Family Residence - 2018 IRC Occ. Class R-3

PROJECT LEGAL DESCRIPTION

Lot 166AR2-7 Stonegate 6 Stonegate Drive Town of Mountain Village, CO 81435

Drawing Set Description	Issued Date
IASR Review	10/08/2021


Description Date


Lot 7

STONEGATE

Entry Level Floor Plan

10/08/2021 DH / BF Drawn by: Checked by: DH / BF

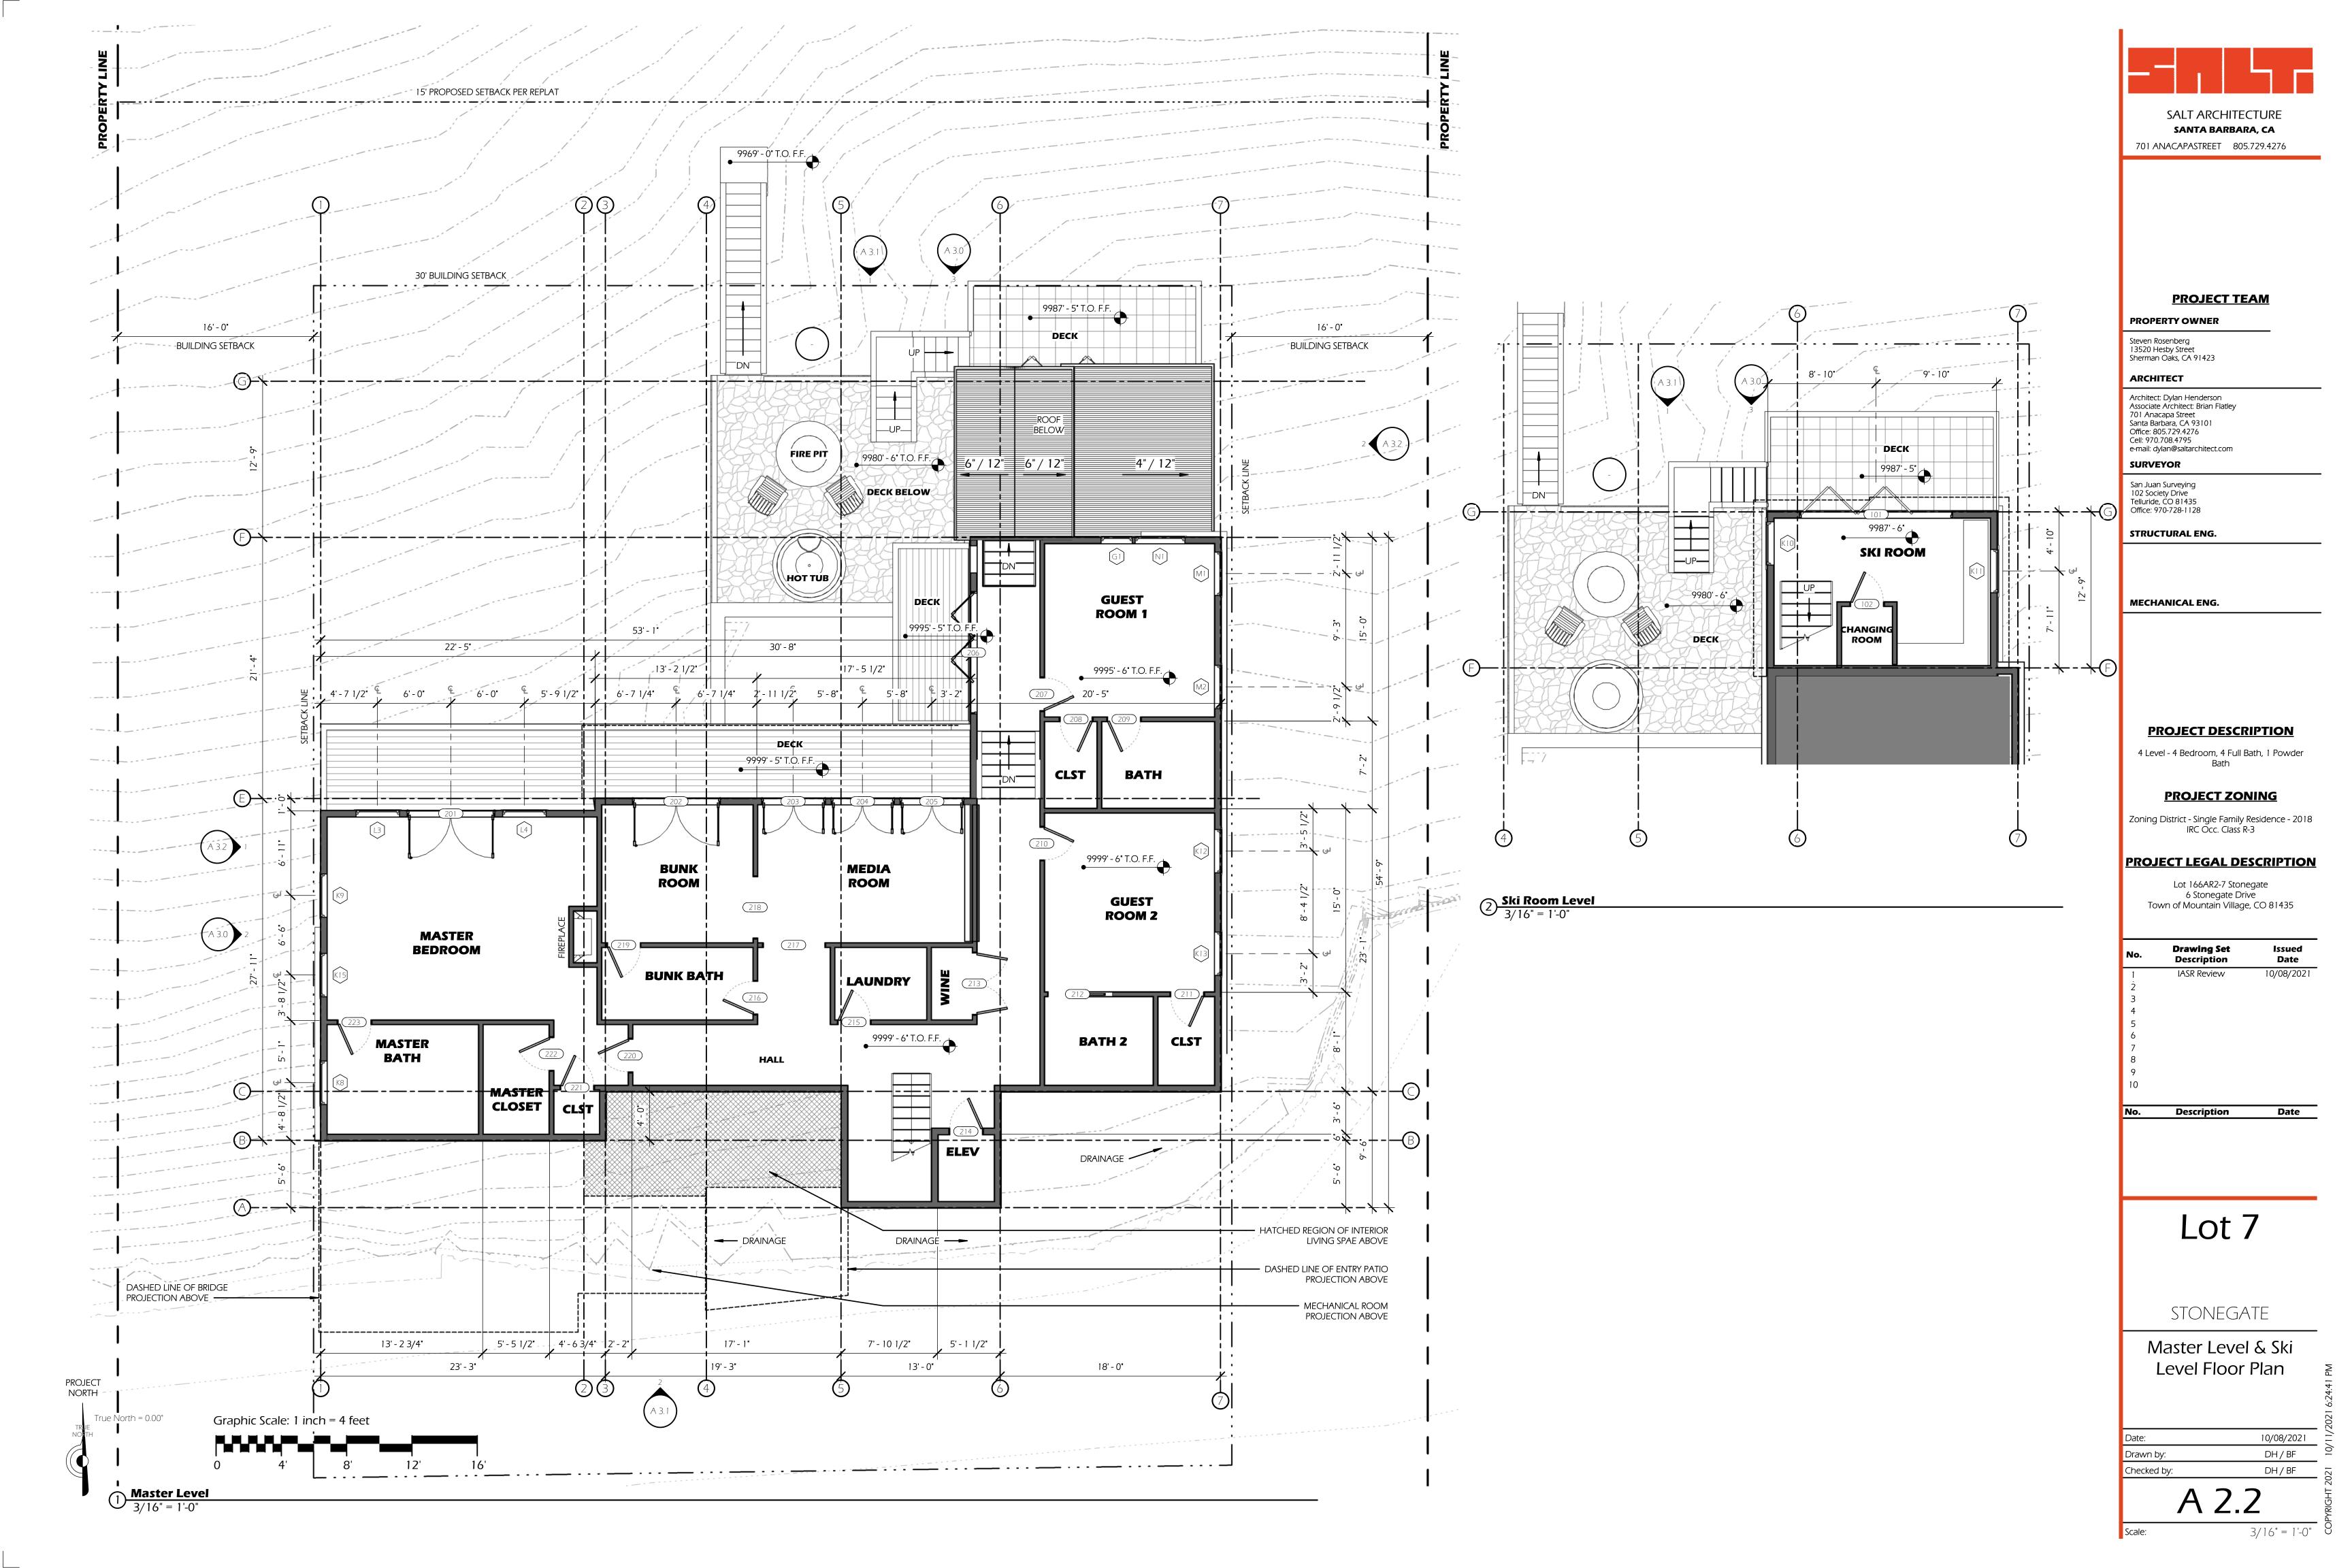

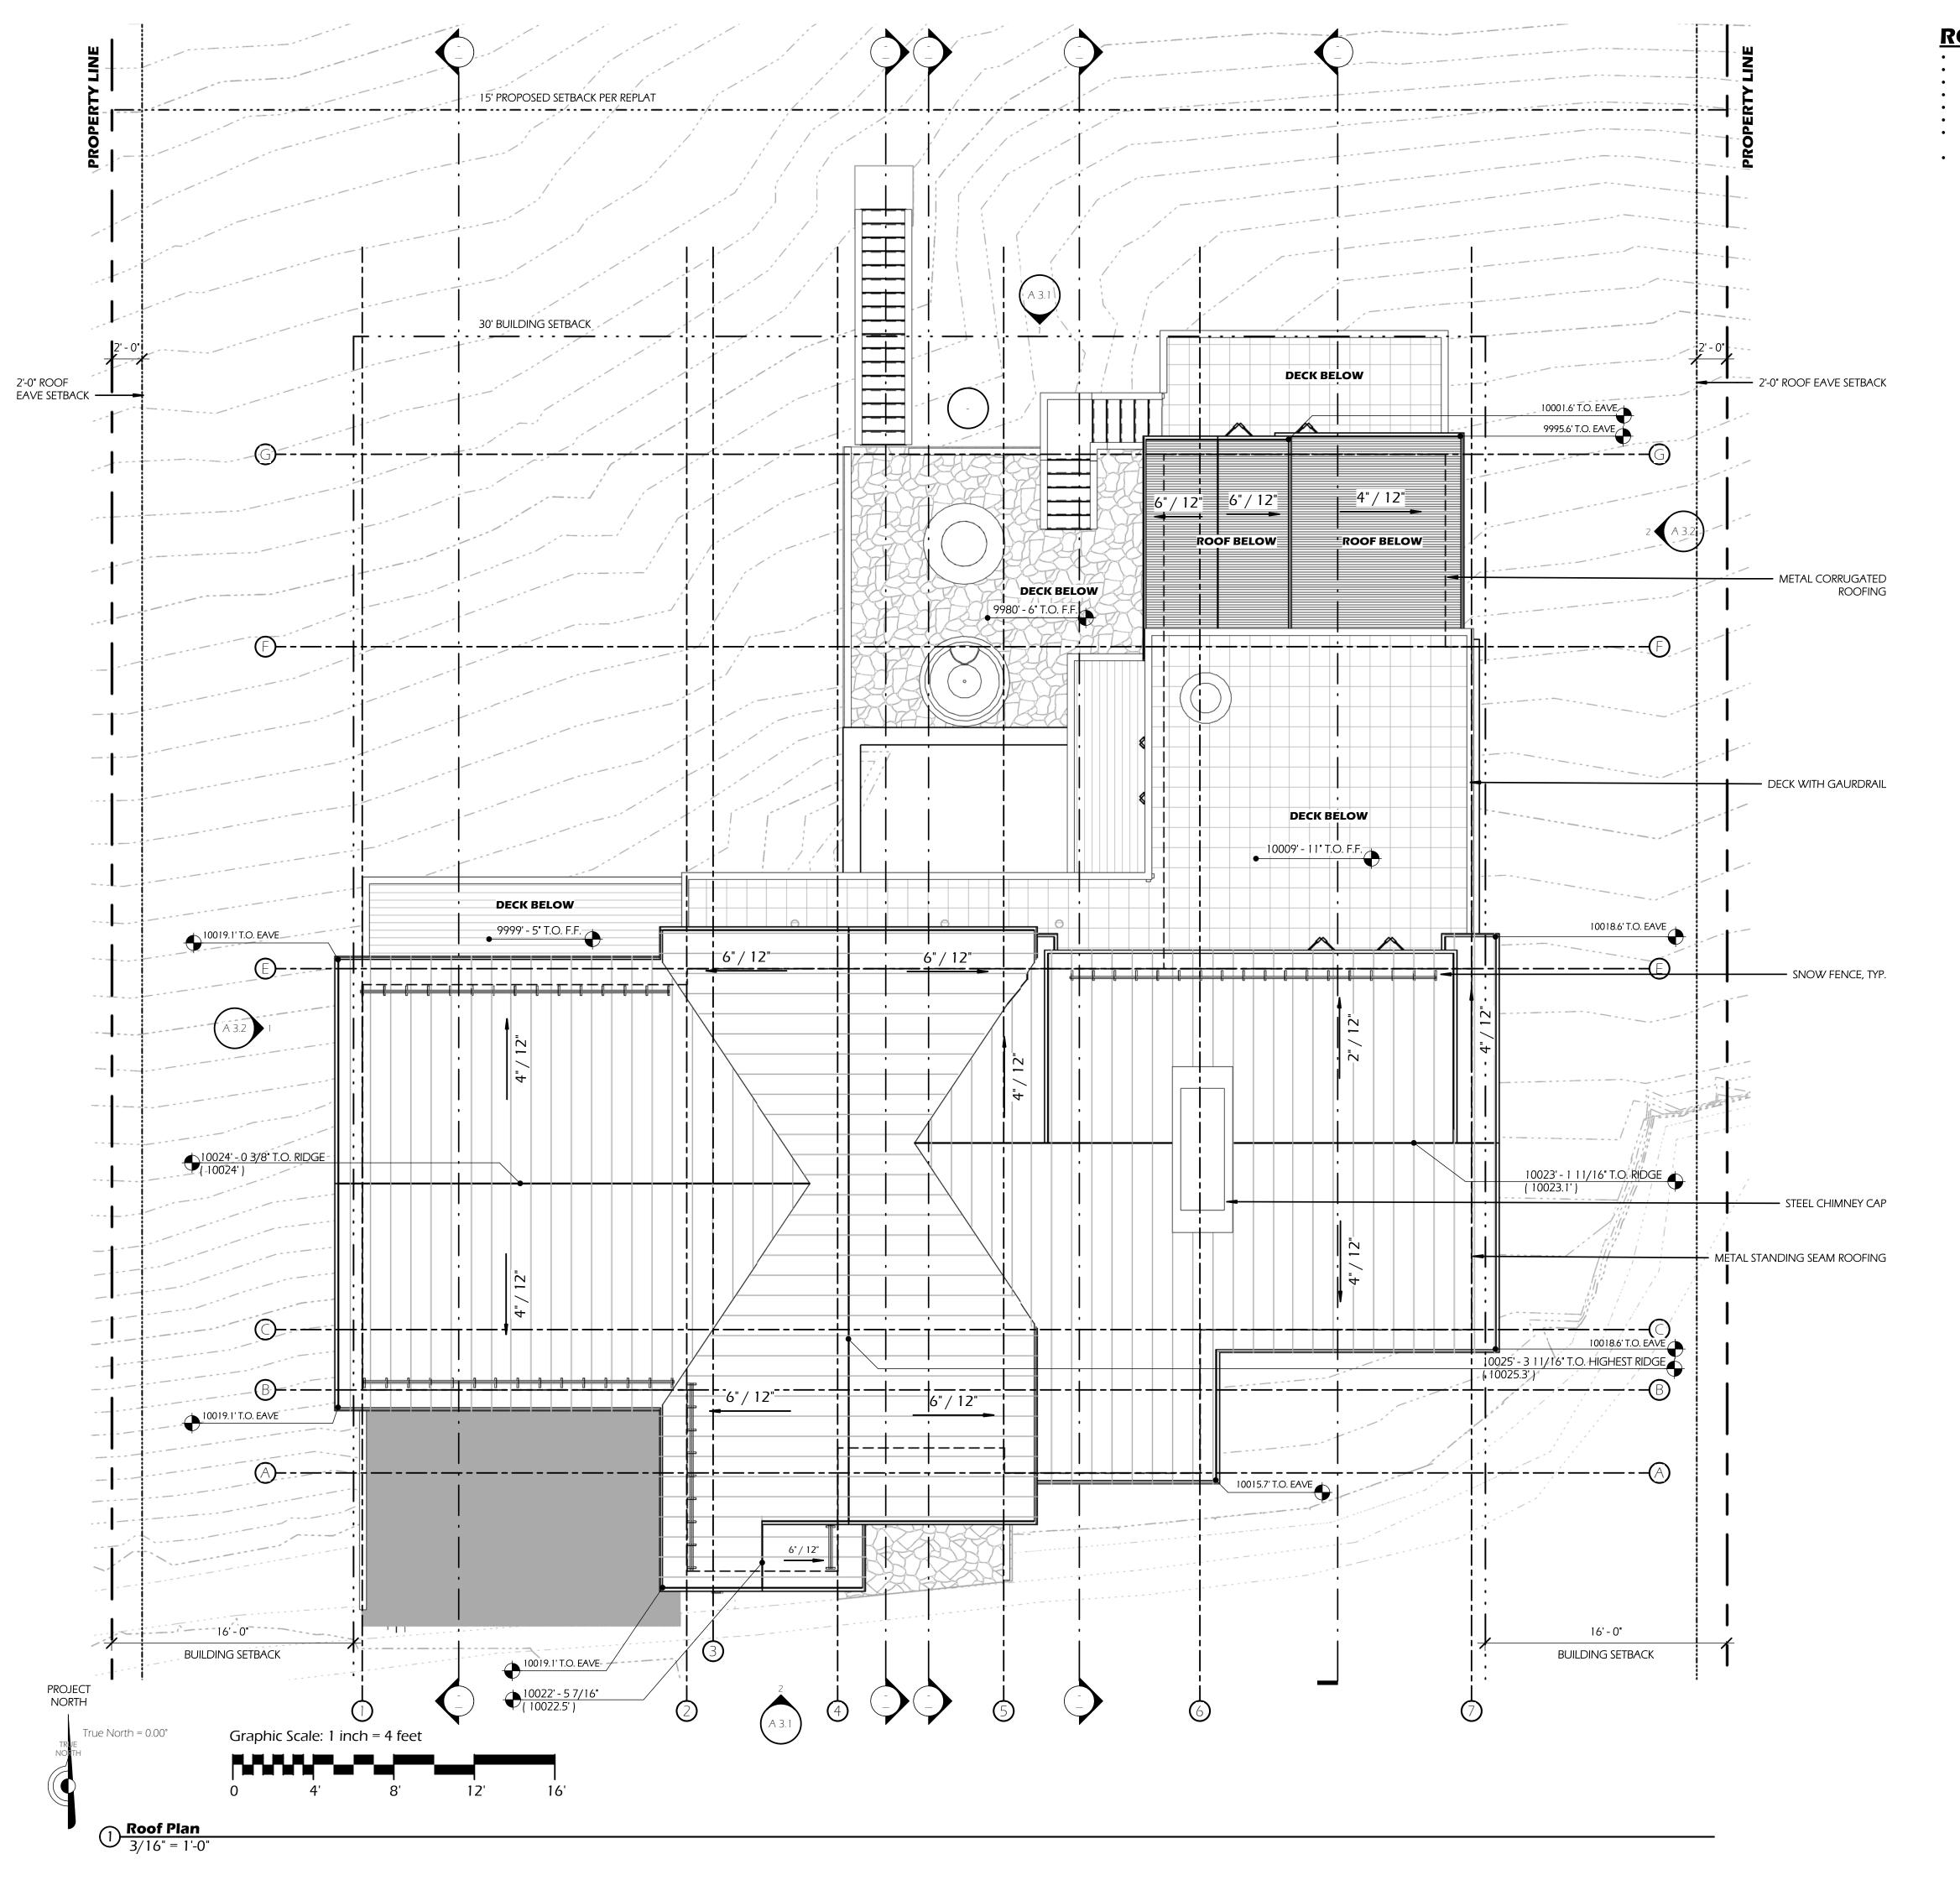

ROOF PLAN NOTES:

- SOUND BATT INSULATION AT ALL INTERIOR WALLS & FLOOR, TYP.
- SEE A5 SERIES FOR STAIR DETAILS SEE A7 FOR ALL ASSEMBLY DETAILS
- ALL FURRING ON CONCRETE WALLS SHOWN @ 2", U.N.O.
- ALL EXTERIOR FLOORS TO BE 1" BELOW ADJACENT INTERIOR FINISH FLOOR ELEVATION ALL SOFFITS & RIDGES TO BE FULLY SEALED PER DETAILS
- SAFETY GLAZING TO BE PROVIDED AS REQUIRED BY LOCAL CODES, (R308.4) REFER TO A8.1 FOR SPECIFIC WINDOWS & DOORS LOCATIONS THAT REQUIRE SAFETY GLAZING
 - EAVE OUTLOOK DIMENSIONS SHOWN ON BUILDING SECTIONS



701 ANACAPASTREET 805.729.4276

PROJECT TEAM

PROPERTY OWNER

Steven Rosenberg 13520 Hesby Street Sherman Oaks, CA 91423

ARCHITECT

Architect: Dylan Henderson Associate Architect: Brian Flatley 701 Anacapa Street Santa Barbara, CA 93101 Office: 805.729.4276 Cell: 970.708.4795 e-mail: dylan@saltarchitect.com

SURVEYOR San Juan Surveying

102 Society Drive Telluride, CO 81435 Office: 970-728-1128

STRUCTURAL ENG.

MECHANICAL ENG.

PROJECT DESCRIPTION

4 Level - 4 Bedroom, 4 Full Bath, 1 Powder

PROJECT ZONING

Zoning District - Single Family Residence - 2018 IRC Occ. Class R-3

PROJECT LEGAL DESCRIPTION

Lot 166AR2-7 Stonegate 6 Stonegate Drive Town of Mountain Village, CO 81435

Description	Date
IASR Review	10/08/2021


Description


Lot 7

STONEGATE

Roof Plan

Date:	10/08/2021
Drawn by:	DH / BF
Chaskad by	DU / DE

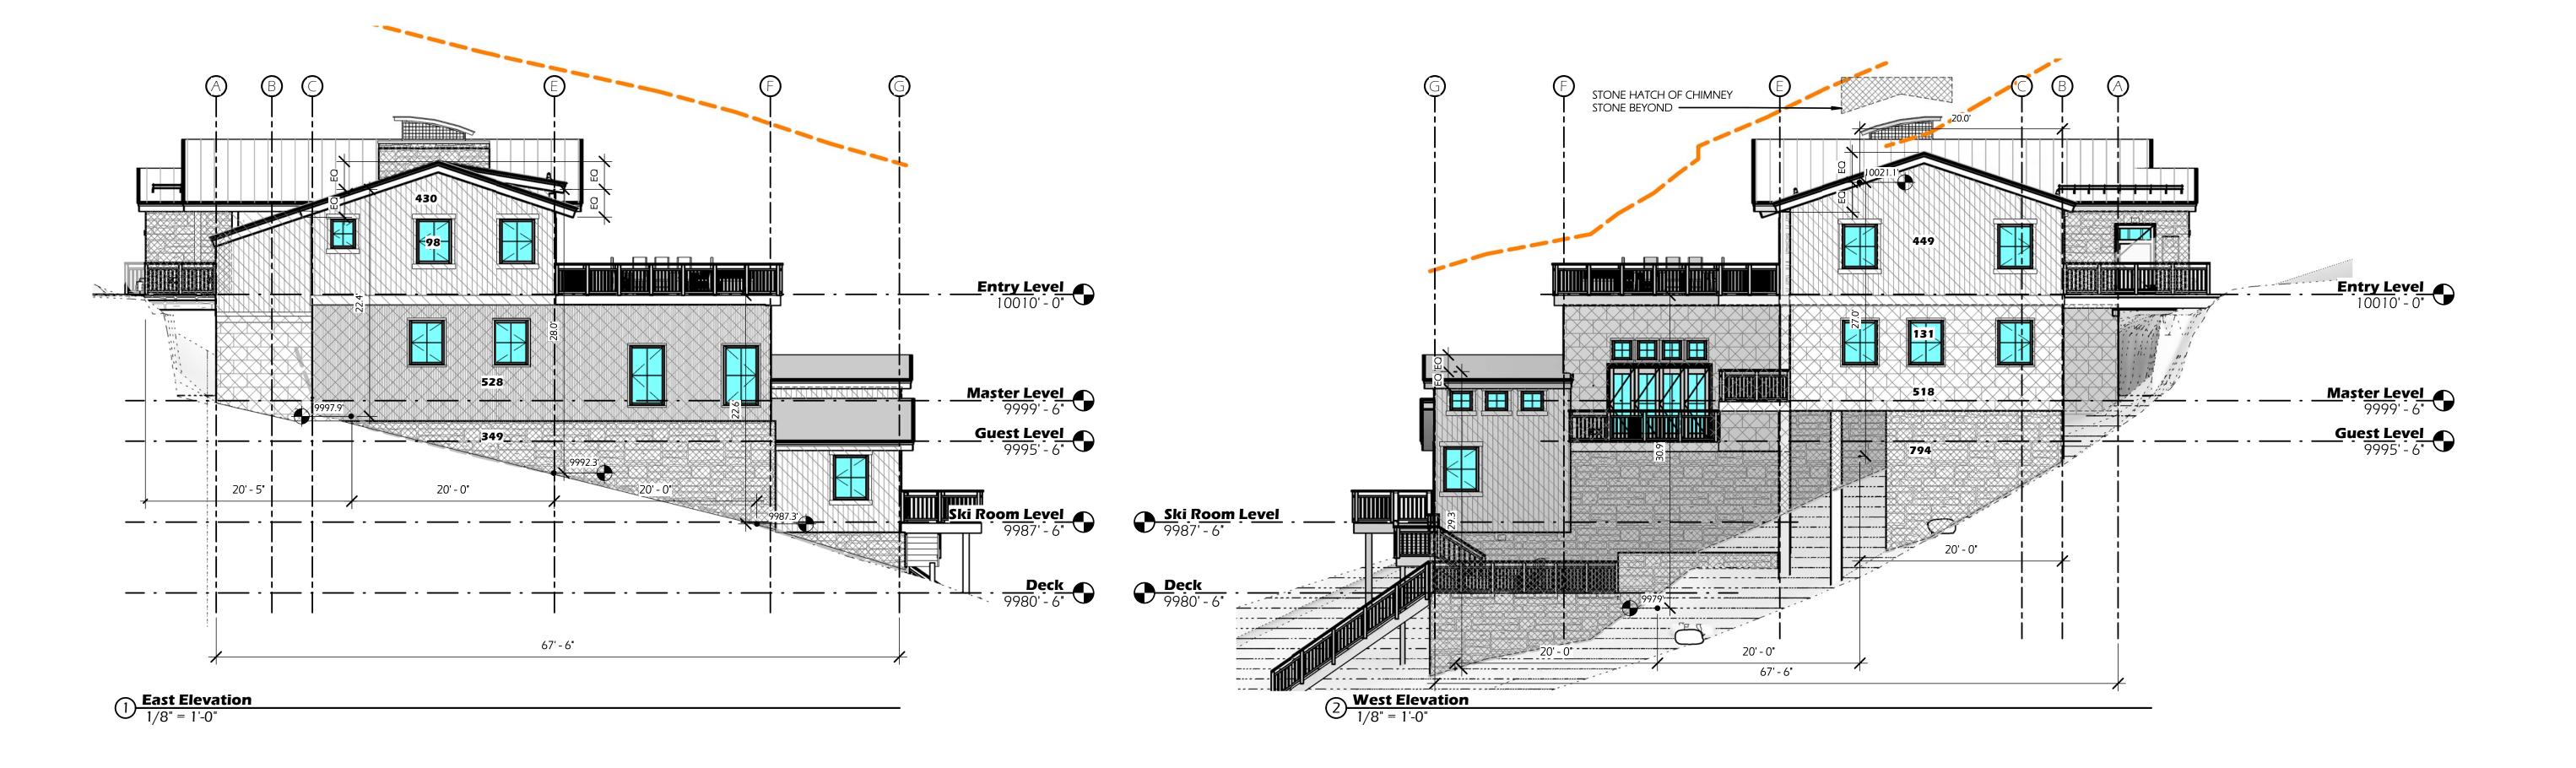

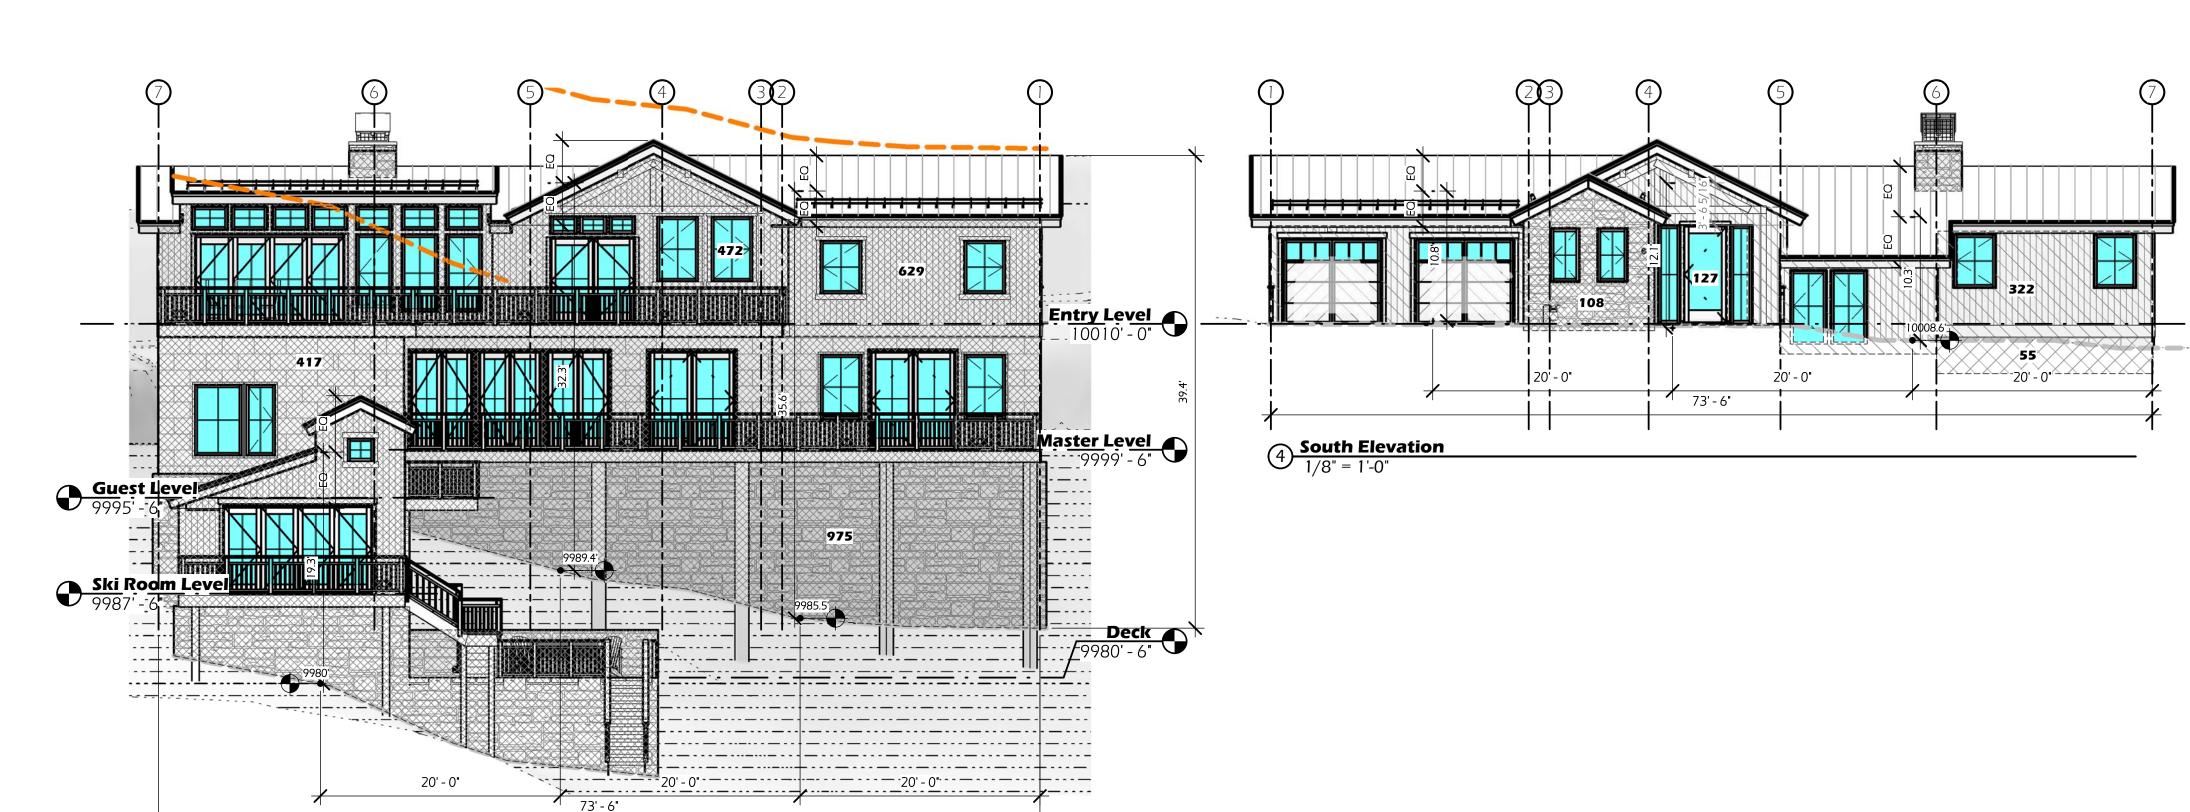

North Elevation1/8" = 1'-0"

EXTERIOR WALL MATERIAL PERCENTAGES NORTH ELEVATION 2,493 PERCENTAGE OF STONE: TOTAL SQ. FT. OF EXTERIOR WALL PERCENTAGE OF STUCCO: TOTAL SQ. FT. OF STONE 975 PERCENTAGE OF WOOD: TOTAL SQ. FT. OF STUCCO PERCENTAGE OF ACCENT MATERIAL: TOTAL SQ. FT. OF WOOD 629 24% PERCENTAGE OF FENESTRATION: TOTAL SQ. FT. OF ACCENT MATERIAL: TOTAL SQ. FT. OF FENESTRATION : 472 TOTAL BUILDING **EAST ELEVATION** TOTAL SQ. FT. OF STONE: TOTAL SQ. FT. OF EXTERIOR WALL 1,405 TOTAL SQ. FT. OF STUCCO: TOTAL SQ. FT. OF STONE 349 TOTAL SQ. FT. OF WOOD: TOTAL SQ. FT. OF STUCCO TOTAL SQ. FT. OF ACCENT MATERIAL: TOTAL SQ. FT. OF WOOD 430 1,518 TOTAL SQ. FT. OF FENESTRATION: TOTAL SQ. FT. OF ACCENT MATERIAL: TOTAL SQ. FT. OF FENESTRATION : **SOUTH ELEVATION** TOTAL SQ. FT. OF EXTERIOR WALL 612 TOTAL SQ. FT. OF STONE TOTAL SQ. FT. OF STUCCO TOTAL SQ. FT. OF WOOD TOTAL SQ. FT. OF ACCENT MATERIAL: TOTAL SQ. FT. OF FENESTRATION : 127 **WEST ELEVATION** TOTAL SQ. FT. OF EXTERIOR WALL 1,892 TOTAL SQ. FT. OF STONE TOTAL SQ. FT. OF STUCCO 449 TOTAL SQ. FT. OF WOOD TOTAL SQ. FT. OF ACCENT MAT. 518 TOTAL SQ. FT. OF FENESTRATION : 131

HEIGHT AVERAGE CALCULATIONS

MATERIAL CALCULATIONS

22.4' + 28.0' + 22.6' + 29.3' + 30.9' + 27.0' + 10.3' + 19.3' + 32.3' + 35.6' = 280.6'

(280.6' / 12) = 23.4 FT AVERAGE HEIGHT

SALT ARCHITECTURE SANTA BARBARA, CA 701 ANACAPASTREET 805.729.4276

PROJECT TEAM

PROPERTY OWNER

Steven Rosenberg 13520 Hesby Street Sherman Oaks, CA 91423

ARCHITECT

Architect: Dylan Henderson Associate Architect: Brian Flatley 701 Anacapa Street Santa Barbara, CA 93101 Office: 805.729.4276 Cell: 970.708.4795

e-mail: dylan@saltarchitect.com SURVEYOR

San Juan Surveying 102 Society Drive Telluride, CO 81435 Office: 970-728-1128

STRUCTURAL ENG.

MECHANICAL ENG.

PROJECT DESCRIPTION

4 Level - 4 Bedroom, 4 Full Bath, 1 Powder Bath

PROJECT ZONING

Zoning District - Single Family Residence - 2018 IRC Occ. Class R-3

PROJECT LEGAL DESCRIPTION

Lot 166AR2-7 Stonegate 6 Stonegate Drive Town of Mountain Village, CO 81435

о.	Drawing Set Description	Issued Date
	IASR Review	10/08/2021
2 3		
3		
1		
5		
o		
7		
3		
7		
0		

Date

Lot 7

Description


STONEGATE

Average Height & Exterior Material Compliance

Date:	10/08/2021
Drawn by:	DH / BF
Checked by:	DH / BF
	-

A 3.0



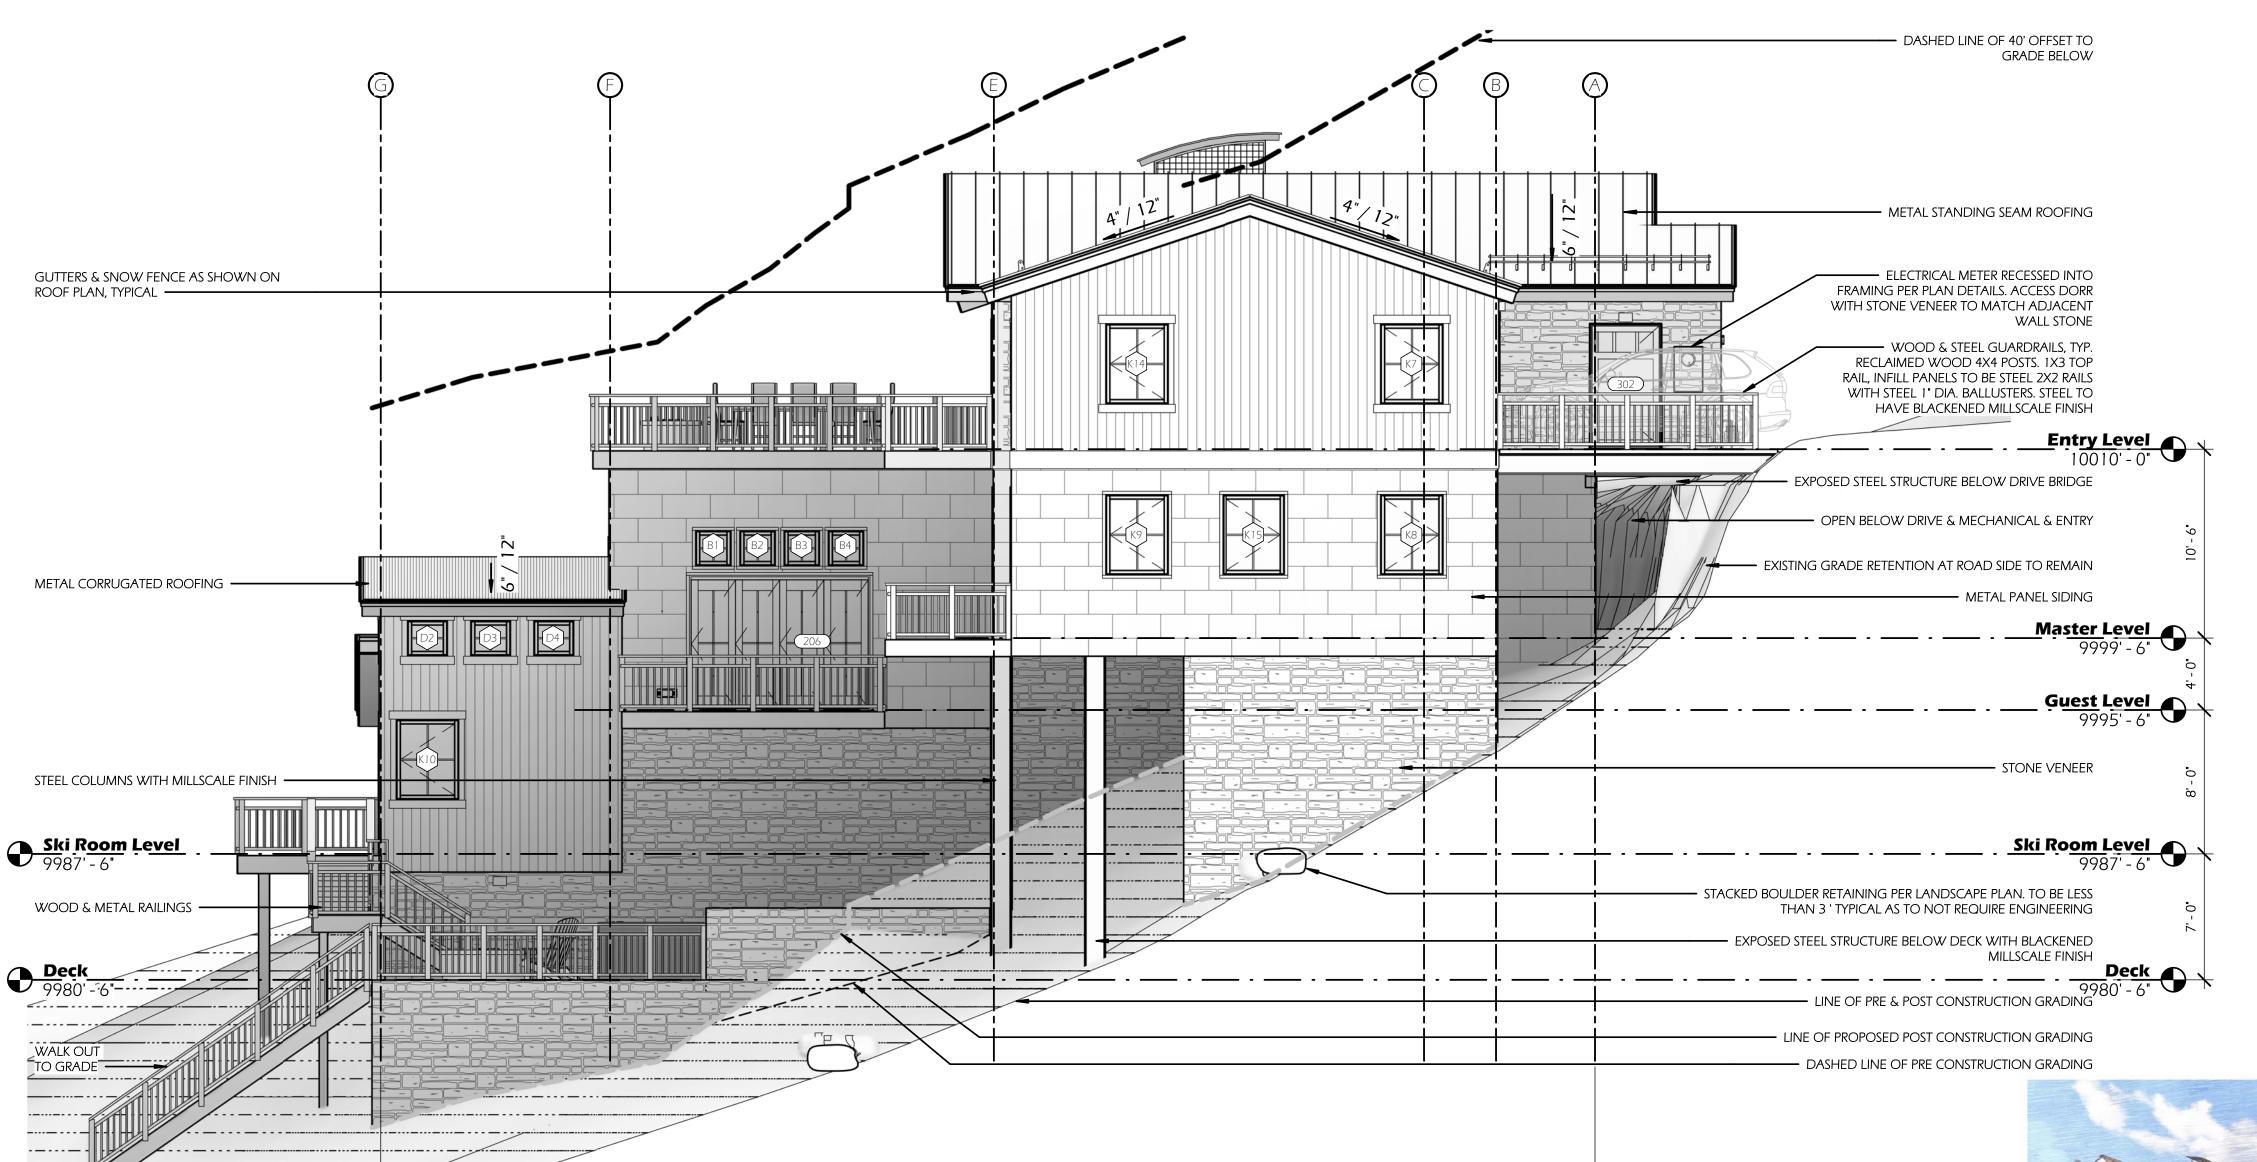

EXTERIOR ELEVATION NOTES:

- ALL MECHANICAL VENTING TO BE PAINTED TO MATCH ADJACENT MATERIALS TO CONCEAL VENTS AS
- ALL WINDOWS & DOORS TO HAVE ALUMINUM CLAD EXTERIORS U.N.O.
- ALL WINDOW & DOORS TO THAT ALE MINDOW CDAD EXTERIORS O.N.O.

 ALL WINDOW & DOOR SDL BARS SHOWN ARE TO BE INTEGRAL & NOT REMOVABLE
- NO ROOF TOP EQUIPMENT SHOWN AS NONE WILL BE INSTALLED
 SEE A8.1 WINDOW & DOOR SCHEDULE FOR HEADER HEIGHTS
- SEE A4 SERIES BUILDING SECTIONS FOR DETAIL LOCATIONS DASHED LINES REPRESENT WINDOW & DOOR OPERATIONS
- LABELS SHOWN ON NEW WINDOWS AND DOORS ONLY, UNLABELED WINDOWS & DOORS ARE EXISTING TO
- REMAIN
 USE GRADES SHOWN AS GUIDES ONLY. FINAL SITE GRADES TO HAVE POSITIVE DRAINAGE AWAY FOR BUILDING AT
 ALL SIDES, WITH REQUIRED MINIMUM 6" CONCRETE FOUNDATION EXPOSED. PROVIDE GRAVEL/ TRENCH DRAINAGE



PROJECT TEAM

PROPERTY OWNER

Steven Rosenberg 13520 Hesby Street Sherman Oaks, CA 91423

ARCHITECT

Architect: Dylan Henderson Associate Architect: Brian Flatley 701 Anacapa Street Santa Barbara, CA 93101 Office: 805.729.4276 Cell: 970.708.4795

e-mail: dylan@saltarchitect.com SURVEYOR

San Juan Surveying 102 Society Drive Telluride, CO 81435

Office: 970-728-1128

STRUCTURAL ENG.

MECHANICAL ENG.

PROJECT DESCRIPTION

4 Level - 4 Bedroom, 4 Full Bath, 1 Powder Bath

PROJECT ZONING

Zoning District - Single Family Residence - 2018 IRC Occ. Class R-3

PROJECT LEGAL DESCRIPTION

Lot 166AR2-7 Stonegate 6 Stonegate Drive Town of Mountain Village, CO 81435

No.	Drawing Set Description	Issued Date
1	IASR Review	10/08/2021
Ż		
3		
4		
5		
6		
7		
8		
9		

Description Date

Lot 7

STONEGATE

Elevations


Date:	10/08/2021
Orawn by:	DH / BF
Thecked by:	DH / BE

A 3.2

As indicated





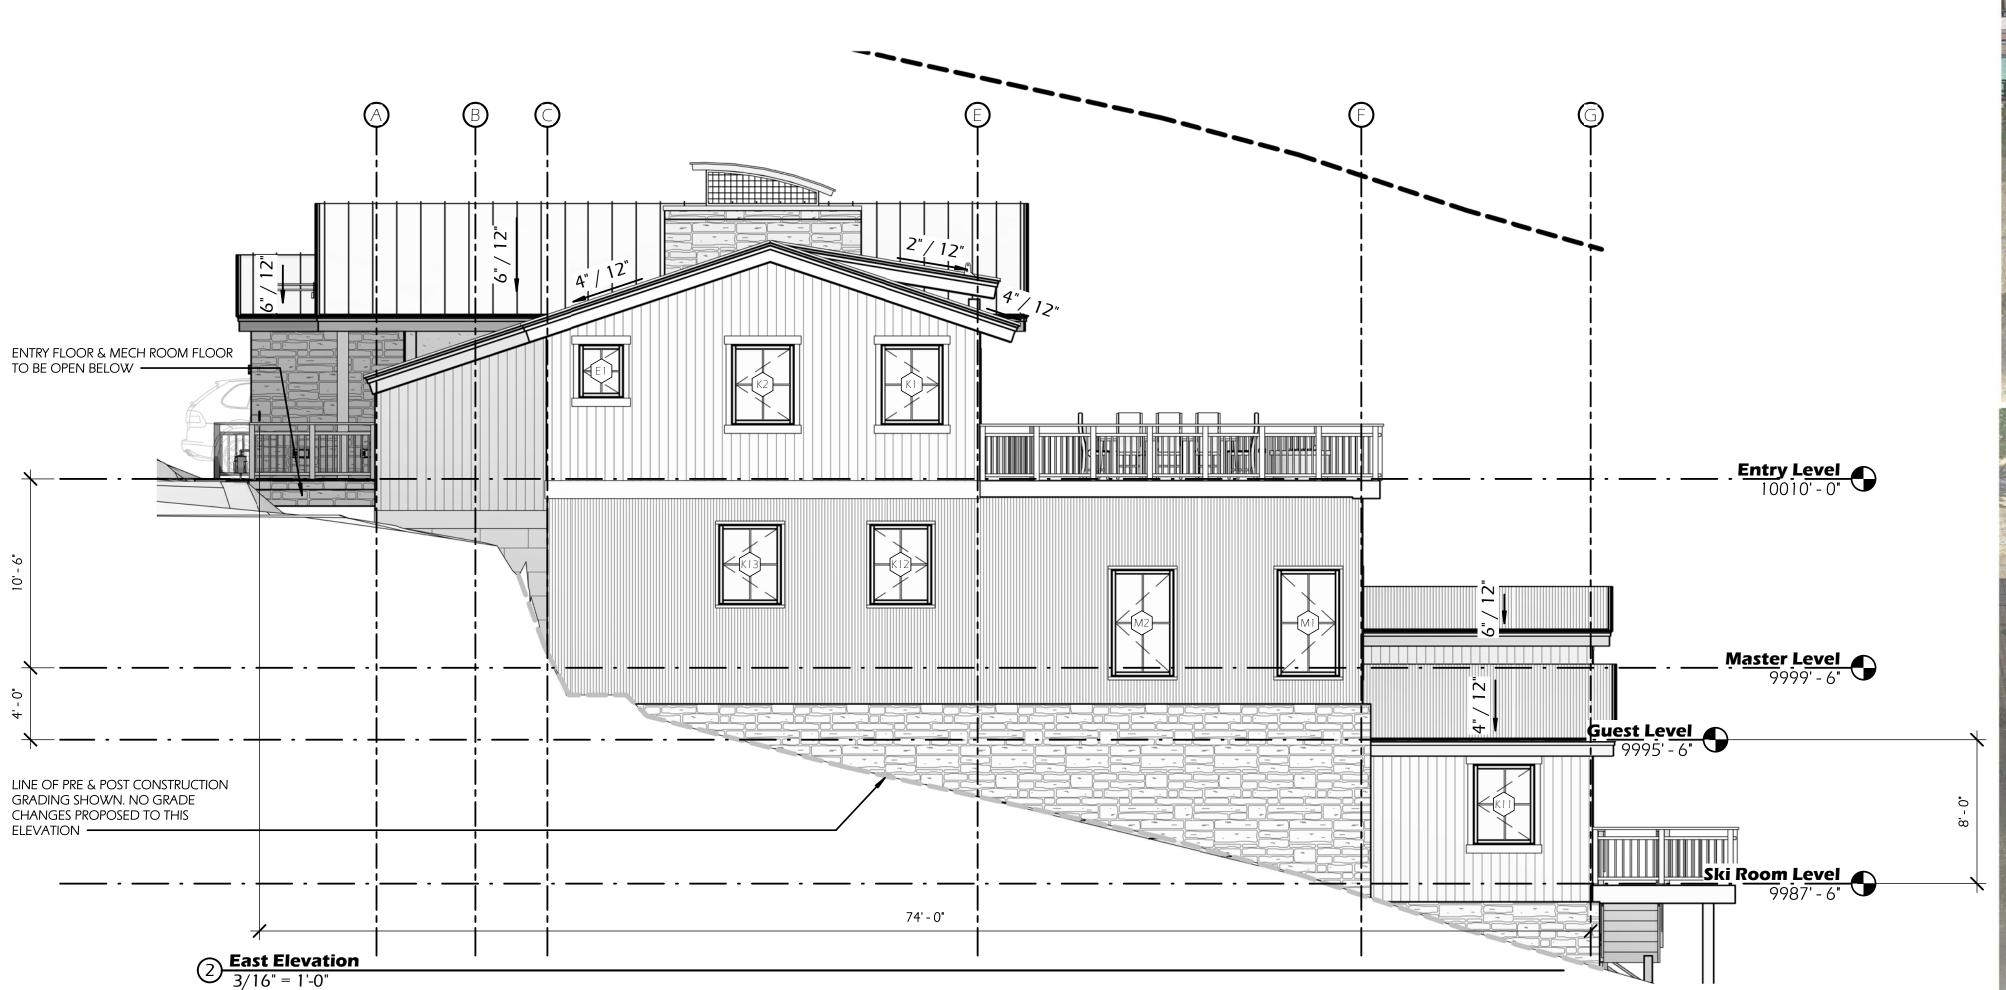

67' - 6**"**

West Elevation3/16" = 1'-0"



BLACK CLAD WINDOWS AND DOORS




EXTERIOR TIMBERS AT ROOFLINE AND TRUSS



TELLURIDE GOLD ASHLAR PATTERN STONE



EXTERIOR DECK RAIL- COLOR TBD

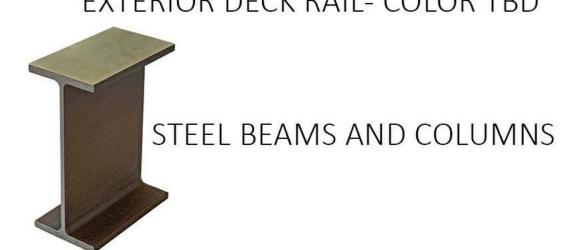

GARAGE DOORS





SALT ARCHITECTURE SANTA BARBARA, CA

701 ANACAPASTREET 805.729.4276

PROPERTY OWNER

Steven Rosenberg 13520 Hesby Street Sherman Oaks, CA 91423

ARCHITECT

Architect: Dylan Henderson Associate Architect: Brian Flatley 701 Anacapa Street Santa Barbara, CA 93101 Office: 805.729.4276 Cell: 970.708.4795 e-mail: dylan@saltarchitect.com

SURVEYOR

San Juan Surveying 102 Society Drive Telluride, CO 81435 Office: 970-728-1128

STRUCTURAL ENG.

MECHANICAL ENG.

PROJECT DESCRIPTION

4 Level - 4 Bedroom, 4 Full Bath, 1 Powder

PROJECT ZONING

Zoning District - Single Family Residence - 2018 IRC Occ. Class R-3

PROJECT LEGAL DESCRIPTION

Lot 166AR2-7 Stonegate 6 Stonegate Drive Town of Mountain Village, CO 81435

No.	Drawing Set Description	Issued Date
1	IASR Review	10/08/202
Ź		
3		
4		
5		
6		
7		
8		
_		

Description

Lot 7

STONEGATE

Exterior Materials Board

10/11/21 DH / BF Checked by: DH / BF


A 3.3



VERTICAL STAINED CEDAR SIDING

LOT 7 STONEGATE MATERIAL BOARD

BONDERIZED METAL SHINGLE SIDING BONDERIZED CORRUGATED SIDING

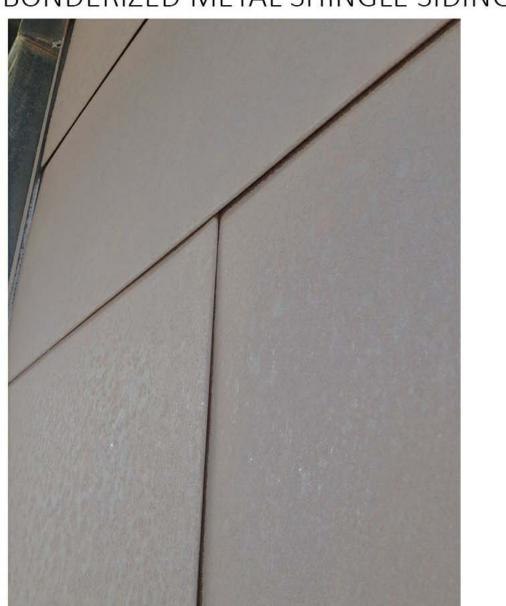



Door Schedule								
ID Mark	Level	Height	Width	Head Height	Sill Height	Comments	Operation	Type Comments
101	Ski Room Level	7' - 6"	12' - 6"	7' - 6"	0"		Fold N Stack w Single Swing Panel	Quad 2/3 Lite Panel Fold N Stack w Single Operable Panel
102	Ski Room Level	7' - 0"	2' - 8"	7' - 0"	0"		Single French - Swing Per Plan	Typical Interior Flush Panel
201	Master Level	8' - 0"	7' - 0"	8' - 0"	0"		Inswing Double French	Exterior Aluminum Clad Double Full Lite Panel
202	Master Level	8' - 0"	7' - 0"	8' - 0"	0"		Inswing Double French	Exterior Aluminum Clad Double Full Lite Panel
203	Master Level	8' - 0"	5' - 0"	8' - 0"	0"		Inswing Double French	Exterior Aluminum Clad Double Full Lite Panel
204	Master Level	8' - 0"	5' - 0"	8' - 0"	0"		Inswing Double French	Exterior Aluminum Clad Double Full Lite Panel
205	Master Level	8' - 0"	5' - 0"	8' - 0"	0"		Inswing Double French	Exterior Aluminum Clad Double Full Lite Panel
206	Guest Level	7' - 6"	10' - 0"	7' - 6"	0"		Fold N Stack w Single Swing Panel	Quad 2/3 Lite Panel Fold N Stack w Single Operable Panel
207	Guest Level	7' - 0"	2' - 8"	7' - 0"	0"		Single French - Swing Per Plan	Typical Interior Flush Panel
208	Guest Level	7' - 0"	2' - 8"	7' - 0"	0"		Single French - Swing Per Plan	Typical Interior Flush Panel
209	Guest Level	7' - 0"	2' - 8"	7' - 0"	0"		Single French - Swing Per Plan	Typical Interior Flush Panel
210	Master Level	7' - 0"	2' - 8"	7' - 0"	0"		Single French - Swing Per Plan	Typical Interior Flush Panel
211	Master Level	7' - 0"	2' - 8"	7' - 0"	0"		Single French - Swing Per Plan	Typical Interior Flush Panel
212	Master Level	7' - 0"	2' - 7 1/4"	7' - 0"	0"		Pocket Slider - See Plan	Typical Interior Full Lite Panel
213	Master Level	7' - 0"	5' - 0"	7' - 0"	0"		Double French - Swing Per Plan	Double Typical Interior 3 Panel
214	Master Level	7' - 0"	2' - 8"	7' - 0"	0"		Single French - Swing Per Plan	Typical Interior Flush Panel
215	Master Level	7' - 0"	2' - 8"	7' - 0"	0"		Single French - Swing Per Plan	Typical Interior Flush Panel
216	Master Level	7' - 0"	2' - 8"	7' - 0"	0"		Single French - Swing Per Plan	Typical Interior Flush Panel
217	Master Level	7' - 0"	5' - 0"	7' - 0"	0"		Open - No Panel	Cased Opening
218	Master Level	7' - 0"	5' - 0"	7' - 0"	0"		Open - No Panel	Cased Opening
219	Master Level	7' - 0"	2' - 8"	7' - 0"	0"		Single French - Swing Per Plan	Typical Interior Flush Panel
220	Master Level	7' - 0"	2' - 8"	7' - 0"	0"		Single French - Swing Per Plan	Typical Interior Flush Panel
221	Master Level	7' - 0"	2' - 8"	7' - 0"	0"		Single French - Swing Per Plan	Typical Interior Flush Panel
222	Master Level	7' - 0"	2' - 8"	7' - 0"	0"		Single French - Swing Per Plan	Typical Interior Flush Panel
223	Master Level	7' - 0"	2' - 8"	7' - 0"	0"		Single French - Swing Per Plan	Typical Interior Flush Panel
301	Entry Level	8' - 0"	3' - 6"	8' - 0"	0"		Inswing Single French	Exterior Aluminum Clad Full Lite Panel
302	Entry Level	7' - 0"	4' - 0"	7' - 0"	0"		Outswing Single French	Exterior Aluminum Clad 2/3 Lite Panel
303	Entry Level	7' - 0"	8' - 0"	7' - 0"	0"		Overhead Track	Garage Door
304	Entry Level	7' - 0"	8' - 0"	7' - 0"	0"		Overhead Track	Garage Door
305	Entry Level	7' - 0"	7' - 0"	7' - 0"	0"		Inswing Double French	Exterior Aluminum Clad Double Full Lite Panel
306	Entry Level	7' - 6"	12' - 6"	7' - 6"	0"		Fold N Stack w Single Swing Panel	Quad 2/3 Lite Panel Fold N Stack w Single Operable Panel
307	Entry Level	7' - 0"	2' - 8"	7' - 0"	0"		Single French - Swing Per Plan	Typical Interior Flush Panel
308	Entry Level	7' - 0"	4' - 6"	7' - 0"	0"		Double French - Swing Per Plan	Double Typical Interior 3 Panel
309	Entry Level	7' - 0"	6' - 0"	7' - 0"	0"		Open - No Panel	Cased Opening
310	Entry Level	7' - 0"	2' - 8"	7' - 0"	0"		Pocket Slider - See Plan	Typical Interior Flush Panel
311	Entry Level	7' - 0"	5' - 0"	7' - 0"	0"		Open - No Panel	Cased Opening
317	Entry Level	7' - 0"	2' - 8"	7' - 0"	0"		Hinged - See Plan	Millwork Panel

EXTERIOR SHEATHING PER STRUCTURAL

CEDAR SHIMS AT ALL WINDOW AND DOOR

WRAP TYVEK STRAIGHT FLASH INTO R.O. TYP

Door Jamb at Wood Siding

3" = 1'-0"

FINISH @

Door Sill At Wood Floor w/ Radiant Heat

6" WIDE GRACE VYCOR OR EQUAL OVER

SEALANT AND BACKER ROD TYP

SIDING PER SPECIFICATION

INSTALLATIONS TYP

NAIL FIN TY

Window Schedule									
ID Mark	Level	Width	Height	Head Height	Sill Height	Type Comments	Operation		
				,					
A1	Entry Level	1' - 10"	8' - 3"	8' - 3"	0"	Casement - 1 Wide	Casement		
A2	Entry Level	1' - 10"	8' - 3"	8' - 3"	O"	Casement - 1 Wide	Casement		
B1	Guest Level	2' - 0"	2' - 0"	10' - 0"	8' - 0"	Casement - 1 Wide	Casement		
B2	Guest Level	2' - 0"	2' - 0"	10' - 0"	8' - 0"	Casement - 1 Wide	Casement		
В3	Guest Level	2' - 0"	2' - 0"	10' - 0"	8' - 0"	Casement - 1 Wide	Casement		
B4	Guest Level	2' - 0"	2' - 0"	10' - 0"	8' - 0"	Casement - 1 Wide	Casement		
C1	Entry Level	2' - 3"	1'-6"	9' - 0"	7' - 6"	Casement - 1 Wide	Casement		
C2	Entry Level	2' - 3"	1' - 6"	9' - 0"	7' - 6"	Casement - 1 Wide	Casement		
C3	Entry Level	2' - 3"	1'-6"	9' - 0"	7' - 6"	Casement - 1 Wide	Casement		
D1	Ski Room Level	2' - 3"	2' - 0"	13' - 0"	11'-0"	Casement - 1 Wide	Casement		
D2	Ski Room Level	2' - 3"	2' - 0"	13' - 0"	11'-0"	Casement - 1 Wide	Casement		
D3	Ski Room Level	2' - 3"	2' - 0"	13' - 0"	11'-0"	Casement - 1 Wide	Casement		
D4	Ski Room Level	2' - 3"	2' - 0"	13' - 0"	11'-0"	Casement - 1 Wide	Casement		
E1	Entry Level	2' - 6"	3' - 0"	7' - 6"	4' - 6"	Casement - 1 Wide	Casement		
F1	Entry Level	2' - 6"	4' - 6"	8' - 0"	3' - 6"	Casement - 1 Wide	Casement		
F2	Entry Level	2' - 6"	4' - 6"	8' - 0"	3' - 6"	Casement - 1 Wide	Casement		
G1	Guest Level	2' - 6"	6' - 0"	9' - 6"	3' - 6"	Casement - 1 Wide	Casement		
H1	Entry Level	3' - 0"	2' - 0"	9' - 10"	7' - 10"	Casement - 1 Wide	Casement		
H2	Entry Level	3' - 0"	2' - 0"	9' - 10"	7' - 10"	Casement - 1 Wide	Casement		
H3	Entry Level	3' - 0"	2' - 0"	9' - 10"	7' - 10"	Casement - 1 Wide	Casement		
H4	Entry Level	3' - 0"	2' - 0"	9' - 10"	7' - 10"	Casement - 1 Wide	Casement		
H5	Entry Level	3' - 0"	2' - 0"	9' - 10"	7' - 10"	Casement - 1 Wide	Casement		
H6	Entry Level	3' - 0"	2' - 0"	9' - 10"	7' - 10"	Casement - 1 Wide	Casement		
H7	Entry Level	3' - 0"	2' - 0"	9' - 10"	7' - 10"	Casement - 1 Wide	Casement		
11	Entry Level	3' - 0"	6' - 0"	4' - 6"	-1' - 6"	Casement - 1 Wide	Casement		
12	Entry Level	3' - 0"	6' - 0"	4' - 6"	-1' - 6"	Casement - 1 Wide	Casement		

	Window Schedule								
ID Mark	Level	Width	Height	Head Height	Sill Height	Type Comments	Operation		
JI	Entry Level	3' - 0"	6' - 6"	7' - 6"	1' - 0"	Casement - 1 Wide	Casement		
J2	Entry Level	3' - 0"	6' - 6"	7' - 6"	1' - 0"	Casement - 1 Wide	Casement		
J3	Entry Level	3' - 0"	6' - 6"	7' - 6"	1'-0"	Casement - 1 Wide	Casement		
K1	Entry Level	3' - 6"	4' - 6"	7' - 6"	3' - 0"	Casement - 1 Wide	Casement		
K2	Entry Level	3' - 6"	4' - 6"	7' - 6"	3' - 0"	Casement - 1 Wide	Casement		
К3	Entry Level	3' - 6"	4' - 6"	7' - 6"	3' - 0"	Casement - 1 Wide	Casement		
K4	Entry Level	3' - 6"	4' - 6"	7' - 6"	3' - 0"	Casement - 1 Wide	Casement		
K5	Entry Level	3' - 6"	4' - 6"	7' - 0"	2' - 6"	Casement - 1 Wide	Casement		
K6	Entry Level	3' - 6"	4' - 6"	7' - 0"	2' - 6"	Casement - 1 Wide	Casement		
K7	Entry Level	3' - 6"	4' - 6"	7' - 0"	2' - 6"	Casement - 1 Wide	Casement		
K8	Master Level	3' - 6"	4' - 6"	8' - 0"	3' - 6"	Casement - 1 Wide	Casement		
K9	Master Level	3' - 6"	4' - 6"	8' - 0"	3' - 6"	Casement - 1 Wide	Casement		
K10	Ski Room Level	3' - 6"	4' - 6"	7' - 6"	3' - 0"	Casement - 1 Wide	Casement		
K11	Ski Room Level	3' - 6"	4' - 6"	6' - 8"	2' - 2"	Casement - 1 Wide	Casement		
K12	Master Level	3' - 6"	4' - 6"	8' - 0"	3' - 6"	Casement - 1 Wide	Casement		
K13	Master Level	3' - 6"	4' - 6"	8' - 0"	3' - 6"	Casement - 1 Wide	Casement		
K14	Entry Level	3' - 6"	4' - 6"	7' - 0"	2' - 6"	Casement - 1 Wide	Casement		
K15	Master Level	3' - 6"	4' - 6"	8' - 0"	3' - 6"	Casement - 1 Wide	Casement		
L1	Entry Level	3' - 6"	5' - 6"	9' - 0"	3' - 6"	Casement - 1 Wide	Casement		
L2	Entry Level	3' - 6"	5' - 6"	9' - 0"	3' - 6"	Casement - 1 Wide	Casement		
L3	Master Level	3' - 6"	5' - 6"	8' - 0"	2' - 6"	Casement - 1 Wide	Casement		
L4	Master Level	3' - 6"	5' - 6"	8' - 0"	2' - 6"	Casement - 1 Wide	Casement		
M1	Guest Level	3' - 6"	6' - 0"	9' - 6"	3' - 6"	Casement - 1 Wide	Casement		
M2	Guest Level	3' - 6"	6' - 0"	9' - 6"	3' - 6"	Casement - 1 Wide	Casement		
N1	Guest Level	4' - 0"	6' - 0"	9' - 6"	3' - 6"	Casement - 1 Wide	Casement		

HEAD HEIGHTS LISTED IN WINDOW SCHEDULE REFERENCE T.O. WINDOW FRAME. BUILDER TO ADD R.O. PER

ALL WINDOWS & DOORS TO HAVE ALUMINUM CLAD EXTERIOR & ARE TO BE INSTALLED PER MANU. INSTRUCTIONS

WINDOW MANUFACTURER RECOMMENDATIONS AND ADJUST HEADER HEIGHTS ACCORDINGLY

NAIL FINS & PENETRATIONS TO BE WRAPPED WITH GRACE ICE & WATER SHIELD OR EQUAL

DOOR & WINDOW NOTES:

Window Head at Wood Siding

3" = 1'-0"

Window Sill at Wood Siding

3" = 1'-0"

LOCAL CODE

EXTERIOR SHEATHING PER STRUCTURAL

1" AIR GAP TO BE MAINTAINED BEHIND MASONRY

2 LAYER ASPHALT IMPREGNATED GRADE

"D" OR CODE REQ WRB

PROJECT TEAM

SALT ARCHITECTURE SANTA BARBARA, CA

701 ANACAPASTREET 805.729.4276

PROPERTY OWNER Steven Rosenberg

13520 Hesby Street Sherman Oaks, CA 91423

ARCHITECT

Architect: Dylan Henderson Associate Architect: Brian Flatley 701 Anacapa Street Santa Barbara, CA 93101 Office: 805.729.4276 Cell: 970.708.4795 e-mail: dylan@saltarchitect.com

San Juan Surveying 102 Society Drive

SURVEYOR

Telluride, ČO 81435 Office: 970-728-1128

STRUCTURAL ENG.

MECHANICAL ENG.

PROJECT DESCRIPTION

4 Level - 4 Bedroom, 4 Full Bath, 1 Powder

PROJECT ZONING

Zoning District - Single Family Residence - 2018 IRC Occ. Class R-3

PROJECT LEGAL DESCRIPTION

Lot 166AR2-7 Stonegate 6 Stonegate Drive Town of Mountain Village, CO 81435

Drawing Set

	LOCAL CODE	No.	Description	Date
	EXTERIOR SHEATHING PER STRUCTURAL	1	IASR Review	10/08/2021
/ / / _	TYVEK HOUSE WRAP OR EQUAL	ż		
	CIDING BED CRECIEICATION	3		
	SIDING PER SPECIFICATION	4		
	CEDAR SHIMS AT ALL WINDOW AND DOOR	5		
	INSTALLATIONS TYP	6		
		7		
		8		
		9		
		10		
			B	
		No.	Description	Date
\	SEALANT AND BACKER ROD TYP			

2x STUD PER STRUC WITH INSULATION

EXTERIOR SHEATHING PER STRUCTURAL

TYVEK OR EQ HOME WRAP

INSULATED HEADER_SIZE PER

WOOD SIDING PER SPECIFICATION

GRACE VYCOR OR EQUAL OVER NAII

SEALANT AND BACKER ROD TY

WRAP TYVEK STRAIGHT FLASH INTO

- CEDAR SHIMS AT ALL WINDOW AND

2x STUD PER STRUC WITH INSULATION PER


DOOR INSTALLATIONS TYP

PER LOCAL CODE

STRUCTURA

METAL FLASHING


FIN TYP

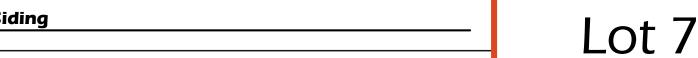

WRAP TYVEK STRAIGHT FLASH INTO R.O. TY

SPECIFICATION

Scale:

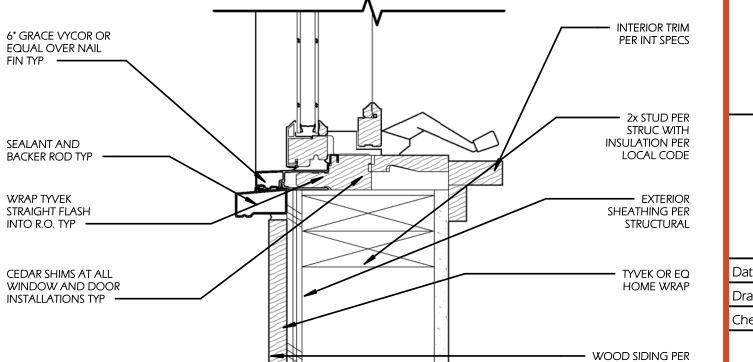



STONEGATE Door & Window


Schedule

10/08/2021 Drawn by: DH / BF Checked by: DH / BF


A 8. As indicated

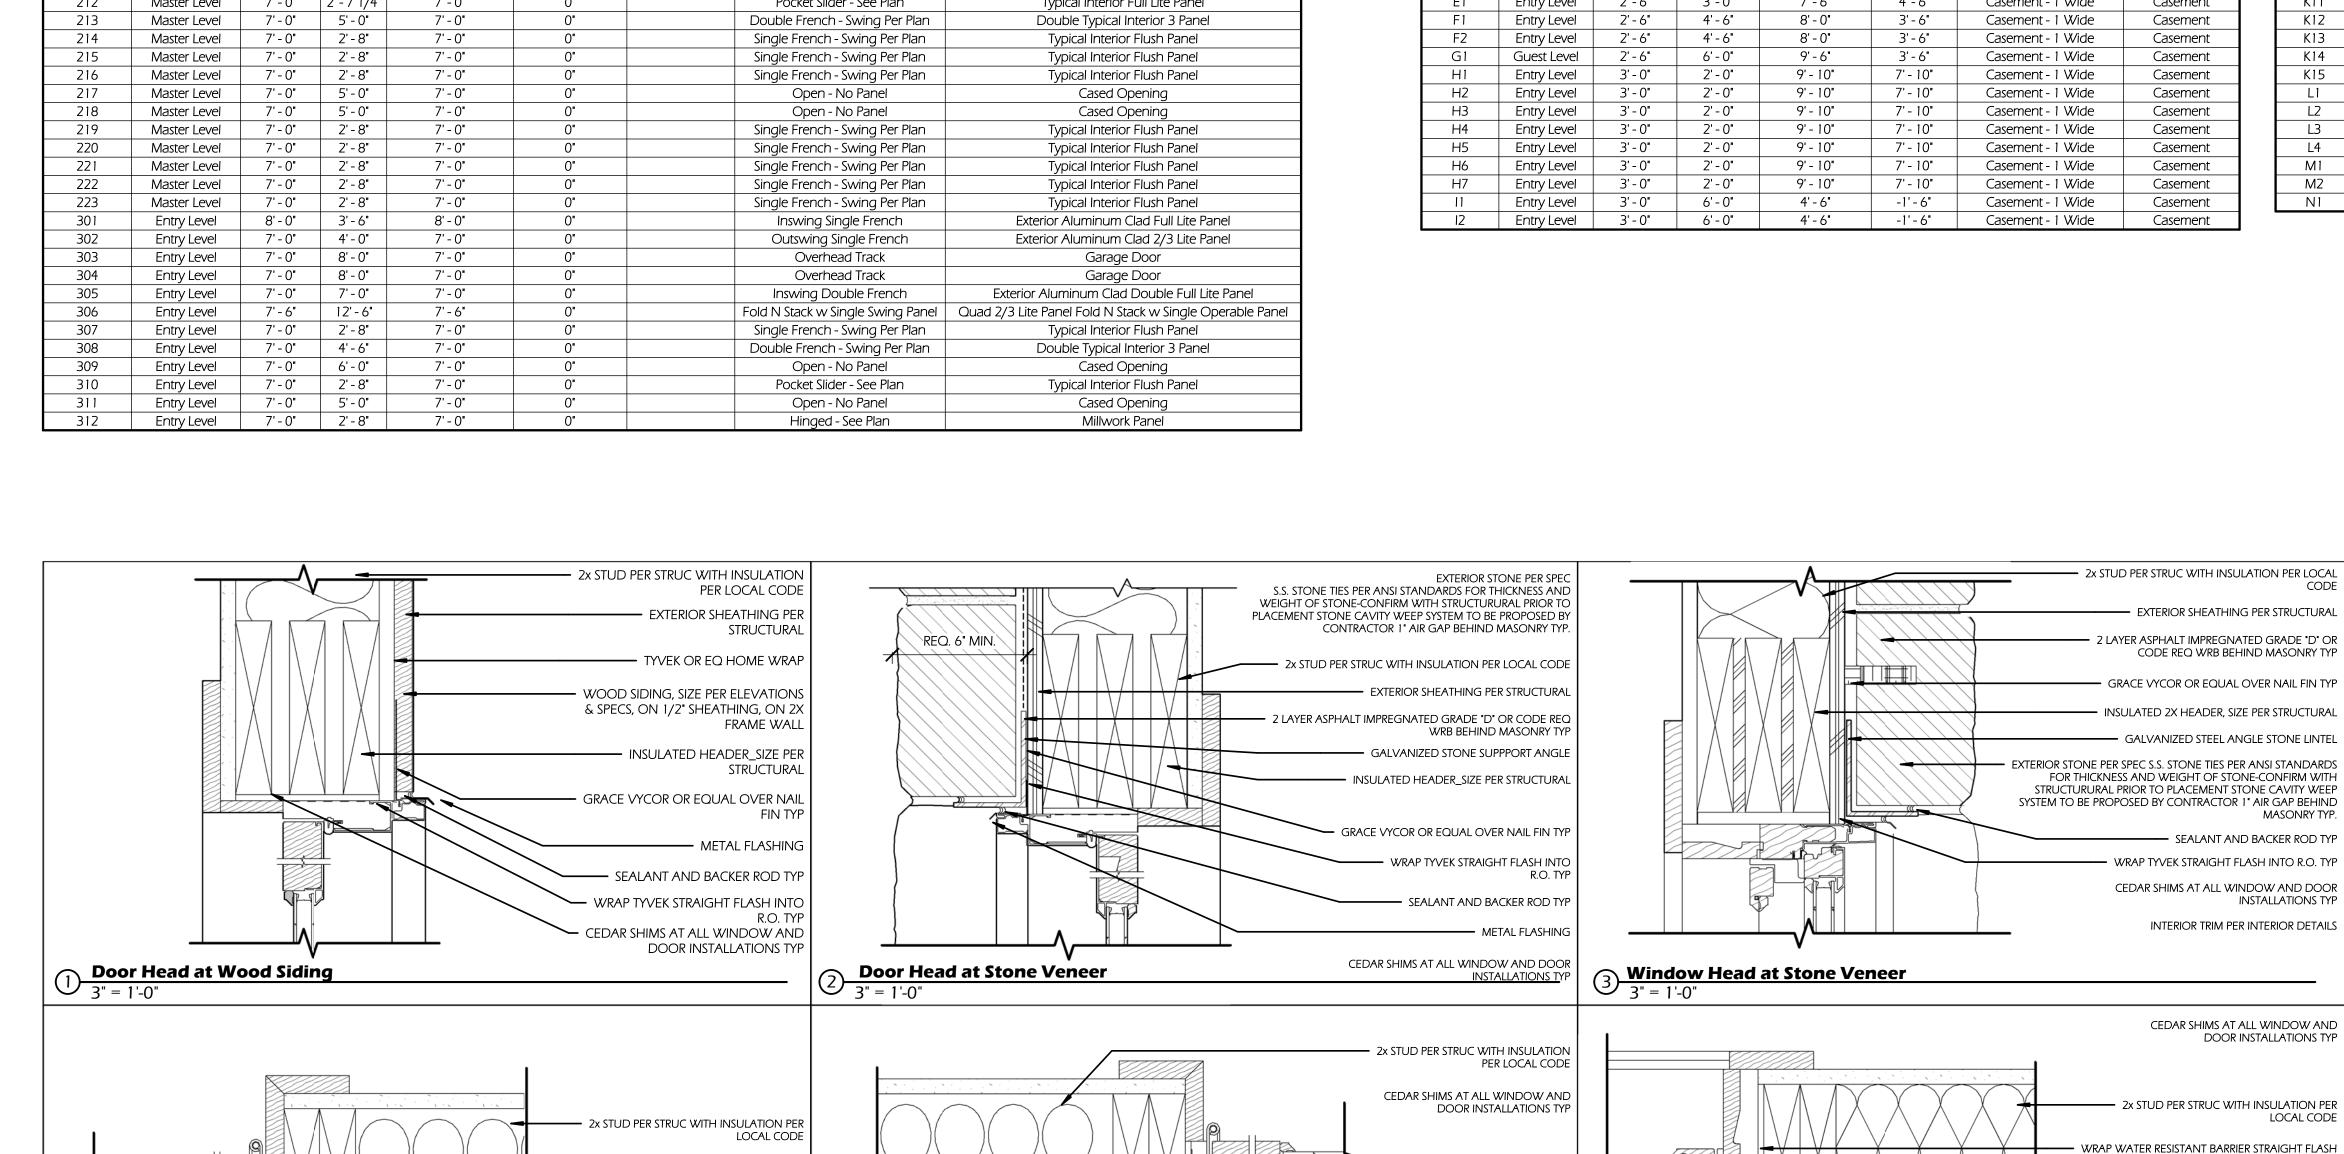

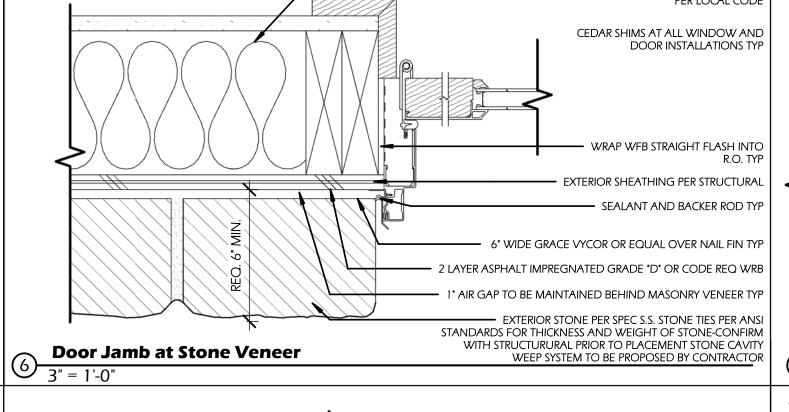

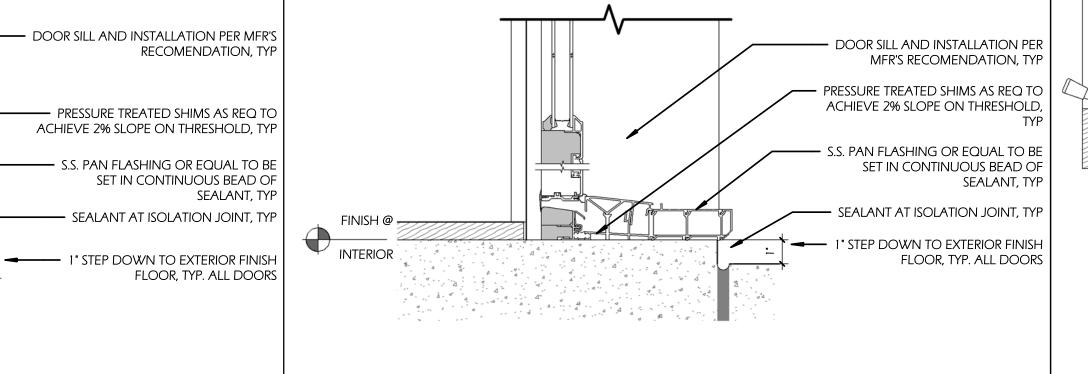

Door Sill At Concrete Slab

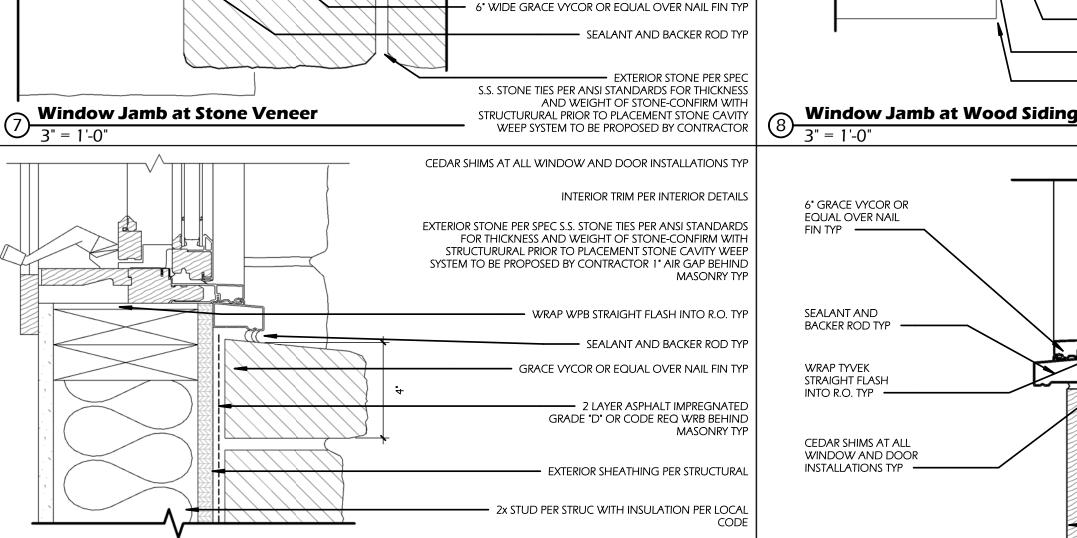

Window Sill at Stone Veneer

3" = 1'-0"

GENERAL CIVIL ENGINEERING NOTES:

1. THE EXISTING UTILITY LINES SHOWN ON THE PLANS ARE APPROXIMATE. AT LEAST TWO (2) FULL WORKING DAYS PRIOR TO TO COMMENCING CONSTRUCTION, THE CONTRACTOR SHALL CONTACT THE UTILITY NOTIFICATION CENTER OF COLORADO @ 1-800-922-1987 OR 811 TO GET ALL UTILITIES LOCATED. IF ANY OF THESE UNDERGROUND UTILITIES ARE IN CONFLICT WITH THE CONSTRUCTION PLANS, THE CONTRACTOR SHALL NOTIFY THE ENGINEER AND WORK WITH THE ENGINEER TO FIND A SOLUTION BEFORE THE START OF CONSTRUCTION.

INSTALLATION AND SEPARATION REQUIREMENTS SHALL BE COORDINATED WITH THE INDIVIDUAL UTILITY PROVIDERS.

THE UTILITY PROVIDERS ARE:
SEWER, WATER, CABLE TV AND FIBEROPTIC: TOWN OF MOUNTAIN VILLAGE
NATURAL GAS: BLACK HILLS ENERGY
POWER: SAN MIGUEL POWER
TELEPHONE: CENTURY LINK

2. PRIOR TO BEGINNING ANY CONSTRUCTION ACTIVITIES, ALL NECESSARY PERMITS SHALL BE OBTAINED BY THE OWNER OR CONTRACTOR.

3. IT IS THE CONTRACTOR'S RESPONSIBILITY TO INSURE THAT EXCAVATED SLOPES ARE SAFE AND COMPLY WITH OSHA REQUIRIEMENTS. REFER TO THE SITE—SPECIFIC REPORT FOR THIS PROJECT FOR ADDITIONAL INFORMATION..

4. ALL TRENCHES SHALL BE ADEQUATELY SUPPORTED OR LAID BACK PER OSHA REGULATIONS.

5. ALL MATERIALS AND CONSTRUCTION SHALL BE IN CONFORMANCE WITH THE TOWN OF MOUNTAIN VILLAGE DESIGN STANDARDS LATEST EDITION. ALL CONSTRUCTION WITHIN EXISTING STREET OR ALLEY RIGHT—OF—WAY SHALL BE SUBJECT TO TOWN OF MOUNTAIN VILLAGE INSPECTION.

6. THE CONTRACTOR SHALL HAVE ONE COPY OF THE STAMPED PLANS ON THE JOB SITE AT ALL TIMES.

7. THE CONTRACTOR SHALL NOTIFY THE TOWN 48 HOURS PRIOR TO THE START OF CONSTRUCTION.

8. THE CONTRACTOR IS RESPONSIBLE FOR IMPLEMENTING AND MAINTAINING EROSION AND SEDIMENT CONTROL MEASURES AT ALL TIMES DURING CONSTRUCTION. THE ADJOINING ROADWAYS SHALL BE FREE OF DEBRIS AT THE END OF CONSTRUCTION ACTIVITIES EACH DAY.

9. THE CONTRACTOR SHALL PROVIDE, ERECT AND MAINTAIN PROPER TRAFFIC CONTROL DEVICES UNTIL THE SITE IS OPEN TO TRAFFIC. ANY TRAFFIC CLOSURES MUST BE COORDINATED WITH THE TOWN OF MOUNTAIN VILLAGE.

10. ALL DAMAGE TO PUBLIC STREETS AND ROADS, INCLUDING HAUL ROUTES, TRAILS, OR STREET IMPROVEMENTS, OR TO PRIVATE PROPERTY, SHALL BE REPAIRED AT THE SOLE EXPENSE OF THE CONTRACTOR TO THE ORIGINAL CONDITIONS.

11. WHEN AN EXISTING ASPHALT STREET IS CUT, THE STREET MUST BE RESTORED TO A CONDITION EQUAL TO OR BETTER THAN ITS ORIGINAL CONDITION. THE FINISHED PATCH SHALL BLEND SMOOTHLY INTO THE EXISTING SURFACE. ALL LARGE PATCHES SHALL BE PAVED WITH AN ASPHALT LAY—DOWN MACHINE.

12. IF DEWATERING IS REQUIRED, THE CONTRACTOR SHALL NOTIFY THE ENGINEER. ANY DISCHARGE REQUIREMENTS SHALL BE COORDINATED WITH THE TOWN OF MOUNTAIN VILLAGE.

13. CONTRACTOR SHALL NOTIFY ALL RESIDENTS IN WRITING 24 HOURS PRIOR TO ANY SHUT-OFF IN SERVICE. THE NOTICES MUST HAVE CONTRACTOR'S PHONE NUMBER AND NAME OF CONTACT PERSON, AND EMERGENCY PHONE NUMBER FOR AFTER HOURS CALLS. ALL SHUT-OFF'S MUST BE APPROVED BY THE TOWN AND TOWN VALVES AND APPURTENANCES SHALL BE OPERATED BY TOWN PERSONNEL.

14. CONTRACTOR SHALL KEEP SITE CLEAN AND LITTER FREE (INCLUDING CIGARETTE BUTTS) BY PROVIDING A CONSTRUCTION DEBRIS TRASH CONTAINER AND A BEAR-PROOF POLY-CART TRASH CONTAINER, WHICH IS TO BE LOCKED AT ALL TIMES.

15. CONTRACTOR MUST BE AWARE OF ALL TREES TO REMAIN PER THE DESIGN AND APPROVAL PROCESS AND PROTECT THEM ACCORDINGLY.

16. THE CONTRACTOR SHALL PROVIDE UNDERGROUND UTILITY AS-BUILTS TO THE TOWN.

17. ALL STRUCTURAL FILL UNDER HARDSCAPE OR ROADS MUST BE COMPACTED TO 95% MODIFIED PROCTOR (MIN.) AT PLUS OR MINUS 2% OF THE OPTIMUM MOISTURE CONTENT. NON—STRUCTURAL FILL SHALL BE PLACED AT 90% (MIN.) MODIFIED PROCTOR.

18. UNSUITABLE MATERIAL SHALL BE REMOVED AS REQUIRED BY THE SOILS ENGINEER. ALL MATERIALS SUCH AS LUMBER, LOGS, BRUSH, TOPSOIL OR ORGANIC MATERIALS OR RUBBISH SHALL BE REMOVED FROM ALL AREAS TO RECEIVE COMPACTED FILL.

19. NO MATERIAL SHALL BE COMPACTED WHEN FROZEN.

20. NATIVE TOPSOIL SHALL BE STOCKPILED TO THE EXTENT FEASIBLE ON THE SITE FOR USE ON AREAS TO BE REVEGETATED.

21. THE CONTRACTOR SHALL BE RESPONSIBLE FOR DUST ABATEMENT AND EROSION CONTROL MEASURES DEEMED NECESSARY BY THE TOWN, IF CONDITIONS WARRANT THEM.


22. ALL DISTURBED GROUND SHALL BE RE-SEEDED WITH A TOWN-APPROVED SEED MIX. REFER TO THE LANDSCAPE PLAN.

23. THE CONTRACTOR IS REQUIRED TO PROTECT ALL EXISTING SURVEY MONUMENTS AND PROPERTY CORNERS DURING GRADING AND CONSTRUCTION.

24. ALL UNDERGROUND PIPE SHALL BE PROTECTED WITH BEDDING TO PROTECT THE PIPE FROM BEING DAMAGED.

25. HOT TUBS SHALL DRAIN TO THE SANITARY SEWER (OR PUMPED TO AA CLEAN-OUT).

26. THE UTILITY PLAN DEPICTS FINAL UTILITY LOCATIONS BUT HAS BEEN COMPLETED AT A PRELIMINARY STAGE. CONTRACTOR SHALL VERIFY ALIGNMENTS WITH THE ARCHITECT PRIOR TO CONSTRUCTION.

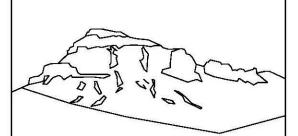

Uncompahgre Engineering, LLC

P.O. Box 3945 Telluride, CO 81435 970-729-0683

SUBMISSIONS:

DRB SUBMITTAL

2021-08-11

Lot 7 Stonegate Mtn. Village, CO



CONTRACTOR TO REVIEW AND COMPARE ALL CHAPTERS AND INTERDISCIPLINARY DRAWINGS AND REPORT ANY DISCREPANCIES TO THE ARCHITECT PRIOR TO ANY FIELD WORK BEING DONE IN ACCORDANCE WITH AIA DOCUMENT A201

Notes

C1

