architect

Town of Mountain Village Sketch Design Review Freeman Residence - Lot 22 The Ridge 11-5-21

The building site is located within the Ridge Development (161D-1 parcel) near the top of the gondola. The home is designed to be a single family detached condominium home on three levels in a traditional alpine vernacular with contemporary references and details. The site is accessible via snow melted electric cart paths only, or via the ski slopes. The home is designed to blend with the surrounding ski area and other homes and respects the natural topography and landscape. The home will have shallow sloping shed roof lines often seen in alpine architecture. It will be built with materials proven to last in a high alpine environment. The primary building forms have been designed to have strong architectural lines and heed the building height restrictions and all of the design regulations.

We are requesting a small rotation in the building envelope to shift out of steeper topography and maximize sun and view angles. The building envelope will not change in size. The rotation will occur around the existing northwest corner of the building envelope.

The driveway/cart path to the site is planned to be connected to the existing HOA snow melted road system. The new HOA road/driveway extension will be approximately 210' long and 10' wide. (2100sf). The residence will require 620 sf of the allowable 1000sf of exterior snowmelt, therefore the bottom 320sf of the access drive can be melted by the residence/cart court area.

The site design includes an outdoor firepit area outside of the building envelope, on Open Space, and is allowable per the regulations. The firepit is half in the envelope and half out of the envelope, approximately 10' outside of the envelope.

Additionally, we would like to request a variance from the requirement of putting up a story pole and light on the site due to the long distance away from the ridge line and the fact that the site is located approximately 160' below the ridge.

FREEMAN RESIDENCE THE RIDGE LOT 22

TOWN OF MOUNTAIN VILLAGE TELLURIDE, COLORADO







MECHINICAL:

BIGHORN CONSULTING ENGINEERS, CO.

M. BLAINE BUCK - Project Manager Phone: 970.241.8709 Email: blaine@bighorneng.com

386 INDIAN RD.

GRAND JUNCTION, CO 81501



OWNER:

JAMES & LISA FREEMAN 1135 Heights Blvd. Houston, TX 77008 713.651.9684 ifreeman@zflawfirm.com

ARCHITECT:

MORTON ARCHITECTS INC. STEVE MORTON - PRINCIPAL

221 S. PINE ST. P.O. BOX 3561 TELLURIDE, CO 81435 970.708.2246

smorton@mortonarchitects.com

STRUCTURAL:

ALPINE EDGE ENGINEERING

Matt Hepp, PE Alpine Edge Engineering 970-318-1469

INTERIOR DESIGN: LINDA EYLES

> 713.520.7426 info@lindaeylesdesign.com

LIGHTING DESIGN: LUMINOSITY

Craig Spring | IALD | IES | LC | LEED AP

www.luminosityald.com

P 970.729.8892 618 Mtn Vlg Blvd, Ste 203A, Mtn Vlg, CO 81435


CONTRACTOR:

NW PARTNERS DOUG GURLEA - Project Manager

Phone: 970.389.4101

Email: DOUG@NWPARTNERS.NET

69 MARKSBERRY WAY BRECKENRIDGE, CO. 80424

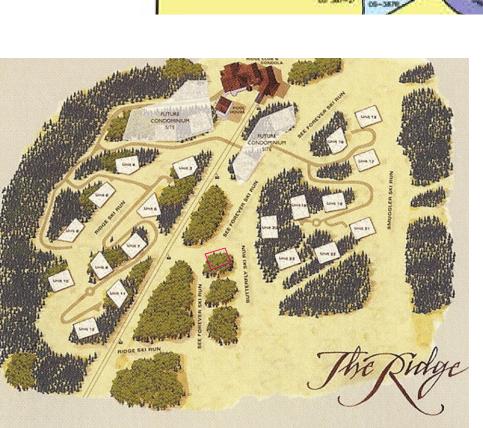

PROJECT SUMMARY - 11.5.21

LOWER LIVING

MAIN LIVING

UPPER LIVING

TOTAL LIVING

TOTAL BUILDABLE

LOWER LEVEL PATIO MAIN LEVEL DECKS

Lot 161-D1 TMV Lot 22

Maximum ht.

Parking req

Maximum avg. ht.

RIDGELINE LOT AREAS

TOTAL EXT. SURFACE 2000 S.F.

TOTAL CART COURT 620 S.F.

GARAGE

SINGLE FAMILY DWELLING UNIT - LOT 22

2,406 S.F.

2,675 S.F.

5,806 S.F.

6,139 S.F.

1000 S.F.

333 S.F.

725 S.F.

COVER SHEET

SURVEYOR PLAT SURVEYOR TOPOGRAPHY

GRADING PLAN TBD DRAINAGE PLAN TBD UTILITY PLAN TBD

A-1.0 SITE PLAN

A-1.2 SITE CONSTRUCTION STAGING PLAN A-1.2B SITE CONSTRUCTION ACCESS PLAN

SITE ROOF PLAN

LOWER LEVEL FLOOR PLAN

EXTERIOR ELEVATIONS EXTERIOR ELEVATIONS PARTIAL

A-3.5m EXTERIOR MATERIAL CALC.S

A-3.7m EXTERIOR MATERIAL CALC.S

DOOR AND WINDOW SCHEDULES

DETAILS

EXTERIOR MATERIALS SAMPLE BOARD

INDEX

3D COLORED RENDERINGS LAND SURVEY

VICINITY MAP

A-1.4 SITE SNOWMELT PLAN

A-2.1 MAIN LEVEL FLOOR PLAN A-2.2 UPPER LEVEL FLOOR PLAN

A-2.4 ROOF PLAN

A-3.0 EXTERIOR ELEVATIONS

EXTERIOR ELEVATIONS

EXTERIOR ELEVATIONS

A-3.6m EXTERIOR MATERIAL CALC.S

A-3.8m EXTERIOR MATERIAL CALC.S

A-4.0 BUILDING SECTIONS

BUILDING SECTIONS

BUILDING SECTIONS

DETAILS

Town Hall

Center Subarea

LANDSCAPE/IRRIGATION PLAN

LOWER LEVEL LIGHTING PLAN

MAIN LEVEL LIGHTING CALC.S

MAIN LEVEL LIGHTING PLAN

LOWER LEVEL LIGHTING CALC.S

FIRE MITIGATION PLAN

LIGHTING DETAIL

without written permission.

precedence over scaled dimensions and shall be verified at the site. Architect prior to the commencement of the work.

FILE NAME JOB NUMBER

11-5-21 preliminary-not for construction

DRB SKETCH SUBMITTAL SET

Site:

plans indicated by these drawings

be brought to the attention of the

XXX DRAWN BY

FREEMAN RESIDENCE THE RIDGE LOT 22

TOWN OF MOUNTAIN VILLAGE TELLURIDE, COLORADO












DRB SKETCH SUBMITTAL SET


11-5-21


preliminary-not for construction

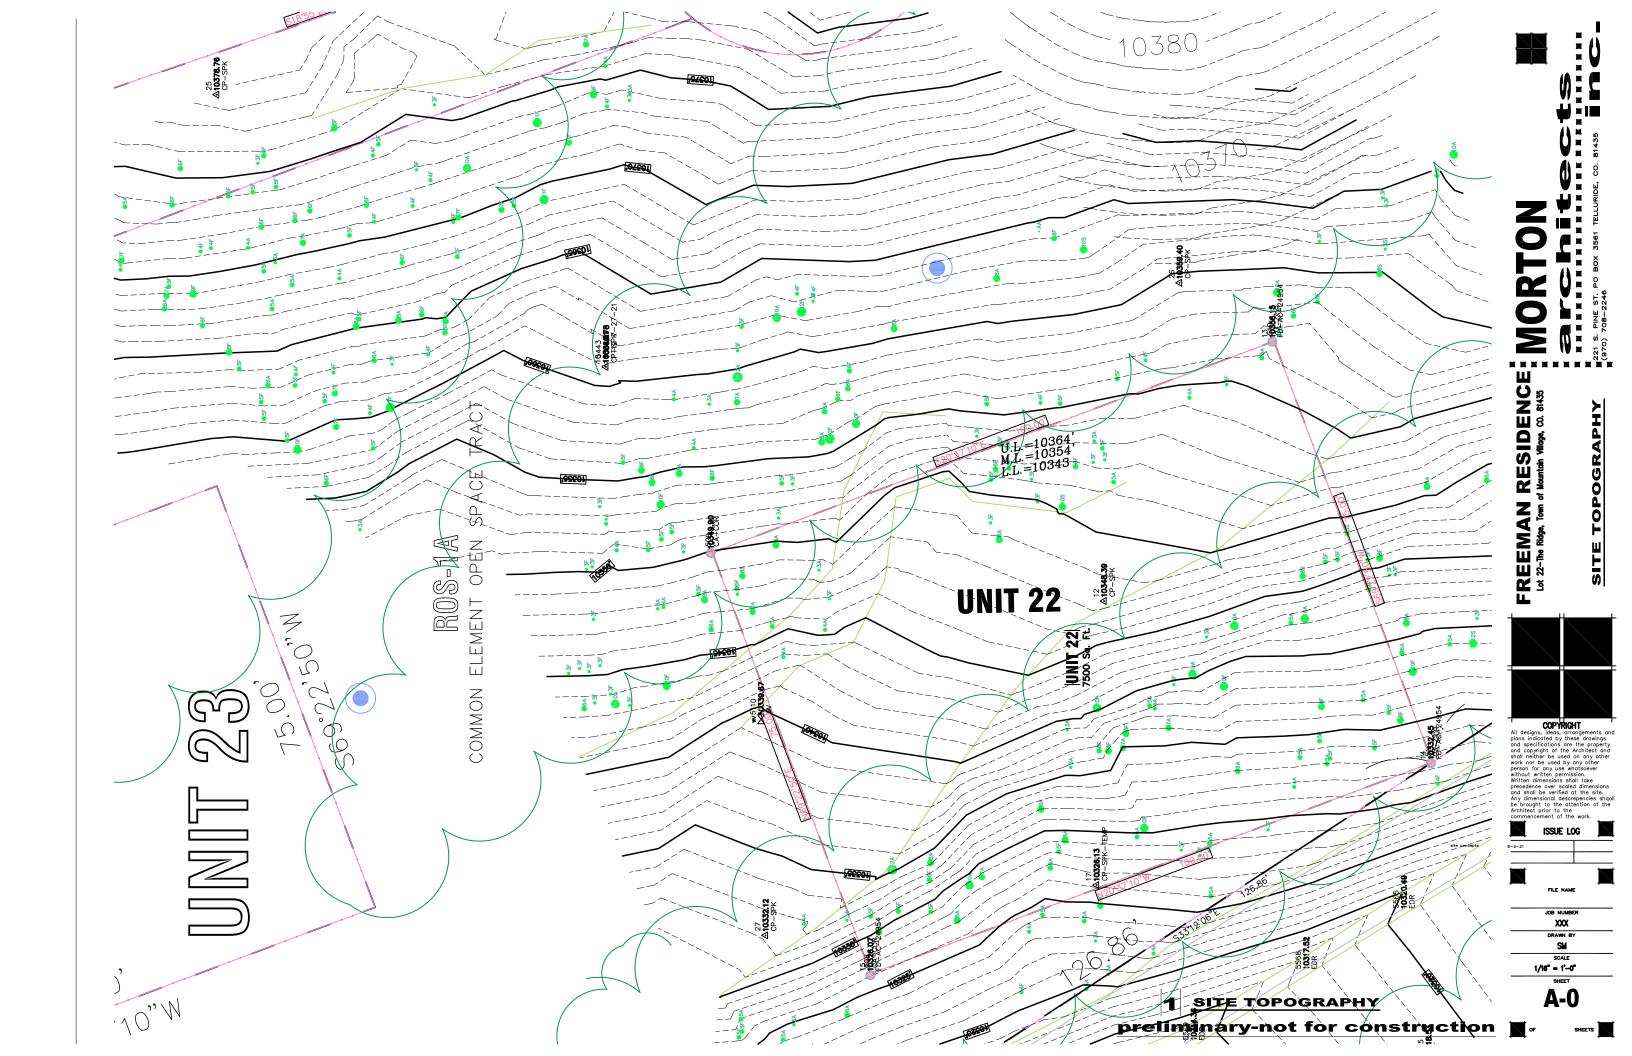


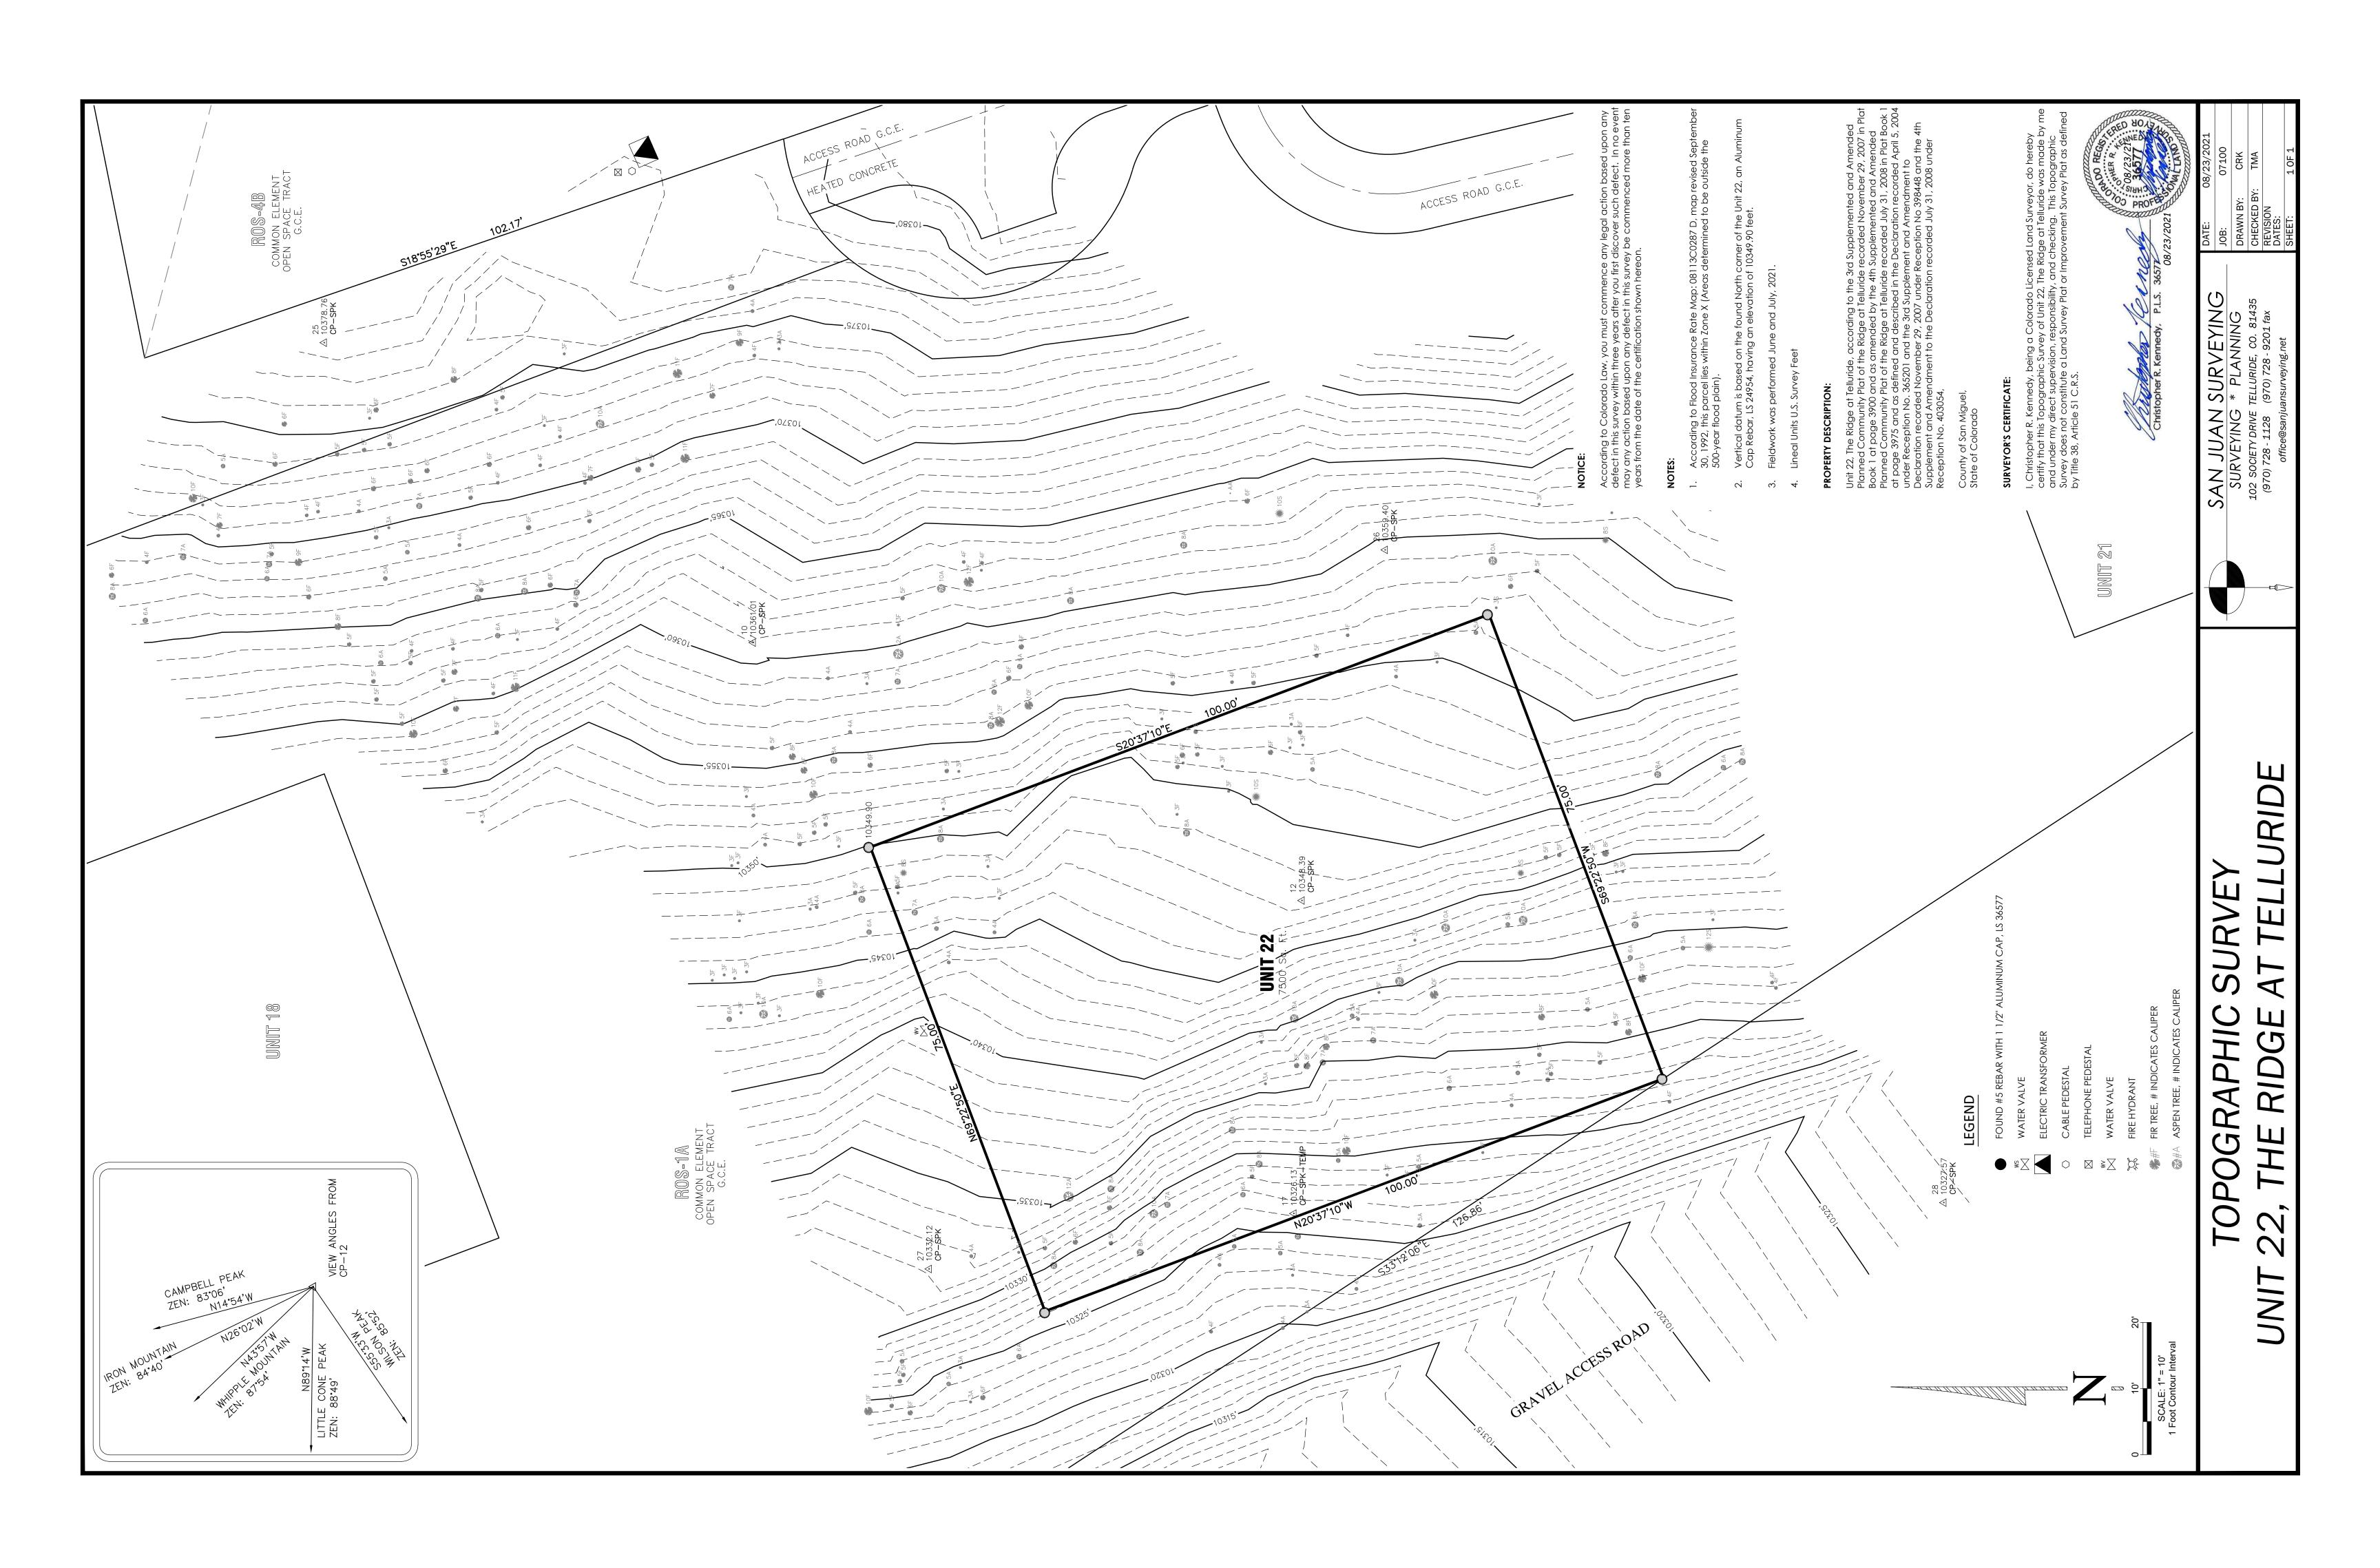


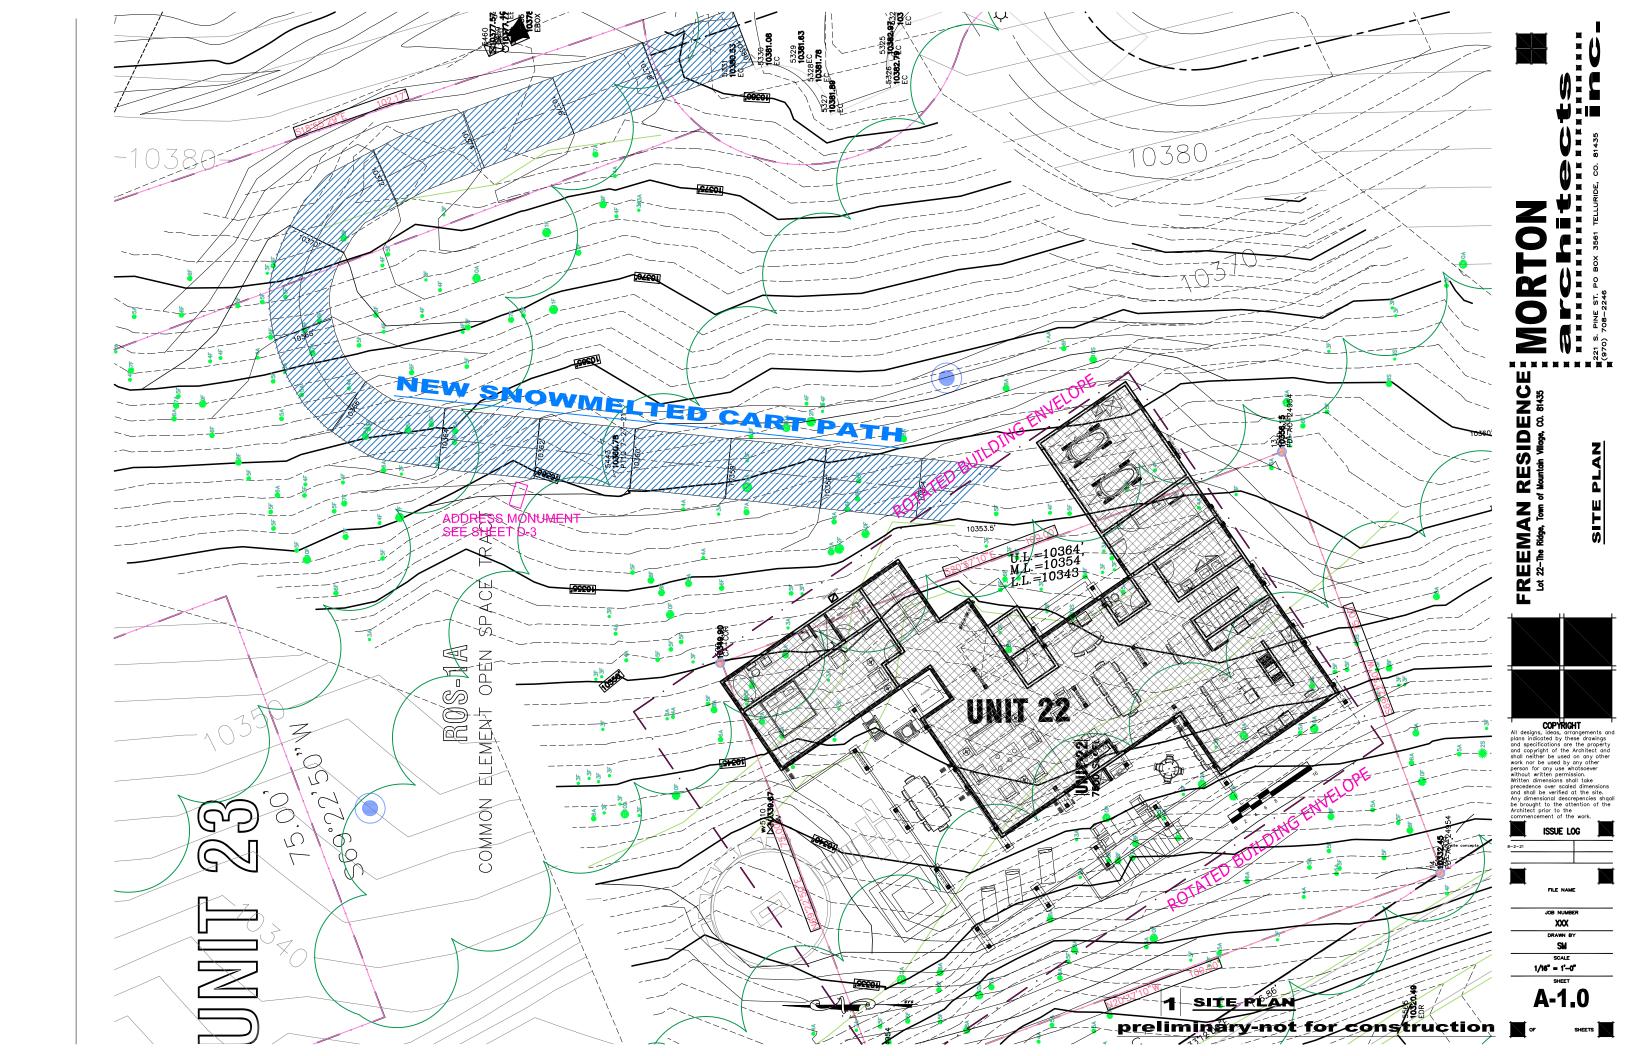


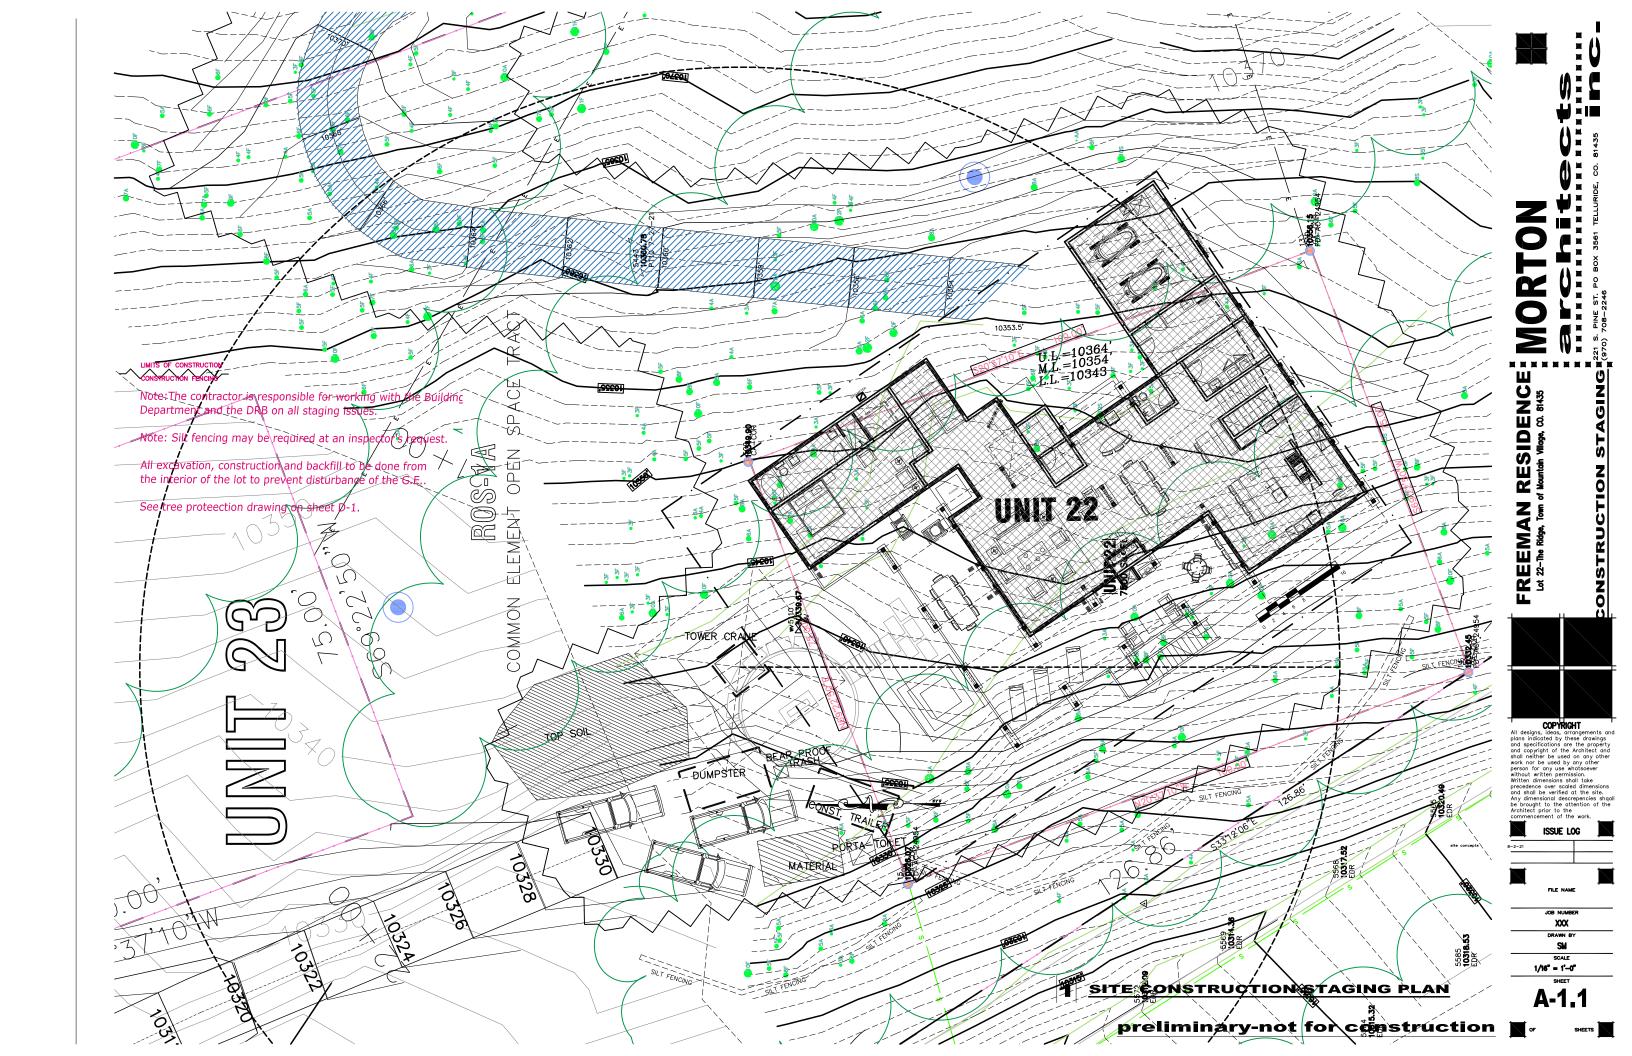


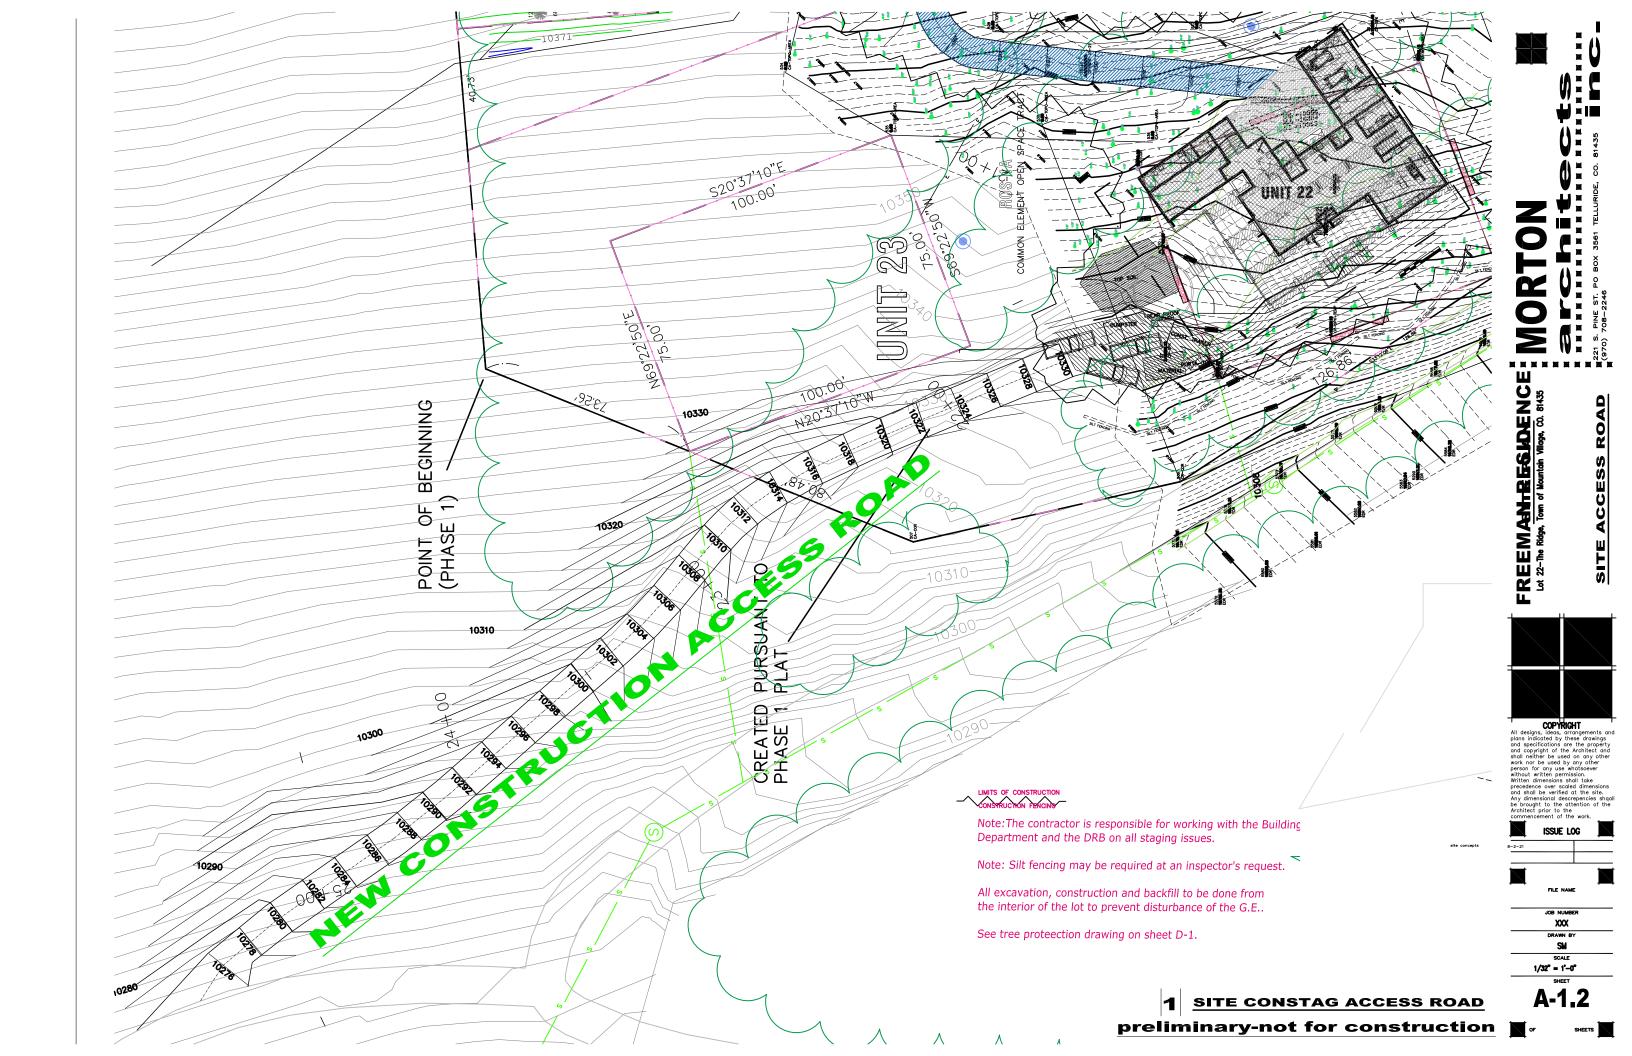


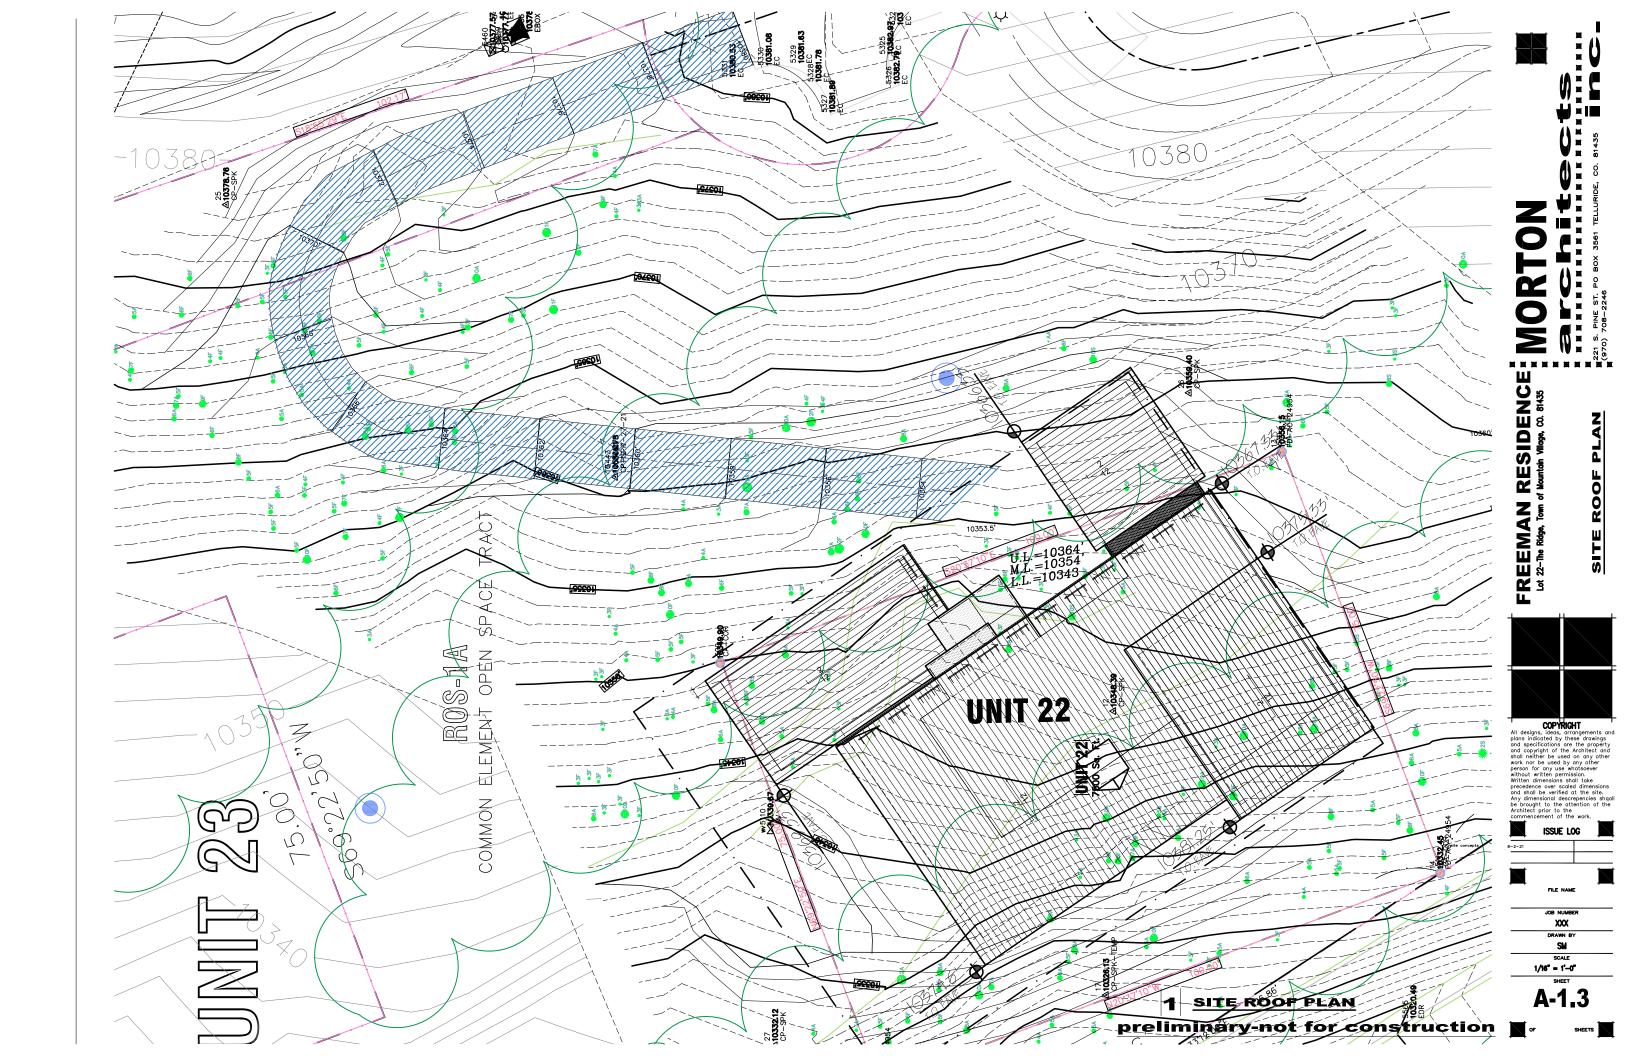


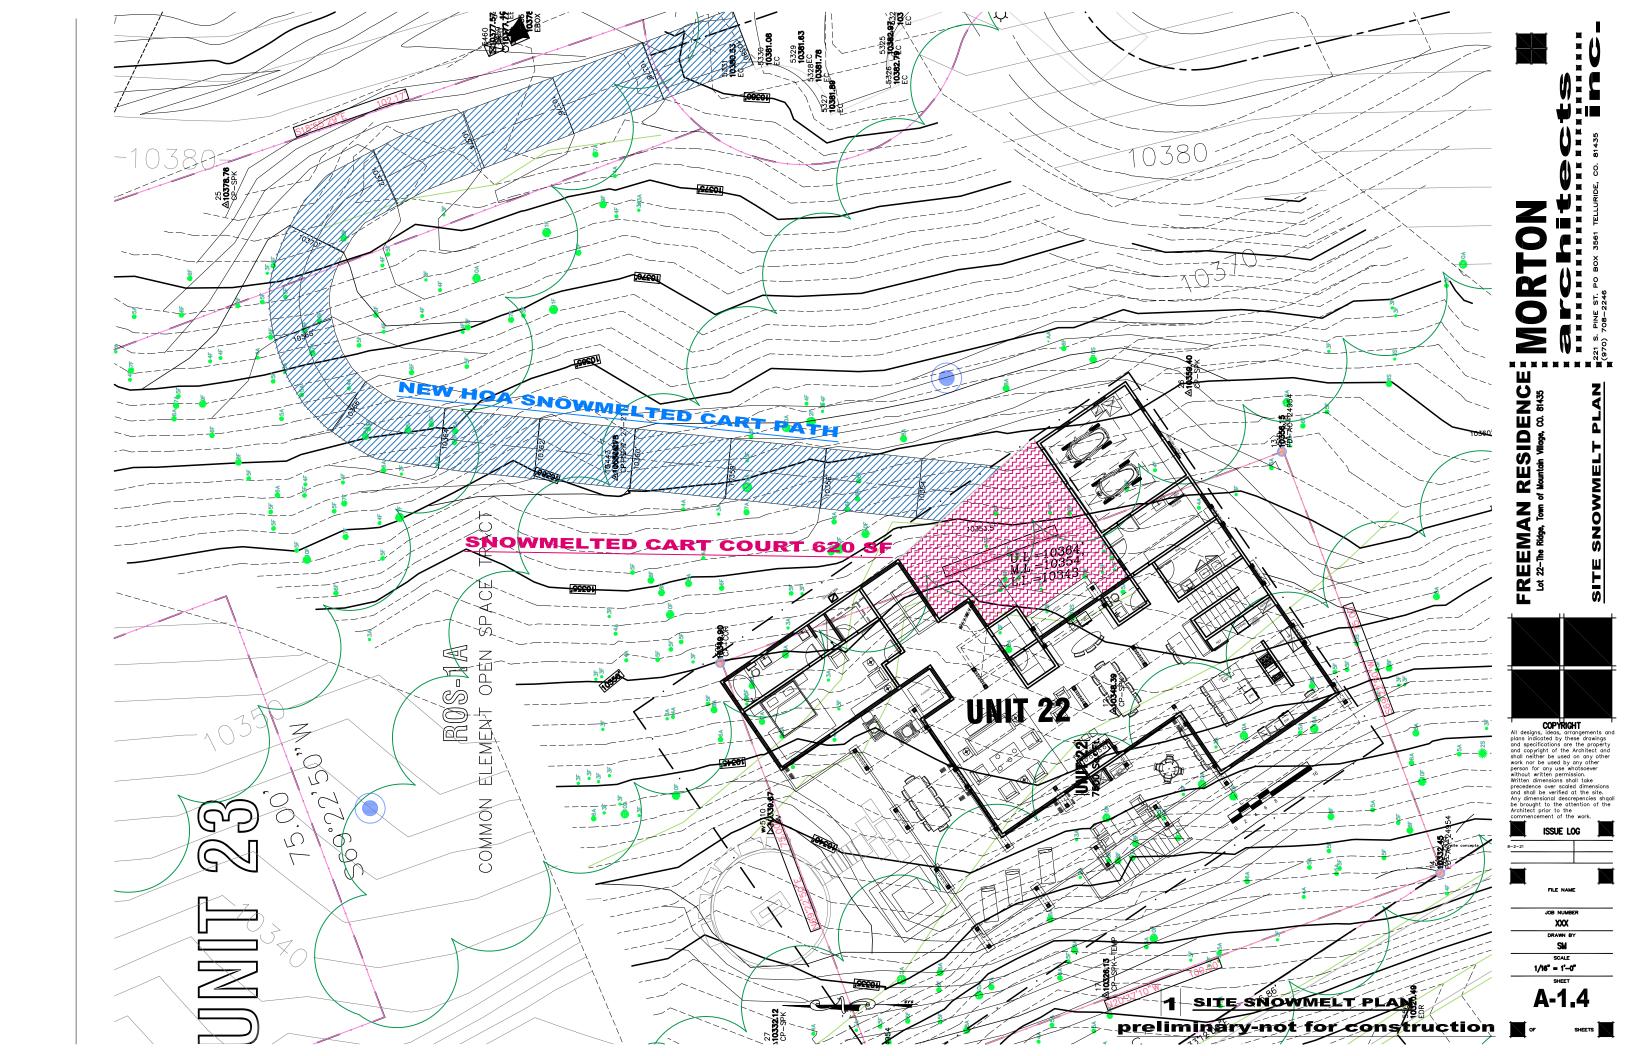


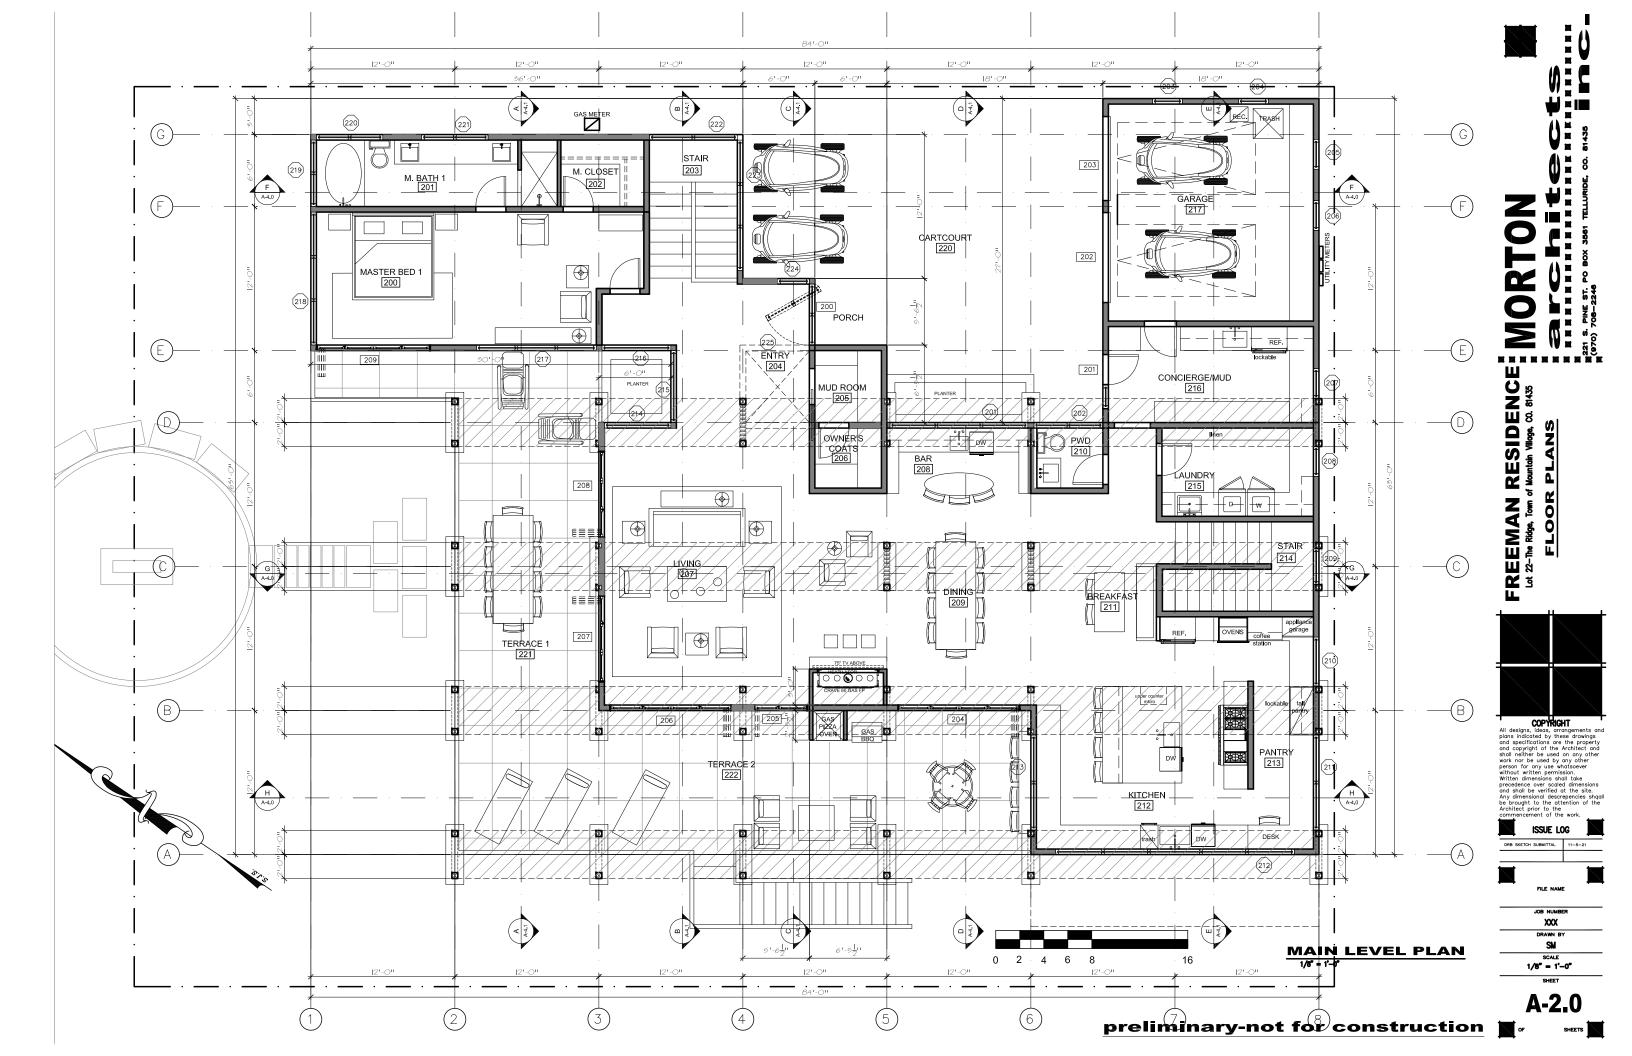


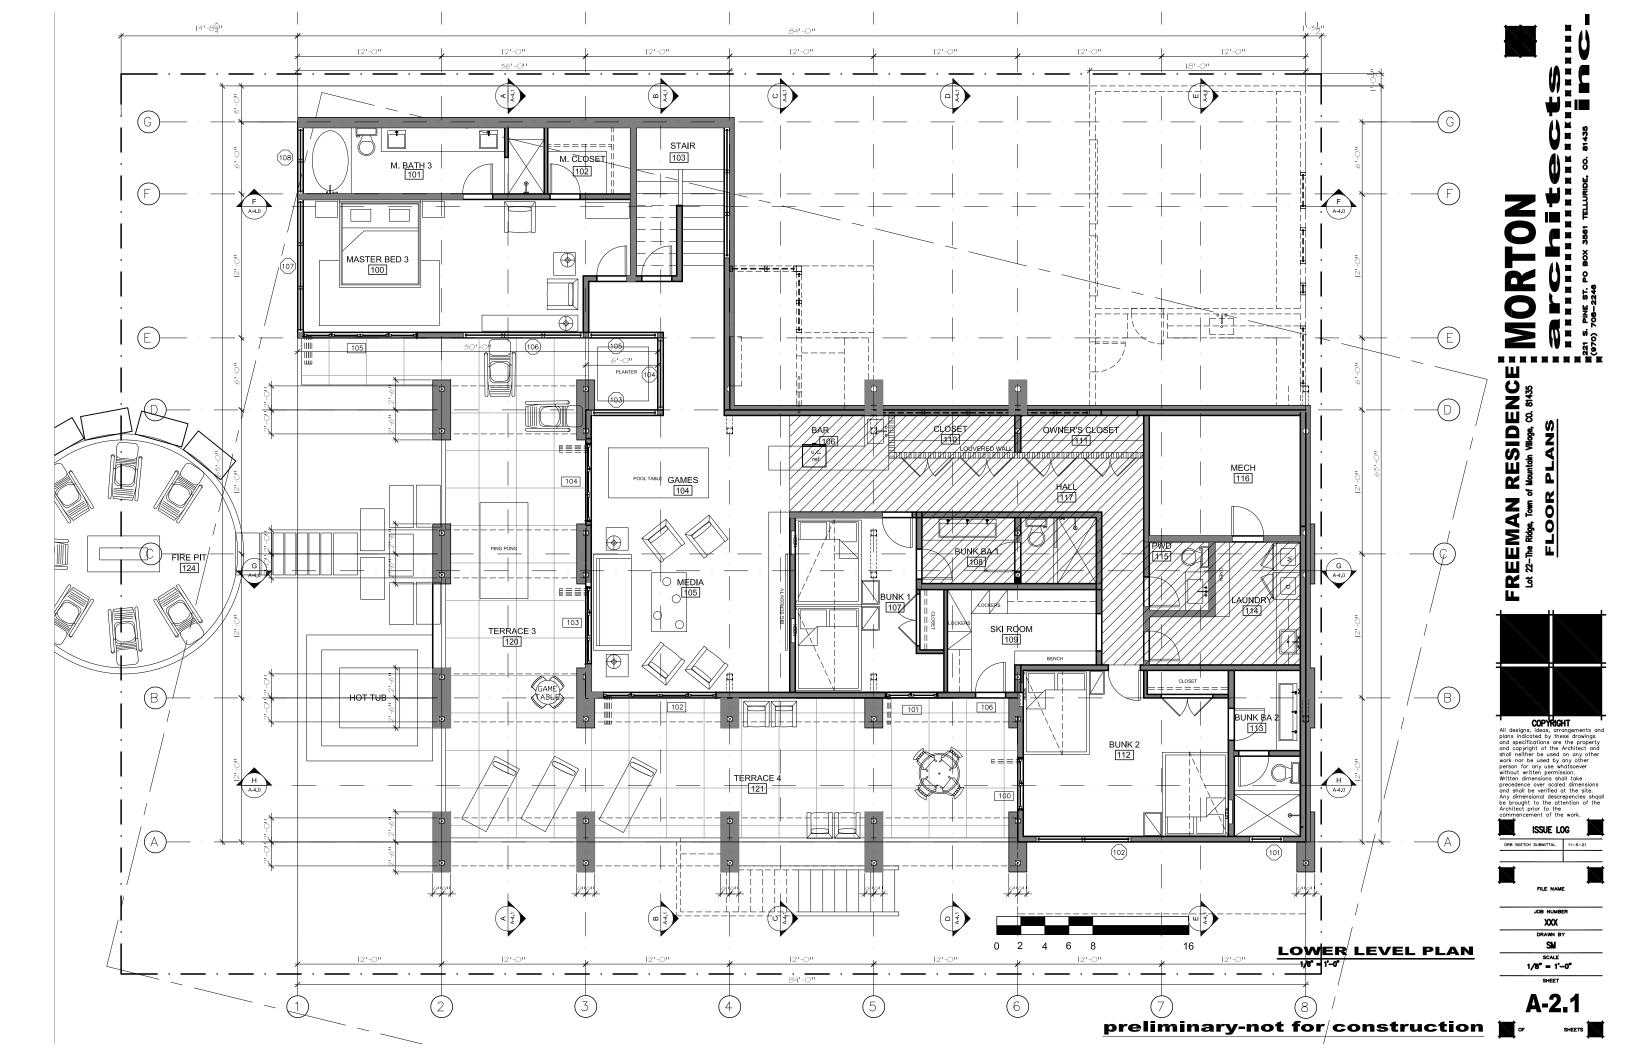


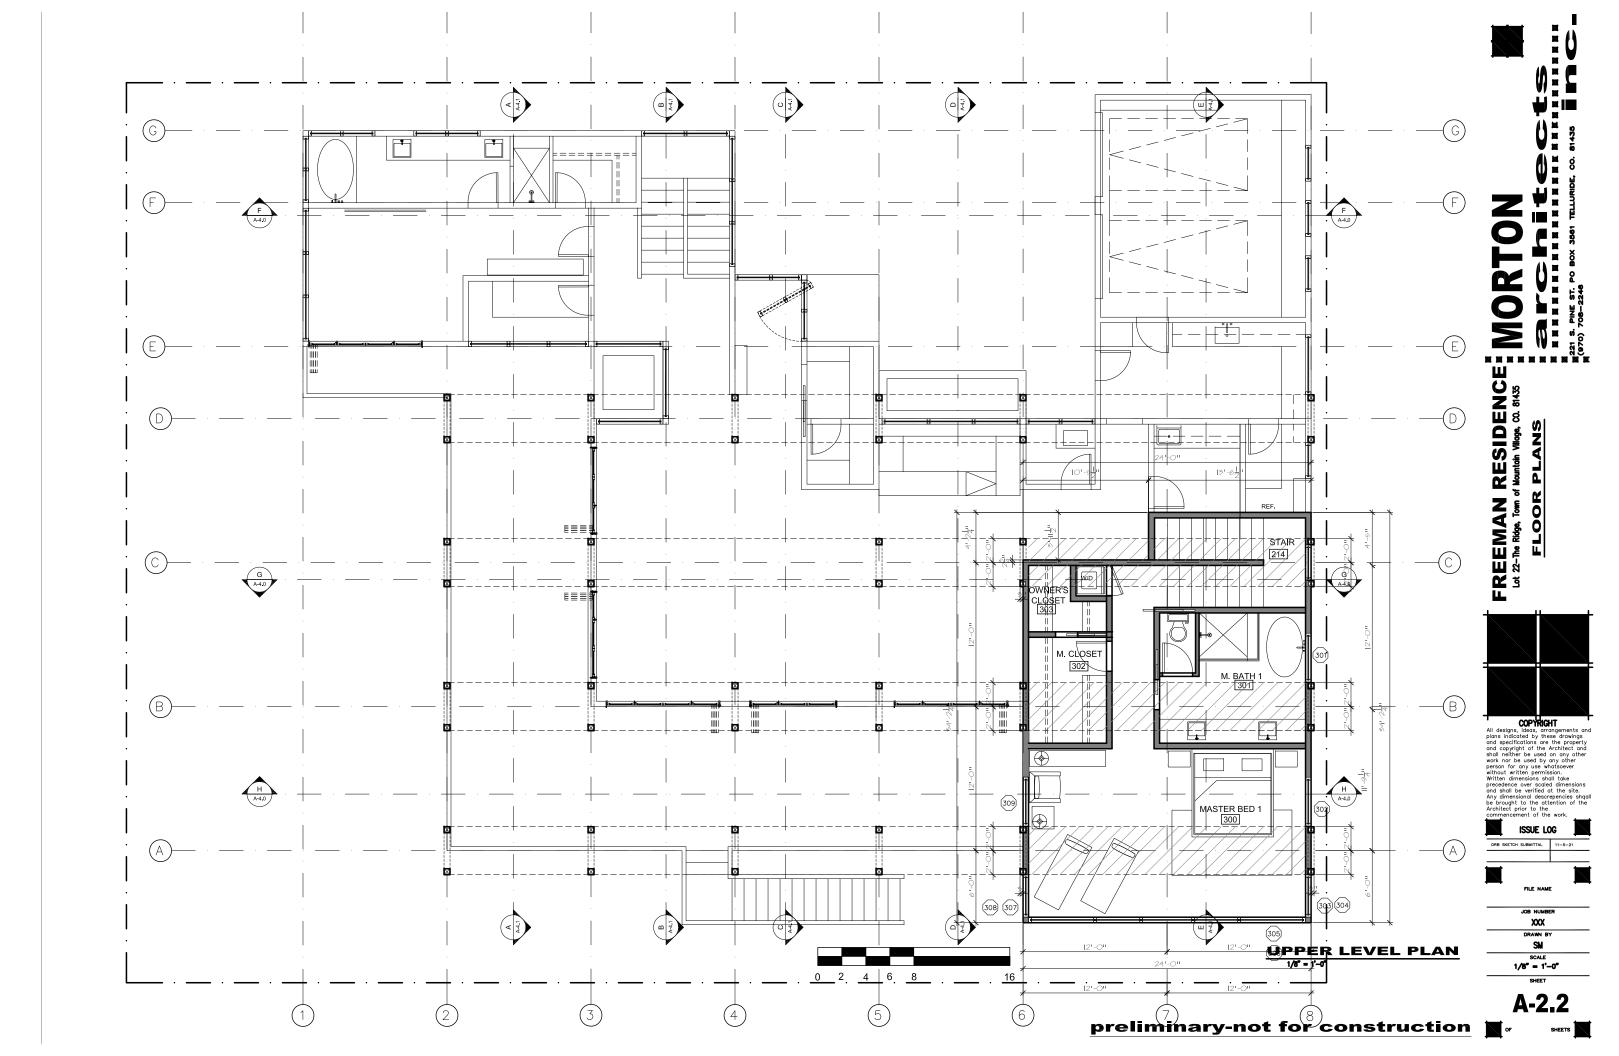


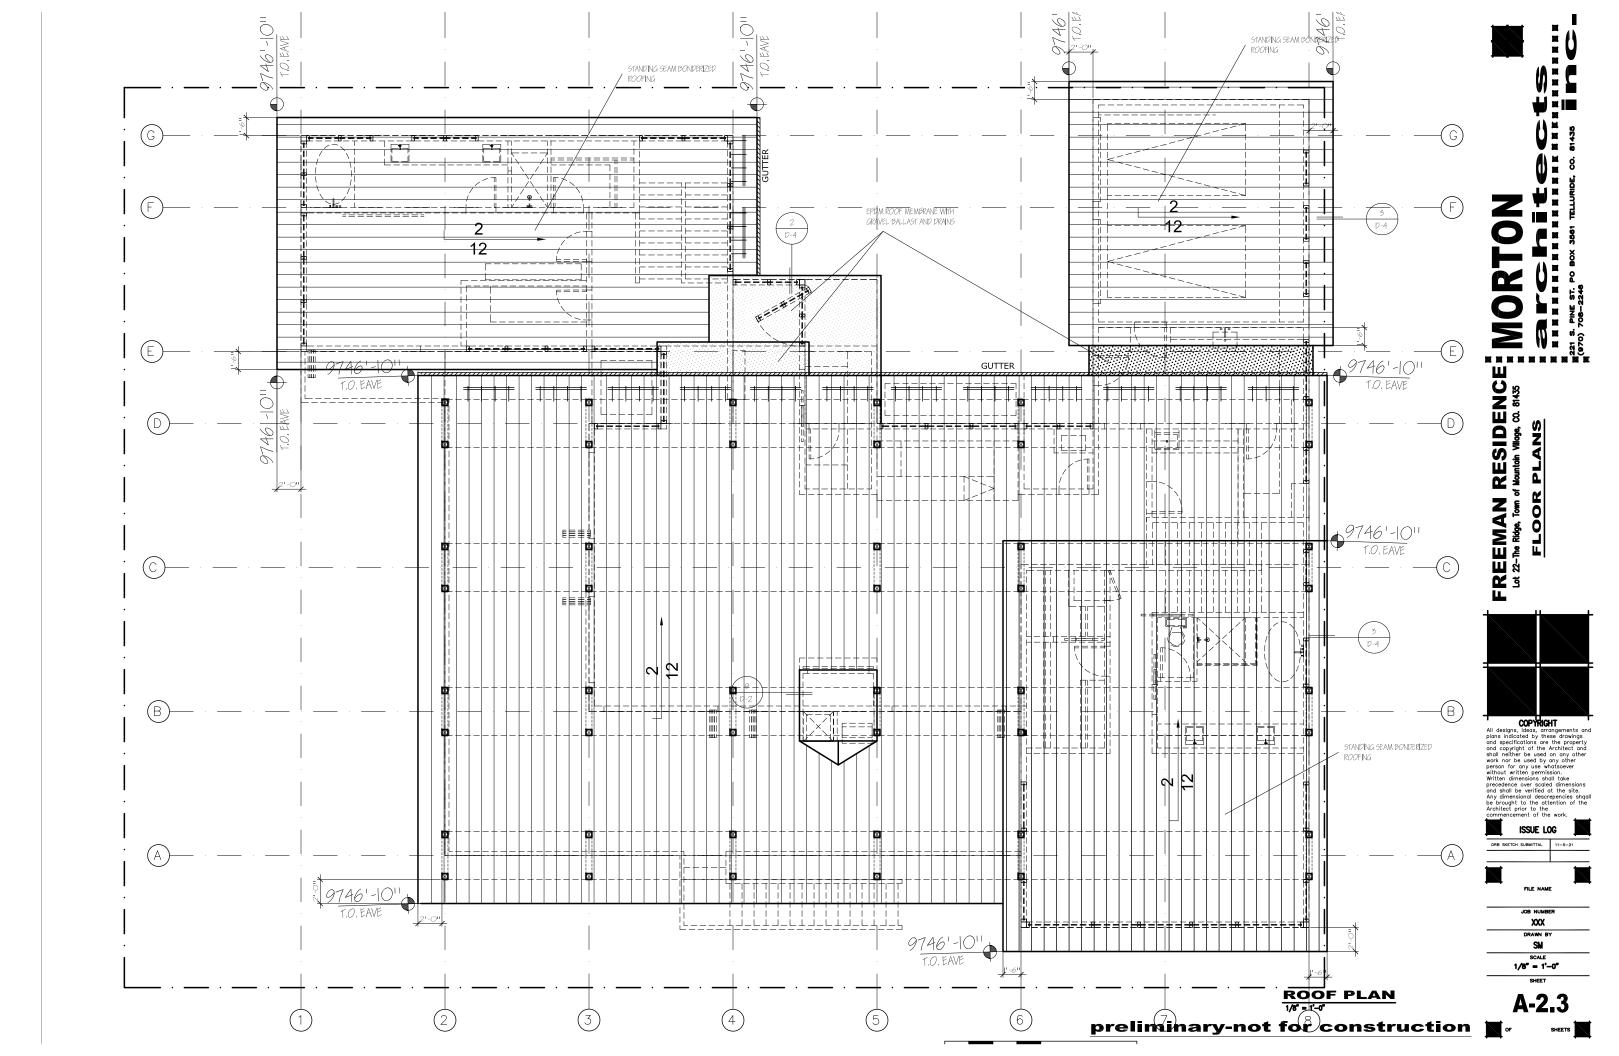


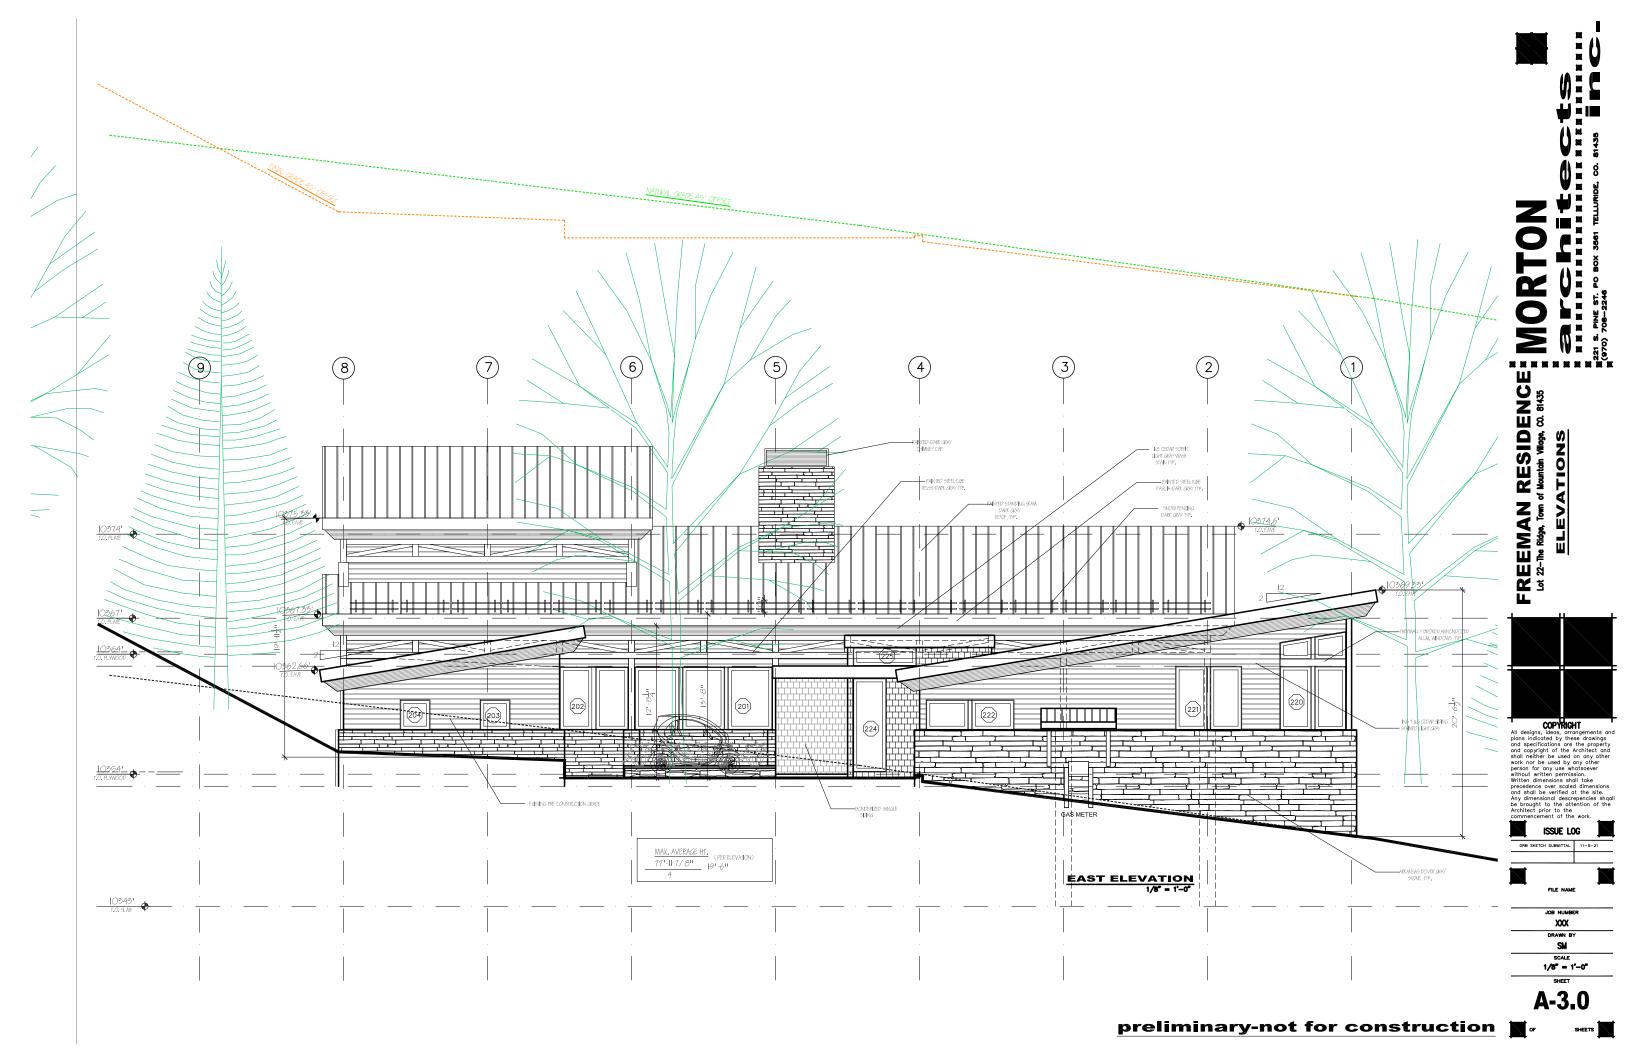

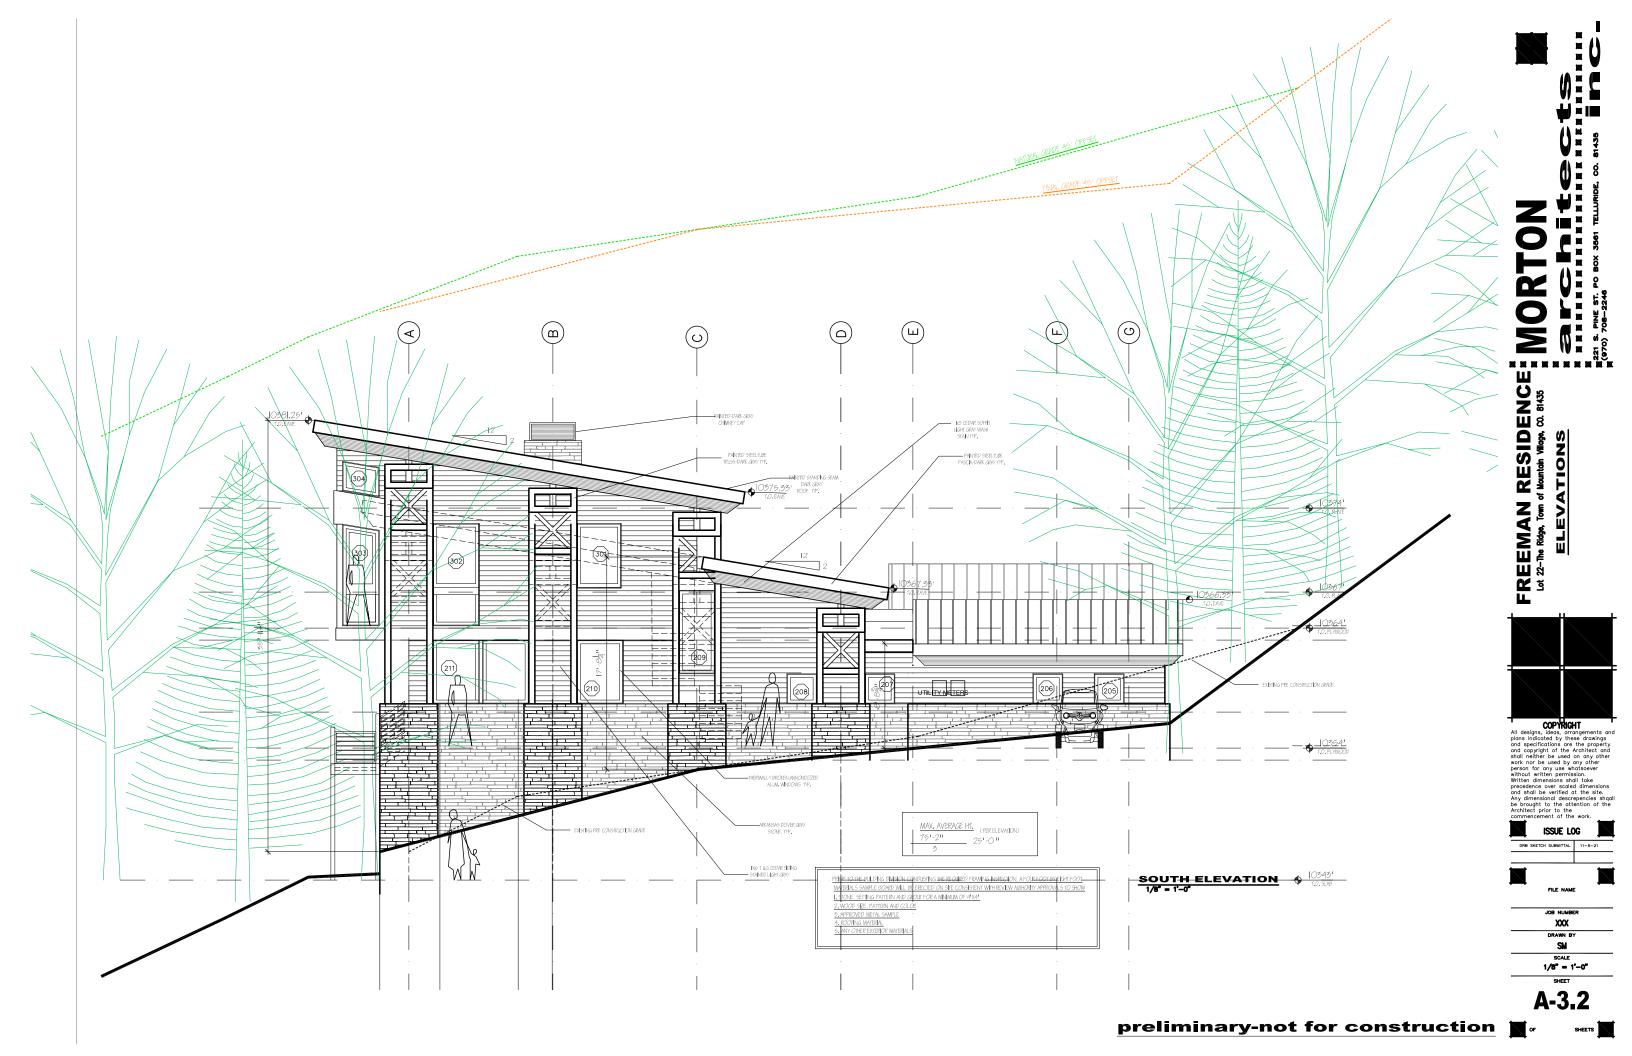

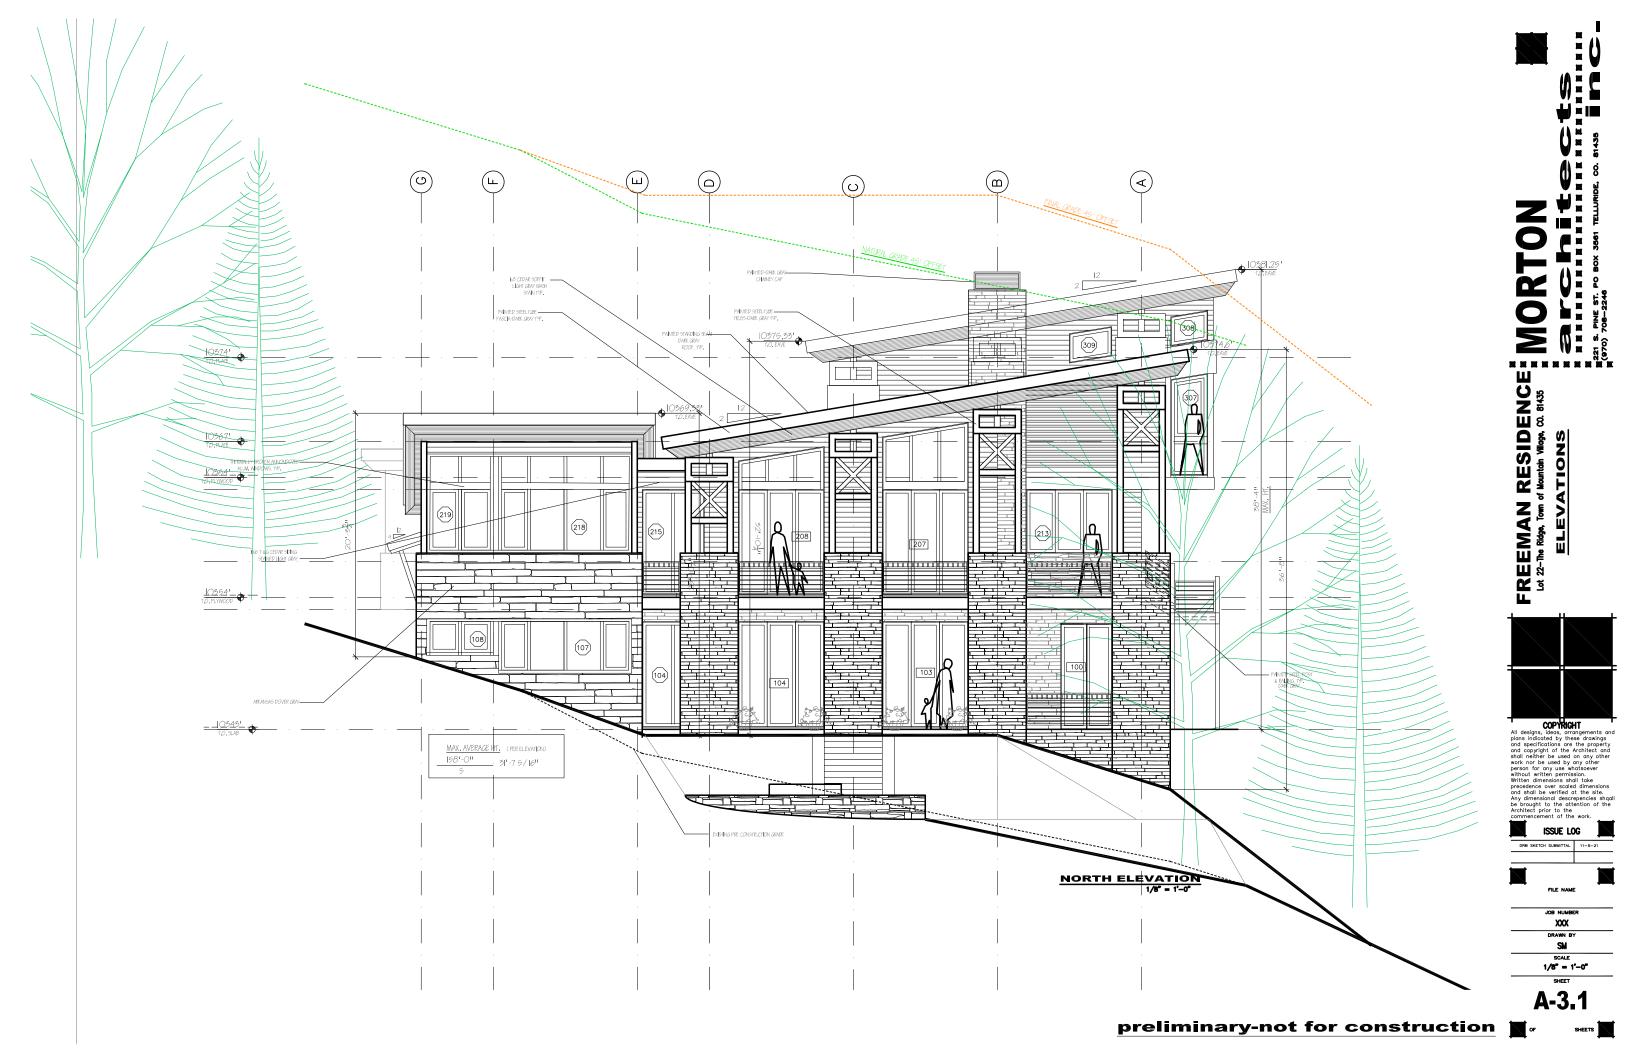


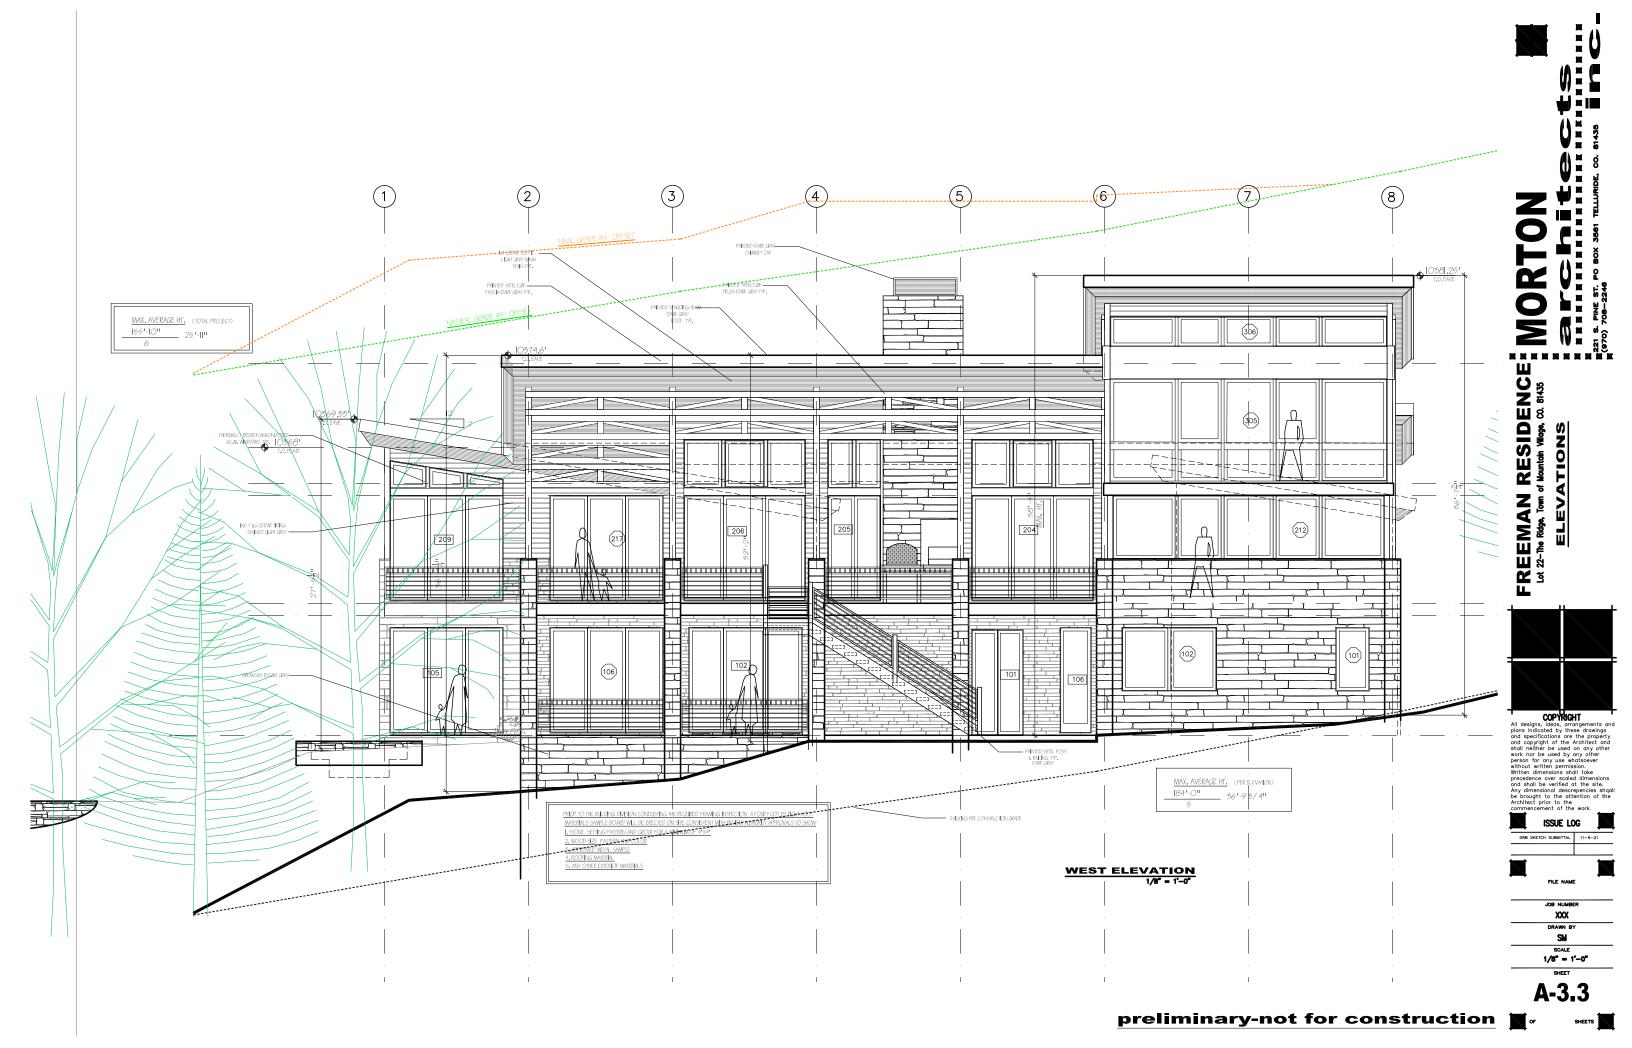

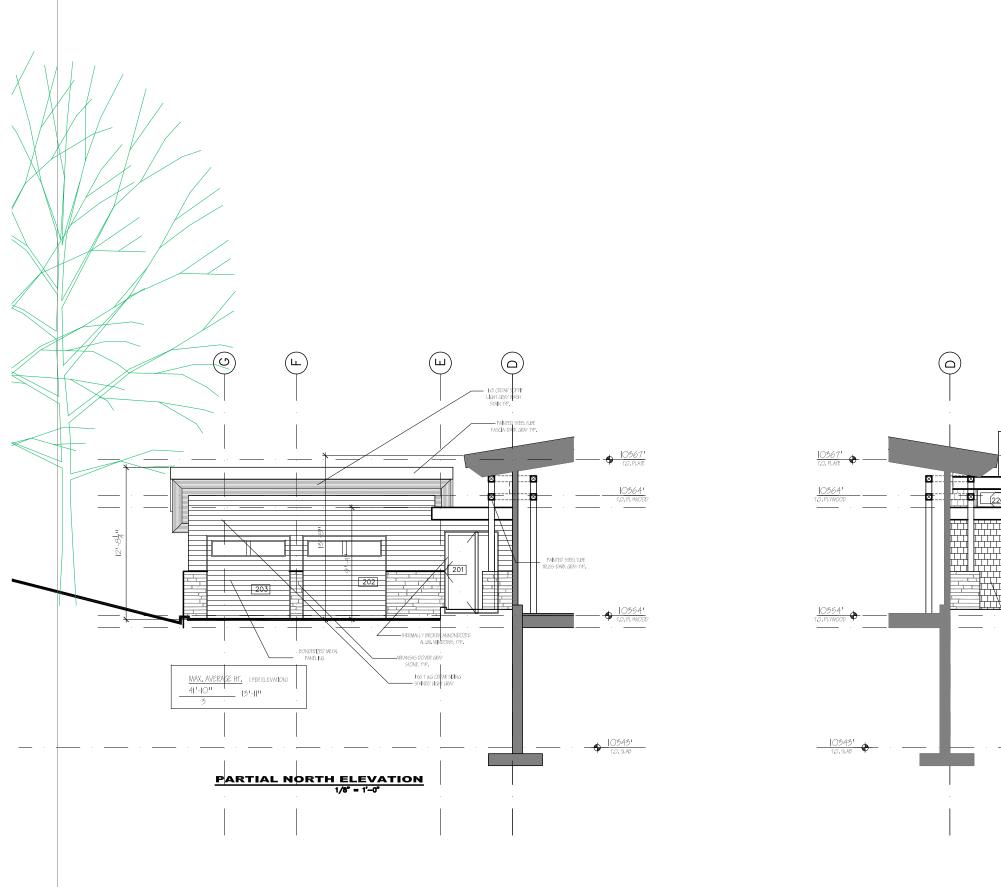



FREEMAN RESIDENCE MORE Town of Mountain Villogs, CD. 81435 HELEVATIONS HEREFIELD

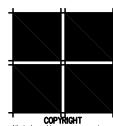


All designs, ideas, arrangements and plans indicated by these drawings and specifications are the property and copyright of the Architect and shall neither be used on any other work nor be used by any other work or the used by any other without written permissioner.
Written dimensions shall take precedence over scaled dimensions


ISSUE LOG

XXX SM

SCALE 1/8" = 1'-0"


preliminary-not for construction

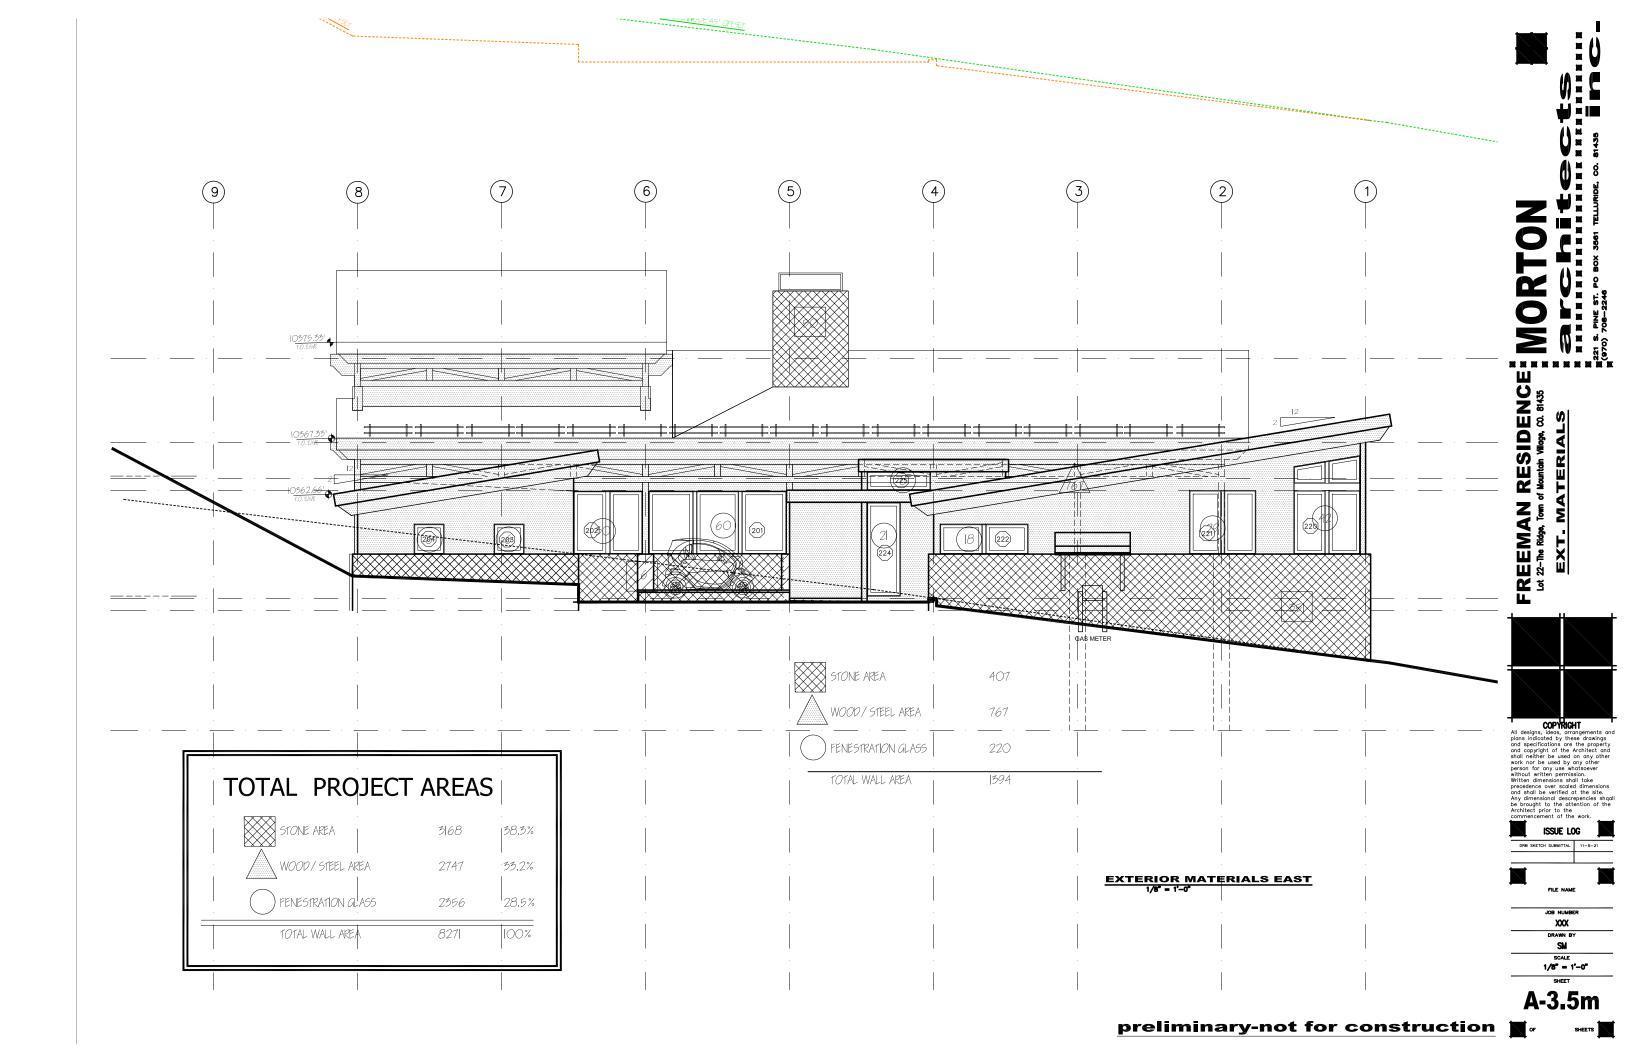

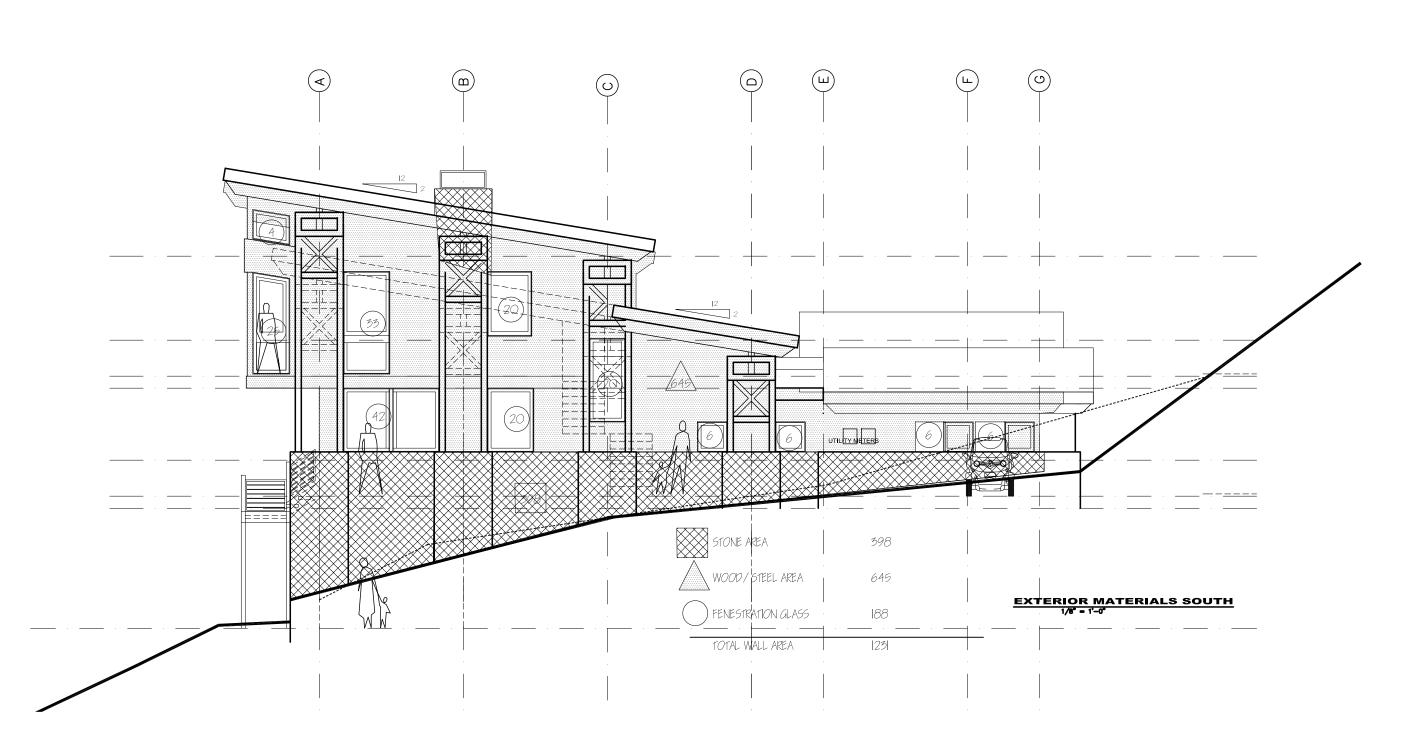



FREEMAN RESIDENCE Lot 22-The Ridge, Town of Mountain Wilege, Co. 81435 EXT. MATERIALS

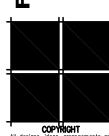

COPYRIGHT


All designs, ideas, arrangements and plans indicated by these drawings and specifications are the property and copyright of the Architect and shall seither be used on any other

XXX DRAWN BY SOLE 1/6" = 1'-0" SHEET A-3.6m





FREEMAN RESIDENCE Lot 22-The Ridge, Town of Mountain Wilege, Co. 81435 EXT. MATERIALS

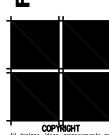

COPYRIGHT


All designs, ideas, arrangemen plans indicated by these drawl and specifications are the pro and copyright of the Architect


XXX DRAWN BY


1/8" - 1'-0"

SHEET


A-3.7m

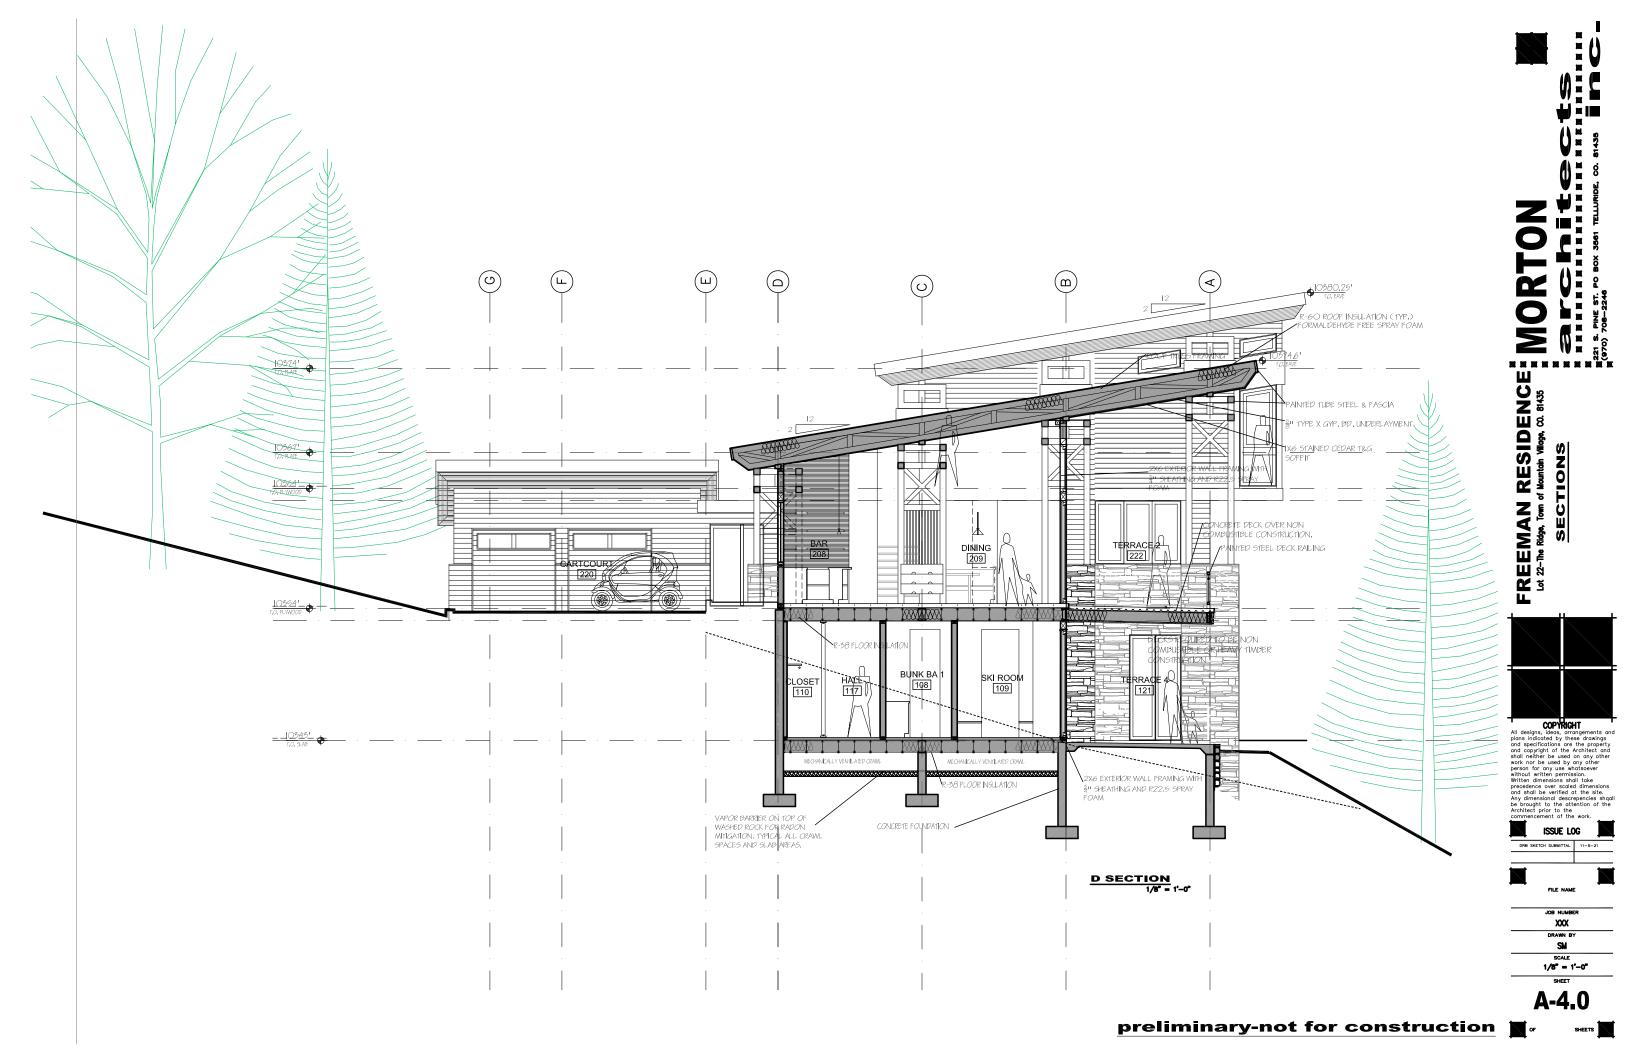


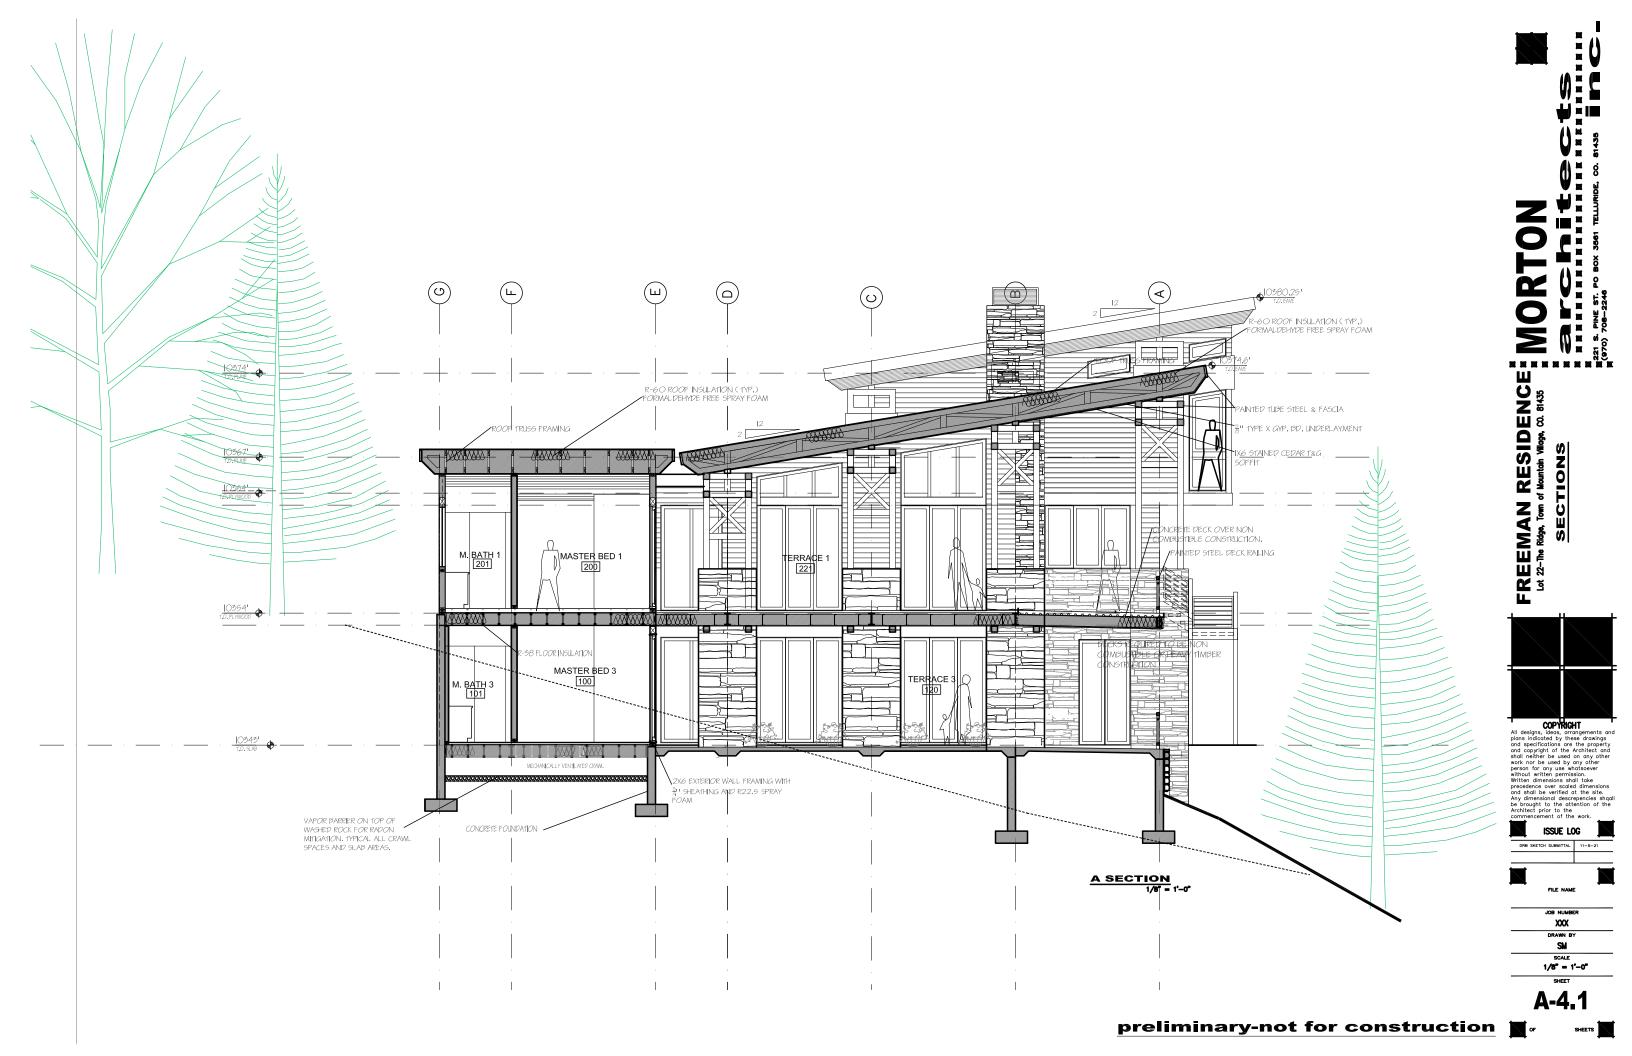


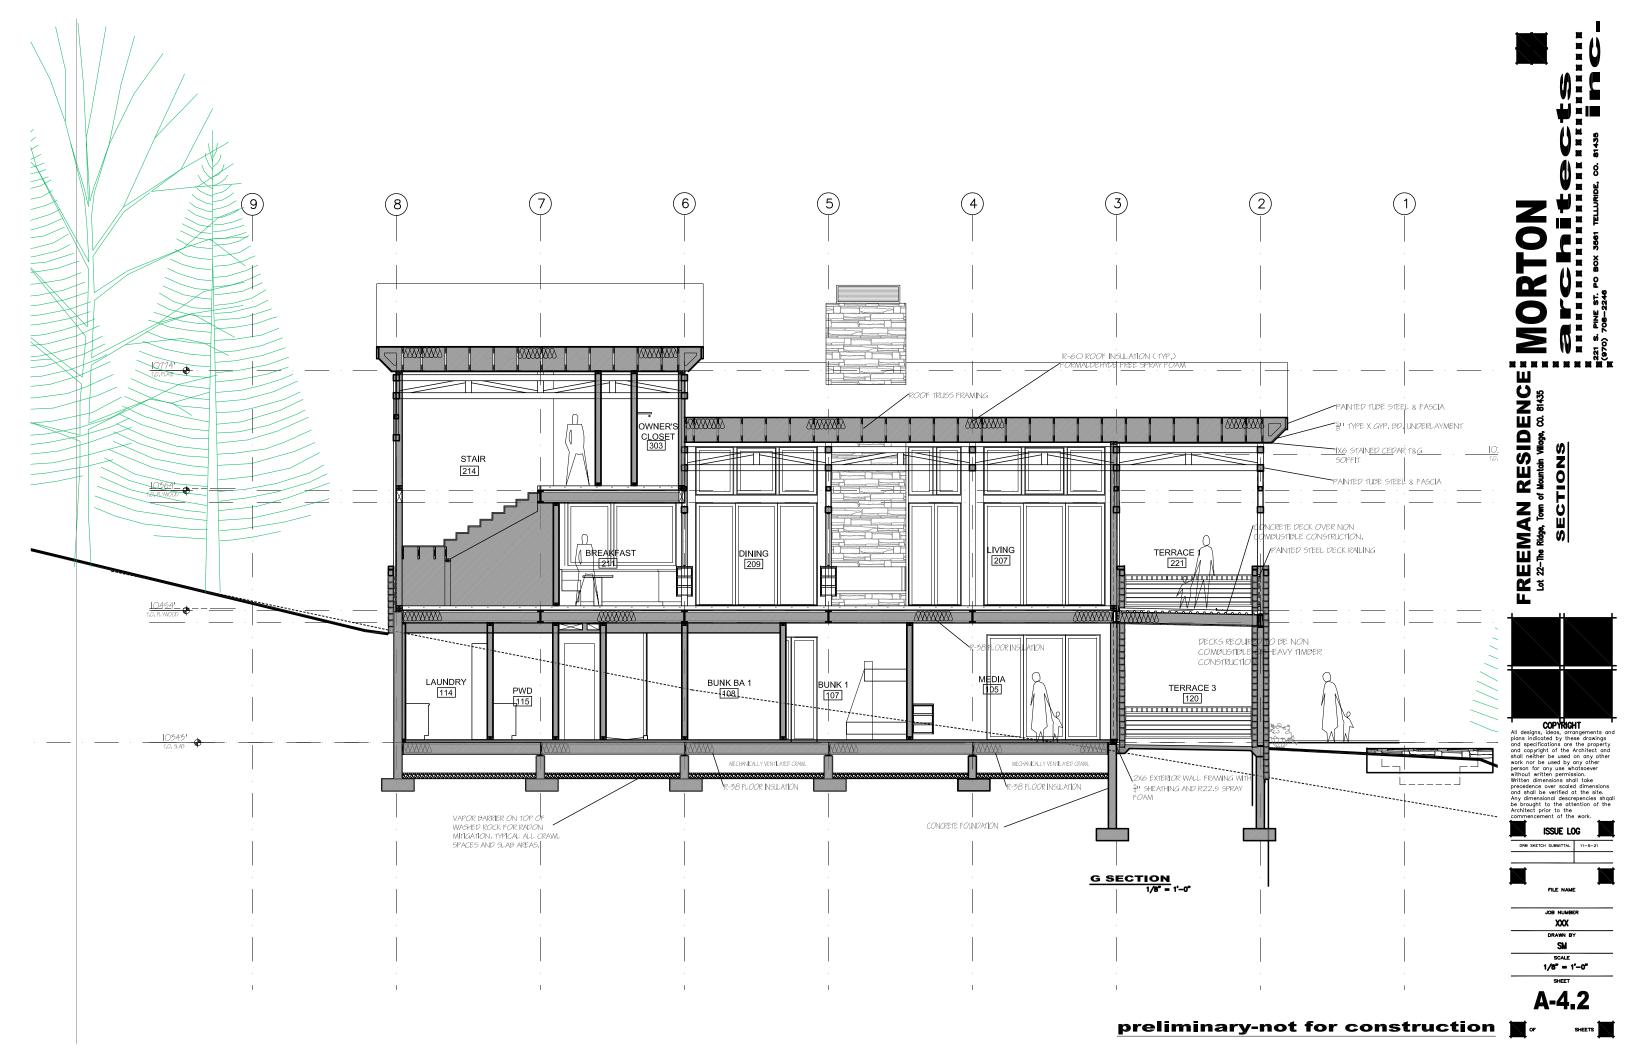



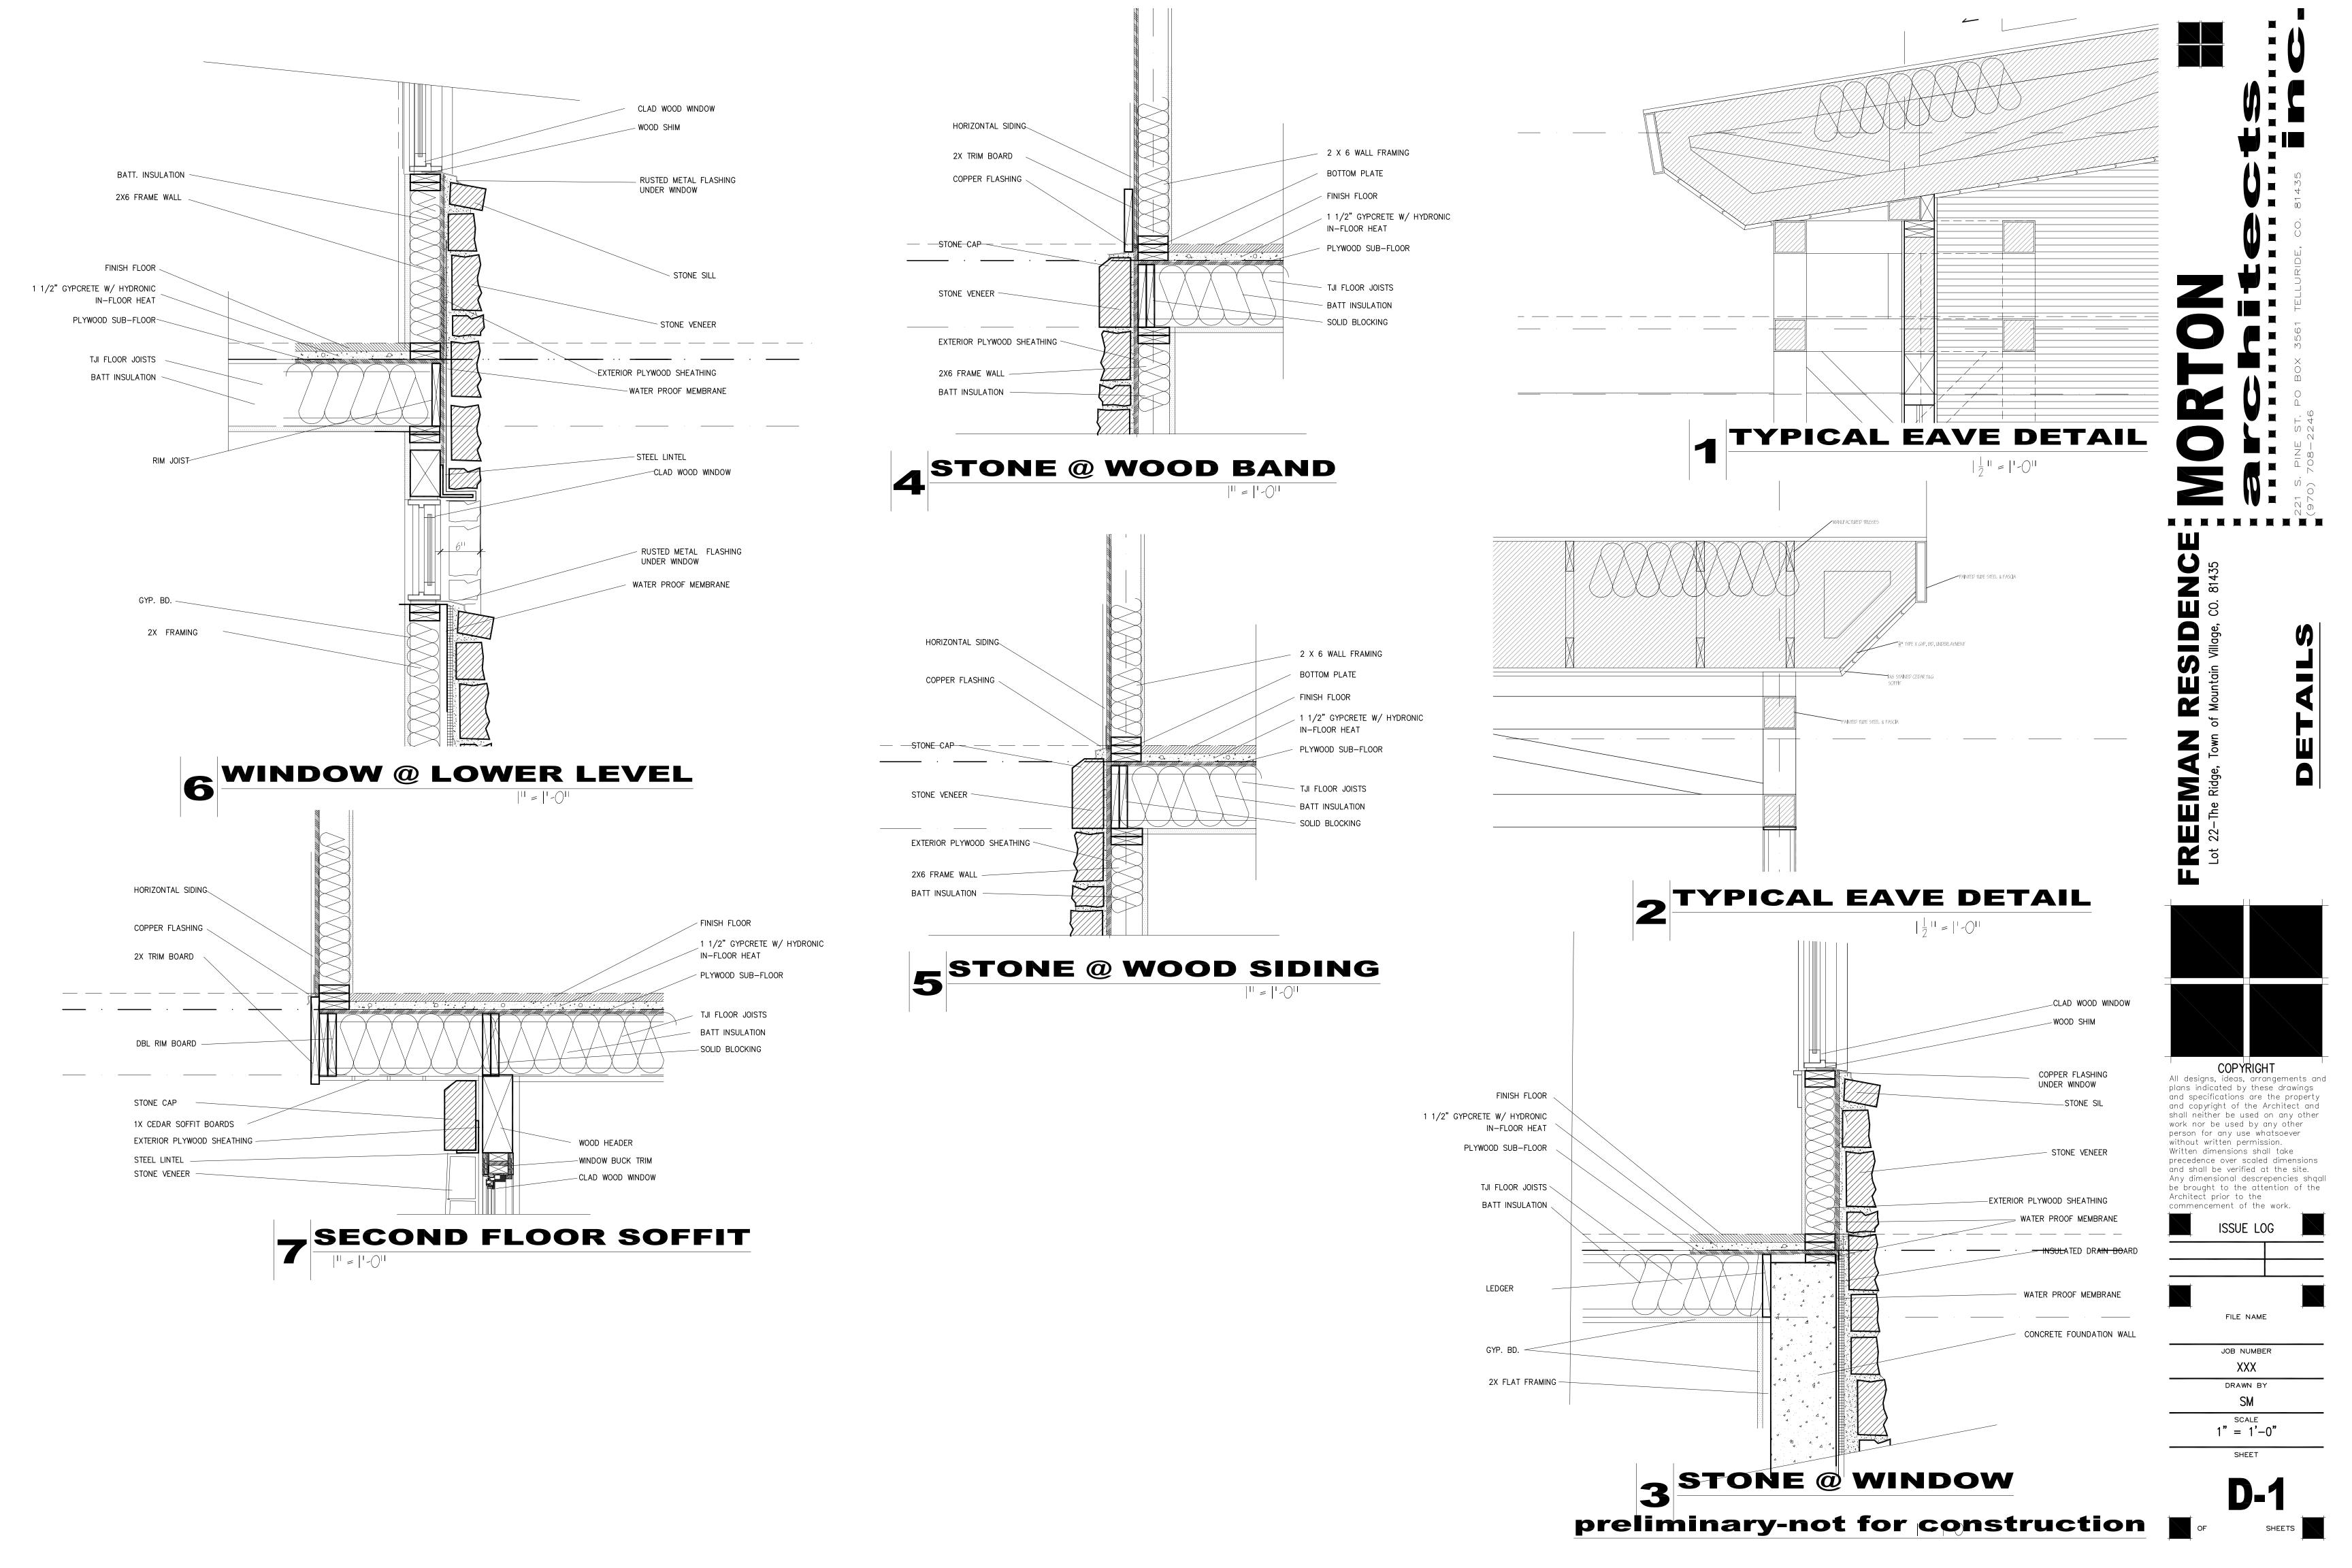

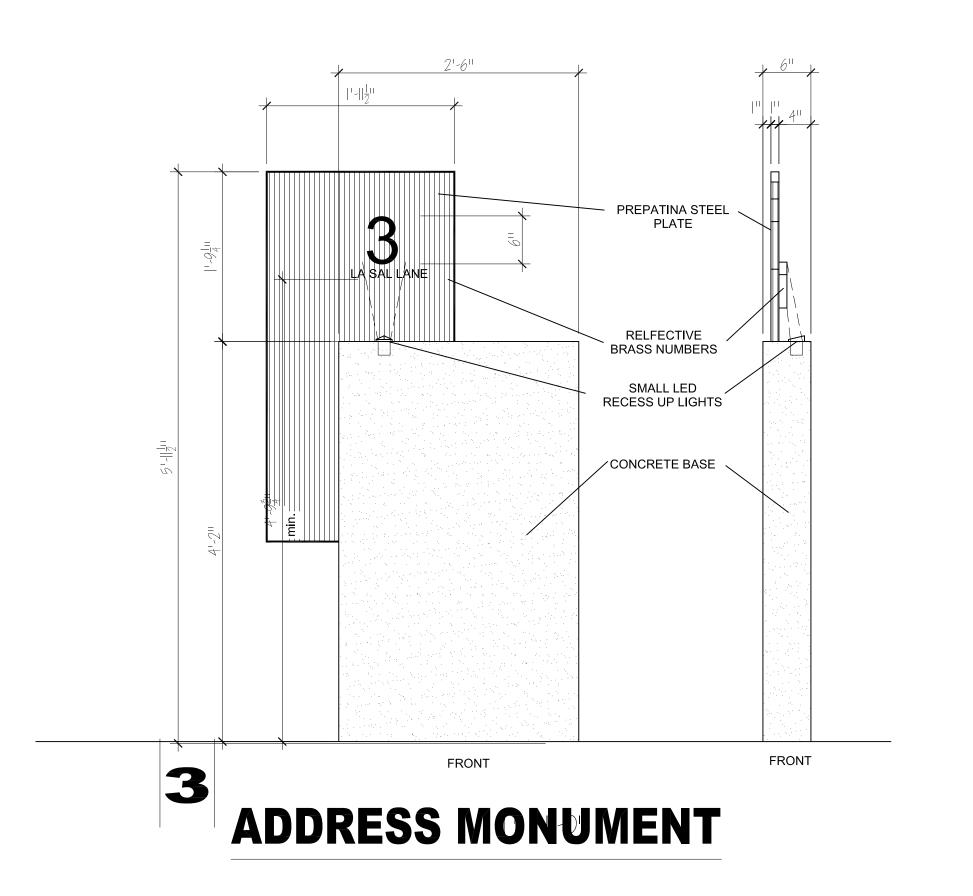

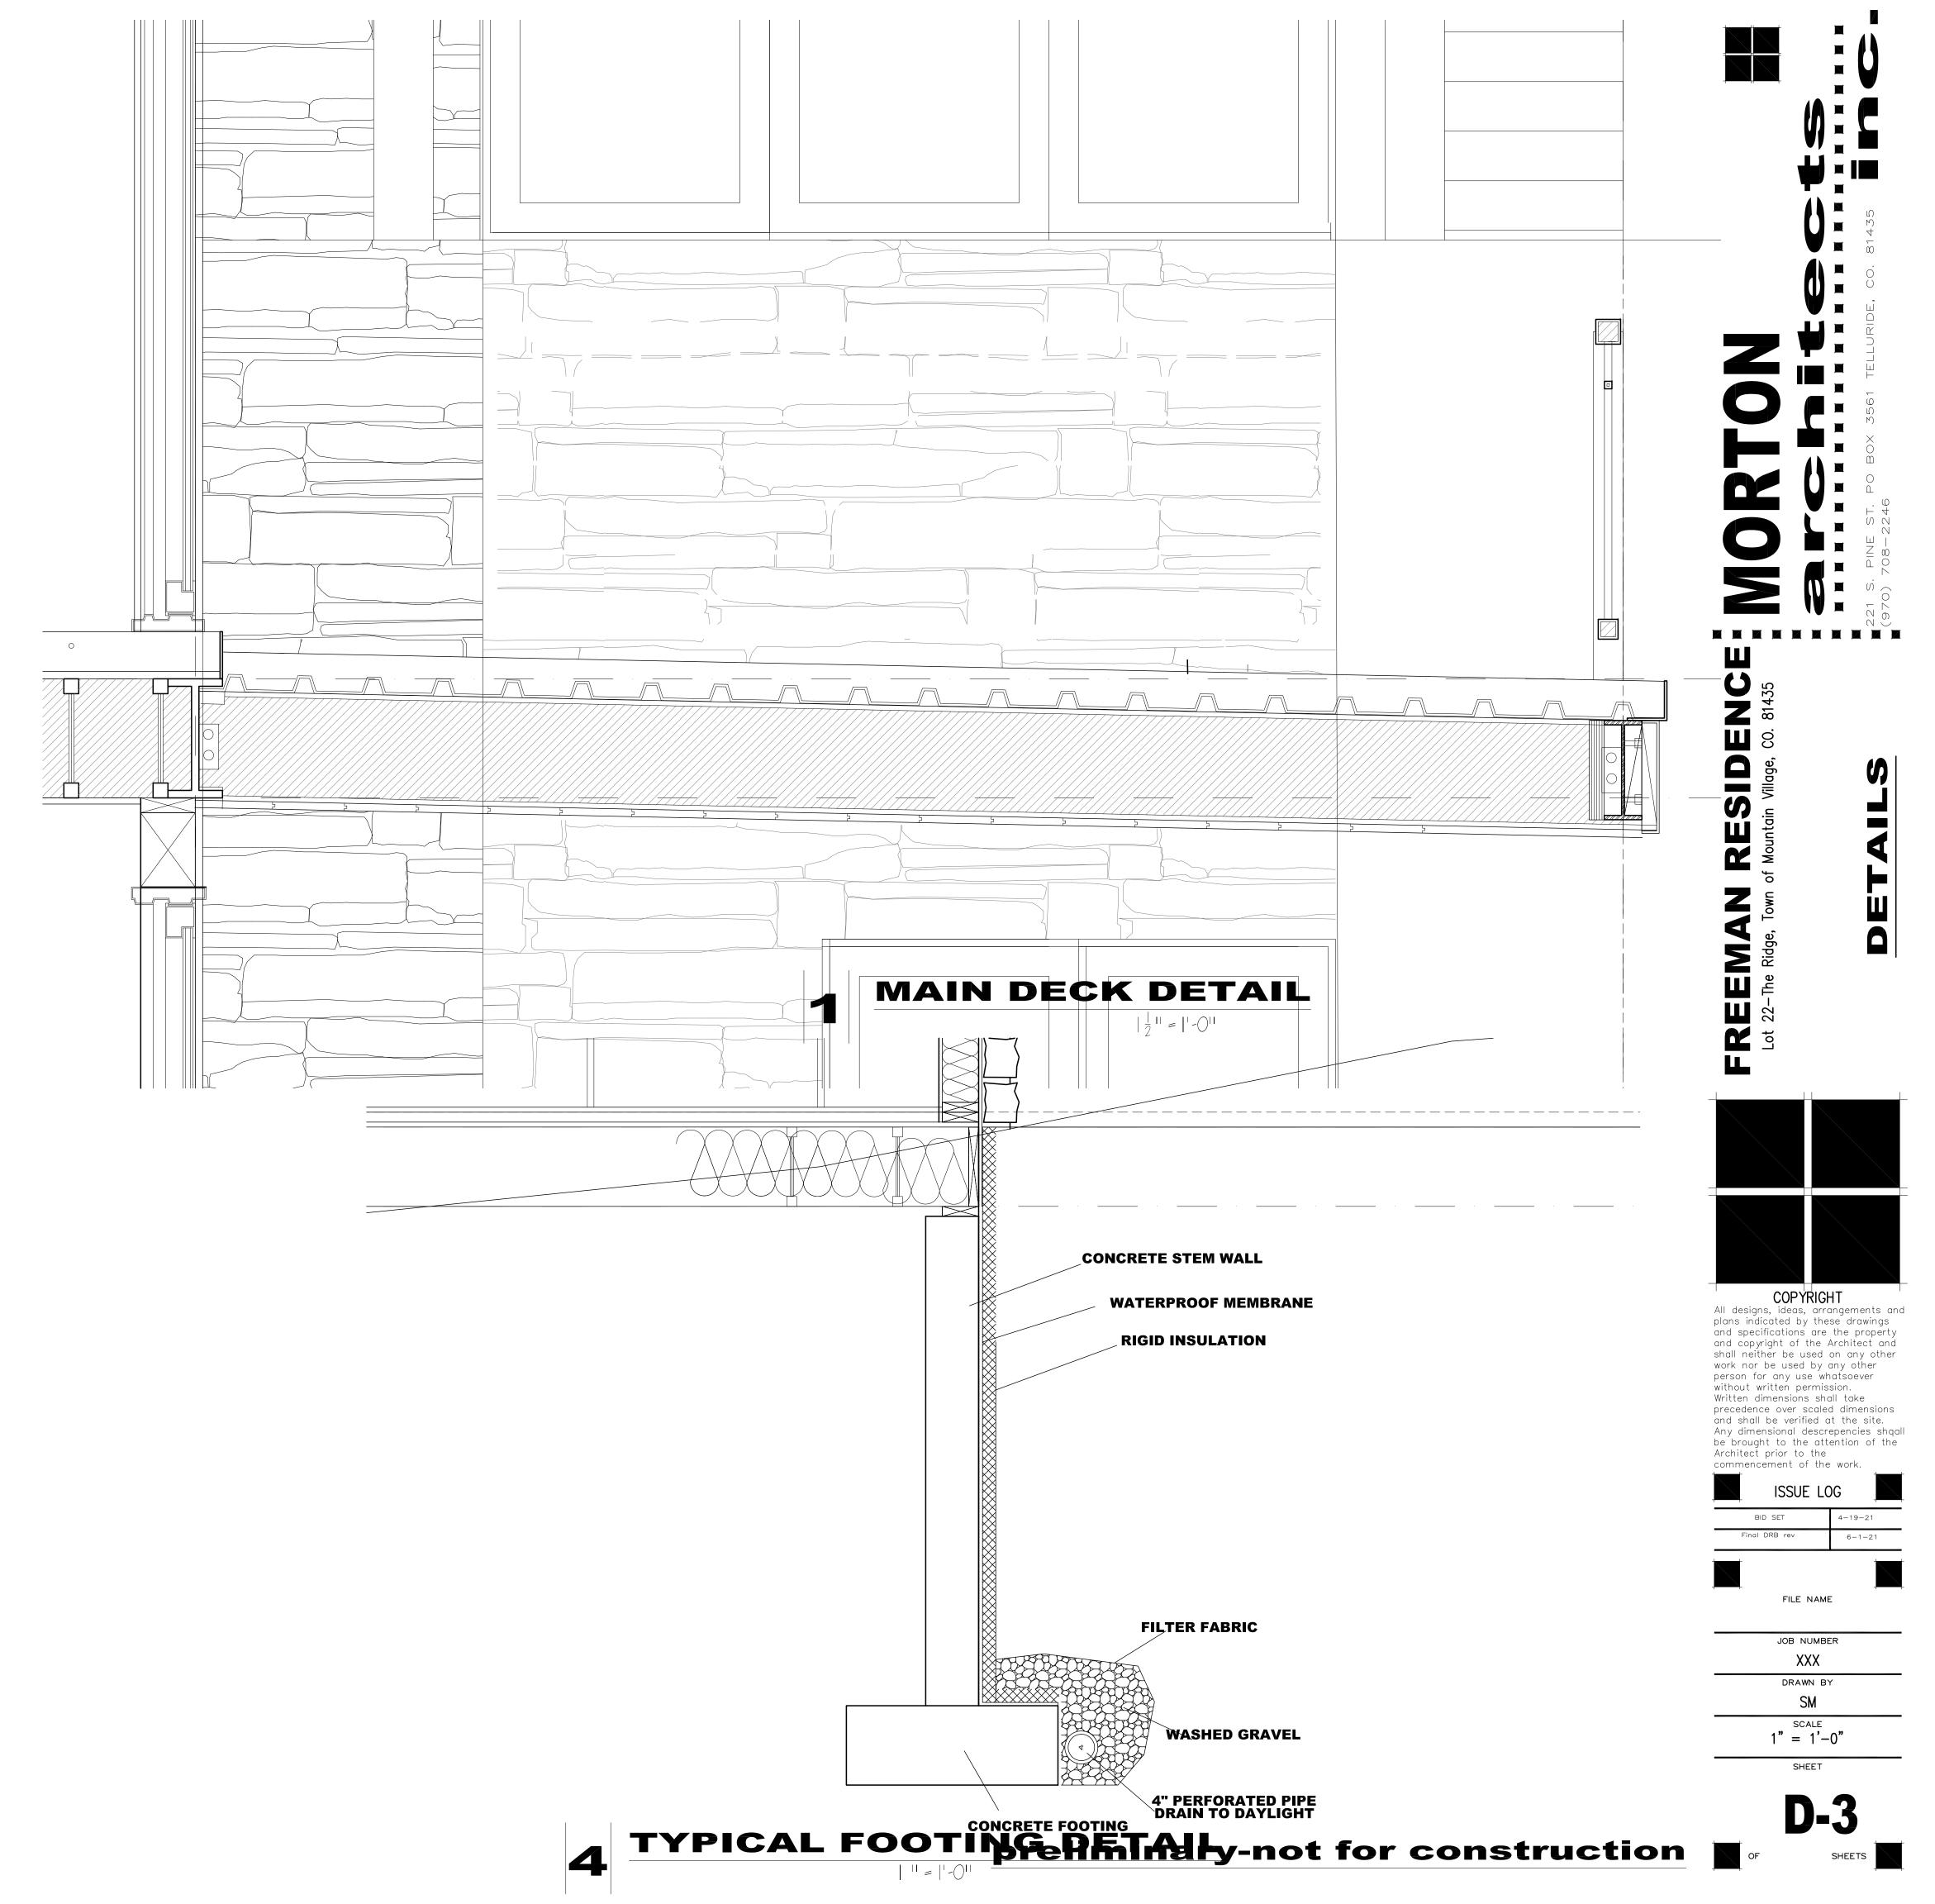

A-M

ROOFING & METAL SHINGLE SIDING BONDERIZED SHEET METAL

NORTH/EAST VIEW



NORTH/WEST VIEW Preliminary-not for construction

TRUSSES/ WNDWS/ACCENTS

STEEL ROOF FASCIA ALUMINUM ANODIZED WINDOWS STEEL TRUSS & DECK RAIL POWDER COATED GRAY





HORIZONTAL 1X6 WIRE BRUSH CHANNEL GROOVE-STAINED





STONE VENEER ARKANSAS DOVER GRAY ARKANSAS DARK DOVER GRAY **BLOCKY-TUMBLED** TIGHT GROUT JOINTS




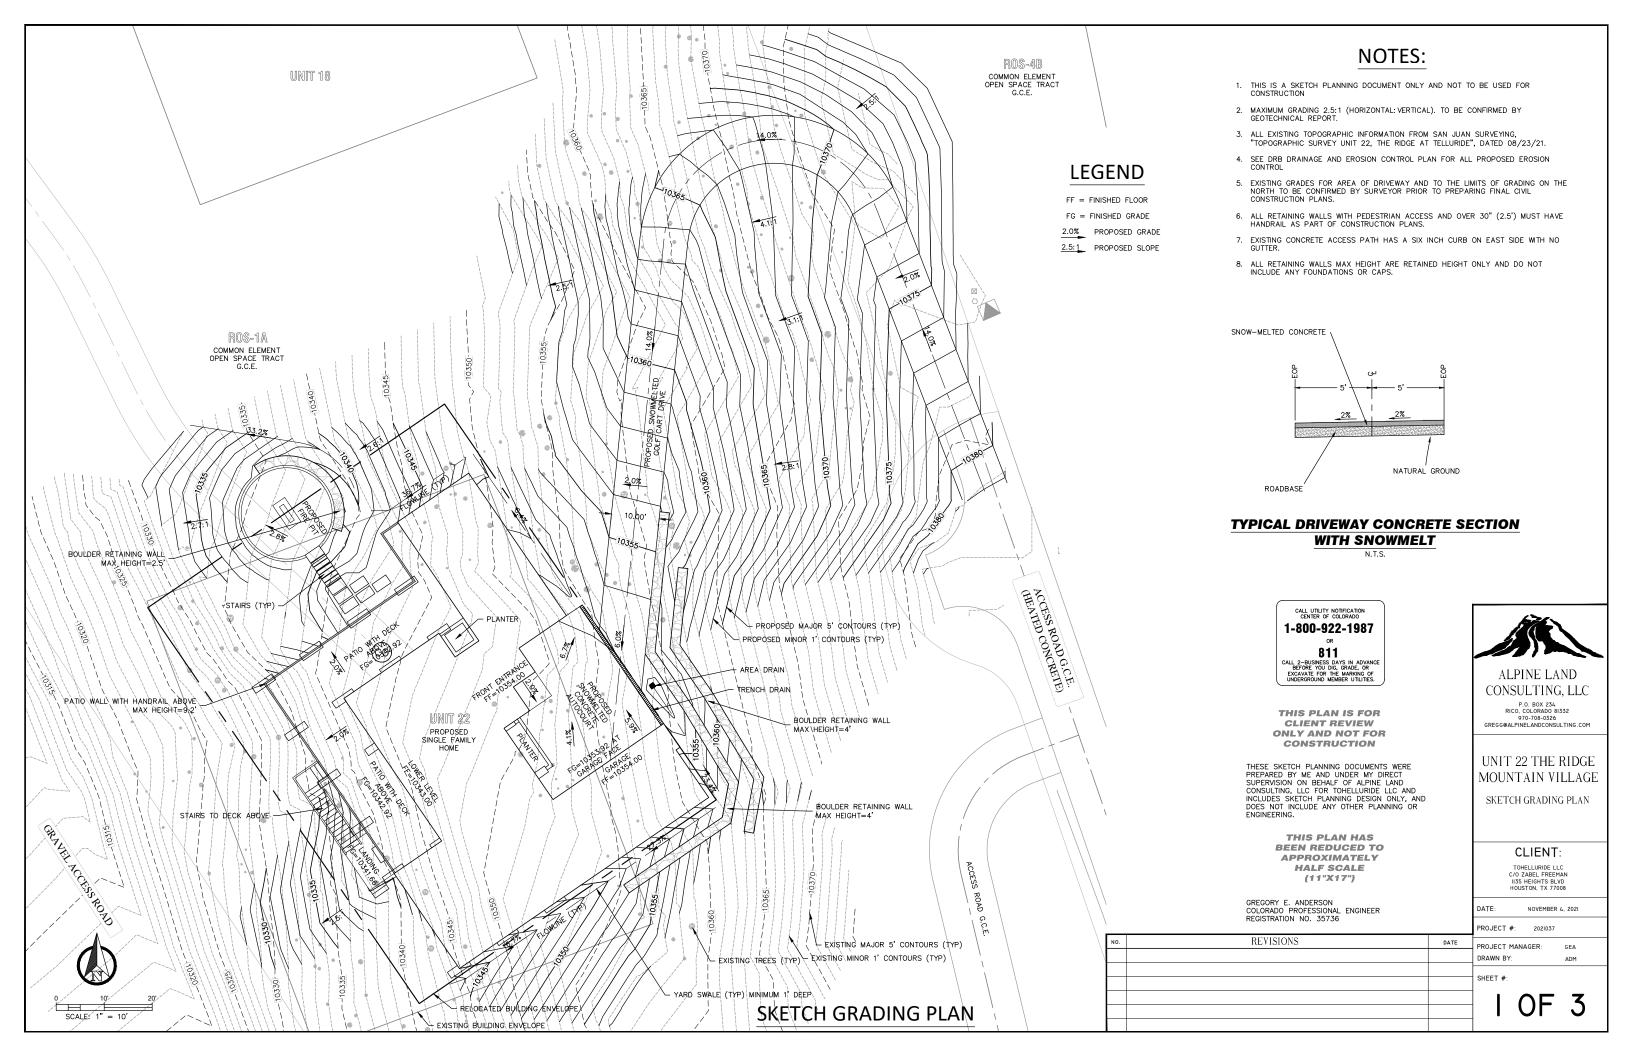

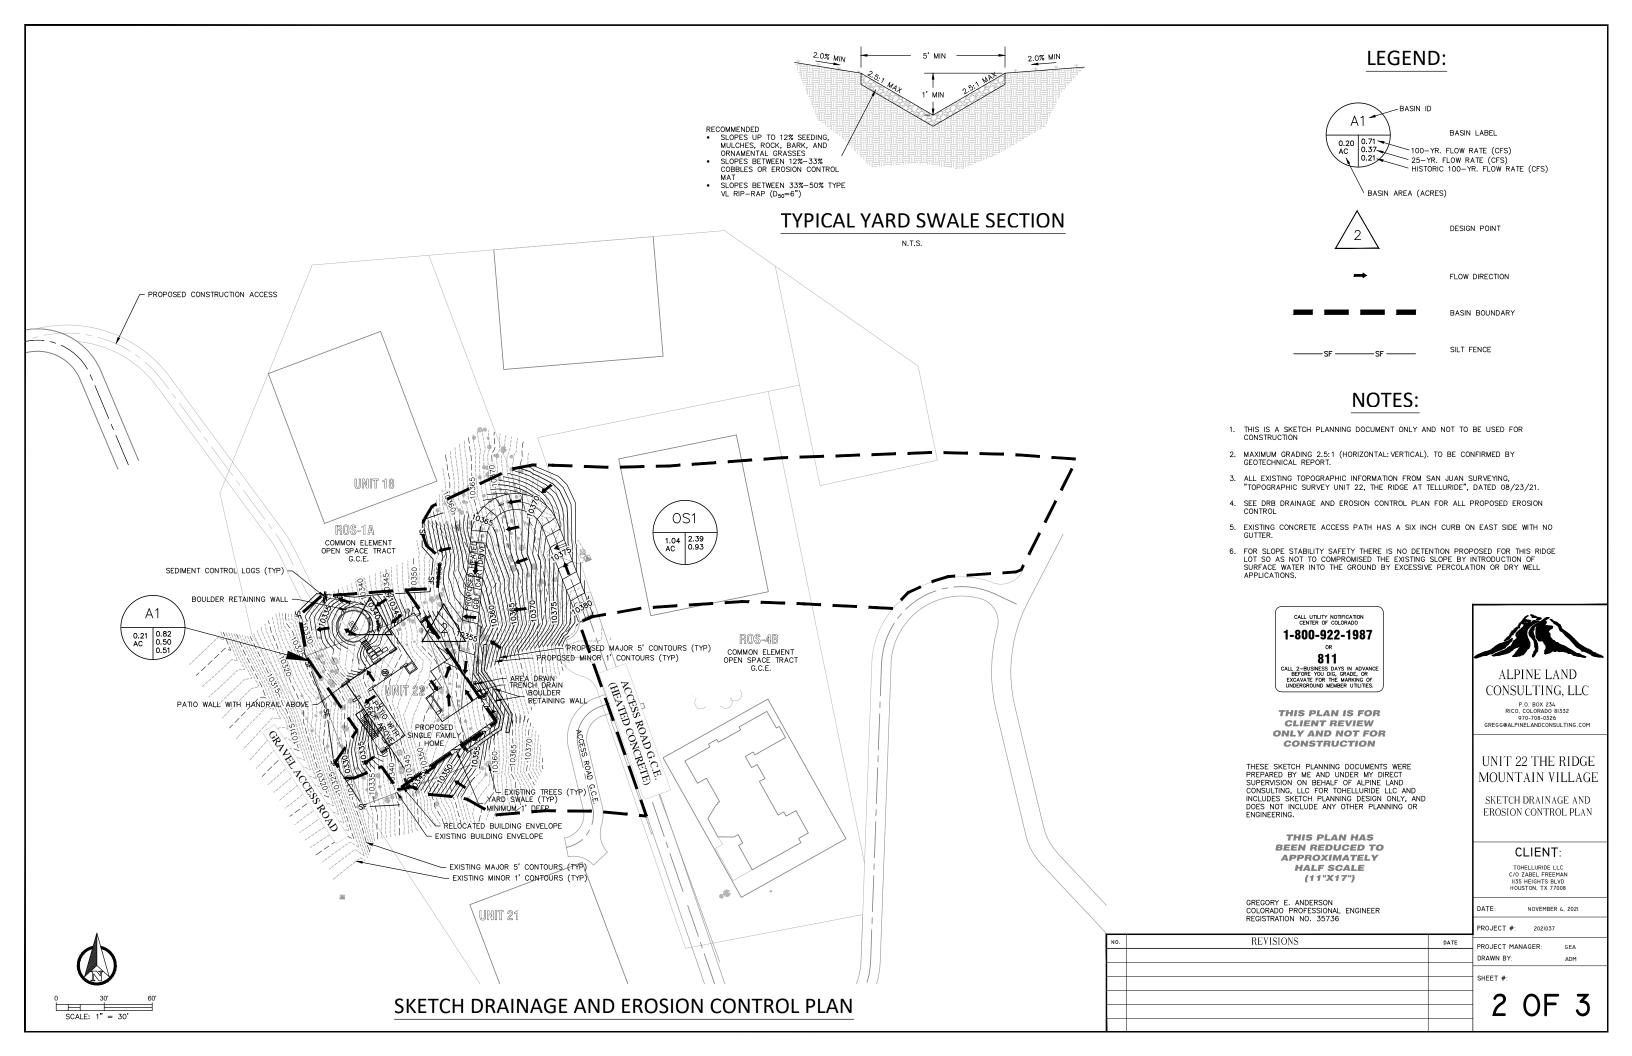

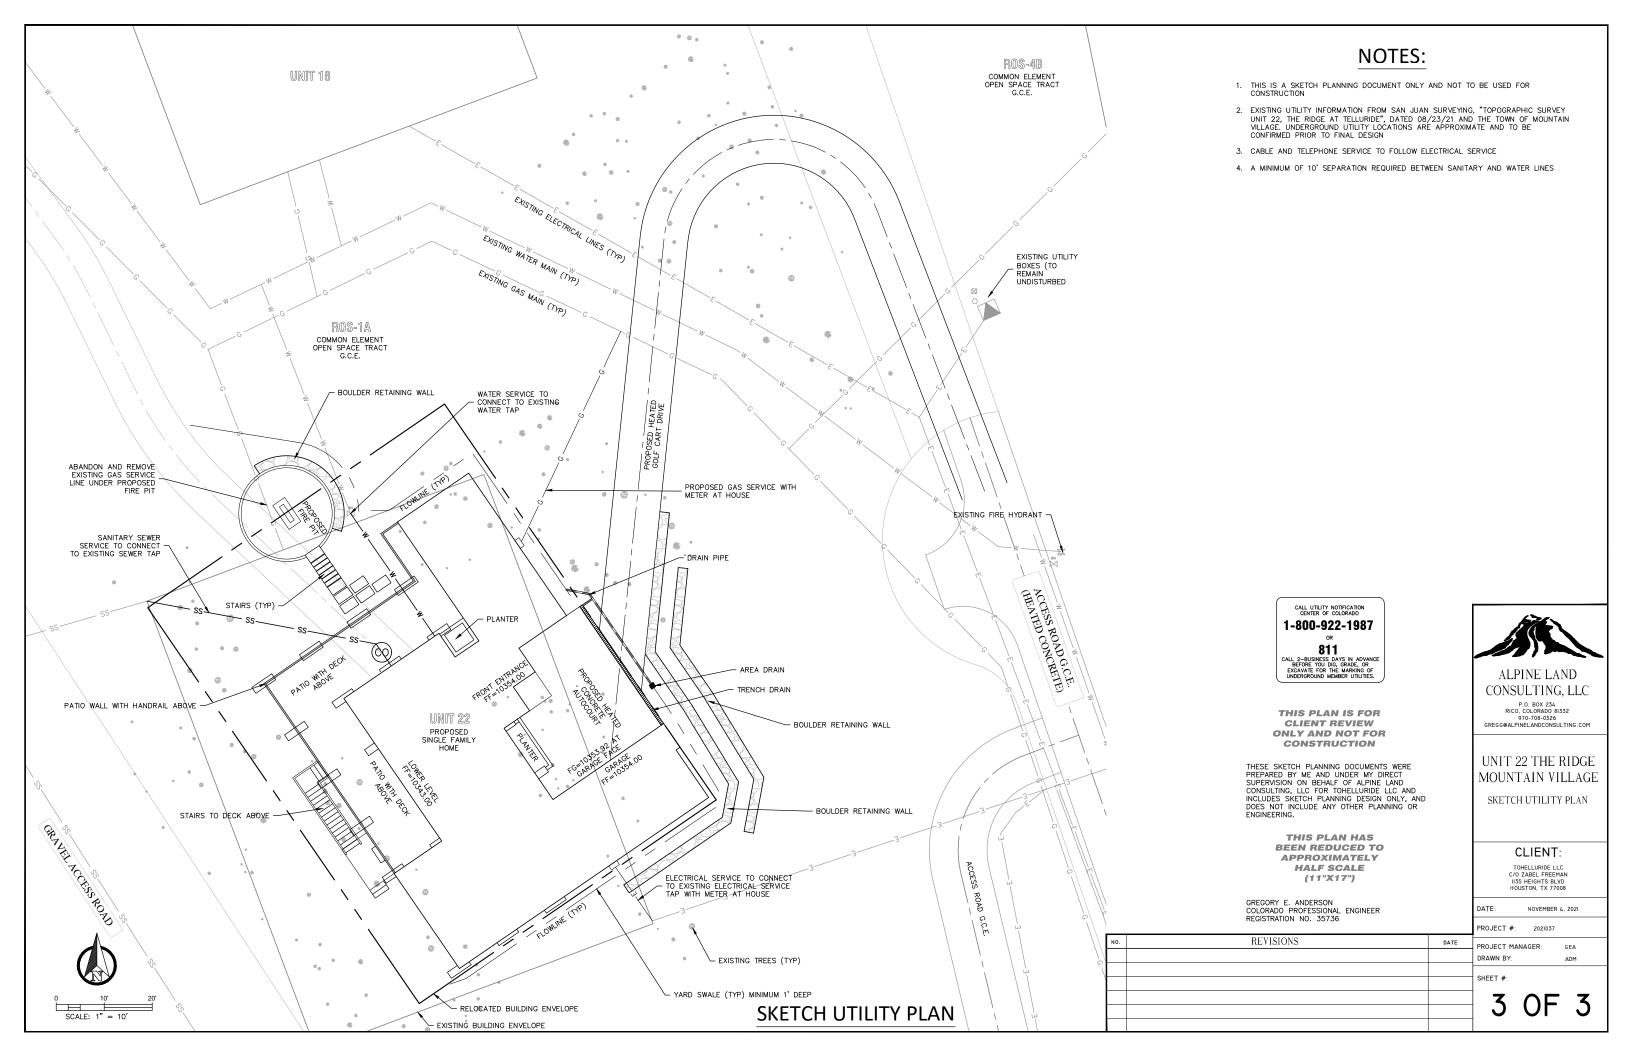

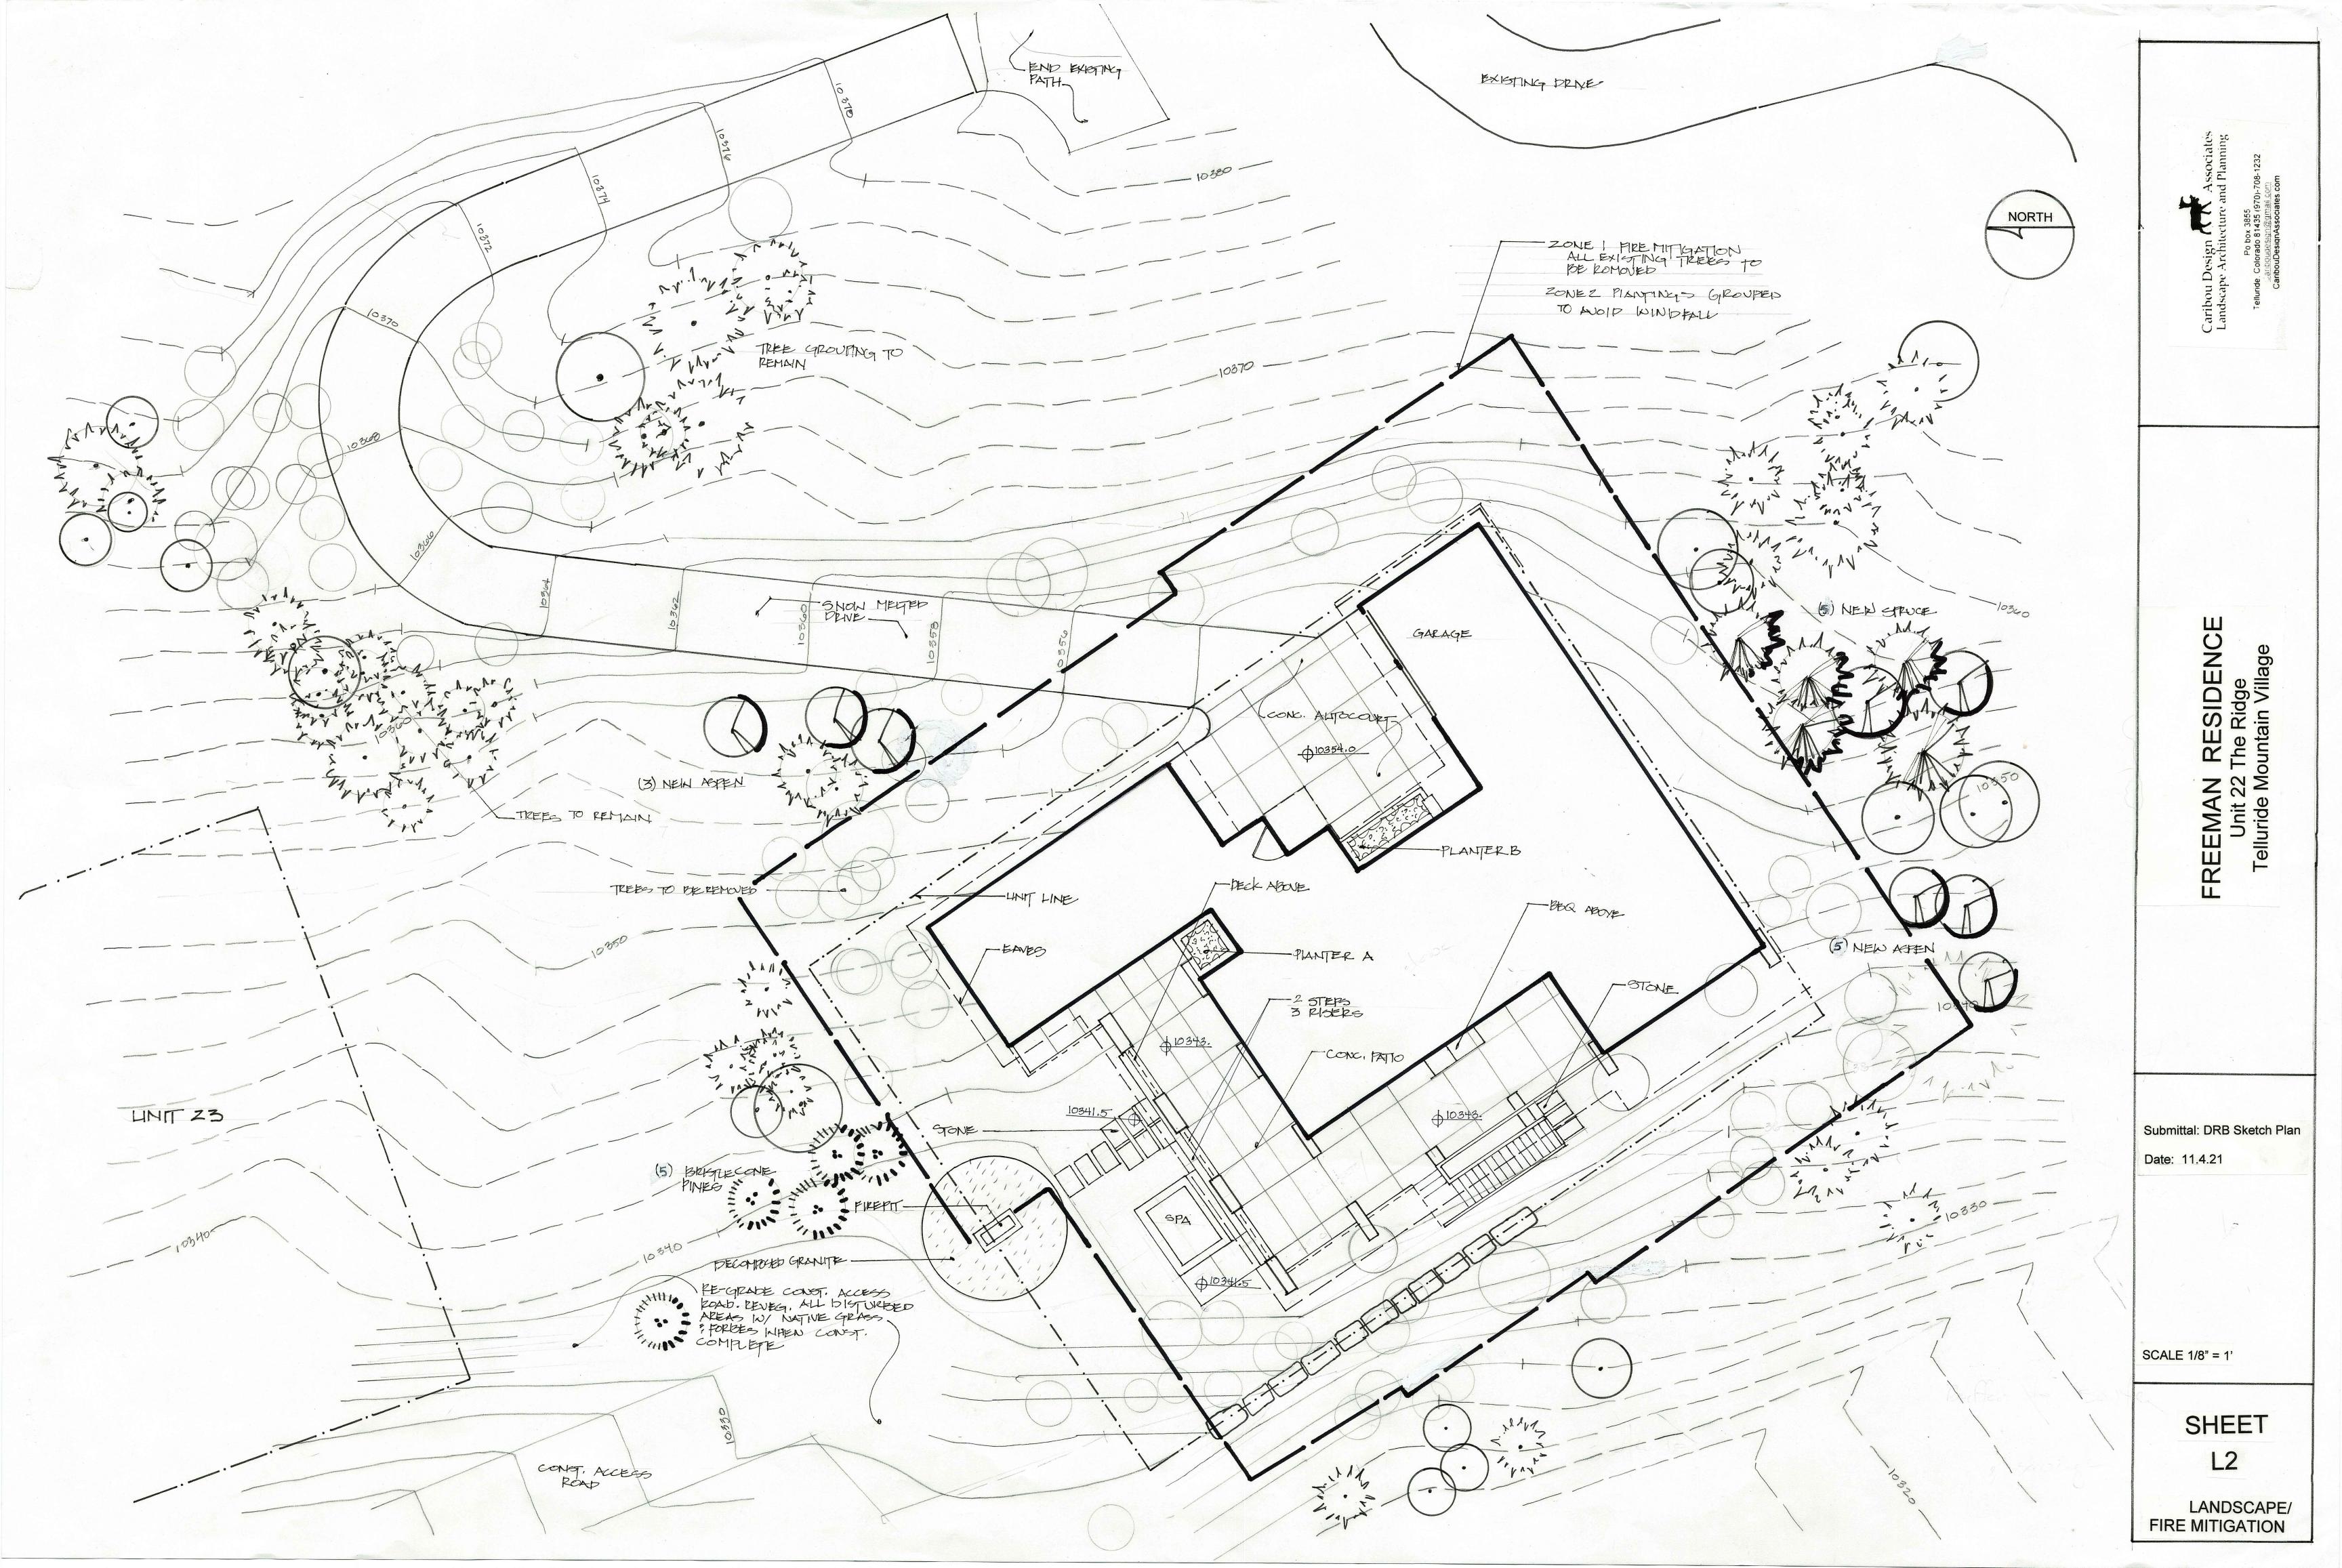

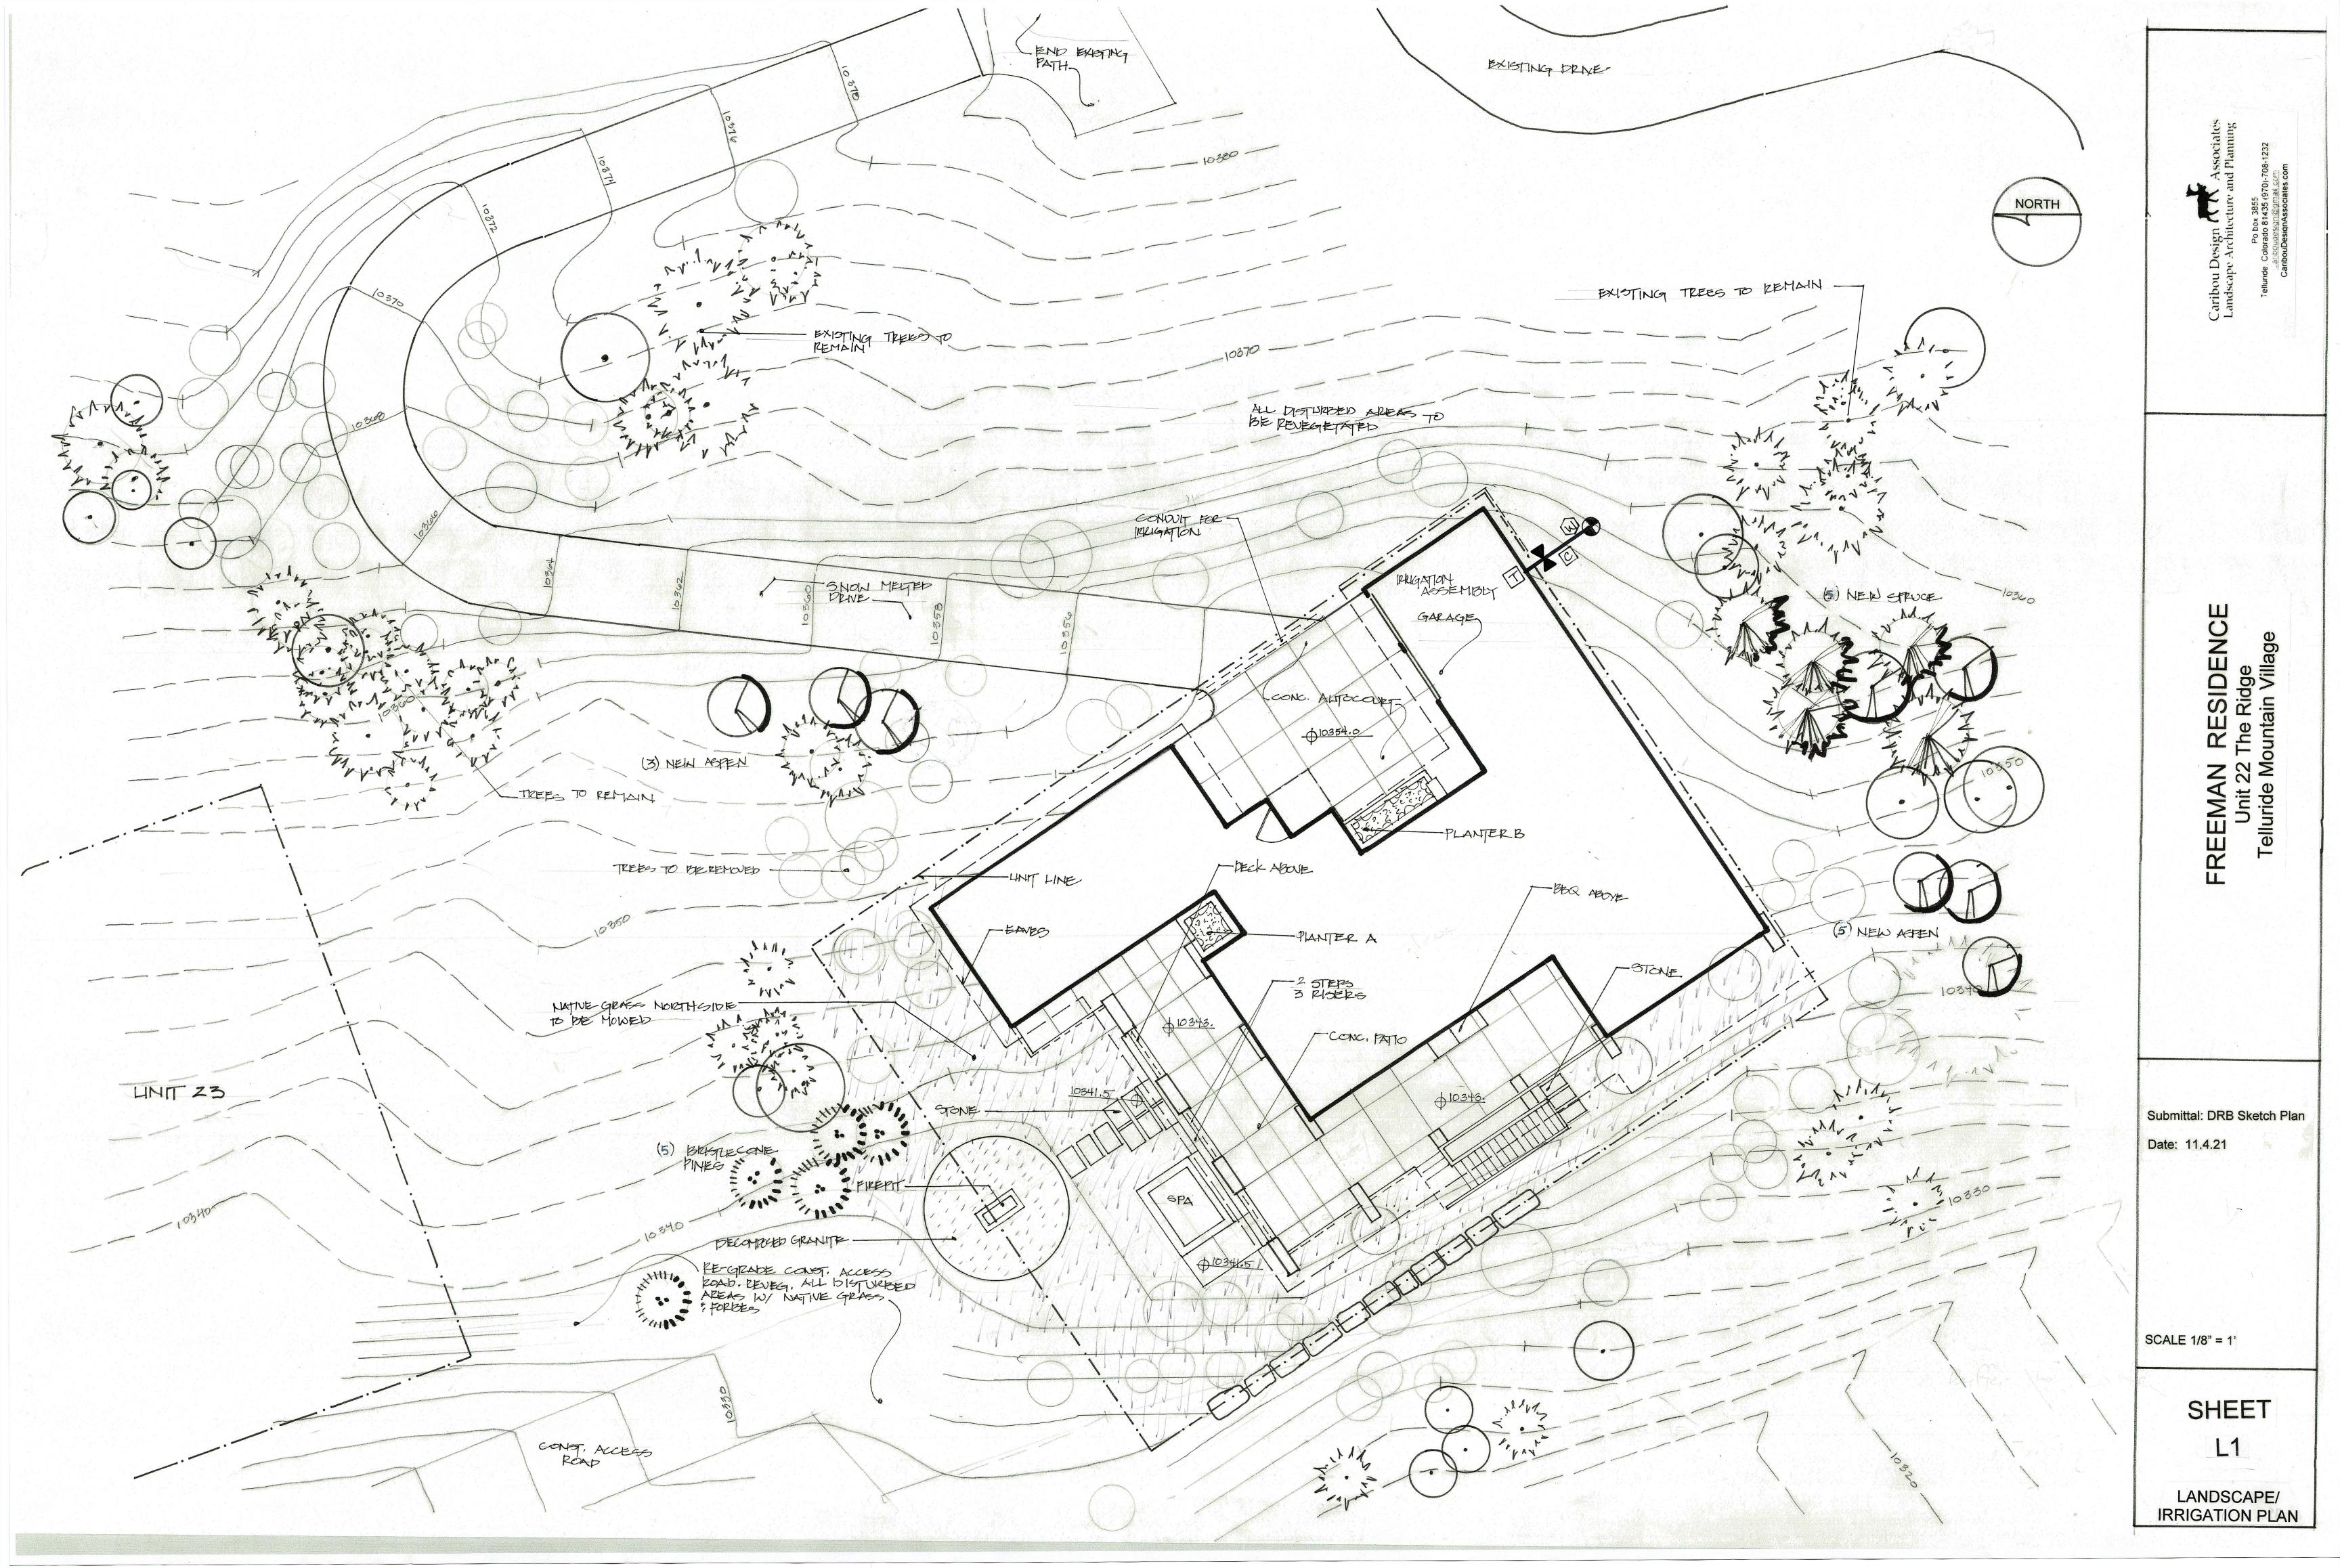

FREEMAN RESIDENCE UNIT 22 THE RIDGE

PLANT SCHEDULE COMMON NAME	BOTANICAL NAME	SIZE	QTY
Populus tremuloides	Quaking Aspen,	2.5" cal.	8
Picea pungens	Colorado spruce	10' 12'	3 2
Pinus aristata	Bristlecone Pine	6'	5
Karl Foerster	Feather Grass	#5	8
Perennials Bed A	Brunerra, Fern, Aconitum napelese	32 SF	
Perennial Bed B	Anemone sylvestris, Ladys Mantle	25 SF	
Native Grass seed	Mountain village native grass mix	Field verify	

GENERAL LANDSCAPE NOTES

- 1. All trees and shrubs shall be field located by project Landscape architect.
- 2. All trees and shrubs shall be backfilled with a topsoil/organic fertilizer mixture at a 2:1 ratio.
- 3. Necessary trees shall e staked with 4 foot metal posts. Trees shall be guyed with 12 gauge galvanized wire and polypropolene tree straps.
- 4. Perennial planting beds shall be tilled to a 6" depth and amended with topsoil and organic fertilizer at a 2:1 ratio.
- 5. Mulch all perennial beds with a pine bark soil conditioner by Southwest Importers; shredded cedar bark.
- 6. All plant material to meet the American Standard for Nursery Stock.
- 7. All newly planted material to be irrigated by an automated irrigation system.
- 8. Re-vegetation of native grasses in primary areas surrounding house shall be irrigated until germination and establishment. At least two growing seasons.
- 9. All planted material shall be irrigated with an automated irrigation system.
- 10. All revegetation areas of native grass seed to be irrigated with automated system for first two growing seasons.
- 11. All planted materials including seed, shall be non-noxious species as specified within the San Miguel County's most current Noxious Weed List.

REVEGETATION NOTES

- 1. Subsoil surfaces shall be tilled to a 4" depth on non fill areas.
- 2. Topsoil shall be spread at a minimum depth of 4" over all areas to be re-vegetated (except on slopes greater than 3:1) and amendments rototilled at a rate of three cubic yards per thousand square feet.
- 3. Broadcasting of seed shall be done immediately after topsoil is applied (within 10 days) to minimize erosion and weeds.
- 4. Areas which have been compacted or relatively undisturbed needing seeding, shall be scarified before broadcasting of seed.
- 5. Broadcast with specified seed mix and follow with dry mulching. Straw or hay shall be uniformly applied over seeded area at a rate 1.5 tons per acre for hay or 2 tons per acre for straw, crimp in.
- 6. On slopes greater than 3:1 erosion control blanket shall be applied in place of straw mulch and pinned.
- 7. All utility cuts shall be re-vegetated within the same planting season after installation of utilities to prevent weed infestation.
- 8. Seed all other areas at a rate of 1.5 lbs per acre. See mix below as specified in DRB guideline:

NATIVE GRASS SEED	MIX
SPECIES	SEED RATE
Western Yarrow	5%
Tall Fescue	10%
Arizona Fescue	5%
Hard Fescue	5%
Creeping Red Fescue	10%
Alpine Bluegrass	15%
Canada Bluegrass	10%
Perennial Ryegrass	15%
Slender Wheatgrass	10%

IRRIGATION NOTES

- 1. Tap with rainbird PVB-075 backflow preventer
- 2. Rainbird RCM-12 electromechanical controller
- 3. 1.5" Wilkins model 500 pressure regulator
- 4. Rainbird 150-PEB 1.5" electric remote control valve
- 5. Class 200 PVC Mainline 1"
- 6. 3/4" 80NSF polylateral line
- 7. All newly planted vegetation is to be irrigated including trees, shrubs, perennials and sod.
- 8. Revegetation areas closest to house shall be irrigated.
- 9. Irrigation for revegetated areas shall be operated for two consecutive growing seasons and turned off

IRRIGATION SCHEDULE

ZONE	LOCATION	HEAD	GPM
1	Aspen trees	drip emitters	-
2	Spruce and Pine trees	drip emitters	-
3	Perennial planters	pop up sprays	24
4	Shrubs East	drip emitters	-
5	Revegetation	rotor heads	temporary

WATER USAGE CHART


Туре	Monthly use	Total # To	tal Monthly Usage
Perennials	2.5 gal./SF	57 SF	143
Revegetation	-	-	-
Shrubs	3.20 gal/EA	8	26
Aspen trees	10 gal. /EA	8	80
Colorado Spruce	25 gal. /EA	5	125
Pinus aristata	20 gal./EA	5	100
CON	IPLETĚ MONTHLY U	SAGE	474 gal/MO

NOTES

- LINEAR LED TO INSTALL ON TOP OF BEAM TO GAZE LIGHT UP WOOD CEILING. SEE LIGHTING DETAIL L2.0-X.
- 2 LED STEP LIGHT FIXTURE TO INSTALL 12" ABOVE CENTER OF TREAD. SEE LIGHTING DETAIL L2.0-X.
- 3 LED FIXTURE TO INSTALL ABOVE HEADER AIMED BACK, PROVIDE JAMB SWITCH OR OCCUPANCY SENSOR.
- 4 LINEAR LED LIGHTING TO BE INSTALLED AT TOP OF BENCH. SEE LIGHTING DETAIL L2.0-X.
- 5 LINEAR LED LIGHTING TO BE INSTALLED AT TOE KICK. SEE LIGHTING DETAIL L2.0-X.
- 6 LINEAR LED TO BE INSTALLED AT HEADER AND CONCEALED BY TRIM PIECE. SEE LIGHTING DETAIL L2.0-X.
- 7 LINEAR LED TO BE INSTALLED RUNNING VERTICALLY CONCEALED BY TRIM PIECE. SEE LIGHTING DETAIL L2.0-X.
- 8 LINEAR LED LIGHTING TO BE INSTALLED ABOVE GARAGE DOOR TO GRAZE LIGHTING DOWN DOOR. SEE LIGHTING DETAIL L2.0-XX.

- 9 LINEAR LED LIGHTING TO BE INSTALLED TUCKED UP BEHIND CABINET. SEE LIGHTING DETAIL L2.0-XX.
- 10 LINEAR LED LIGHTING TO BE INSTALLED IN ROUTERED CHANNEL 3" FROM THE FRONT OF THE SHELF. SEE LIGHTING DETAIL L2.0-XX
- LINEAR LED TO BE INSTALLED INSIDE CEILING SLOT. SEE LIGHTING DETAIL L2.0-XX.
- 12 LINEAR LED TO BE INSTALLED INSIDE CEILING SLOT. SEE LIGHTING DETAIL L2.0-XX.
- 13 STAIR DESIGN, MATERIAL TBD AND REVIEWED BEFORE LIGHTING SELECTION IS MADE.
- 14 INSTALL LINEAR SPREAD LENS WITH DISTRIBUTION PARALLEL TO WALKWAY.
- 15 HOOD LIGHTING TBD AND REVIEWED BEFORE LIGHTING SELECTION IS FINALIZED.



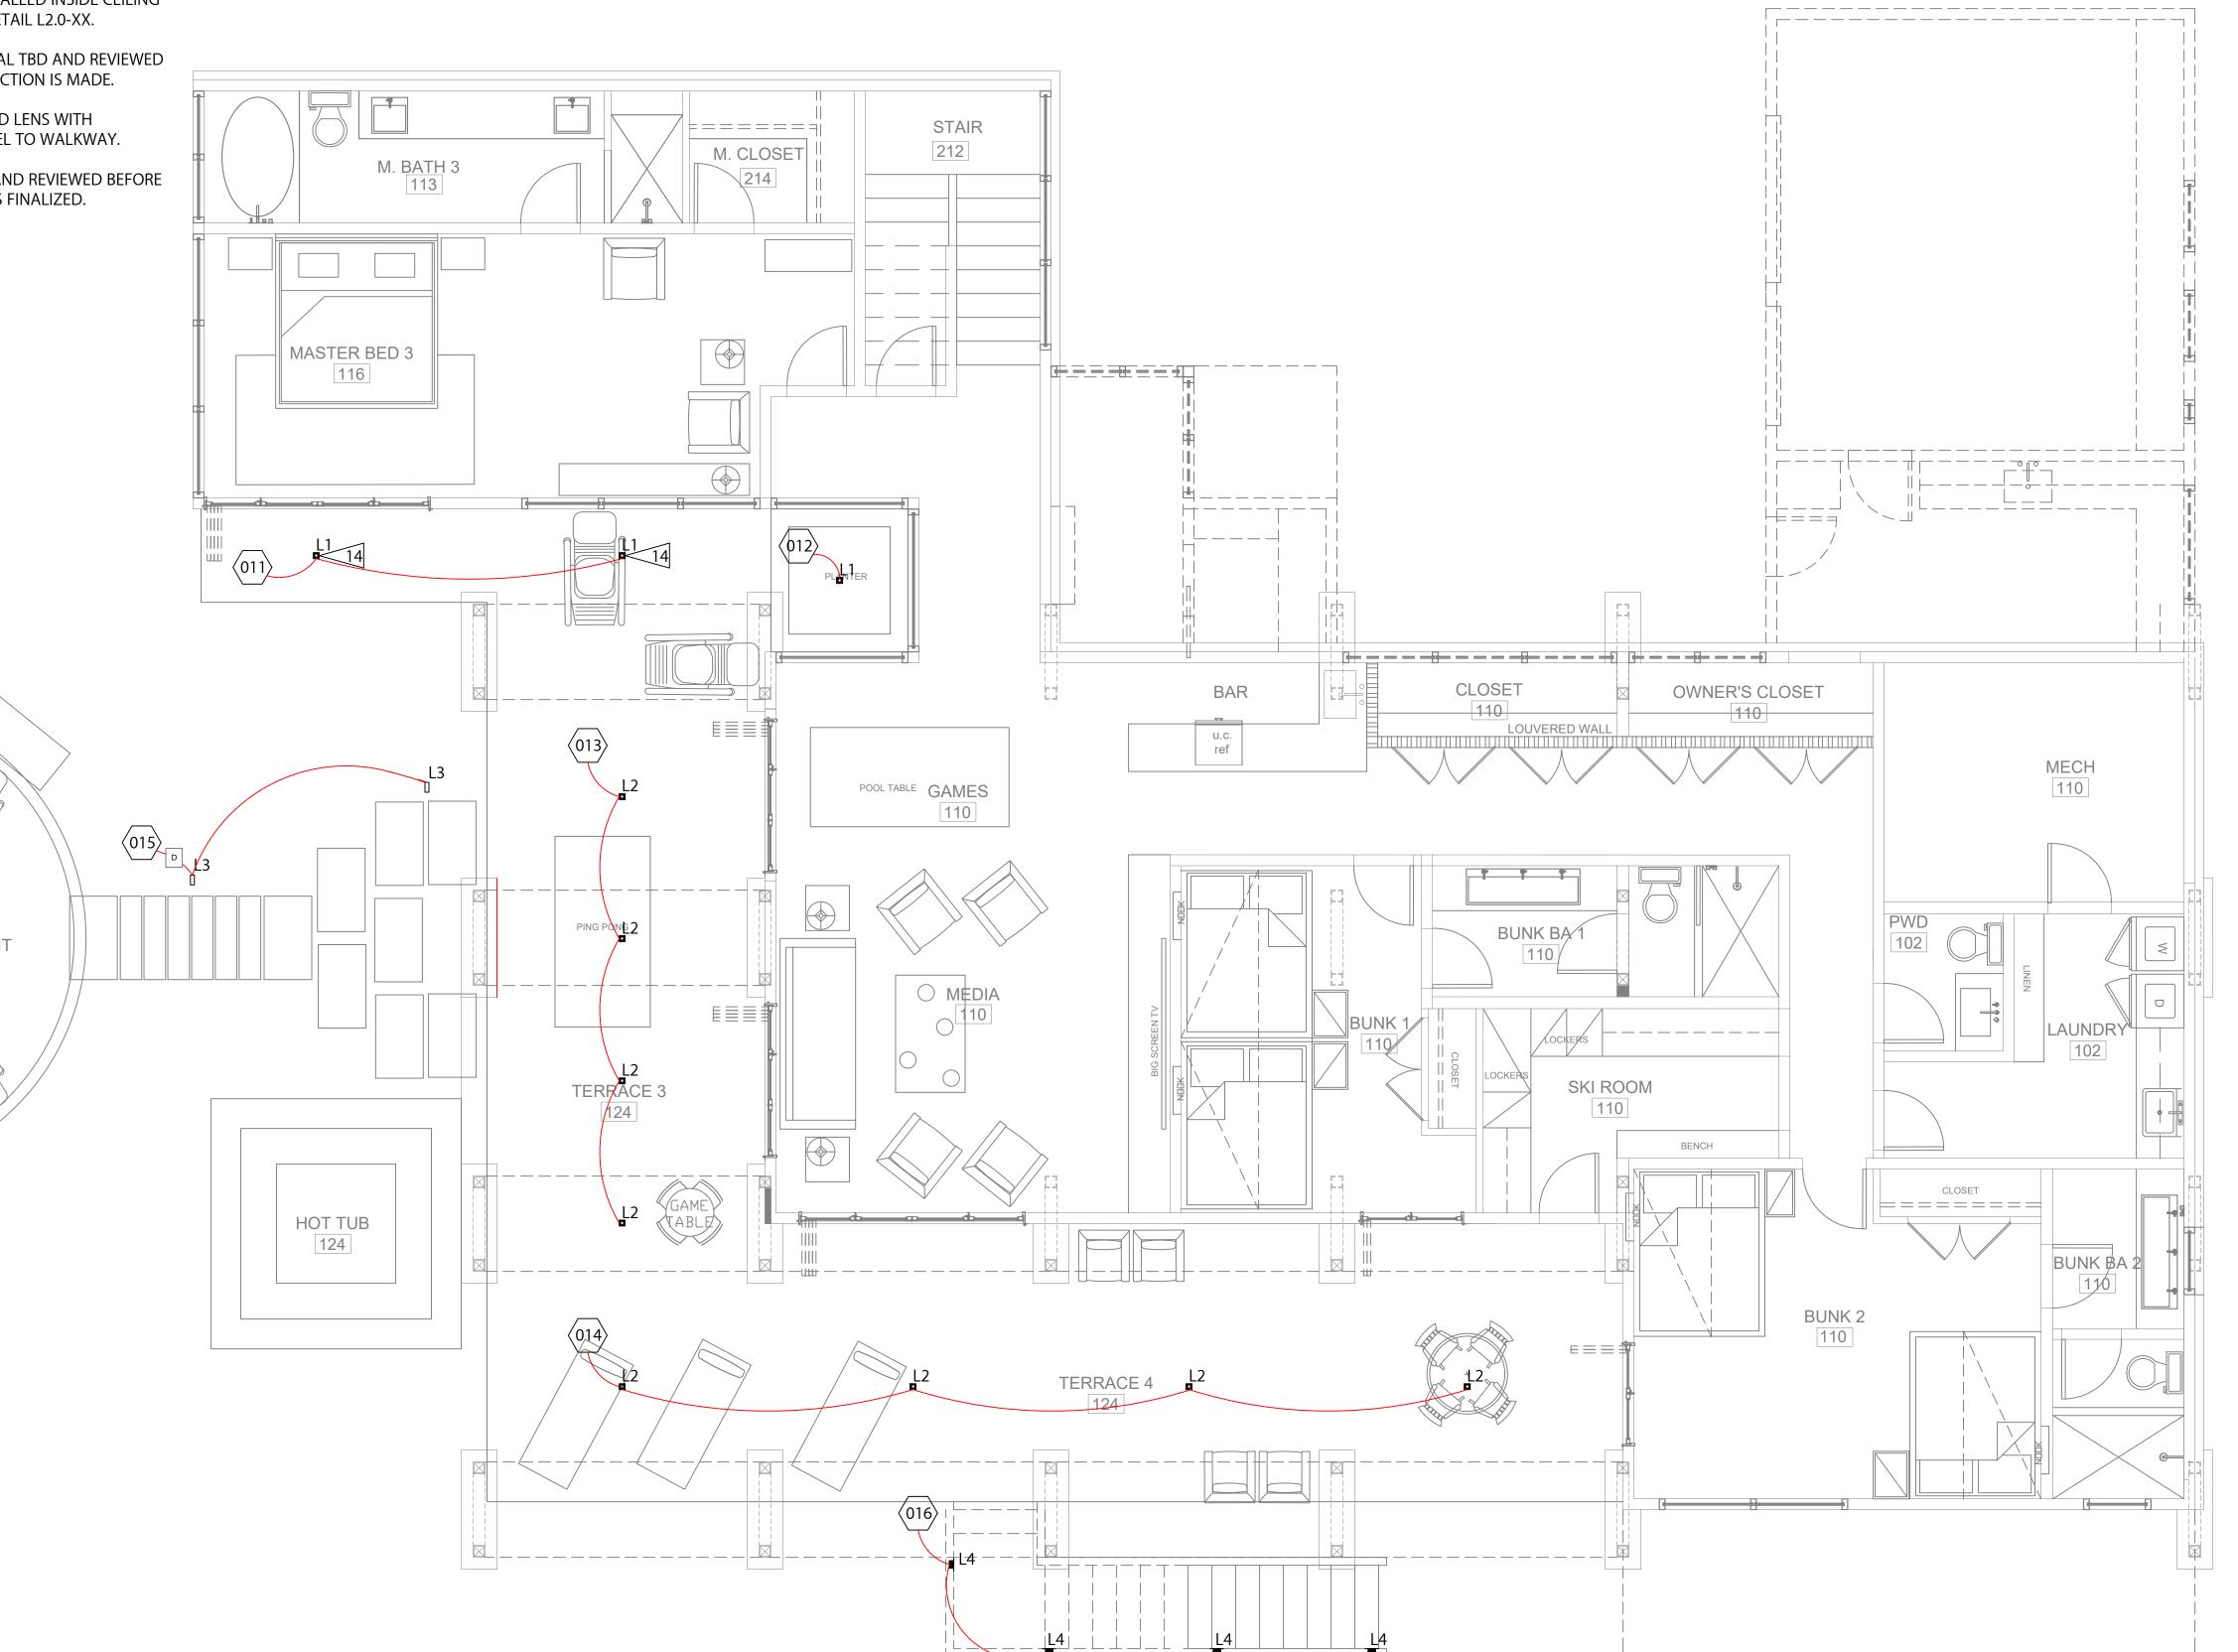



architectural lighting design

618 Mtn Vlg Blvd, Ste 203A PO Box 3610 Telluride, CO 81435 P 970.729.8892 www.luminosityald.com

CONSULTANTS

Architect

MORTON ARCHITECTS
221 S. Pine St.
PO Box 3561
Telluride, CO 81435
970.708.2246

Interior Architect

LINDA EYLES DESIGN
736 Arlington St.
Houston, TX 77007
713.520.7426

Landscape Architect

General Contractor

Electrical Contractor

REVISIONS

DATE DESCRIPTION

11.05.2021 DRB SUBMISSION

PROJECT

FREEMAN RESIDENCE
THE RIDGE LOT 22
MOUNTAIN VILLAGE, CO

SITE ORIENTATION

DRAWING TITLE

LOWER LEVEL EXTERIOR LIGHTING PLAN

DRAWING ISSUE

ISSUE: DRB SUBMISSION

DATE: 05 NOVEMBER 2021

DRAWING: ARCH D - 24 X 36


SCALE: AS NOTED ON DRAWING

JOB #: NA

CHECKED BY: CS

DRAWN BY: AC

DRAWING NO.

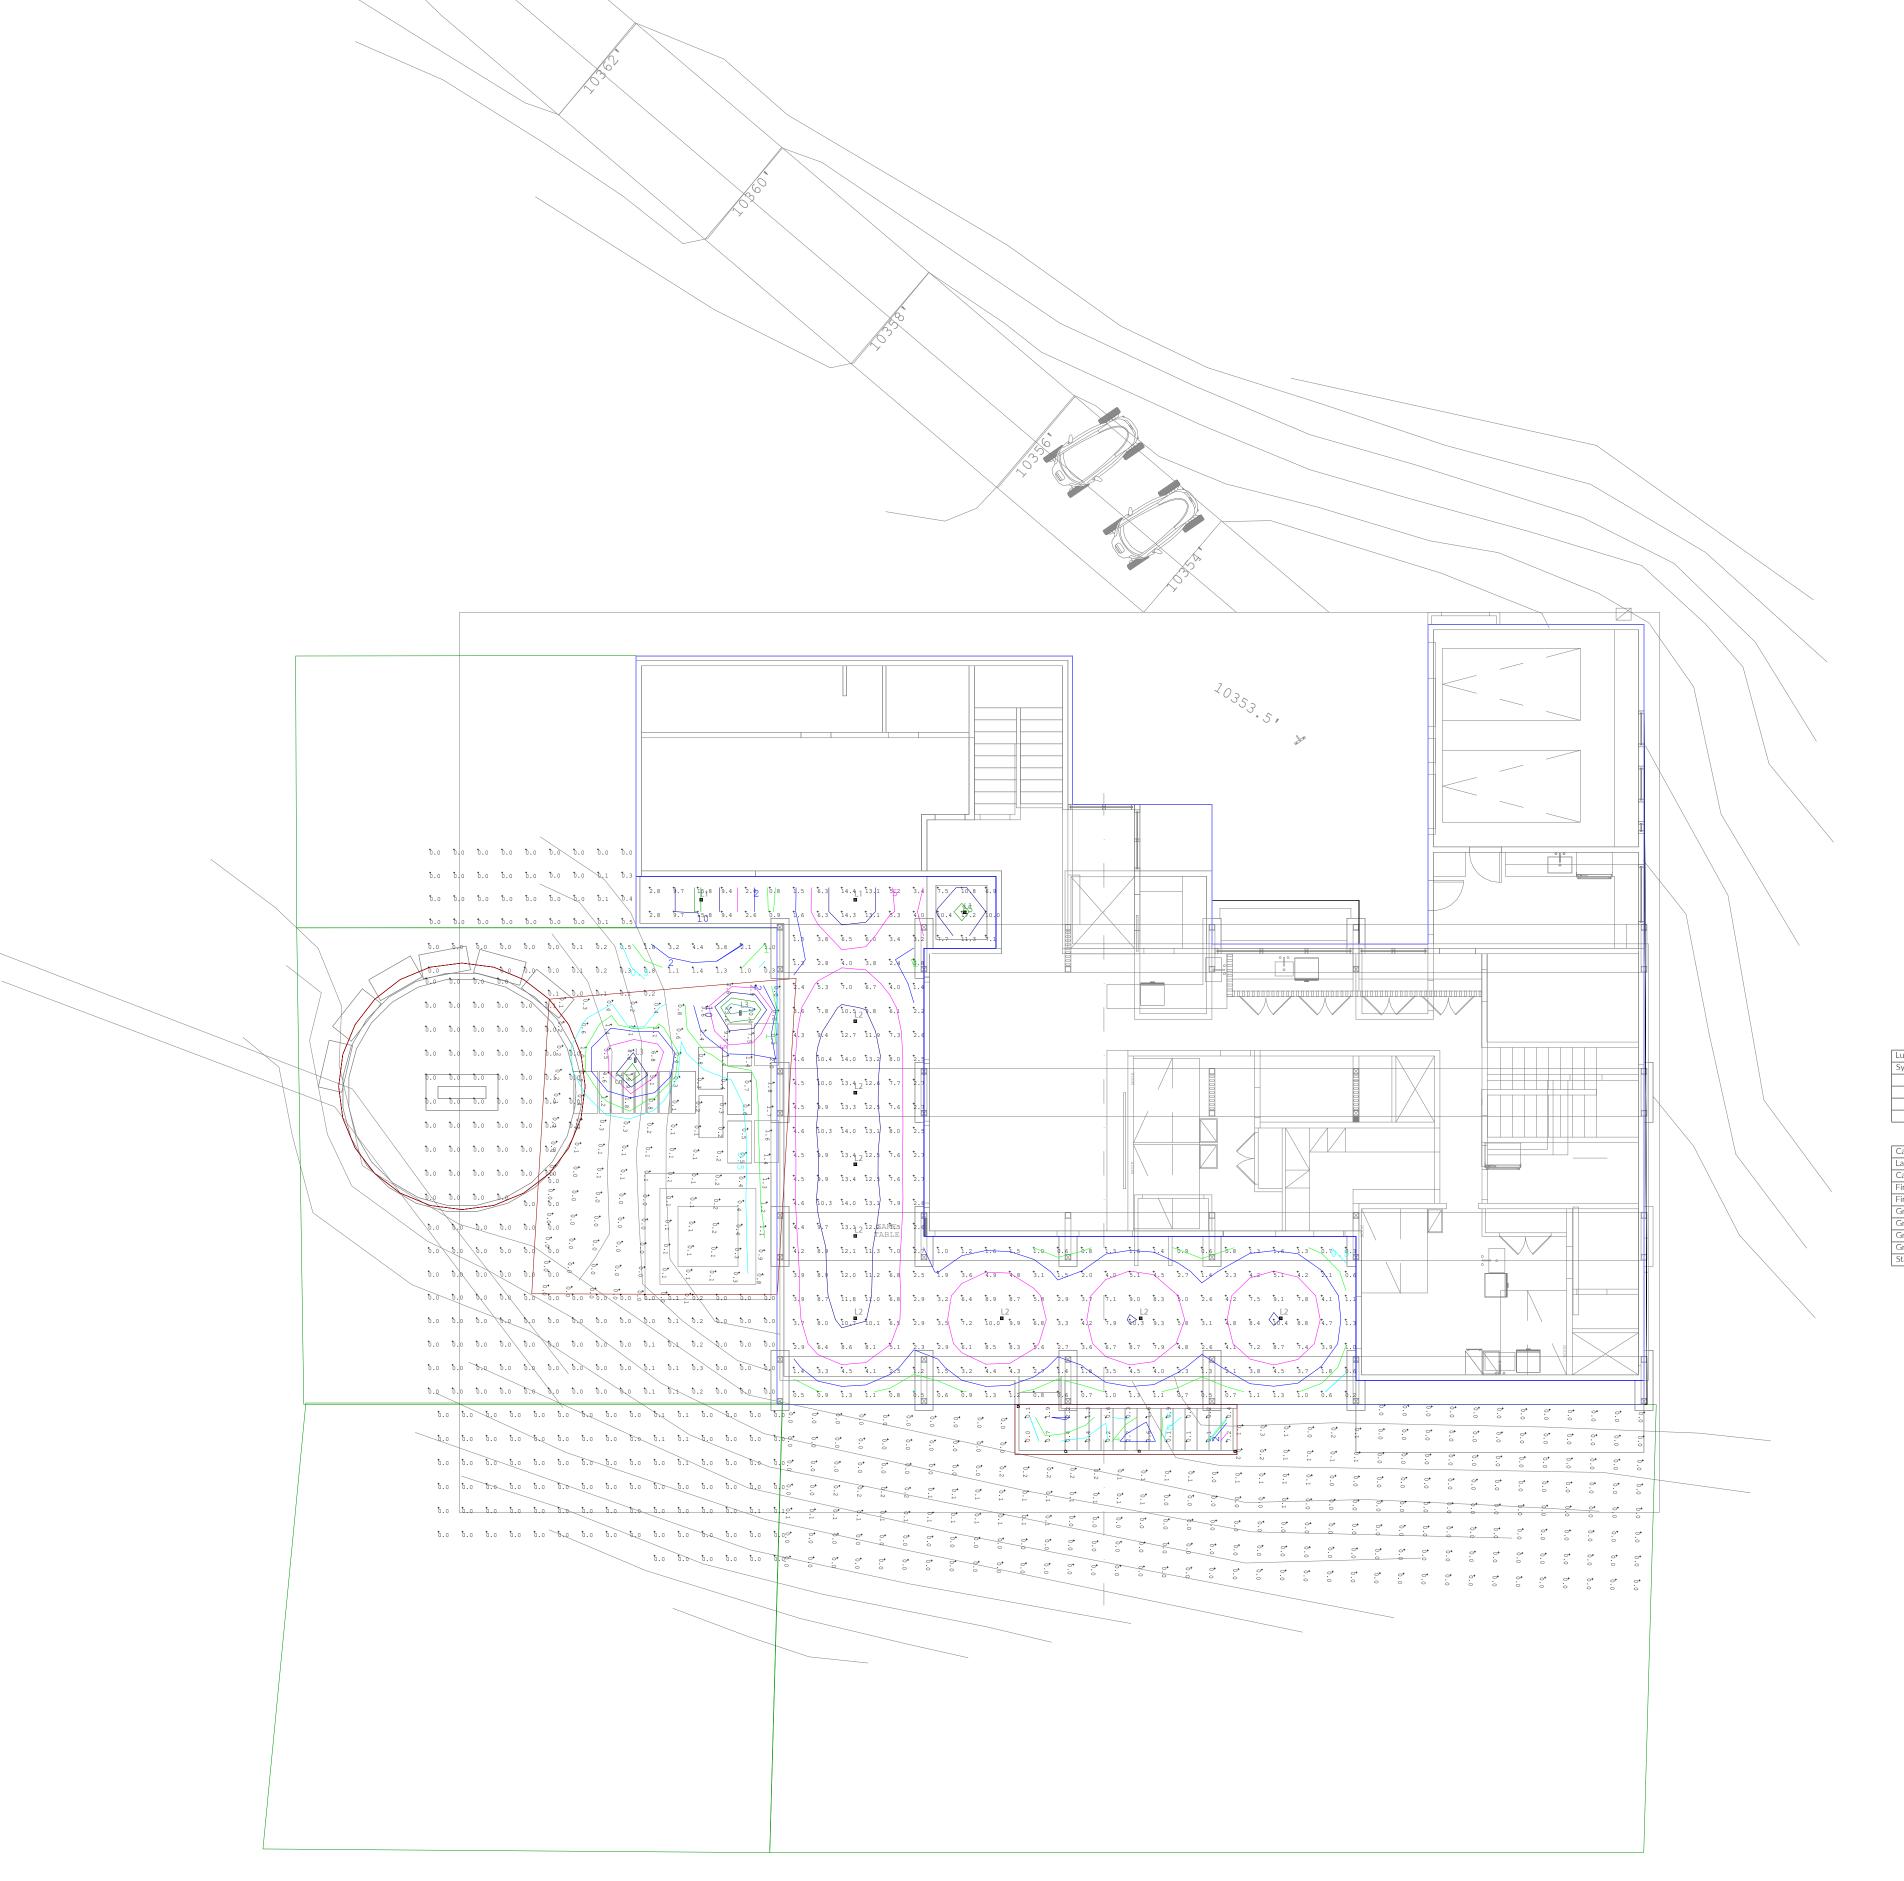

0.700 HNLS11 RECT WL ST LED 30K MVOLT

Calculation Summary Avg Max Min Avg/Min Max/N CalcPts_1 5.48 17.2 0.2 27.40 86.00 Firepit stairs_Firepit stai 1.26 23.6 0.0 N.A. N.A. Firepit_Top 0.00 0.1 0.0 N.A. N.A. Grade 1_Grade 1 0.20 4.4 0.0 N.A. N.A. Grade 12_Grade 12 0.03 0.3 0.0 N.A. N.A. Grade 13_Grade 13 0.01 0.1 0.0 N.A. N.A.		12 V IIII OCOP 210110				,
Label Avg Max Min Avg/Min Max/N CalcPts_1 5.48 17.2 0.2 27.40 86.00 Firepit stairs_Firepit stai 1.26 23.6 0.0 N.A. N.A. Firepit_Top 0.00 0.1 0.0 N.A. N.A. Grade 1_Grade 1 0.20 4.4 0.0 N.A. N.A. Grade 12_Grade 12 0.03 0.3 0.0 N.A. N.A.						
CalcPts_1 5.48 17.2 0.2 27.40 86.00 Firepit stairs_Firepit stai 1.26 23.6 0.0 N.A. N.A. Firepit_Top 0.00 0.1 0.0 N.A. N.A. Grade 1_Grade 1 0.20 4.4 0.0 N.A. N.A. Grade 12_Grade 12 0.03 0.3 0.0 N.A. N.A.	Calculation Summary					
Firepit stairs_Firepit stai 1.26 23.6 0.0 N.A. N.A. Firepit_Top 0.00 0.1 0.0 N.A. N.A. Grade 1_Grade 1 0.20 4.4 0.0 N.A. N.A. Grade 12_Grade 12 0.03 0.3 0.0 N.A. N.A.	Label	Avg	Max	Min	Avg/Min	Max/Min
Firepit_Top 0.00 0.1 0.0 N.A. N.A. Grade 1_Grade 1 0.20 4.4 0.0 N.A. N.A. Grade 12_Grade 12 0.03 0.3 0.0 N.A. N.A.	CalcPts_1	5.48	17.2	0.2	27.40	86.00
Grade 1_Grade 1 0.20 4.4 0.0 N.A. N.A. Grade 12_Grade 12 0.03 0.3 0.0 N.A. N.A.	Firepit stairs_Firepit stai	1.26	23.6	0.0	N.A.	N.A.
Grade 12_Grade 12 0.03 0.3 0.0 N.A. N.A.	Firepit_Top	0.00	0.1	0.0	N.A.	N.A.
_	Grade 1_Grade 1	0.20	4.4	0.0	N.A.	N.A.
Grade 13_Grade 13 0.01 0.1 0.0 N.A. N.A.	Grade 12_Grade 12	0.03	0.3	0.0	N.A.	N.A.
	Grade 13_Grade 13	0.01	0.1	0.0	N.A.	N.A.

LUMINOSITY

architectural lighting design

618 Mtn Vlg Blvd, Ste 203A PO Box 3610 Telluride, CO 81435 P 970.729.8892 www.luminosityald.com

CONSULTANTS

Architect

MORTON ARCHITECTS
221 S. Pine St.
PO Box 3561
Telluride, CO 81435
970.708.2246

Interior Architect

LINDA EYLES DESIGN 736 Arlington St. Houston, TX 77007 713.520.7426

Landscape Architect

General Contractor

Electrical Contractor

REVISIONS

DATE DESCRIPTION

11.05.2021 DRB SUBMISSION

PROJECT

FREEMAN RESIDENCE
THE RIDGE LOT 22
MOUNTAIN VILLAGE, CO

SITE ORIENTATION

DRAWING TITLE

LOWER LEVEL

EXTERIOR LIGHTING
CALC

DRAWING ISSUE

ISSUE: DRB SUBMISSION

DATE: 05 NOVEMBER 2021

DRAWING: ARCH D - 24 X 36

SCALE: AS NOTED ON DRAWING

JOB #: NA

DRAWN BY: AC

DRAWING NO.



1 LINEAR LED TO INSTALL ON TOP OF BEAM TO GAZE LIGHT UP WOOD CEILING. SEE LIGHTING DETAIL L2.0-X.

2 LED STEP LIGHT FIXTURE TO INSTALL 12" ABOVE CENTER OF TREAD. SEE LIGHTING DETAIL L2.0-X.

3 LED FIXTURE TO INSTALL ABOVE HEADER AIMED BACK, PROVIDE JAMB SWITCH OR OCCUPANCY SENSOR.

4>> LINEAR LED LIGHTING TO BE INSTALLED AT TOP OF BENCH. SEE LIGHTING DETAIL L2.0-X.

5 LINEAR LED LIGHTING TO BE INSTALLED AT TOE KICK. SEE LIGHTING DETAIL L2.0-X.

6 LINEAR LED TO BE INSTALLED AT HEADER AND CONCEALED BY TRIM PIECE. SEE LIGHTING DETAIL L2.0-X.

7 LINEAR LED TO BE INSTALLED RUNNING VERTICALLY CONCEALED BY TRIM PIECE. SEE LIGHTING DETAIL L2.0-X.

8 LINEAR LED LIGHTING TO BE INSTALLED ABOVE GARAGE DOOR TO GRAZE LIGHTING DOWN DOOR. SEE LIGHTING DETAIL L2.0-XX.

9 LINEAR LED LIGHTING TO BE INSTALLED TUCKED UP BEHIND CABINET. SEE LIGHTING DETAIL L2.0-XX.

10> LINEAR LED LIGHTING TO BE INSTALLED IN ROUTERED CHANNEL 3" FROM THE FRONT OF THE SHELF. SEE LIGHTING DETAIL L2.0-XX

11 > LINEAR LED TO BE INSTALLED INSIDE CEILING SLOT. SEE LIGHTING DETAIL L2.0-XX.

12>> LINEAR LED TO BE INSTALLED INSIDE CEILING SLOT. SEE LIGHTING DETAIL L2.0-XX.

13>> STAIR DESIGN, MATERIAL TBD AND REVIEWED BEFORE LIGHTING SELECTION IS MADE.

14 INSTALL LINEAR SPREAD LENS WITH DISTRIBUTION PARALLEL TO WALKWAY.

15>> HOOD LIGHTING TBD AND REVIEWED BEFORE

LIGHTING SELECTION IS FINALIZED.

16>

MASTER BED 1 216

TERRACE 1

M. BATH 1

213

ENTRY 203 (006)

STAIR

212

GAS METER

|=======

M. CLOSET

MUD ROOM

∥OWN⊭R'S COATS

BIKE STORAGE UNDER STAIR

PLANTER

AUTOCOURT

222

004

003 D1

CONCIERGE/MUD

202

LAUNDRY

202

DESK

75" TV ABOVE under counter micro

TERRACE 2 KITCHEN 219

DRAWING ISSUE

05 NOVEMBER 202 AS NOTED ON DRAWING JOB #: DRAWN BY: AC

DRAWING TITLE

MAIN LEVEL EXTERIOR

LIGHTING PLAN

DRAWING NO.

CHECKED BY: CS

LUMINOSITY

architectural lighting design

618 Mtn Vlg Blvd, Ste 203A

Telluride, CO 81435

www.luminosityald.com

PO Box 3610

P 970.729.8892

CONSULTANTS

Interior Architect

Landscape Architect

General Contractor

Electrical Contractor

_______ DATE DESCRIPTION 11.05.2021 DRB SUBMISSION

REVISIONS

PROJECT

THE RIDGE LOT 22

SITE ORIENTATION


MOUNTAIN VILLAGE, CO

FREEMAN RESIDENCE

Architect

MORTON ARCHITECTS 221 S. Pine St. PO Box 3561 Telluride, CO 81435 970.708.2246

LINDA EYLES DESIGN 736 Arlington St. Houston, TX 77007 713.520.7426

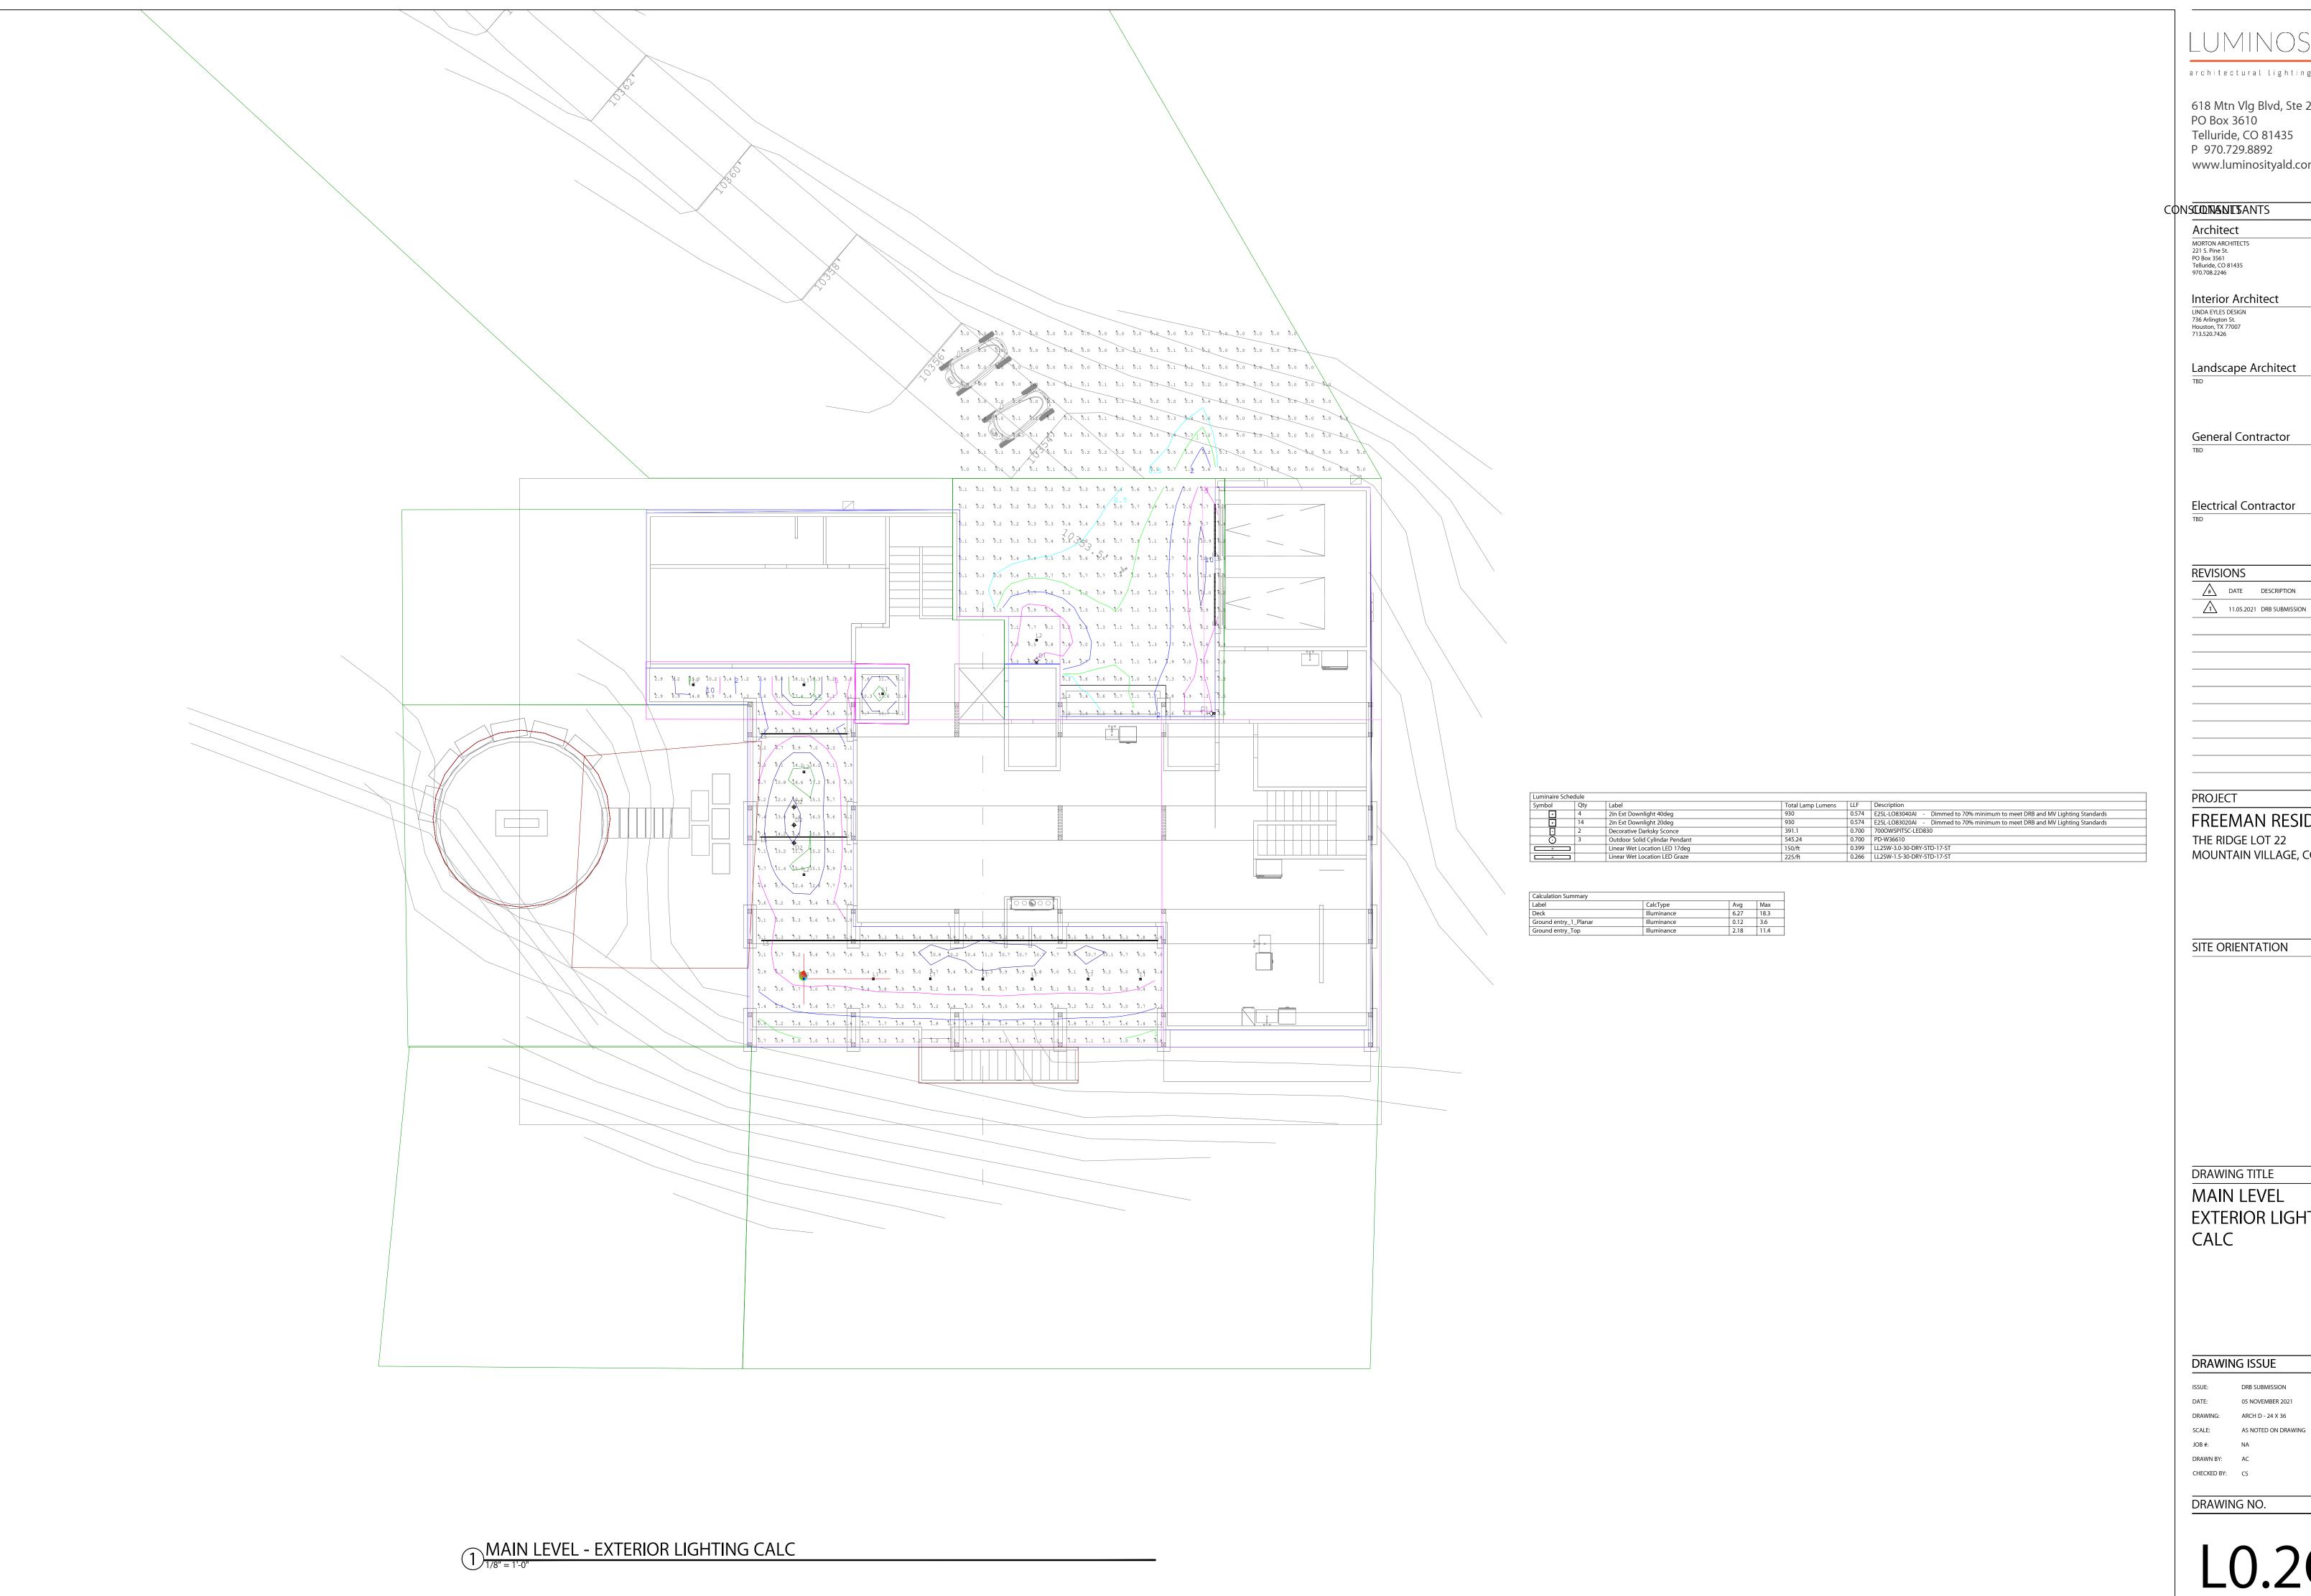

architectural lighting design

618 Mtn Vlg Blvd, Ste 203A PO Box 3610 Telluride, CO 81435 P 970.729.8892 www.luminosityald.com

Interior Architect

Landscape Architect

DATE DESCRIPTION

FREEMAN RESIDENCE THE RIDGE LOT 22 MOUNTAIN VILLAGE, CO

SITE ORIENTATION

MAIN LEVEL **EXTERIOR LIGHTING**

DRAWING ISSUE

DRB SUBMISSION 05 NOVEMBER 2021 AS NOTED ON DRAWING

DRAWING NO.

LUMINOSITY

architectural lighting design

618 Mtn Vlg Blvd, Ste 203A PO Box 3610 Telluride, CO 81435 P 970.729.8892 www.luminosityald.com

CONSULTANTS

Architect

MORTON ARCHITECTS
221 S. Pine St.
PO Box 3561
Telluride, CO 81435
970.708.2246

Interior Architect

LINDA EYLES DESIGN 736 Arlington St. Houston, TX 77007 713.520.7426

Landscape Architect

General Contractor

Electrical Contractor

REVISIONS

DATE DESCRIPTION

11.05.2021 DRB SUBMISSION

PROJECT

FREEMAN RESIDENCE
THE RIDGE LOT 22
MOUNTAIN VILLAGE, CO

SITE ORIENTATION

DRAWING TITLE

LIGHTING DETAILS

DRAWING ISSUE

ISSUE: DRB SUBMISSION

DATE: 05 NOVEMBER 2021


DRAWING: ARCH D - 24 X 36

SCALE: AS NOTED ON DRAW

DRAWN BY: AC

CHECKED BY: CS

DRAWING NO.

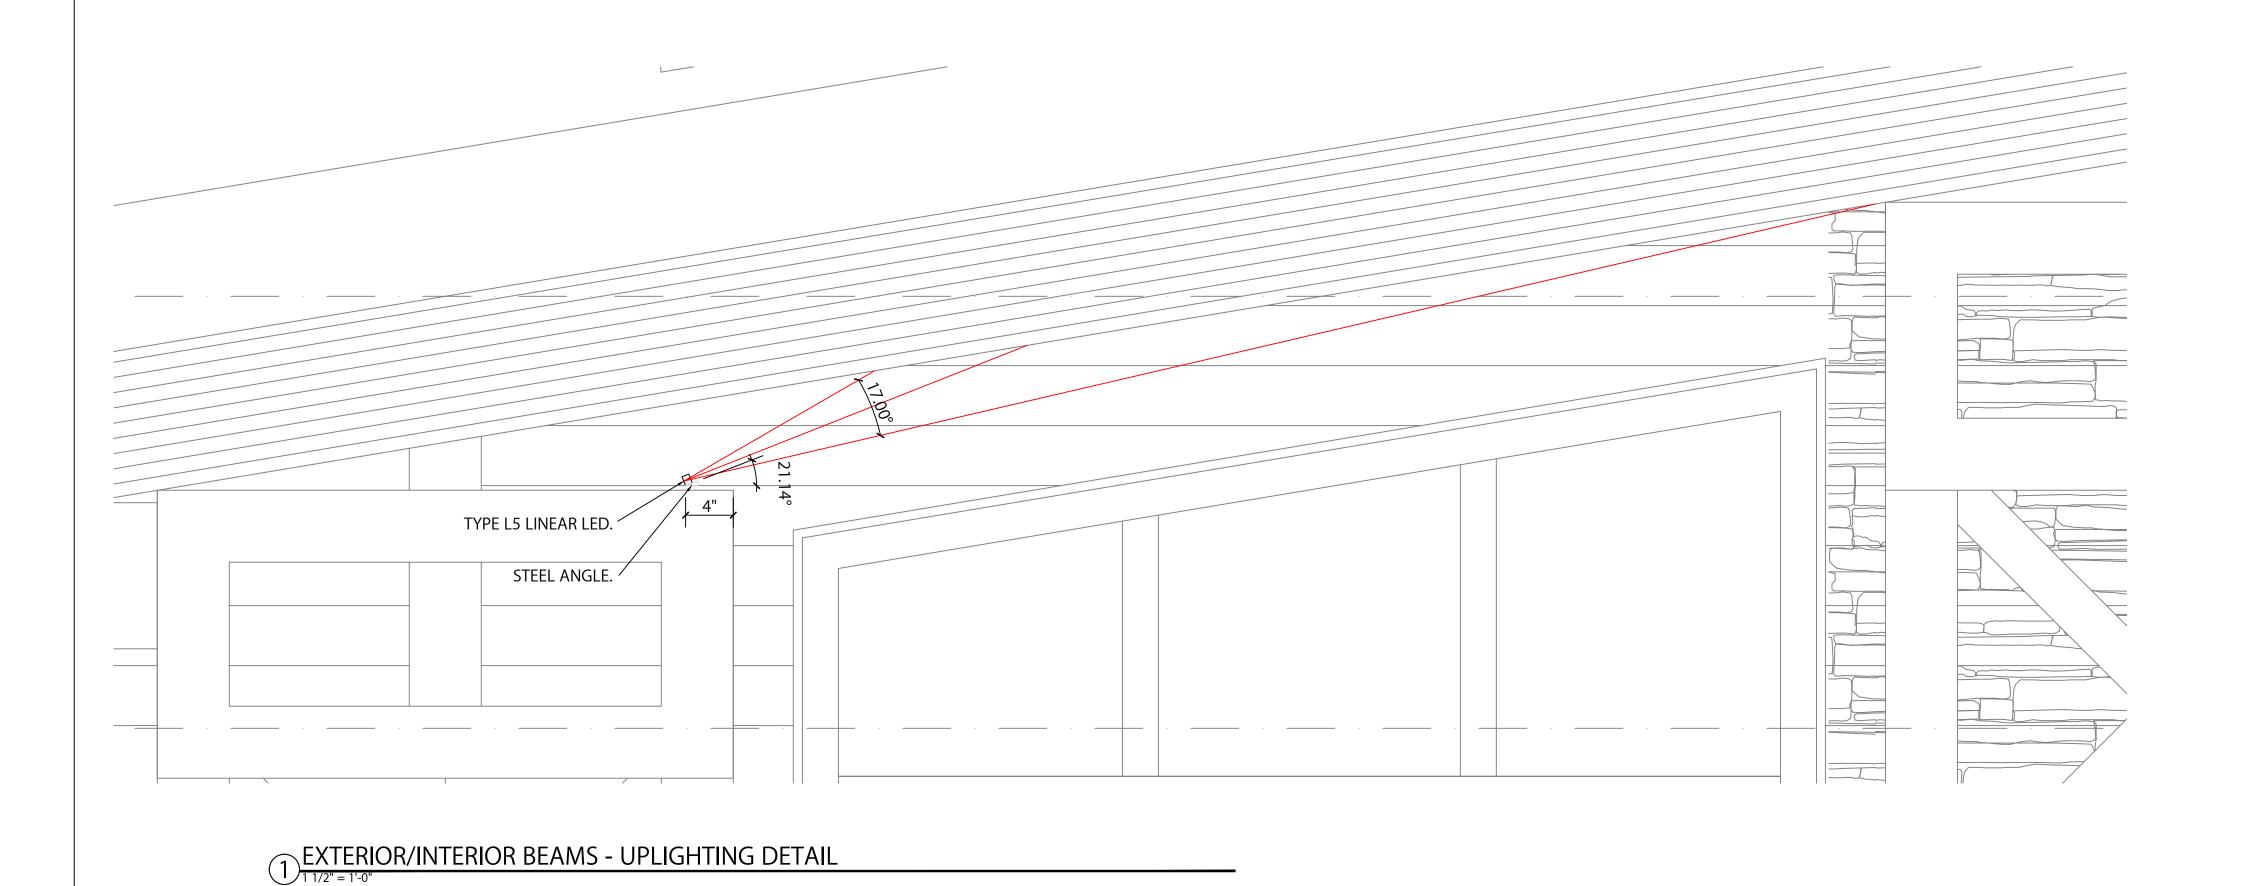



FREEMAN RESIDENCE | EXTERIOR LIGHTING SCHEDULE | REVISION 1

FIXT TYPE	IMAGE	DESCRIPTION	MANUFACTURER	MODEL	CATALOG NO	LAMP LEN (F	IGTH VOLTAG	E DIMMING	REMOTE / INTEGRAL POWER SUPPLY	ENERGY (W)	ENERGY (W/FT)	FINISH / IP RATING DIMENSION	S ACCESSORIES	Dimming Levels	NOTES LOCATION
L1	2.5° GA mm LSAT LSAT	2" Adjustable Recessed Downlight	Element	Element 2* LED	Housing: E2S WC LO927 20 A I Trim: E2S L F H TBD	2700K, 930 Lumens, 12 Watts, 90+ CRI	120V-27	√V Triac	Integral Power Supply	12.0		TBD / Wet Location	"T	Dimmed to 70% minimum to meet DRB and MV Lighting Standards	Wood Ceiling, Flat Trim, Downlights
L2	2.5° 64 mm 1 LL41 34 mm 197 197 197 197 197 197 197 197 197 19	2" Adjustable Recessed Downlight	Element	Element 2* LED	Housing: E2S WC LO927 40 A I Trim: E2S L F H TBD	2700K, 930 Lumens, 12 Watts, 90+ CRI	120V-27	√ Triac	Integral Power Supply	12.0		TBD / Wet Location Housing: 10 X 12"L X 5.2 Trim: 2.5"V	"Т	Dimmed to 70% minimum to meet DRB and MV Lighting Standards	color tbc), Flangeless, Downlights
L3	STRUT PATH shown in Block	LED Path Light	Tech	Strut Pathway	7000ASTR 927 18 D B 12 5 (ST if stake mounting kit is needed) + 7000T150T	2700K, 693.1 Lumens, 15 Watts, 90+ CRI	12v	MLV	Remote Power Supply - Location wet rated	15.0		Black / Wet Location 1.5°W X 6.6 X 1.8°T + 4° base		Dimmed to 44% minimum to meet DRB and MV Lighting Standards	Lighting
L4	4.60° Q 2.50° Ribbed design with mate black finish to reduce glare	Exterior Step Light	Aquity	Pathfinder Step Light 11	HNLS11 RECT MVOLT ST 27K ZT MIN5 WL TBD	2700K, 3W, 36 Lumens	120V	ELV	Line Voltage	3.9W		TBD / 2.5°W X 4.6 Wet X 3.5°D	Т		Finish TBD Exterior Stair Step Light



FREEMAN RESIDENCE | EXTERIOR LIGHTING SCHEDULE | REVISION 1

FIXT TYPE	IMAGE	DESCRIPTION	MANUFACTURER	MODEL	CATALOG NO	LAMP	LENGTH (FT.)	VOLTAGE	DIMMING	REMOTE / INTEGRAL POWER SUPPLY	ENERGY (W)	ENERGY (W/FT)	FINISH / IP RATING	DIMENSIONS	ACCESSORIES	Dimming Levels	NOTES	LOCATION
L5	Profile with optical lens magnet mounting clip	1.5W Static White LED Linear	Qtran	LALO 17 Deg / SW24/1.5	Extrusion: LALO BK SST 17DEG XX XX + LEDs: SW224/1.5 WET 27 XX	2700K, 150 Lumens/ft, 1.5 Watts/ft, 96 CRI		24VDC	MLV	Remote Power Supply		1.5	Black / Wet Location	0.81"W X 0.80°T with magnet clip	Connectors: Provide PS to tape, jumper cables and end caps as required.		Lalo Extrusion, 17 Degree Beam Spread + Magnet Clip	Exterior LED Linear Graze Lighting - wood ceiling
L6	Profile with optical lens stainless steel mounting	3.0W Static White LED Linear	Qtran	LALO 17 Deg / SW24/3.0	Extrusion: LALO BK MG 17DEG XX XX LEDs: SW24/3.0 WET 27 XX	2700K, 225 Lumens/ft, 3.0 Watts/ft, 96 CRI		24VDC	MLV	Remote Power Supply		3.0	Black / Wet Location	0.81"W X 0.60"T with Stainless steel clip	Connectors: Provide PS to tape, jumper cables and end caps as required.		Lalo Extrusion, 17 Degree Beam Spread + Stainless Steel Clip	Exterior LED Linear Graze Lighting - Garage Door Graze
D1	PEAK shown in boross	Exterior Dark- Sky LED Decorative Sconce	Tech	Peak Wall Sconce		Warm Dimming 3000- 2200K 391.1 Lumens, 14.5W		120V	ELV	Integral Power Supply		14.5	Bronze / IP65	5°W X 13°T X 4.3°D				Exterior Dark-Sky Decorative Sconce
D2		Cylinder Pendant	WAC	Caliber	PD-W36610 2700K TBD	2700K, 508 Lumens, 12W, 90 CRI		120V	ELV @ 10%	Integral Power Supply	12.0		TBD / IP44 Location	2.8675°W X 10°T + Stem Length				Exterior Dark-Sky Decorative Pendant