Shift Architects

Date: November 5, 2021 By: Kristine Perpar, Architect

Property address:

TBD Lawson Point; Lot ARC613-C Telluride, CO 81435

Sent to: MV DRB

Re: Development of a Single Family Residence

Dear Mountain Village Design Review Board,

The proposed home for Lot ARC613-C; Big Vanilla was designed to capture the views from the house, sensitivity to the site and neighbors and the existing topography.

Lot ARC613-C is currently vacant of structures with a small aspen grove of in the north east corner.

The driveway is situated to the north of the proposed structure, we are requesting a variance for a 4' high boulder wall and v-pan in the 8' set back to the west of the driveway.

We are also requesting a variance on the required parking spaces. We have two enclosed parking spaces and are asking the DRB to waive the 2 surface parking spaces due to the unique and limited space of this site.

Exterior elevations, plans and roof are simple in form. Roofs consist of a 12:12 gabled with 6:12 and 4:12 sheds. Exterior materials; stone, metal and wood accents were selected for their sensitivity to the environment, neighboring properties and for durability.

The proposed landscape plan is simple with revegetation plan and elevated terraces and planters.

Sincerely,

Kristine Perpar



GENERAL NOTES

CONTRACT DOCUMENTS:
CONTRACT DOCUMENTS CONSIST OF THE AGREEMENT, GENERAL CONDITIONS, SPECIFICATIONS, DETAIL BOOK AND DRAWINGS, WHICH ARE COOPERATIVE AND CONTINUOUS. WORK INDICATED OR REASONABLY IMPLIED IN ANY ONE OF THE DOCUMENTS SHALL BE SUPPLIED AS THOUGH FULLY COVERED IN ALL. ANY DISCREPENCIES BETWEEN THE PARTS CHALL BE REPORTED TO THE ARCHITECT PRIOR TO THE COMMENCEMENT OF WORK. THESE DRAWINGS ARE PART OF THE CONTRACT DOCUMENTS FOR THIS PROJECT. THESE DRAWINGS ARE THE GRAPHIC ILLUSTRATION OF THE WORK TO BE ACCOMPLISHED. ALL DIMENSIONS NOTED TAKE PRECEDENCE OVER SCALED DIMENSIONS. DIMENSIONS NOTED WITH "N.T.S." DENOTES NOT TO SCALE.

THE DRAWINGS FOLLOW A LOGICAL, INTERDISCIPLINARY FORMAT: ARCHITECTURAL DRAWINGS (A SHEETS), CIVIL DRAWINGS (C SHEETS), STRUCTURAL (S SHEETS), MECHANICAL AND PLUMBING (M SHEETS), ELECTRICAL (E SHEETS) AND LIGHTING (LTG SHEETS).

CODE COMPLIANCE:
ALL WORK, MATERIALS, AND ASSEMBLIES SHALL COMPLY WITH APPLICABLE STATE AND LOCAL CODES, ORDINANCES, AND REGULATIONS. THE CONTRACTOR,
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AND ASSEMBLIES SHALL COMPLY WORK TO THE HIGHEST STANDARDS OF CRAFTSMANSHIP AND IN SUBCONTRACTORS, AND JOURNEYMEN OF THE APPROPRIATE TRADES SHALL PERFORM WORK TO THE HIGHEST STANDARDS OF CRAFTSMANSHIP AND IN ACCORDANCE WITH AIA DOCUMENT A201-SECTION 3. THE BUILDING INSPECTOR SHALL BE NOTIFIED BY THE CONTRACTOR WHEN THERE IS NEED OF INSPECTION AS REQUIRED BY THE INTERNATIONAL BUILDING CODE OR ANY LOCAL CODE OR ORDINANCE.

THESE DOCUMENTS ARE INTENDED TO INCLUDE ALL LABOR, MATERIALS, EQUIPMENT AND SERVICES REQUIRED TO COMPLETE THE WORK DESCRIBED HEREIN.


THE CONTRACTOR SHALL CAREFULLY STUDY AND COMPARE THE DOCUMENTS, VERIFY ACTUAL CONDITIONS AND REPORT ANY DISCREPENCIES, ERRORS OR OMMISSIONS TO THE ARCHITECT IN A TIMELY MANNER. THE ARCHITECT SHALL CLARIFY OR PROVIDE REASONABLE ADDITIONAL INFORMATION REQUIRED FOR SUCCESSFUL EXECUTION. THE CONTRACTOR SHALL VERIFY AND COORDINATE ALL OPENINGS THROUGH FLOORS, CEILINGS AND WALLS WITH ALL ARCHITECTURAL, INTERIOR, STRUCTURAL, MECHANICAL AND PLUMBING, ELECTRICAL AND LIGHTING DRAWINGS. CONTRACTOR WILL ASSUME RESPONSIBILITY OF ITEMS REQUIRING COORDINATION AND RESOLUTION DURING THE BIDDING PROCESS.

ANY MATERIALS PROPOSED FOR SUBSTITUTION OF THOSE SPECIFIED OR THE CALLED OUT BY TRADE NAME IN THESE DOCUMENTS SHALL BE PRESENTED TO THE ARCHITECT FOR REVIEW. THE CONTRACTOR SHALL SUBMIT SAMPLES WHEN REQUIRED BY THE ARCHITECT AND SUCH SAMPLES SHALL BE REVIEWED BY THE ARCHITECT BEFORE THE WORK IS PERFORMED. WORK MUST CONFORM TO THE REVIEWED SAMPLES. ANY WORK WHICH DOES NOT CONFORM SHALL BE REMOVED AND REPLACED WITH WORK WHICH CONFORMS AT THE CONTRACTOR'S EXPENSE. SUBCONTRACTORS SHALL SUBMIT REQUESTS AND SAMPLES FOR REVIEW THROUGH THE GENERAL CONTRACTOR WHEN WORK IS LET THROUGH HIM OR HER. REQUIRED VERIFICATION AND SUBMITTALS TO BE MADE IN ADEQUATE TIME AS NOT TO DELAY WORK IN PROGRESS.

SHOP DRAWINGS SHALL BE SUBMITTED TO THE ARCHITECT FOR HIS OR HER REVIEW WHERE CALLED FOR ANYWHERE IN THESE DOCUMENTS. REVIEW SHALL BE MADE BY THE ARCHITECT BEFORE WORK IS BEGUN, AND WORK SHALL CONFORM TO THE REVIEWED SHOP DRAWINGS, SUBJECT TO REPLACEMENT AS REQUIRED IN PARAGRAPH "SUBSTITUTIONS" ABOVE.

SAFETY & PROTECTION OF WORK:

THE CONTRACTOR SHALL BE RESPONSIBLE FOR THE SAFETY AND CARE OF ADJACENT PROPERTIES DURING CONSTRUCTION FOR COMPLIANCE WITH FEDERAL AND STATE O.S.H.A. REGULATIONS, AND FOR THE PROTECTION OF ALL WORK UNTIL IT IS DELIVERED COMPLETED TO THE OWNER.

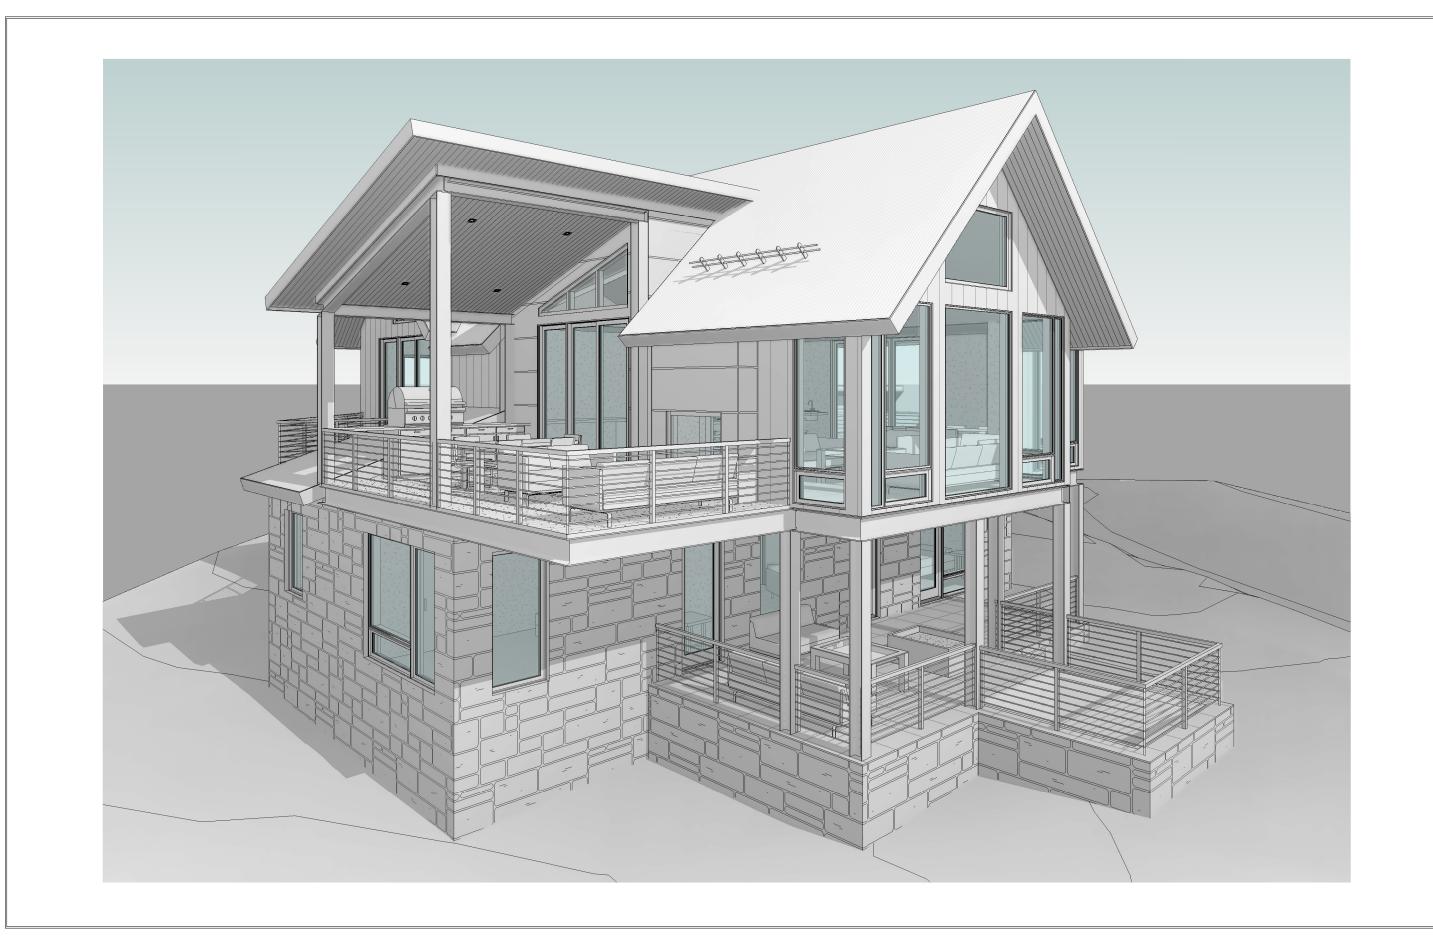

P.O. Box 3206 100 W. Colorado Suite 211 Telluride, Colorado 81435 p 970-728-8145 kristine@shift-architects.com www.shift-architects.com

DATE: 11.04.21 **PRELIMINARY**

PROJECT INFORMATION

TOWN OF MOUNTAIN VILLAGE; SINGLE FAMILY ZONING

IRC 2018 BUILDING CODE

DESCRIPTION 2 STORY SINGLE FAMILY DWELLING

SCOPE NEW 2 STORY WOOD FRAMED SINGLE FAMILY DWELLING W/ ATTACHED 2 CAR GARAGE,

GROUND LEVEL COV'D DECKS & HOT TUB, 2ND STY DECKS COV'D AND UNCOVERED.

SITE DATA

ROOF COVERAGE:

11,933.91 S.F. / .27 ACRES 2 SPACES PROVIDED PARKING ENCLOSED GROUND LEVEL: BUILDING HEIGHT ALLOWABLE 35'

BUILDING HEIGHT PROPOSED

COV'D DECKS: 2ND FLOOR: 2ND FLOOR COV'D DECKS: 183 2ND FLOOR DECKS:

4,001

ALLOWABLE COVERAGE: 4,733.5 (40.0%) PROPOSED COVERAGE: 4,001 (33.5%)

SHEET INDEX

COVER SHEET

<u>CIVIL</u>

SURVEY C1 GENERAL NOTES

C2 SITE GRADING & DRAINAGE PLAN

C3 UTILITY PLAN

C4 CONSTRUCTION MITIGATION PLAN

ARCHITECTURAL

E1.2

SITE PLAN A1.2 LANDSCAPE

PROPOSED FLOOR PLANS

A2.2 PROPOSED FLOOR PLANS

ROOF PLAN

A3.1 PROPOSED ELEVATIONS

A3.2 PROPOSED ELEVATIONS

A3.3 PROPOSED ELEVATIONS

A3.4 ELEVATION HEIGHT CALCS

ELEVATION HEIGHT CALCS A6.1 PERSPECTIVES

A6.2 PERSPECTIVES

A8.1 WINDOW SCHEDULE

A8.2 DOOR SCHEDULE E1.1 1ST FL EXTERIOR LIGHTING PLANS

2ND FL EXTERIOR LIGHTING PLANS

COVER SHEET

<u>ෆ</u>

SHEET NUMBER

VICINITY MAP



PROJECT TEAM

OWNER:

BIG VANILLA LLC PO BOX 837 OPHIR, CO 81426

ARCHITECT:


SHIFT ARCHITECTS 100 W COLORADO STE. 211 TELLURIDE, CO 81435 P. 970.275.0263 kristine@shift-architects.com

GENERAL CONTRACTOR:

STRUCTURAL:

TBD

G1.1

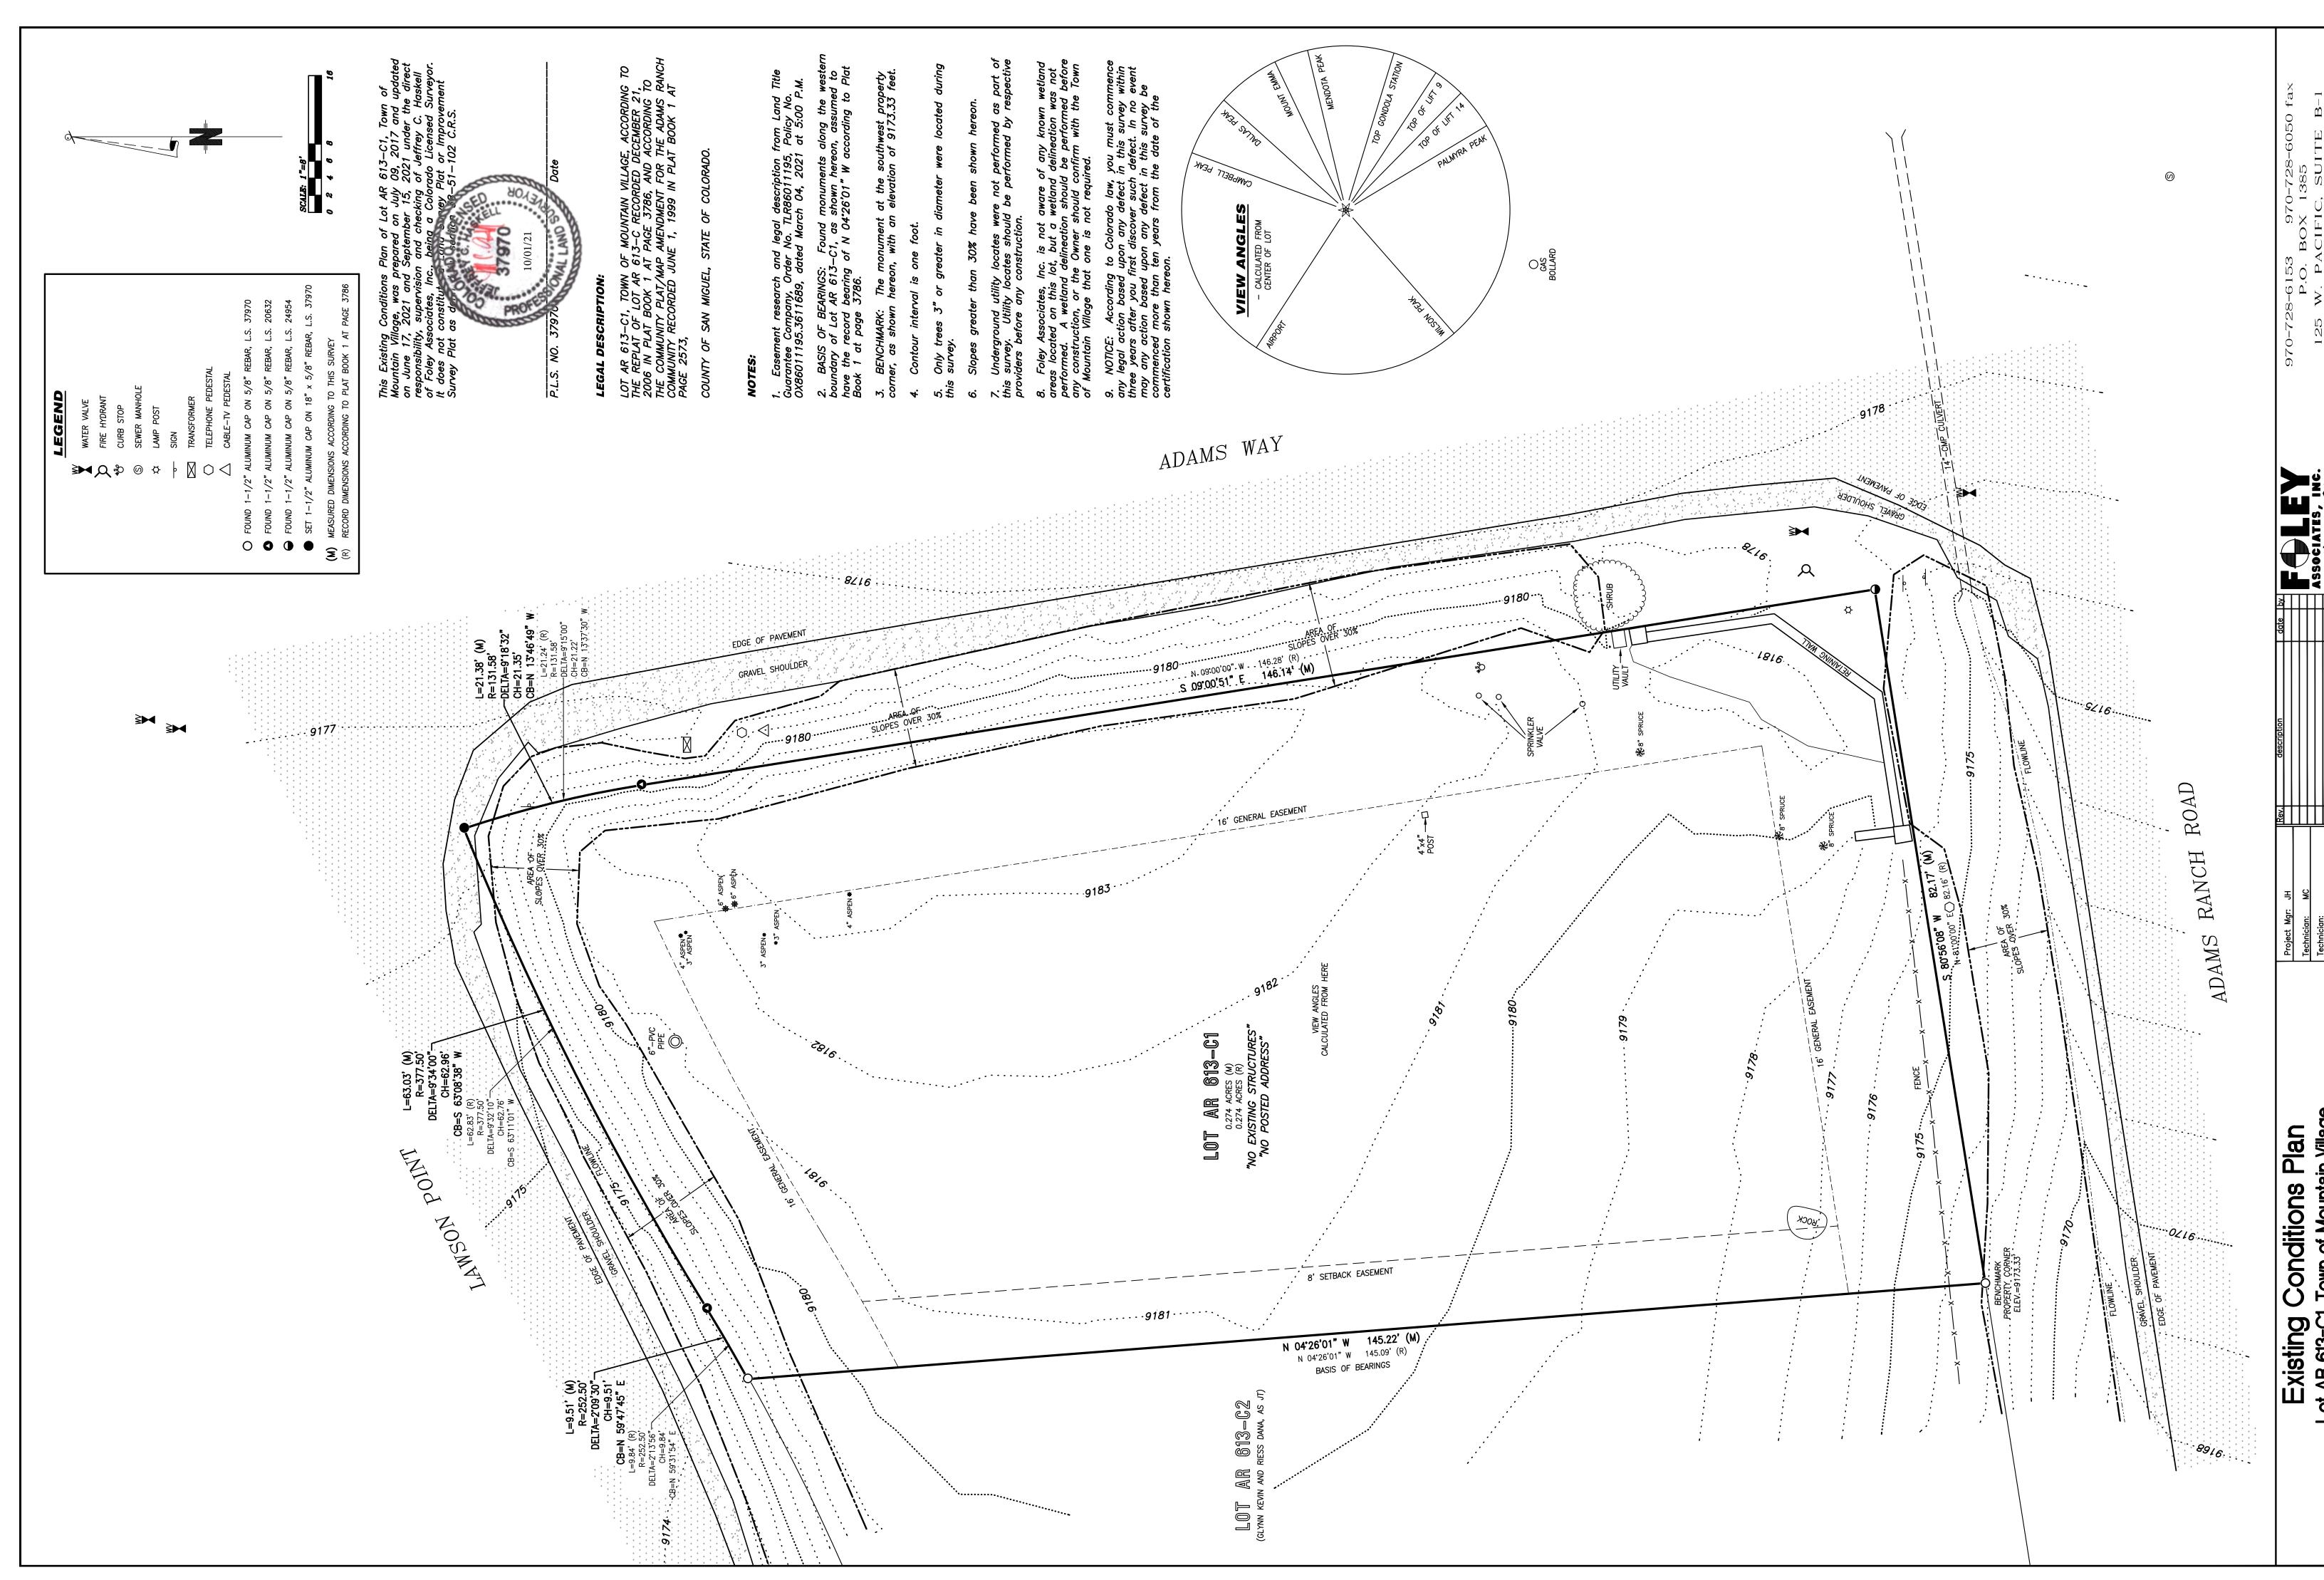

GENERAL CIVIL ENGINEERING NOTES:

1. THE EXISTING UTILITY LINES SHOWN ON THE PLANS ARE APPROXIMATE. AT LEAST TWO (2) FULL WORKING DAYS PRIOR TO TO COMMENCING CONSTRUCTION, THE CONTRACTOR SHALL CONTACT THE UTILITY NOTIFICATION CENTER OF COLORADO @ 1-800-922-1987 OR 811 TO GET ALL UTILITIES LOCATED. IF ANY OF THESE UNDERGROUND UTILITIES ARE IN CONFLICT WITH THE CONSTRUCTION PLANS, THE CONTRACTOR SHALL NOTIFY THE ENGINEER AND WORK WITH THE ENGINEER TO FIND A SOLUTION BEFORE THE START OF CONSTRUCTION.

INSTALLATION AND SEPARATION REQUIREMENTS SHALL BE COORDINATED WITH THE INDIVIDUAL UTILITY PROVIDERS.

THE UTILITY PROVIDERS ARE:
SEWER, WATER, CABLE TV AND FIBEROPTIC: TOWN OF MOUNTAIN VILLAGE
NATURAL GAS: BLACK HILLS ENERGY
POWER: SAN MIGUEL POWER

POWER: SAN MIGUEL POWER TELEPHONE: CENTURY LINK

2. PRIOR TO BEGINNING ANY CONSTRUCTION ACTIVITIES, ALL NECESSARY PERMITS SHALL BE OBTAINED BY THE OWNER OR CONTRACTOR.

3. IT IS THE CONTRACTOR'S RESPONSIBILITY TO INSURE THAT EXCAVATED SLOPES ARE SAFE AND COMPLY WITH OSHA REQUIRIEMENTS. REFER TO THE SITE—SPECIFIC REPORT FOR THIS PROJECT FOR ADDITIONAL INFORMATION..

4. ALL TRENCHES SHALL BE ADEQUATELY SUPPORTED OR LAID BACK PER OSHA REGULATIONS.

5. ALL MATERIALS AND CONSTRUCTION SHALL BE IN CONFORMANCE WITH THE TOWN OF MOUNTAIN VILLAGE DESIGN STANDARDS LATEST EDITION. ALL CONSTRUCTION WITHIN EXISTING STREET OR ALLEY RIGHT—OF—WAY SHALL BE SUBJECT TO TOWN OF MOUNTAIN VILLAGE INSPECTION.

6. THE CONTRACTOR SHALL HAVE ONE COPY OF THE STAMPED PLANS ON THE JOB SITE AT ALL TIMES.

7. THE CONTRACTOR SHALL NOTIFY THE TOWN 48 HOURS PRIOR TO THE START OF CONSTRUCTION.

8. THE CONTRACTOR IS RESPONSIBLE FOR IMPLEMENTING AND MAINTAINING EROSION AND SEDIMENT CONTROL MEASURES AT ALL TIMES DURING CONSTRUCTION. THE ADJOINING ROADWAYS SHALL BE FREE OF DEBRIS AT THE END OF CONSTRUCTION ACTIVITIES EACH DAY.

9. THE CONTRACTOR SHALL PROVIDE, ERECT AND MAINTAIN PROPER TRAFFIC CONTROL DEVICES UNTIL THE SITE IS OPEN TO TRAFFIC. ANY TRAFFIC CLOSURES MUST BE COORDINATED WITH THE TOWN OF MOUNTAIN VILLAGE.

10. ALL DAMAGE TO PUBLIC STREETS AND ROADS, INCLUDING HAUL ROUTES, TRAILS, OR STREET IMPROVEMENTS, OR TO PRIVATE PROPERTY, SHALL BE REPAIRED AT THE SOLE EXPENSE OF THE CONTRACTOR TO THE ORIGINAL CONDITIONS.

11. WHEN AN EXISTING ASPHALT STREET IS CUT, THE STREET MUST BE RESTORED TO A CONDITION EQUAL TO OR BETTER THAN ITS ORIGINAL CONDITION. THE FINISHED PATCH SHALL BLEND SMOOTHLY INTO THE EXISTING SURFACE. ALL LARGE PATCHES SHALL BE PAVED WITH AN ASPHALT LAY—DOWN MACHINE.

12. IF DEWATERING IS REQUIRED, THE CONTRACTOR SHALL NOTIFY THE ENGINEER. ANY DISCHARGE REQUIREMENTS SHALL BE COORDINATED WITH THE TOWN OF MOUNTAIN VILLAGE.

13. CONTRACTOR SHALL NOTIFY ALL RESIDENTS IN WRITING 24 HOURS PRIOR TO ANY SHUT-OFF IN SERVICE. THE NOTICES MUST HAVE CONTRACTOR'S PHONE NUMBER AND NAME OF CONTACT PERSON, AND EMERGENCY PHONE NUMBER FOR AFTER HOURS CALLS. ALL SHUT-OFF'S MUST BE APPROVED BY THE TOWN AND TOWN VALVES AND APPURTENANCES SHALL BE OPERATED BY TOWN PERSONNEL.

14. CONTRACTOR SHALL KEEP SITE CLEAN AND LITTER FREE (INCLUDING CIGARETTE BUTTS) BY PROVIDING A CONSTRUCTION DEBRIS TRASH CONTAINER AND A BEAR-PROOF POLY-CART TRASH CONTAINER, WHICH IS TO BE LOCKED AT ALL TIMES.

15. CONTRACTOR MUST BE AWARE OF ALL TREES TO REMAIN PER THE DESIGN AND APPROVAL PROCESS AND PROTECT THEM ACCORDINGLY.

16. THE CONTRACTOR SHALL PROVIDE UNDERGROUND UTILITY AS-BUILTS TO THE TOWN.

17. ALL STRUCTURAL FILL UNDER HARDSCAPE OR ROADS MUST BE COMPACTED TO 95% MODIFIED PROCTOR (MIN.) AT PLUS OR MINUS 2% OF THE OPTIMUM MOISTURE CONTENT. NON—STRUCTURAL FILL SHALL BE PLACED AT 90% (MIN.) MODIFIED PROCTOR.

18. UNSUITABLE MATERIAL SHALL BE REMOVED AS REQUIRED BY THE SOILS ENGINEER. ALL MATERIALS SUCH AS LUMBER, LOGS, BRUSH, TOPSOIL OR ORGANIC MATERIALS OR RUBBISH SHALL BE REMOVED FROM ALL AREAS TO RECEIVE COMPACTED FILL.

19. NO MATERIAL SHALL BE COMPACTED WHEN FROZEN.

20. NATIVE TOPSOIL SHALL BE STOCKPILED TO THE EXTENT FEASIBLE ON THE SITE FOR USE ON AREAS TO BE REVEGETATED.


21. THE CONTRACTOR SHALL BE RESPONSIBLE FOR DUST ABATEMENT AND EROSION CONTROL MEASURES DEEMED NECESSARY BY THE TOWN, IF CONDITIONS WARRANT THEM.

22. ALL DISTURBED GROUND SHALL BE RE-SEEDED WITH A TOWN-APPROVED SEED MIX. REFER TO THE LANDSCAPE PLAN.

23. THE CONTRACTOR IS REQUIRED TO PROTECT ALL EXISTING SURVEY MONUMENTS AND PROPERTY CORNERS DURING GRADING AND CONSTRUCTION.

24. ALL UNDERGROUND PIPE SHALL BE PROTECTED WITH BEDDING TO PROTECT THE PIPE FROM BEING DAMAGED.

25. HOT TUBS SHALL DRAIN TO THE SANITARY SEWER (OR PUMPED TO AA CLEAN-OUT).

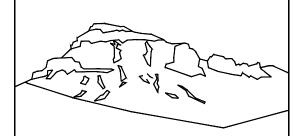

Uncompahgre Engineering, LLC

P.O. Box 3945 Telluride, CO 81435 970-729-0683

2021-10-24

SUBMISSIONS:

DRB SUBMITTAL


Lot AR613 Lawson Point Mtn. Village, CO





CONTRACTOR TO REVIEW AND COMPARE ALL CHAPTERS AND INTERDISCIPLINARY DRAWINGS AND REPORT ANY DISCREPANCIES TO THE ARCHITECT PRIOR TO ANY FIELD WORK BEING DONE IN ACCORDANCE WITH AIA DOCUMENT A201

Notes

C1

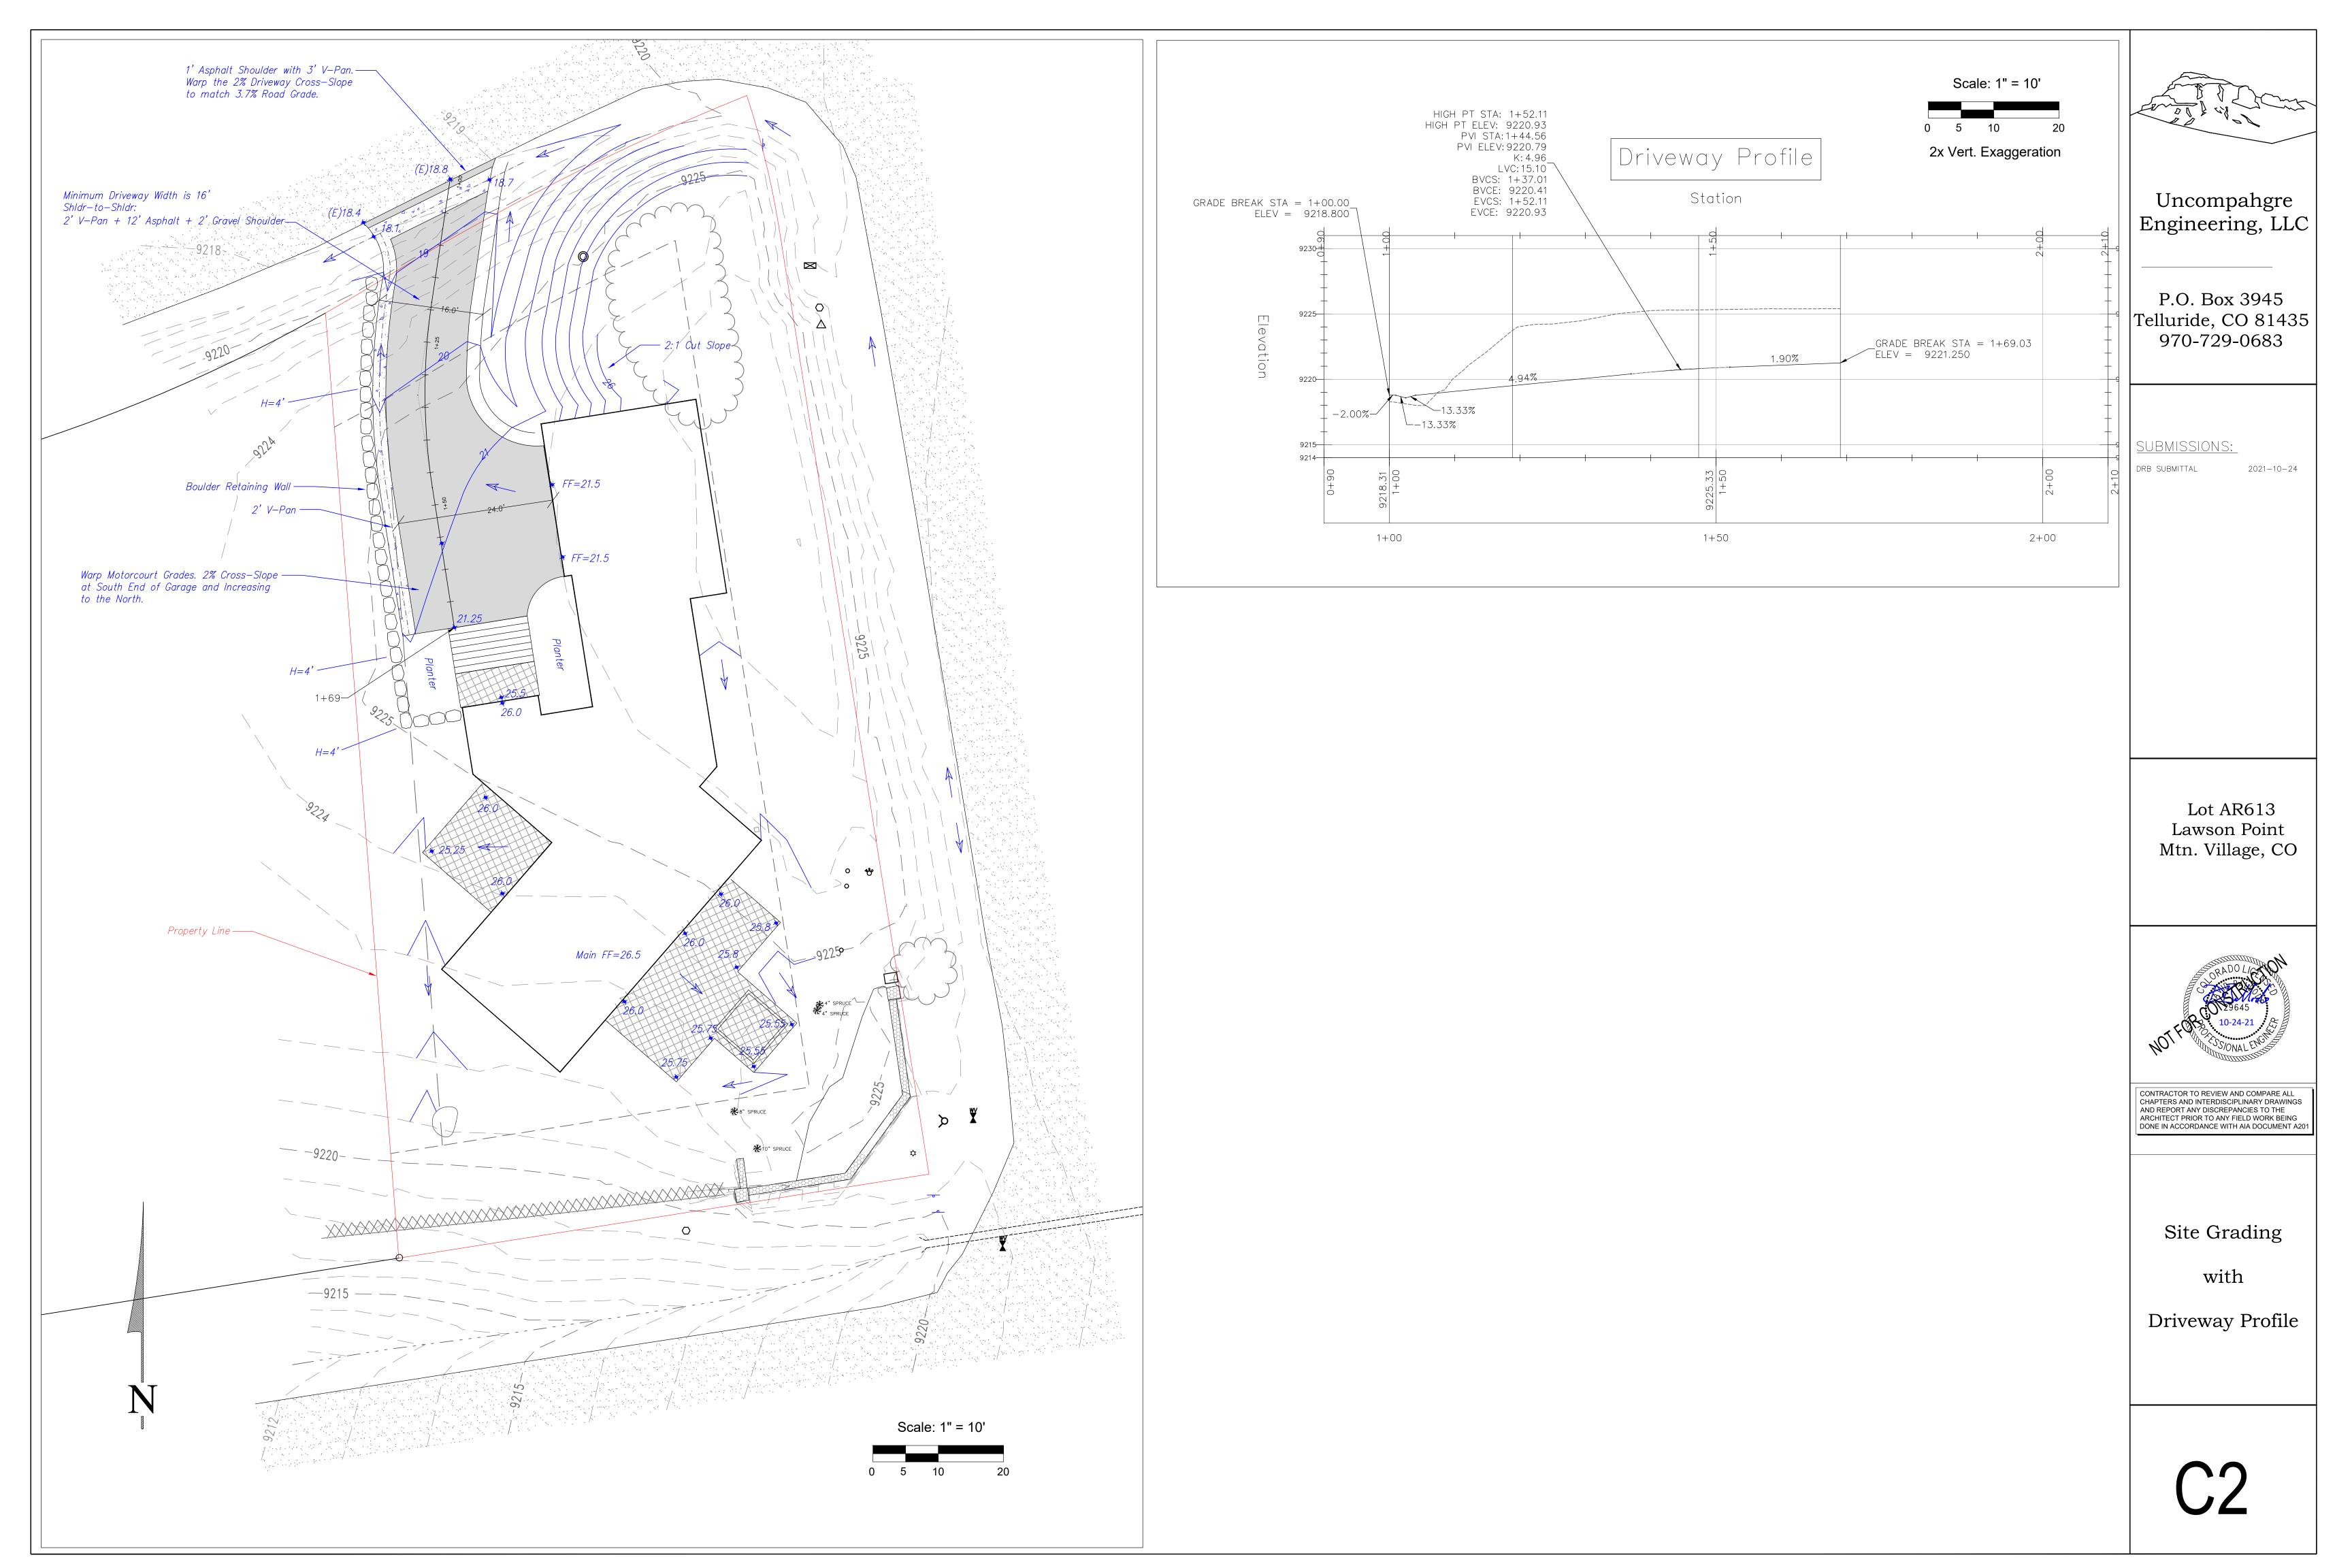

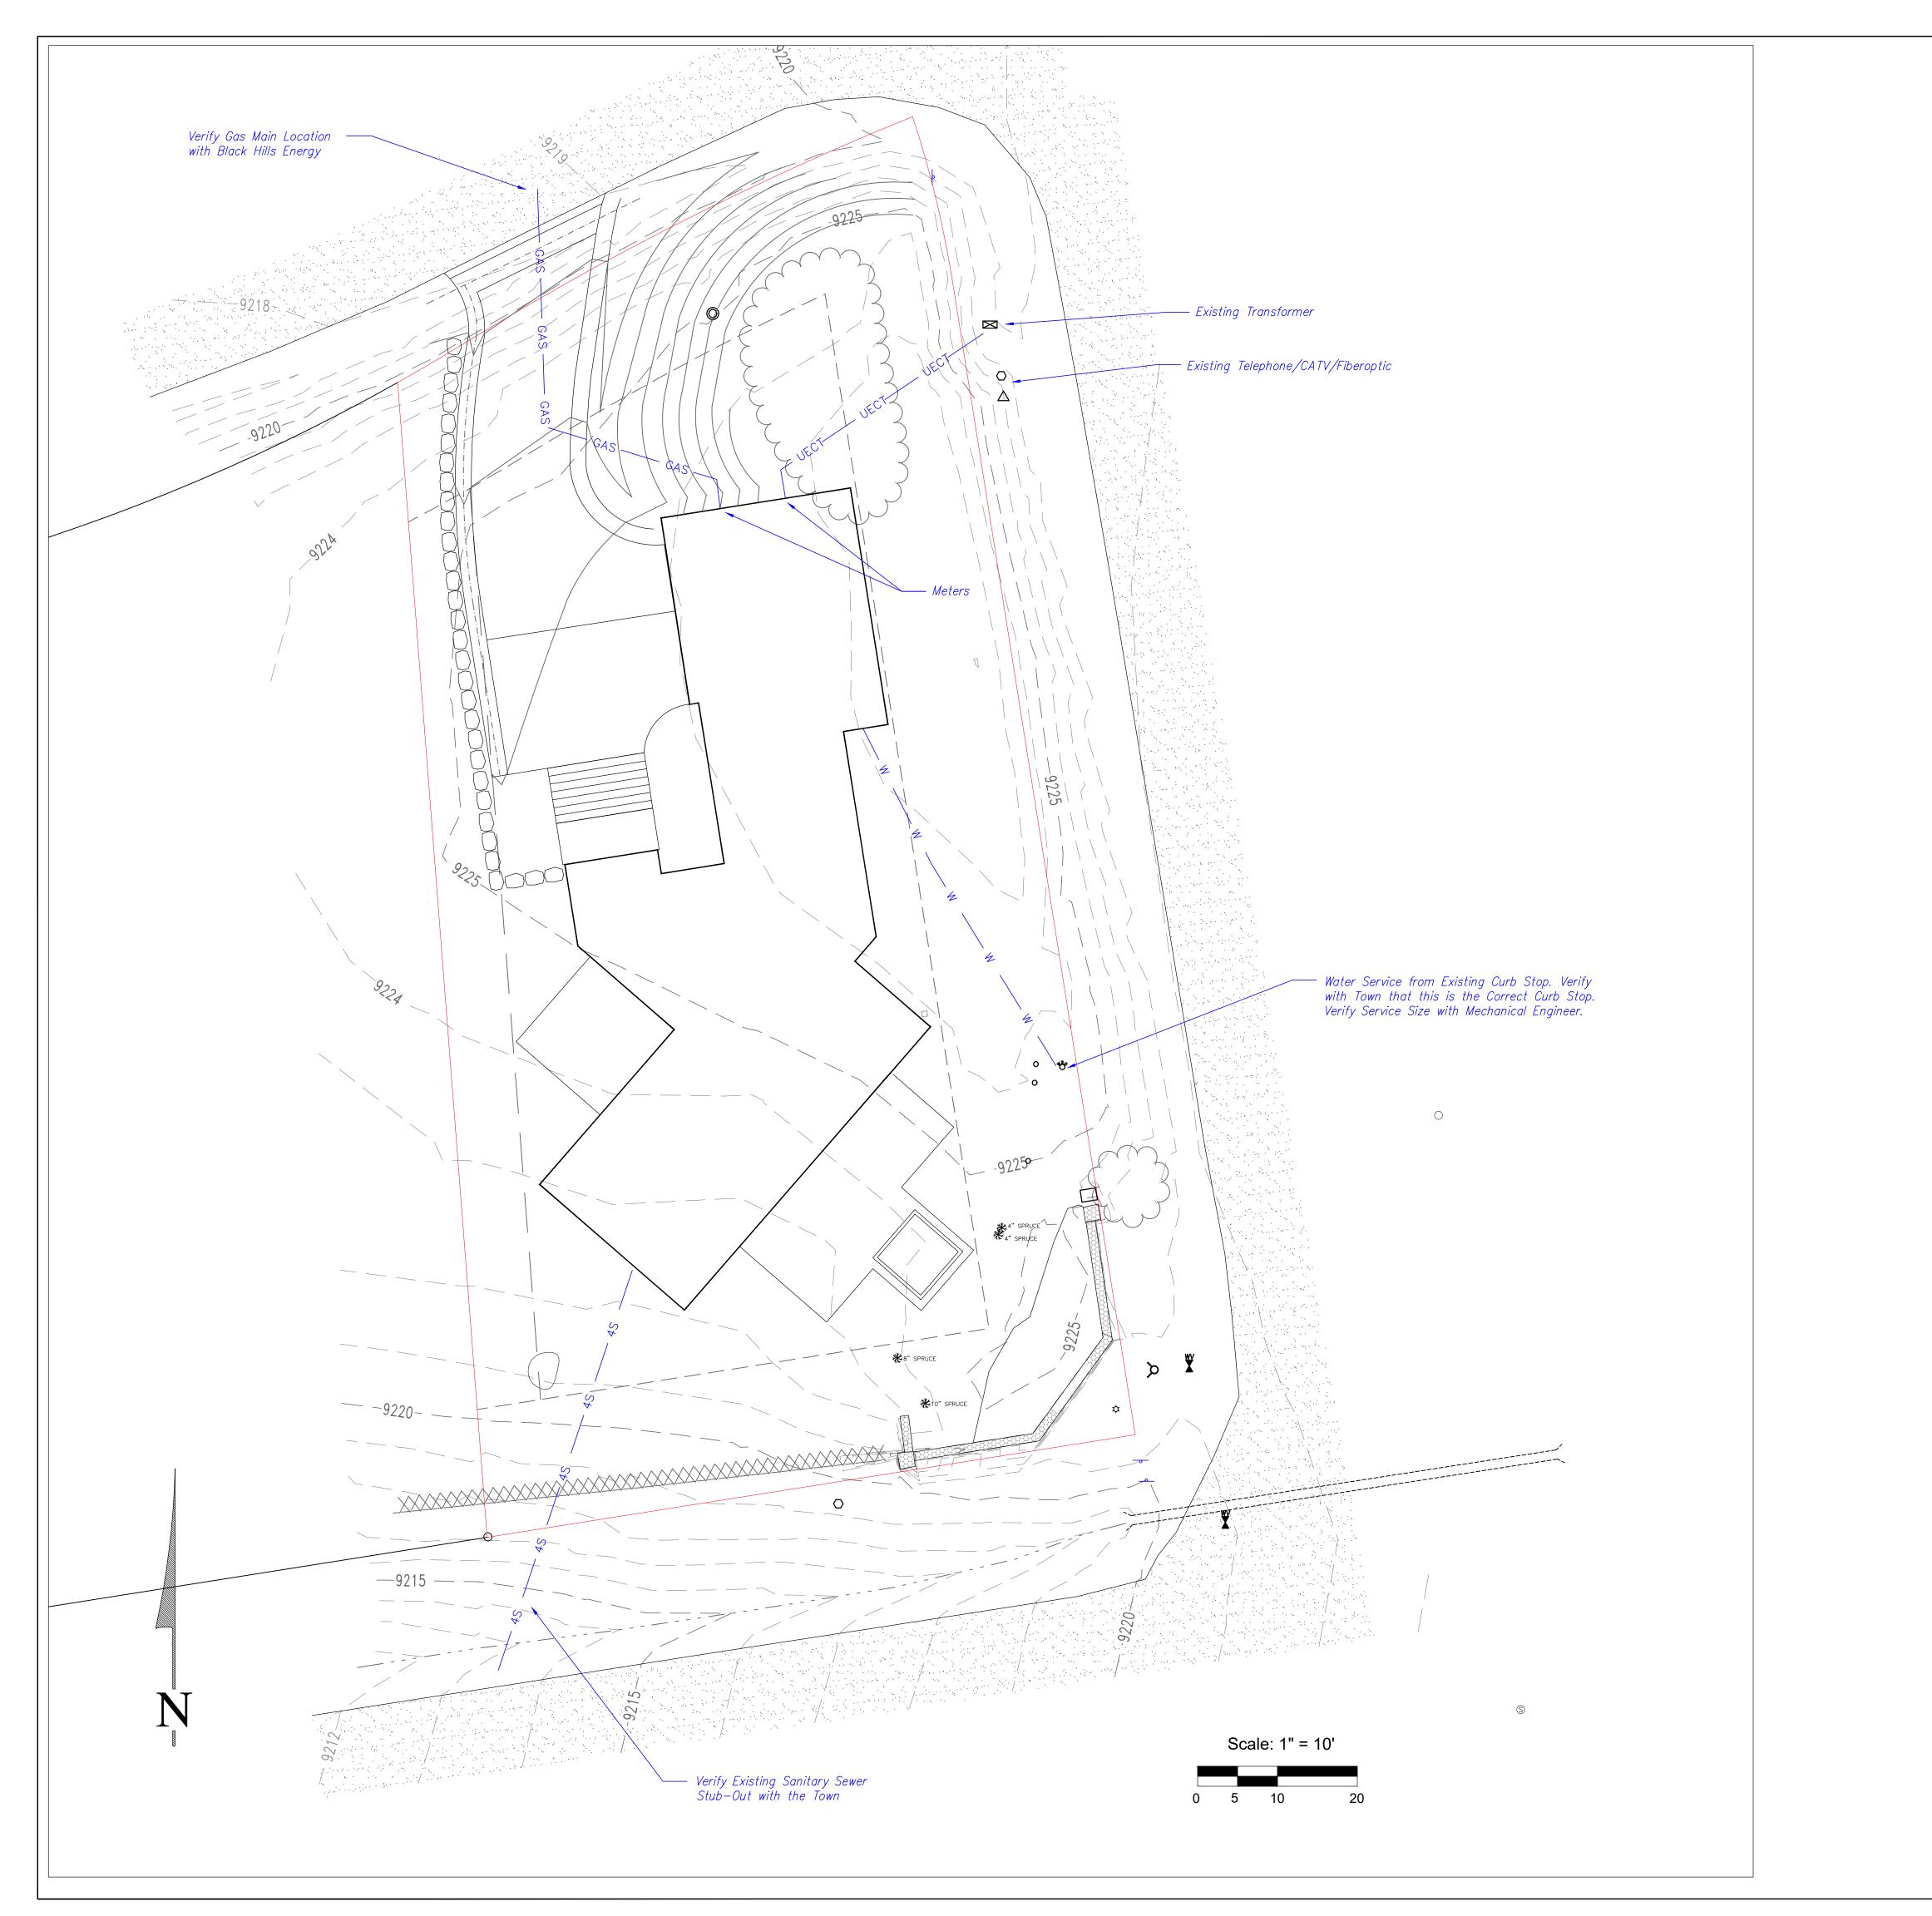

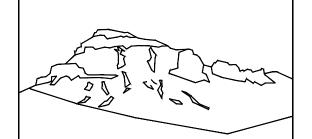

Uncompahgre Engineering, LLC

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2021-10-24

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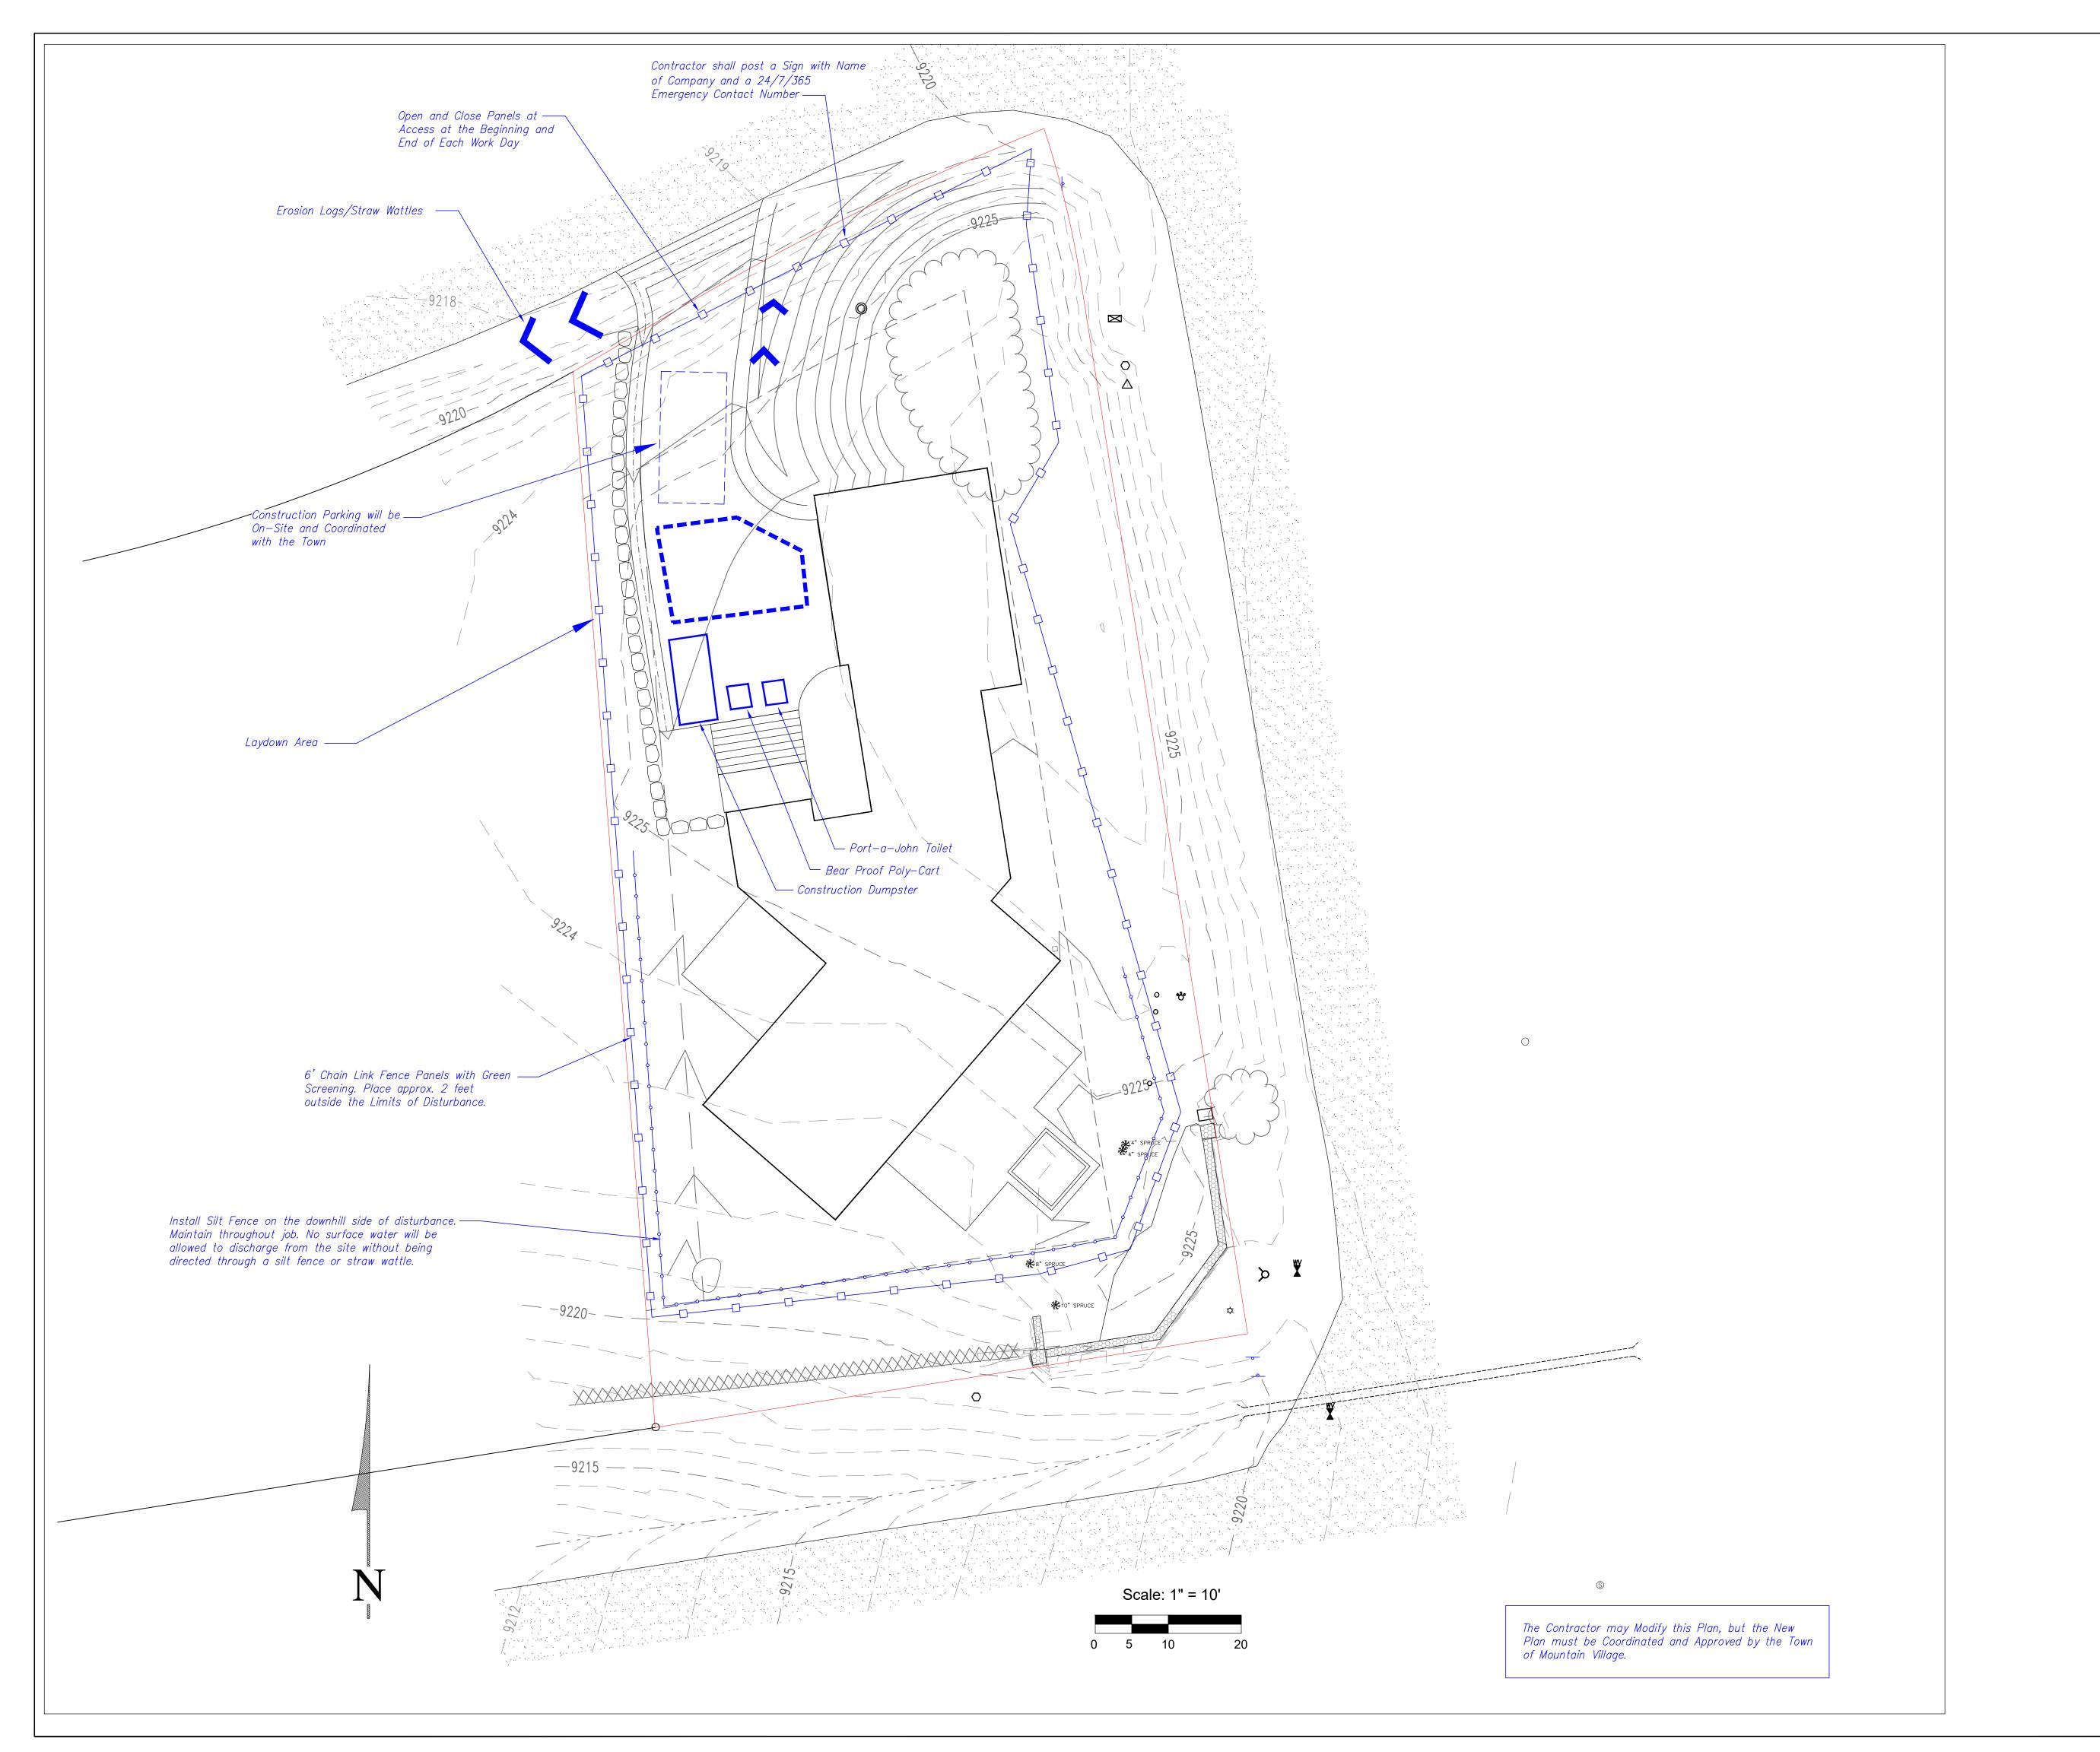
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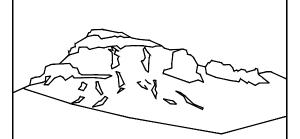


CONTRACTOR TO REVIEW AND COMPARE ALL CHAPTERS AND INTERDISCIPLINARY DRAWINGS AND REPORT ANY DISCREPANCIES TO THE ARCHITECT PRIOR TO ANY FIELD WORK BEING DONE IN ACCORDANCE WITH AIA DOCUMENT A201

Utilities

C3





Uncompahgre Engineering, LLC

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<u>SUBMISSIONS:</u>

DRB SUBMITTAL 2021-10-24
Revised Fence and Note 2021-11-04


Lot AR613 Lawson Point Mtn. Village, CO



CONTRACTOR TO REVIEW AND COMPARE ALL CHAPTERS AND INTERDISCIPLINARY DRAWINGS AND REPORT ANY DISCREPANCIES TO THE ARCHITECT PRIOR TO ANY FIELD WORK BEING DONE IN ACCORDANCE WITH AIA DOCUMENT A201

> Construction Mitigation

> > C4

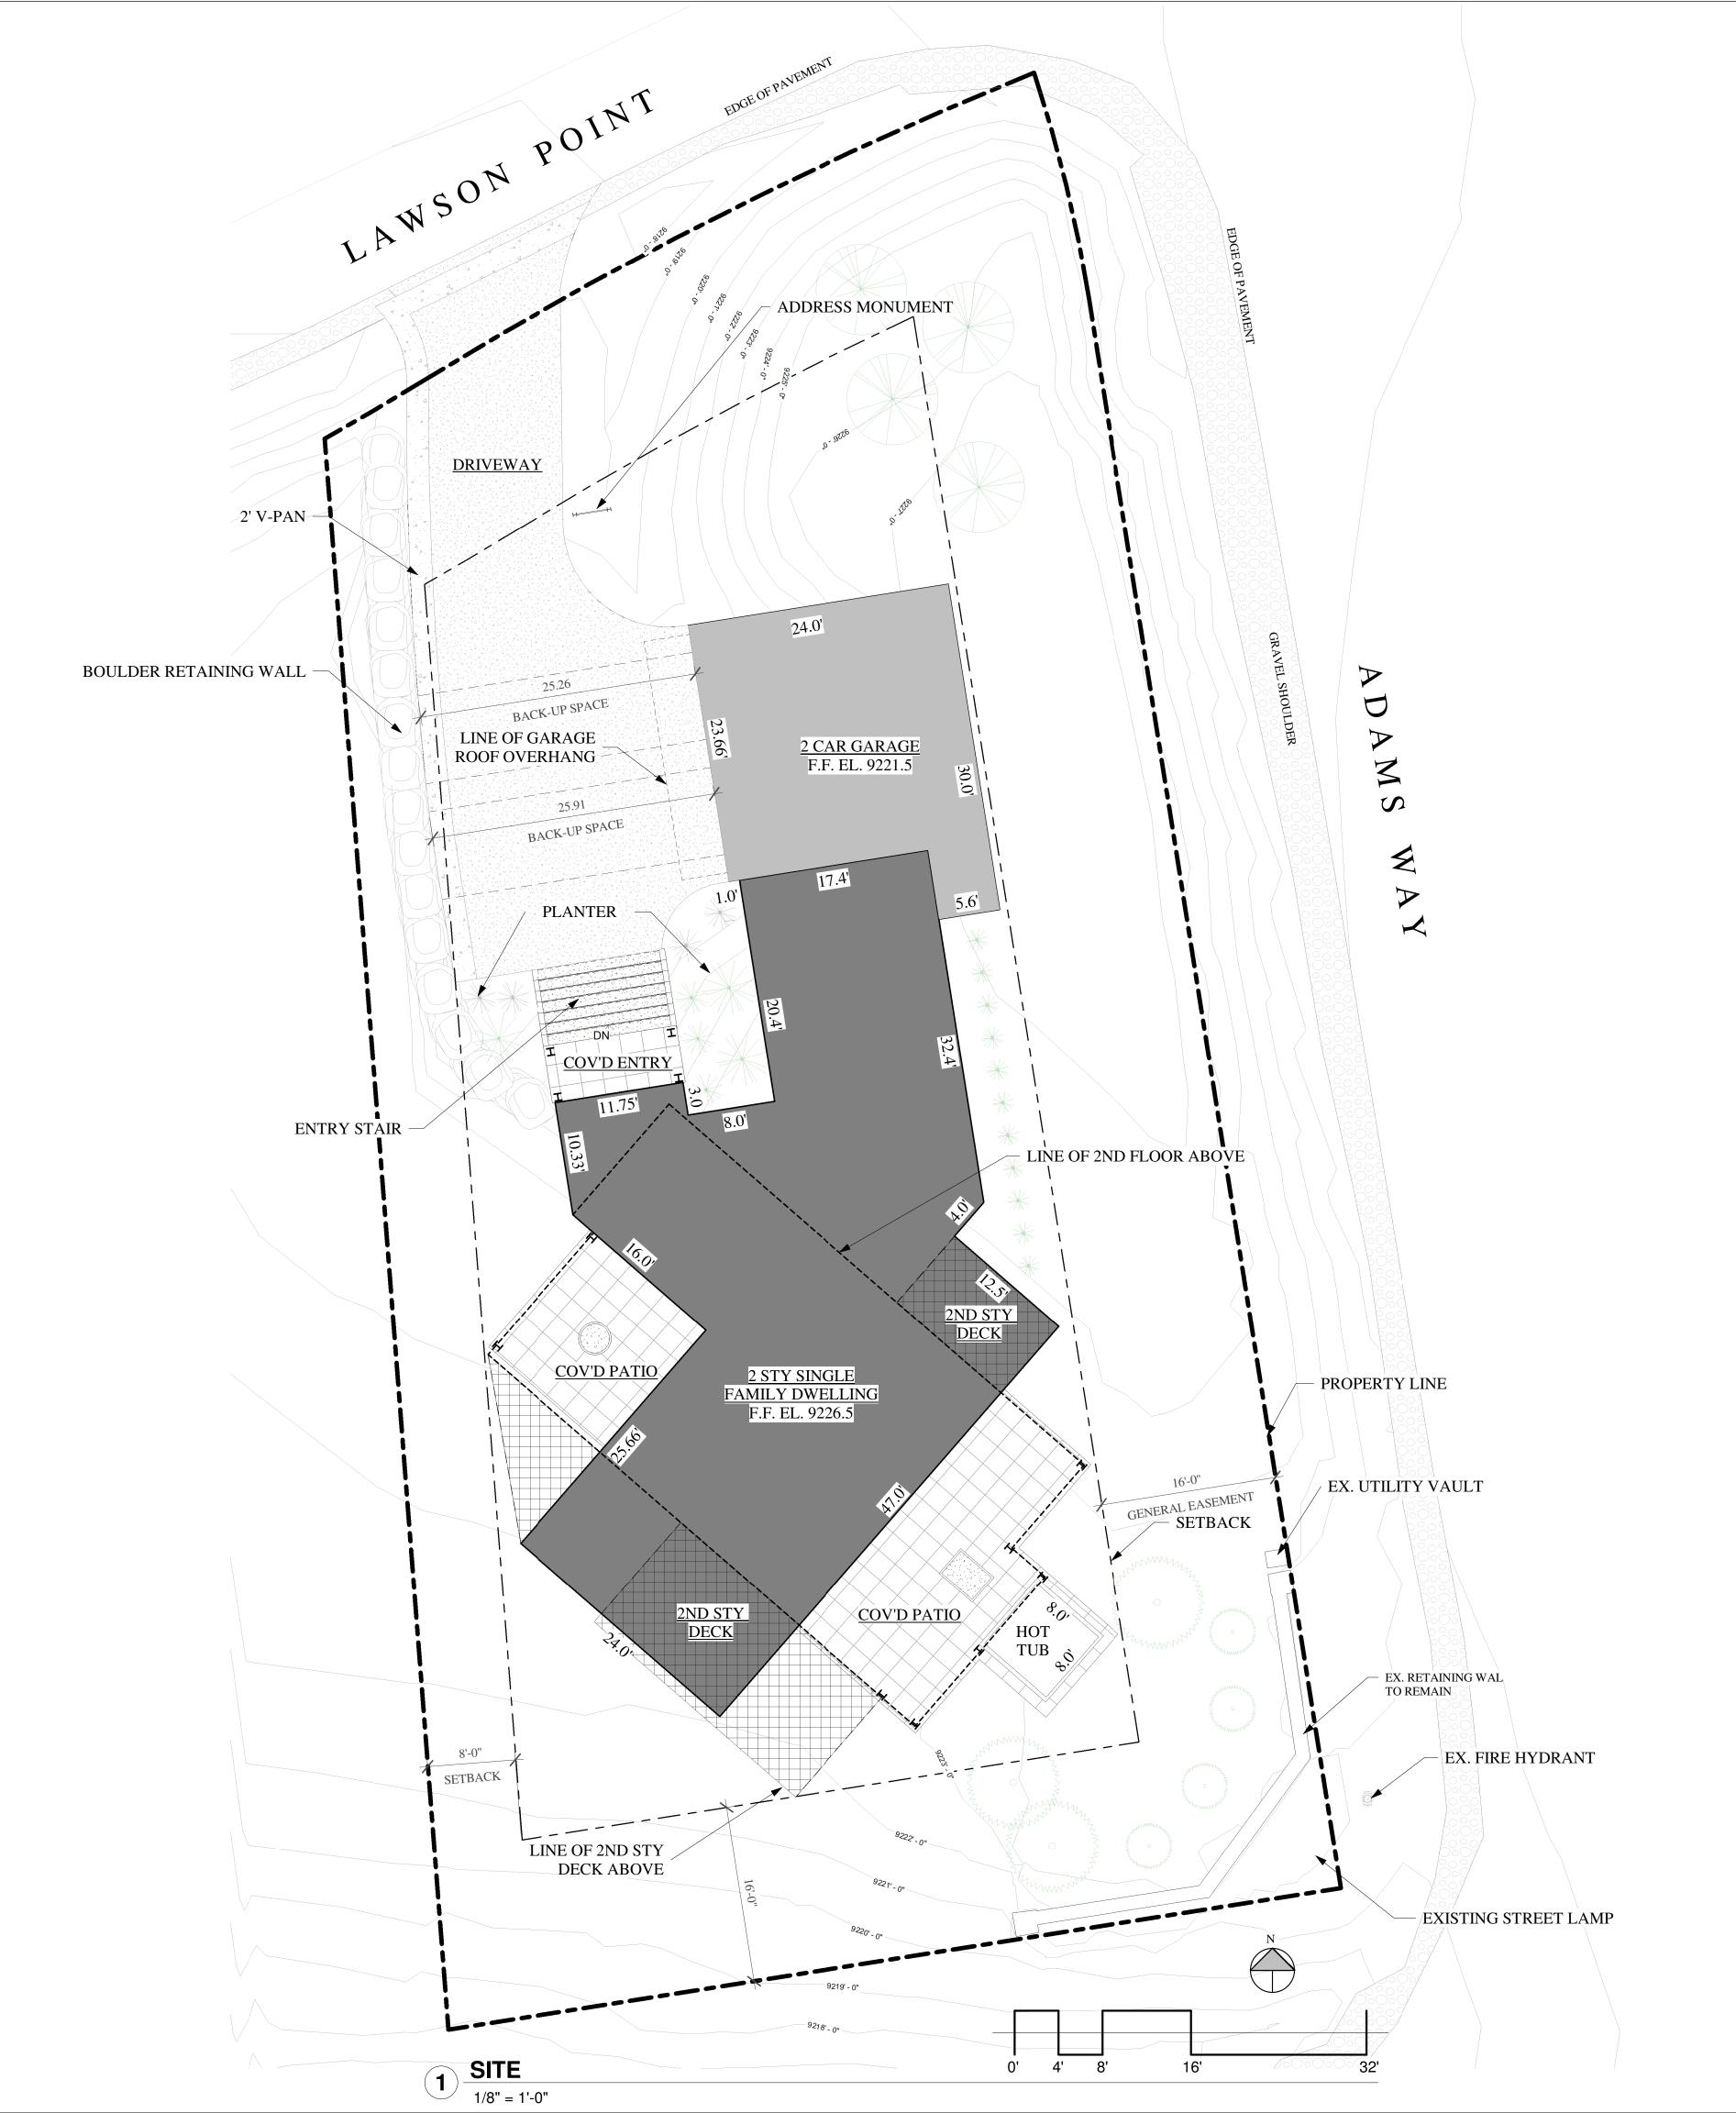

AREA	SQ.FT.	%
SITE	11,933.91	100.00
GROUND LEVEL	2,671.00	22.38
COV'D DECKS (1ST	614.00	5.14
2ND FLOOR	1,466.00	12.28
COV'D DECKS (2ND	183.00	1.53
2ND FLOOR DECKS	237.00	1.98
TOTAL ROOF COV'G	4,001.00	33.52
ALLOWABLE COV'G	4,733.56	40.00
PROPOSED COV'G	4,001.00	33.52

DATE:

11.04.21 PRELIMINARY DRB

Revision Schedule

Revision

Number Date Description

SITE PLAN

SHEET NUMBER

A1.1

1 LANDSCAPE PLAN

1/8" = 1'-0"

GENERAL NOTES:

- 1. ALL TREES AND SHRUBS TO BE LOCATED BY PROJECT ARCHITECT / OWNER.
- . ALL TREES AND SHRUBS SHALL BE BACKED FILLED WITH A TOPSOIL / ORGANIC FERTILIZER MIXTURE AT A 2:1 RATIO.
- 3. NECESSARY TREES SHALL BE STACKED WITH 4' METAL POSTS. TREES SHALL BE GUYED WITH 12 GAUGE GALVANIZED WIRE AND POLYPROPYLENE TREE
- 1. PERENNIAL PLANTING BEDS SHALL BE TILLED 6" DEPTH AND AMENDED WITH TOPSOIL AND ORGANIC FERTILIZER AT A 2:1 RATIO.
- 5. SEE PLANTING DETAILS FOR ALL DECIDUOUS AND EVERGREEN TREES.
- MULCH ALL PERENNIAL BEDS WITH A PINE BARK SOIL CONDITIONER BY SOUTHWEST IMPORTERS; SHREDDED CEDAR BARK.
- ALL PLANT MATERIAL TO MEET THE AMERICAN STANDARD FOR NURSERY STOCK.
- LANDSCAPING SHALL BE IN ACCORDANCE WITH L.U.C. "SECTION 3-505 MAINTENANCE, REMOVAL, OR RELOCATION OF TREES".

NOXIOUS WEEDS:

ALL PLANTED MATERIALS INCLUDING SEEDS, SHALL BE NON NOXIOUS SPECIES AS SPECIFIED WITHIN THE SAN MIGUEL COUNTY'S MOST CURRENT NOXIOUS WEED LIST.

LANDSCAPE MAINTENANCE NOTES:

- 1. TURF SHALL BE AERATED 2 TO 3 TIMES PER YEAR TO INCREASE THE WATER ABSORPTION RATE. NECESSARY ORGANIC FERTILIZATION AND AMENDMENT SHALL BE INCORPORATED AT THE SAME TIME.
- 2. NECESSARY ORGANIC FERTILIZERS AND AMENDMENT SHALL BE ADDED TO PERENNIAL BEDS SEASONALLY ALONG WITH MULCH.
- 3. ALL SHRUBS IN SNOW SHED AREAS TO BE CUT BACK IN FALL TO 12"-18" IN
- 4. IRRIGATION SYSTEM TO BE BLOWN OUT BY OCTOBER 31ST EACH FALL AND TURNED ON BY JUNE 1ST EACH SPRING.

REVEGETATION NOTES:

- SUBSOIL SURFACE SHALL BE TILLED TO A 4" DEPTH ON NON FILL AREAS.
 TOPSOIL SHALL BE SPREAD AT A MINIMUM DEPTH OF 4" OVER ALL AREAS TO BE REEMITTED (EXCEPT OF SLOPES GREATER THAN 3:1) AND AMENDMENT ROTOTILLED AT A RATE OF THREE CUBIC YARDS PER THOUSAND SQUARE FEET
- 3. BROADCASTING OF SEED SHALL BE DONE IMMEDIATELY AFTER TOPSOIL IS APPLIED (WITHIN 10 DAYS) TO MINIMIZE EROSION AND WEEDS.
- APPLIED (WITHIN 10 DAYS) TO MINIMIZE EROSION AND WEEDS.


 4. AREAS WHICH HAVE BEEN COMPACTED OR RELATIVELY UNDISTURBED

 NEEDING SEEDING, SHALL BE SCARIFIED BEFORE BROADCASTING THE SEED.
- 5. BROADCASTING WITH SPECIFIED SEED MIX AND FOLLOW WITH DRY MULCHING, STRAW OR HAY SHALL BE UNIFORMLY APPLIED OVER SEEDED AREA AT A RATE OF 1.5 TONS PER ACRE FOR HAY OR 2 TONS PER ACRE FOR STRAW, CRIMP IN.
- 6. ON SLOPES GREATER THAN 3:1 EROSION CONTROL BLANKET SHALL BE APPLIED IN PLACE OF STRAW MULCH AND PINNED.
- 7. ALL UTILITY CUTS SHALL BE REVEGETATED WITHIN TWO WEEKS AFTER INSTALLATION OF UTILITIES TO PREVENT WEED INFESTATION.
- SEED ALL AREAS LABELED NATIVE GRASS SEED WITH THE FOLLOWING MIXTURE AT A RATE OF 12 LBS. PER ACRE.

GRASS SPECIES	PURE LIVE SEED PER ACRE
WESTERN YARROW	5%
TALL FESCUE	10%
ARIZONA FESCUE	5%
HARD FESCUE	5%
CREEPING RED FESCUE	10%
ALPINE BLUEGRASS	15%
CANADA BLUEGRASS	10%
PERENNIAL RYEGRASS	15%
SLENDER WHEATGRASS	10%
MOUNTAIN BROME	15%
MOUNTAIN BROME (BROMAR)	15%

WILDFLOWER SPECIES PURE LIVE SEED PE INDIAN PAINTBRUSH ROCKY MOUNTAIN COLUMBINE YARROW SKY PILOT		OWED ODECIES	WILDELON
ROCKY MOUNTAIN COLUMBINE YARROW	<u>'EN AUNE</u>	JWEN SPECIES	VVILDELO
YARROW	25%	PAINTBRUSH	INDIAN PA
	25%	MOUNTAIN COLUMBINE	ROCKY M
SKY PILOT	25%	V	YARROW
	25%	TC	SKY PILO

PLANTING SCHEDULE			
LATIN NAME	Type Mark	SIZE	Count
		1	
PICEA PUNGENS	P1	10' (MIN.)	4
SAMBUCAS RACEMOSA	P2	3'	3
CORNUS STOLONIFERA COLORADENSE	P3	5 GAL.	7
RUBAS DELICIOUS	P4	5 GAL.	11
	PICEA PUNGENS SAMBUCAS RACEMOSA CORNUS STOLONIFERA COLORADENSE	LATIN NAME Type Mark PICEA PUNGENS P1 SAMBUCAS RACEMOSA P2 CORNUS STOLONIFERA COLORADENSE P3	LATIN NAME Type Mark SIZE PICEA PUNGENS P1 10' (MIN.) SAMBUCAS RACEMOSA P2 3' CORNUS STOLONIFERA COLORADENSE P3 5 GAL.

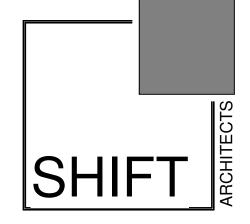

P.O. Box 3206 100 W. Colorado Suite 211 Telluride, Colorado 81435 p 970-728-8145 kristine@shift-architects.com www.shift-architects.com

DATE:

11.04.21 PRELIMINARY DRB

Revision Schedule

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Revision
Number Date Description


SIG VANILLA

LANDSCAPE

Shift O

SHEET NUMBER

A1.2

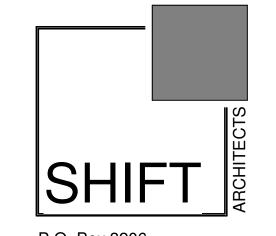

DATE:

11.04.21 PRELIMINARY DRB


BIG VANILLA

PROPOSED FLOOR PLANS

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SHEET NUMBER

A2.1

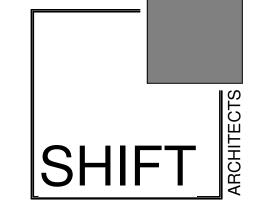


DATE:

11.04.21 PRELIMINARY DRB

IG VANILLA

PROPOSED FLOOR PLANS

> ©shift architects

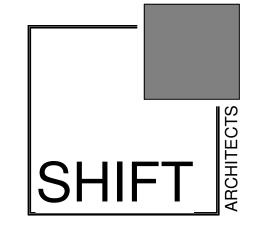


DATE: 11.04.21 PRELIMINARY DRB

ROOF PLAN

SHEET NUMBER

A2.3

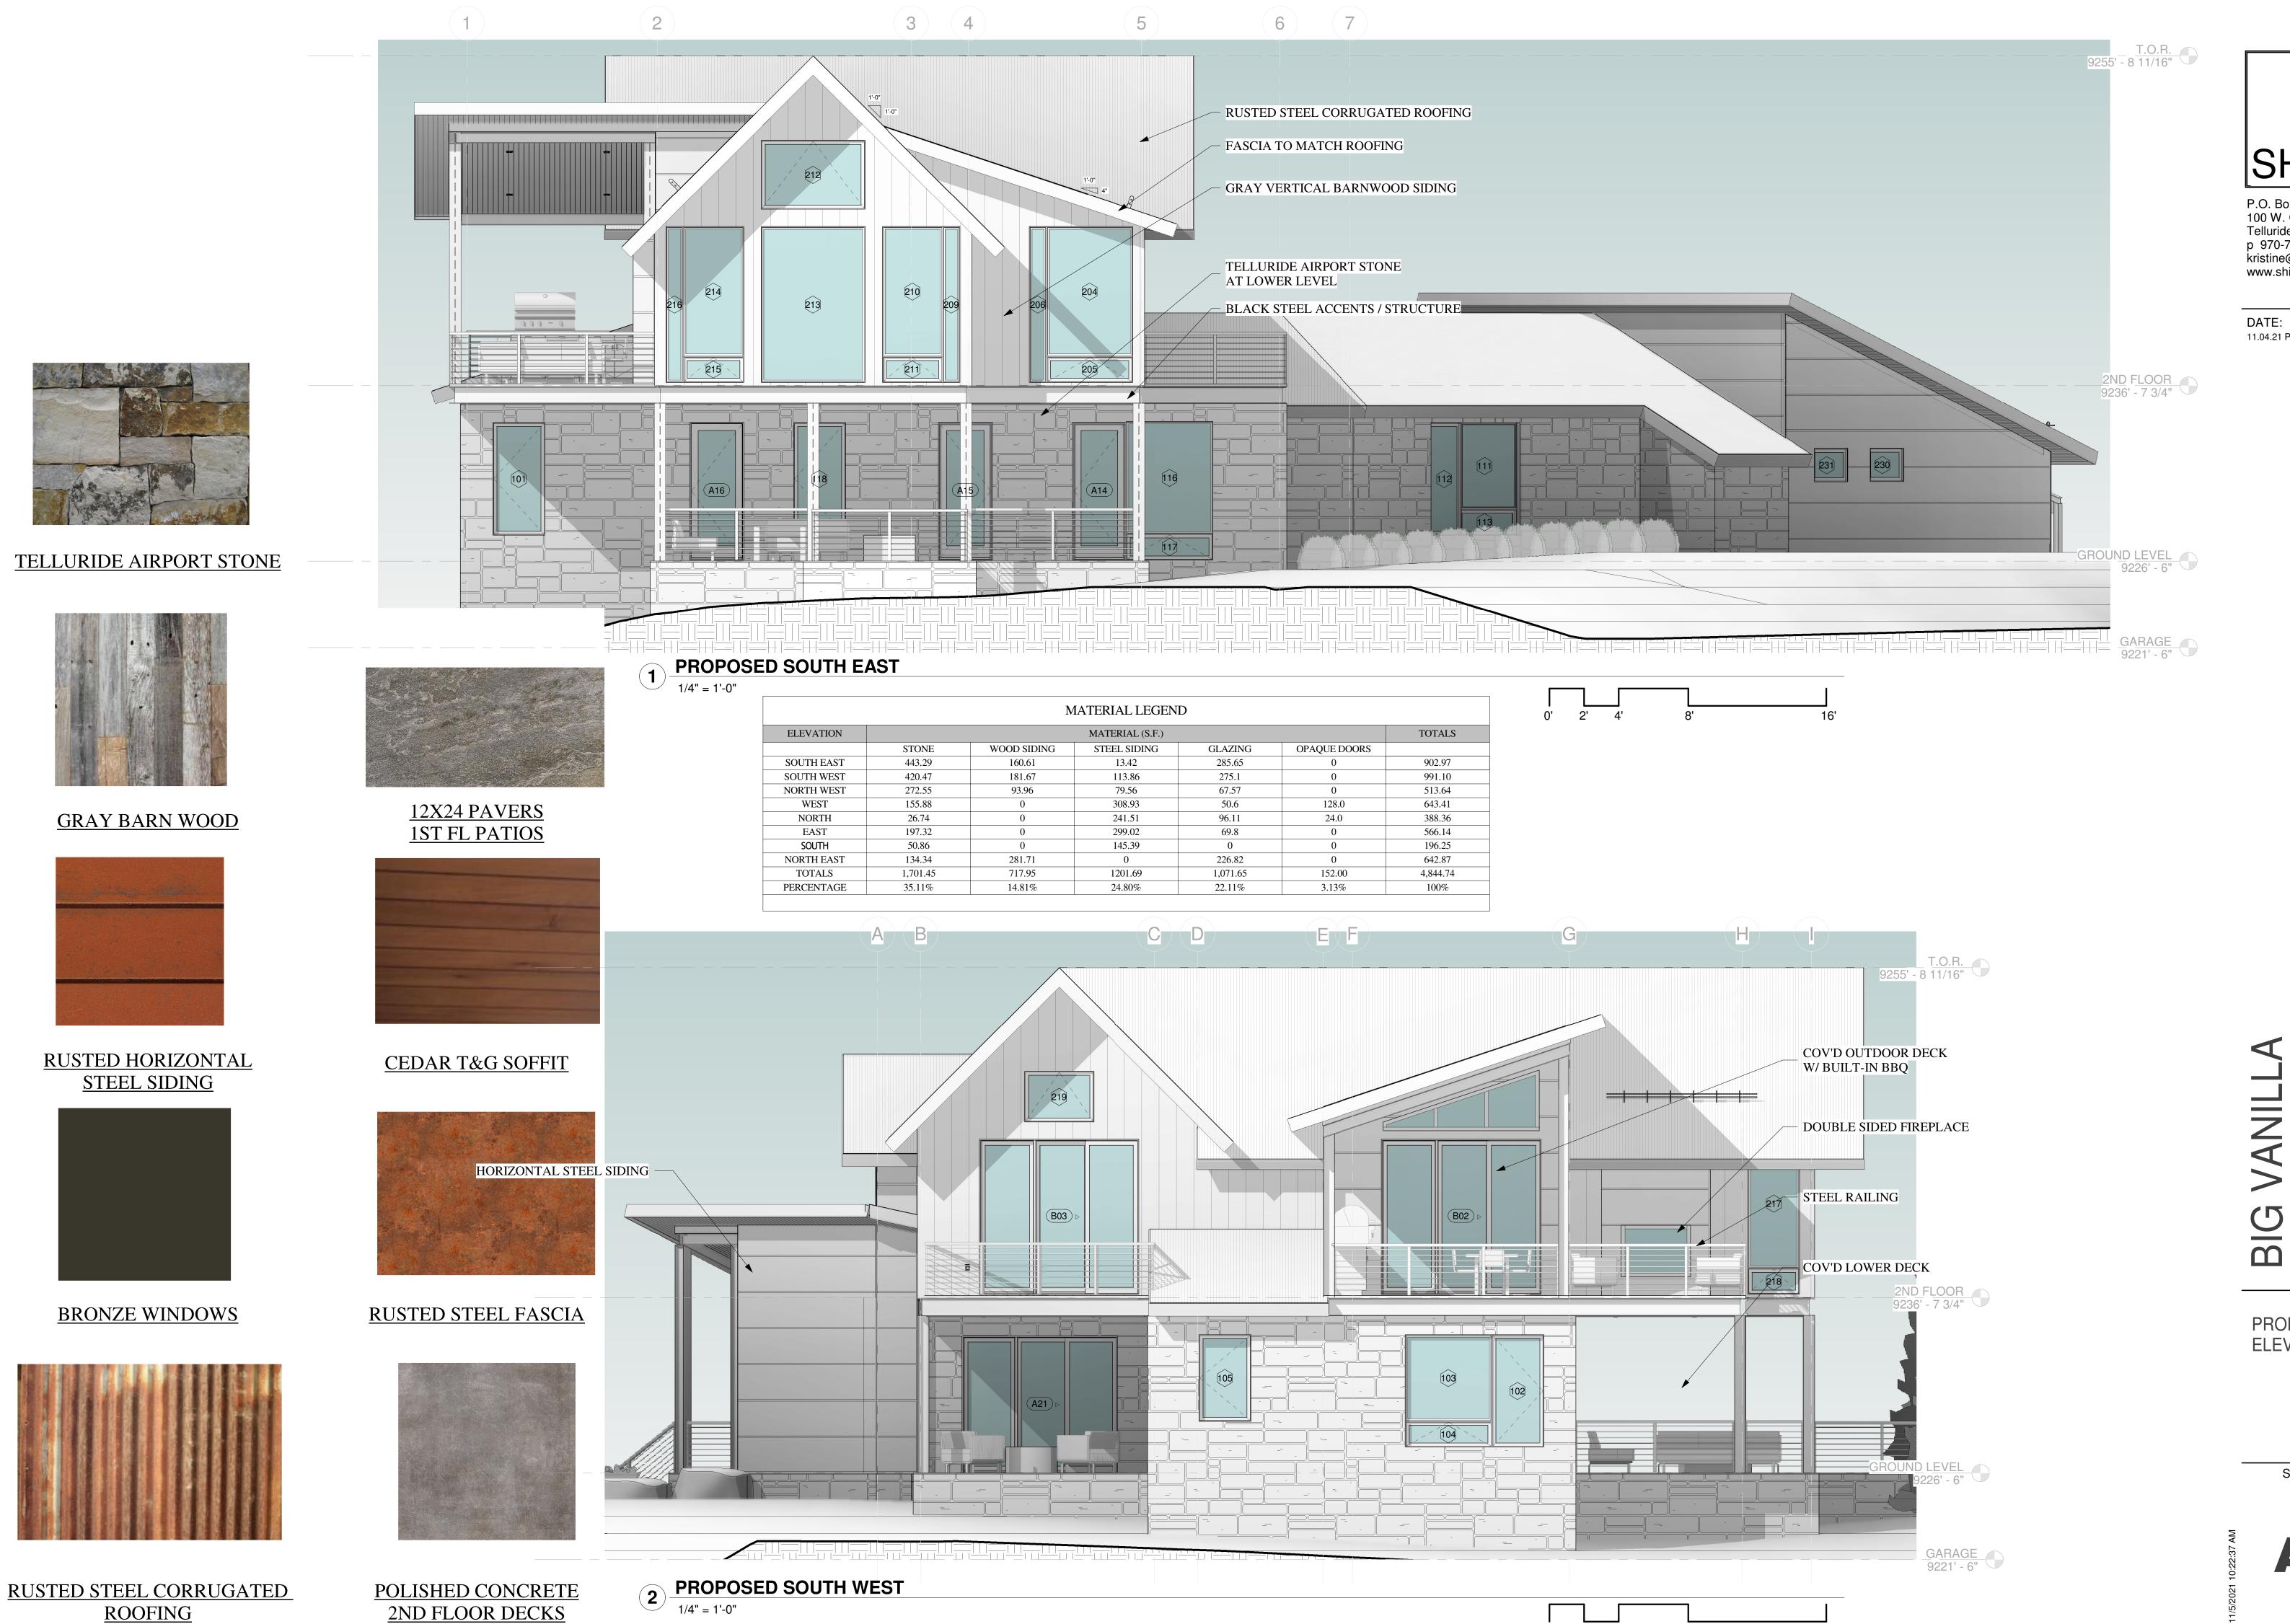

11.04.21 PRELIMINARY DRB

PROPOSED ELEVATIONS

SHEET NUMBER

A3.1



11.04.21 PRELIMINARY DRB

PROPOSED ELEVATIONS

SHEET NUMBER

A3.2



T.O.R. 9255' - 8 11/16" 203 230 112 GROUND LEVEL | 9226' - 6" **PROPOSED EAST**1/4" = 1'-0"


A3.3

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11.04.21 PRELIMINARY DRB

DATE:

PROPOSED ELEVATIONS

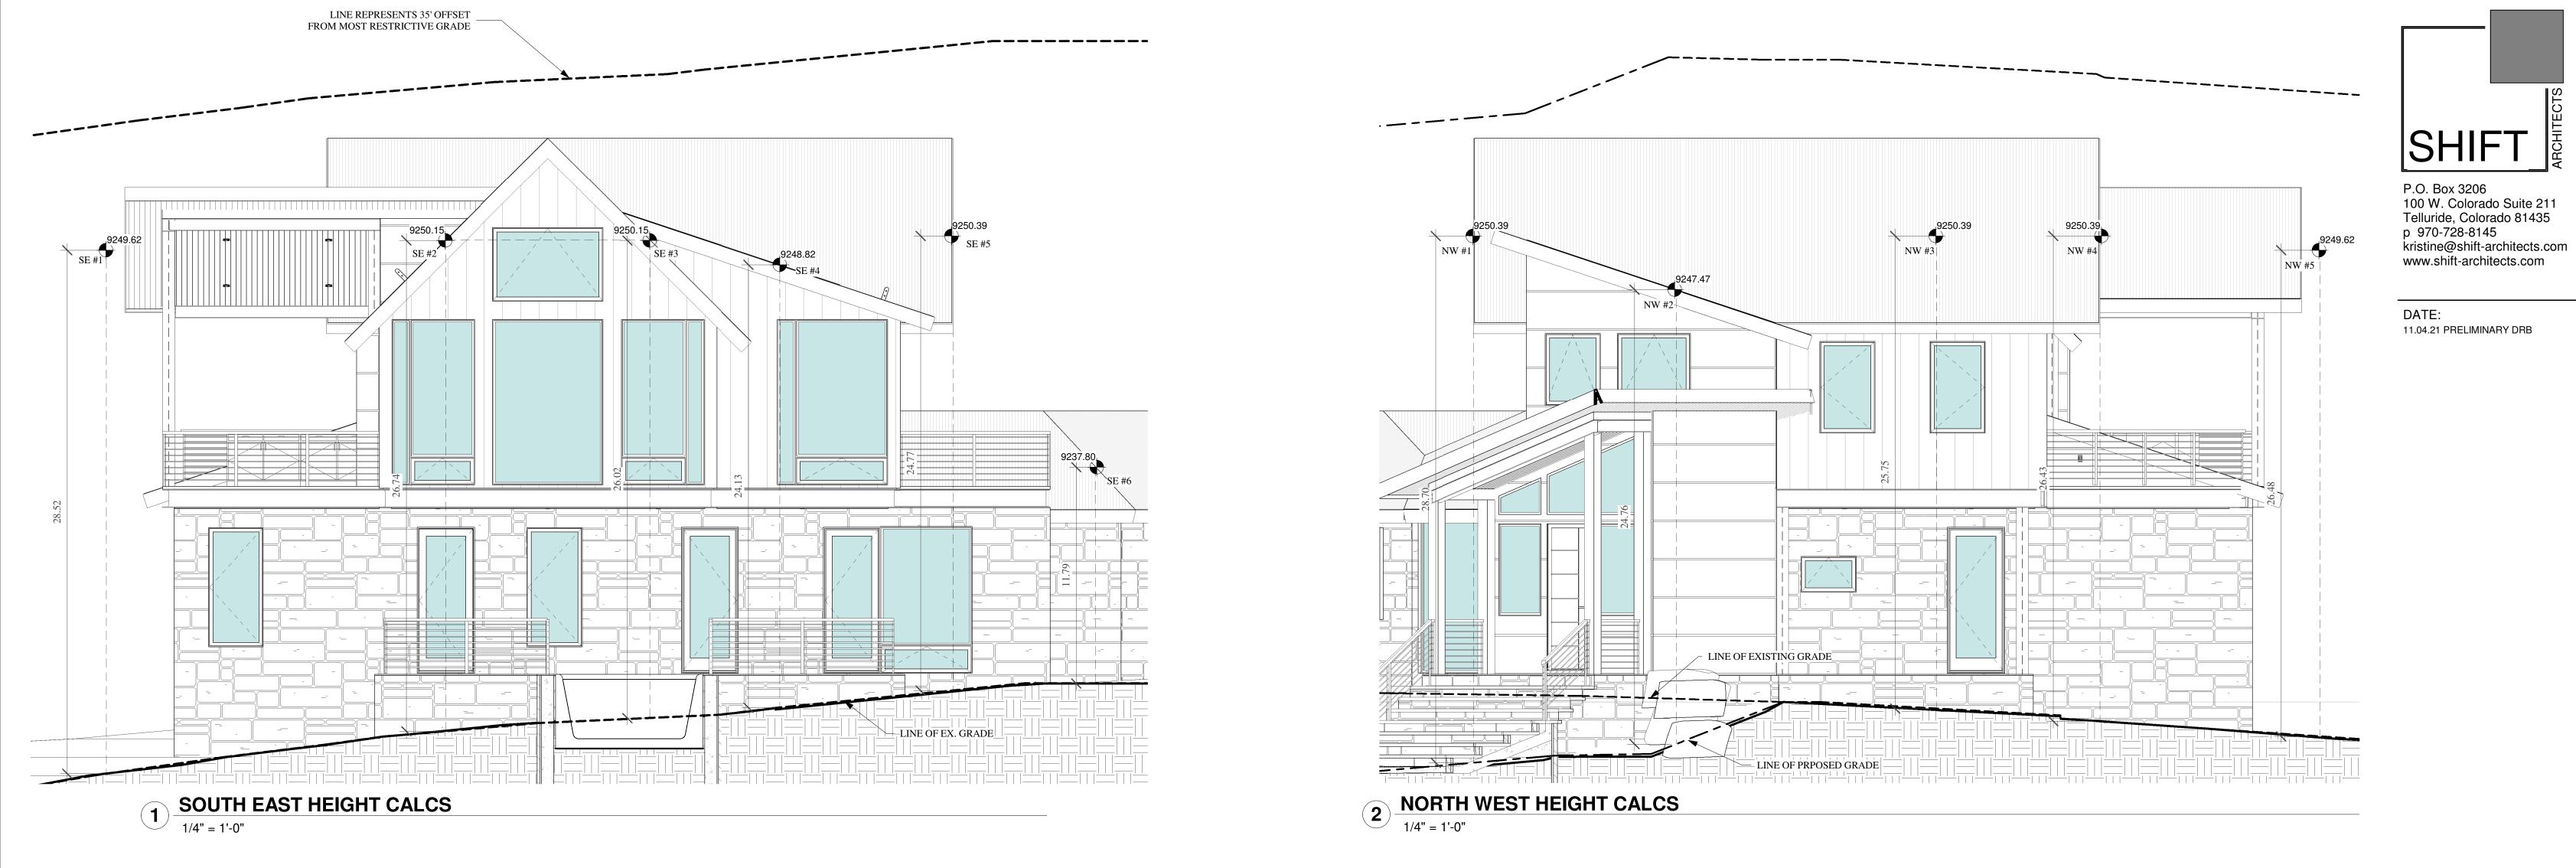

31G VANILLA

ELEVATION HEIGHT CALCS

: 무용 영 SHEET NUMBER

A3.4


LINE OF EXISTING GRADE

LINE OF PROPOSED GRADE

LINE REPRESENTS 35' OFFSET FROM MOST RESTRICTIVE GRADE	
9250.67 9250.67 9249.90 9249.62 SW #1 SW #2 SW #3 SW #4 SW #5	•
27.78 27.48 28.67 29.21	
LINE OF EXISTING GRADE	

6HT 52 74 02 13 77 79 66' 68 97 40 48 67
74 02 13 77 79 66' 68 97 40 48
02 13 77 79 66' 68 97 40 48
13 77 79 66' 68 97 40 48
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AVERAGE HEIGHT CALCULATION

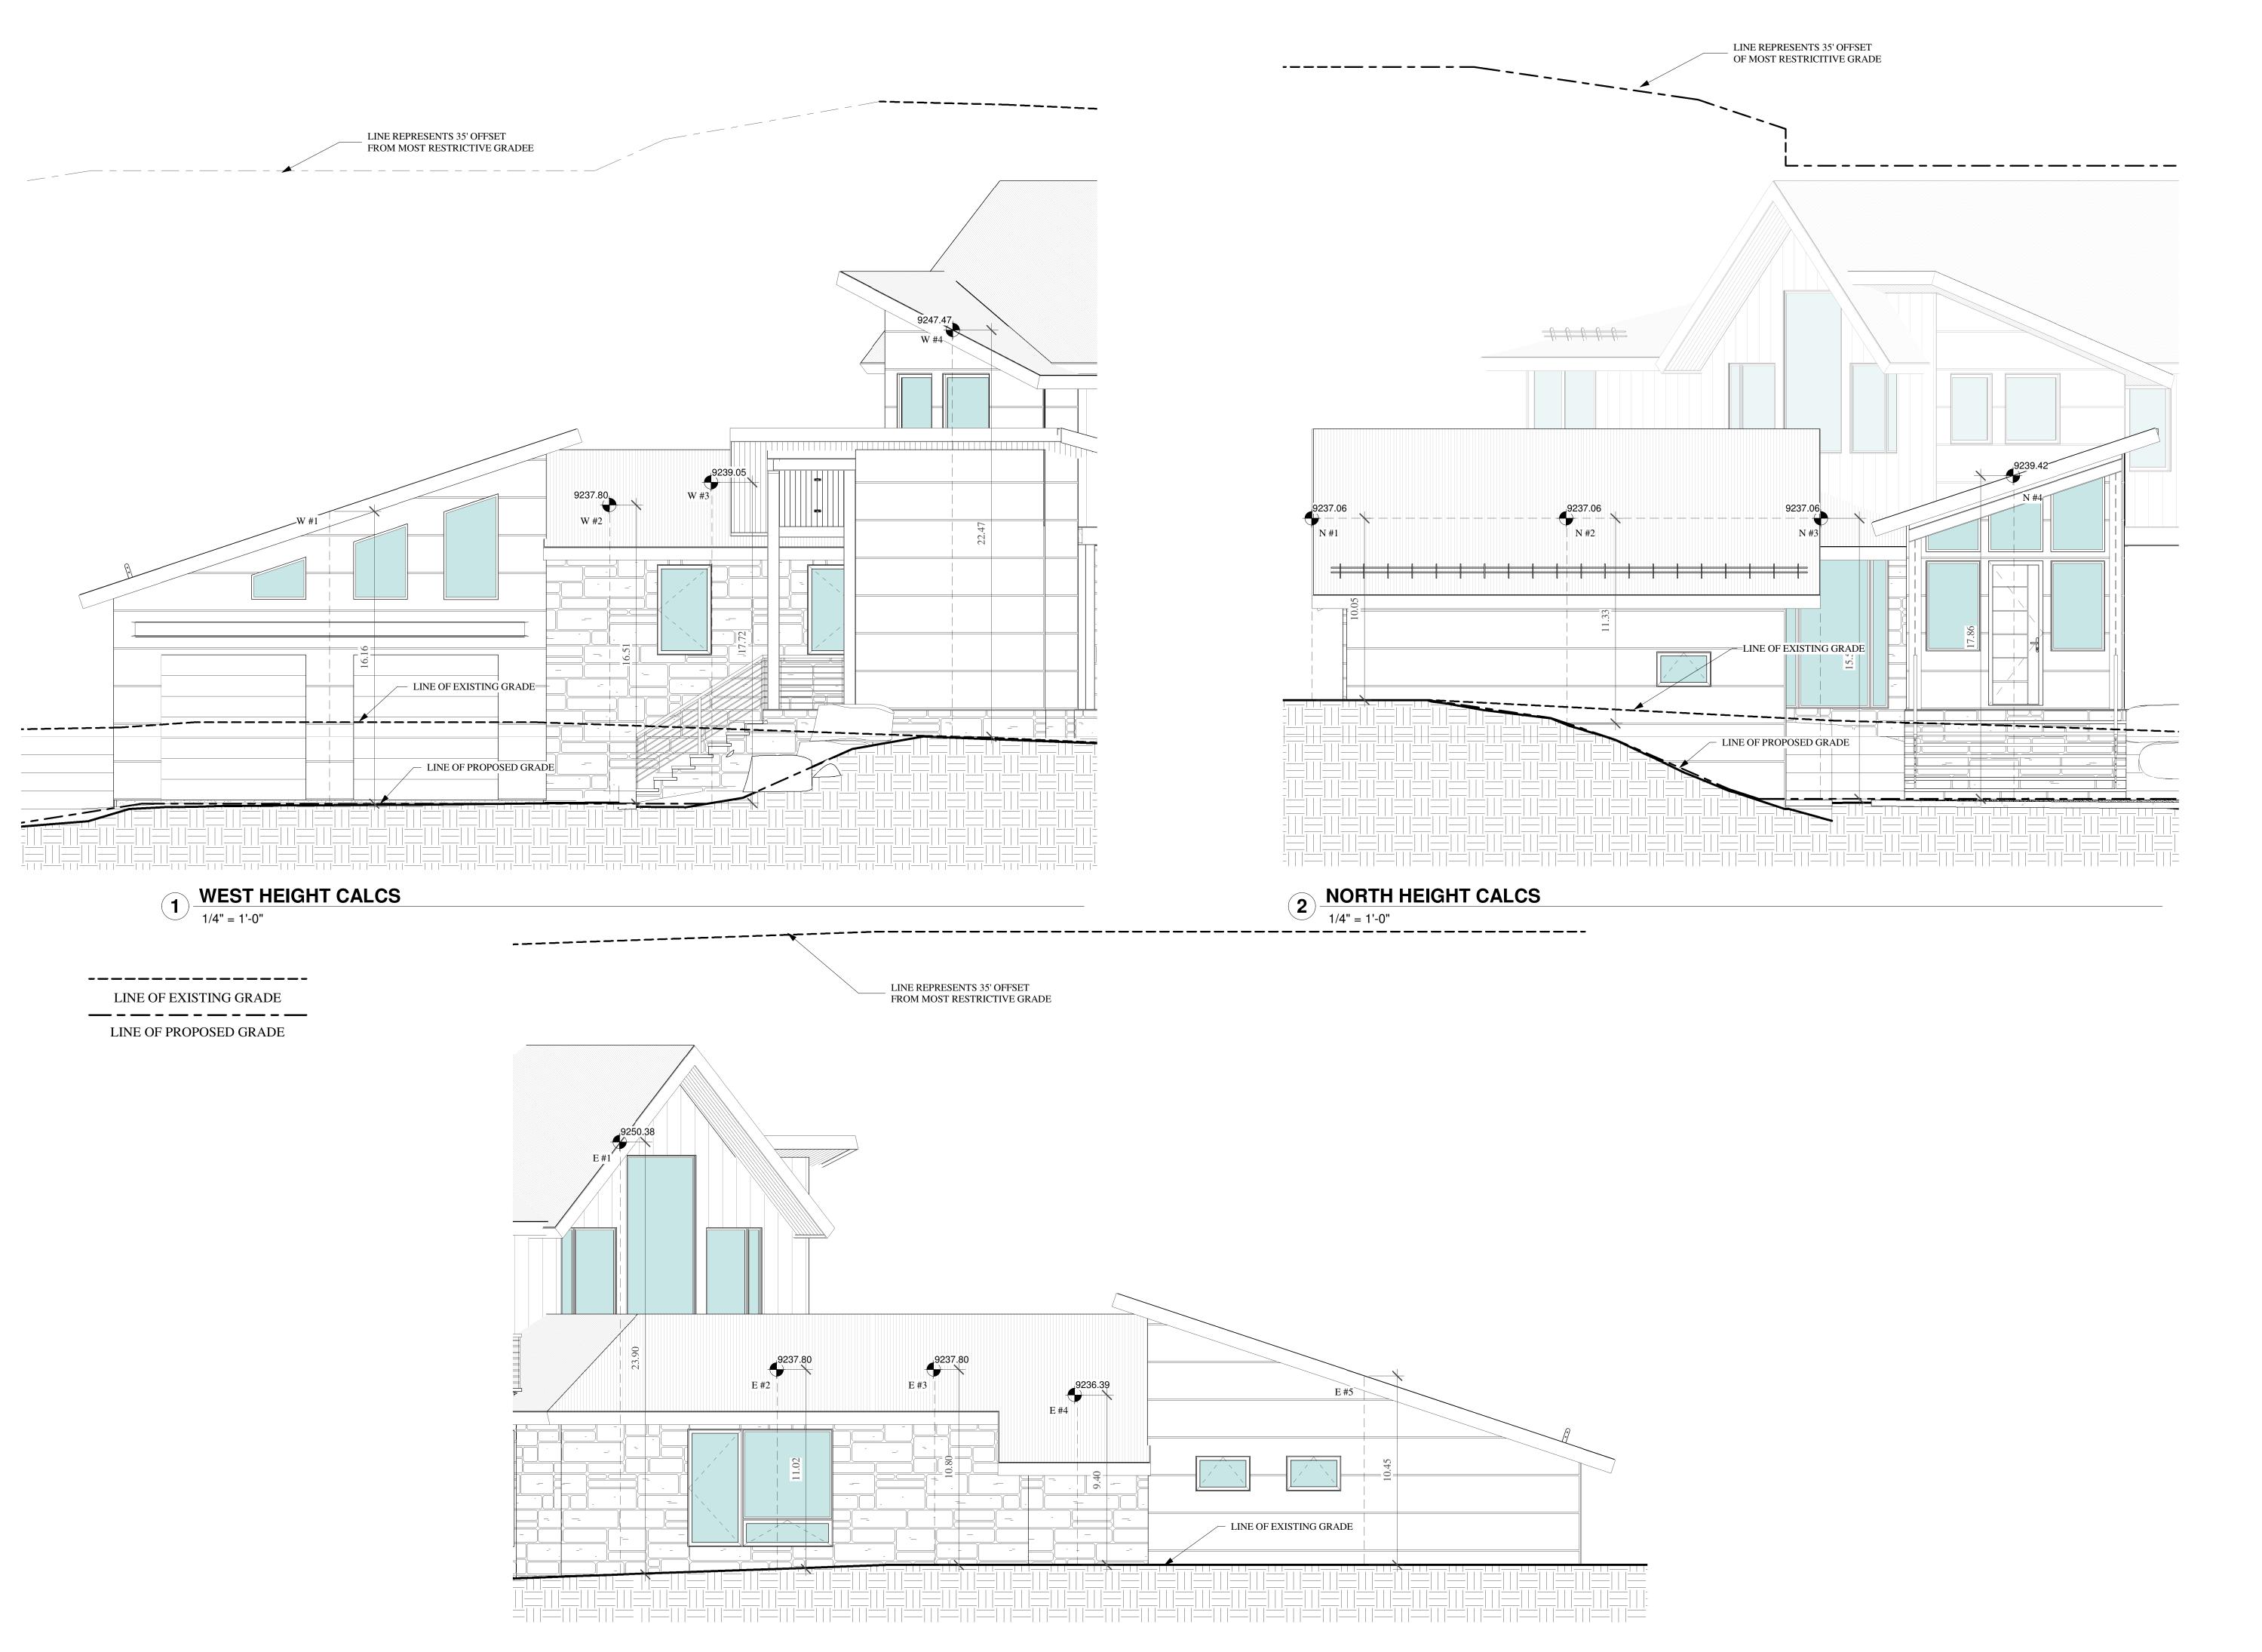

SHIFT

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DATE:

11.04.21 PRELIMINARY DRB

SIG VANILLA

ELEVATION HEIGHT CALCS

SHEET NUMBER

A3.5






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PERSPECTIVES


SHEET NUMBER

A6.1



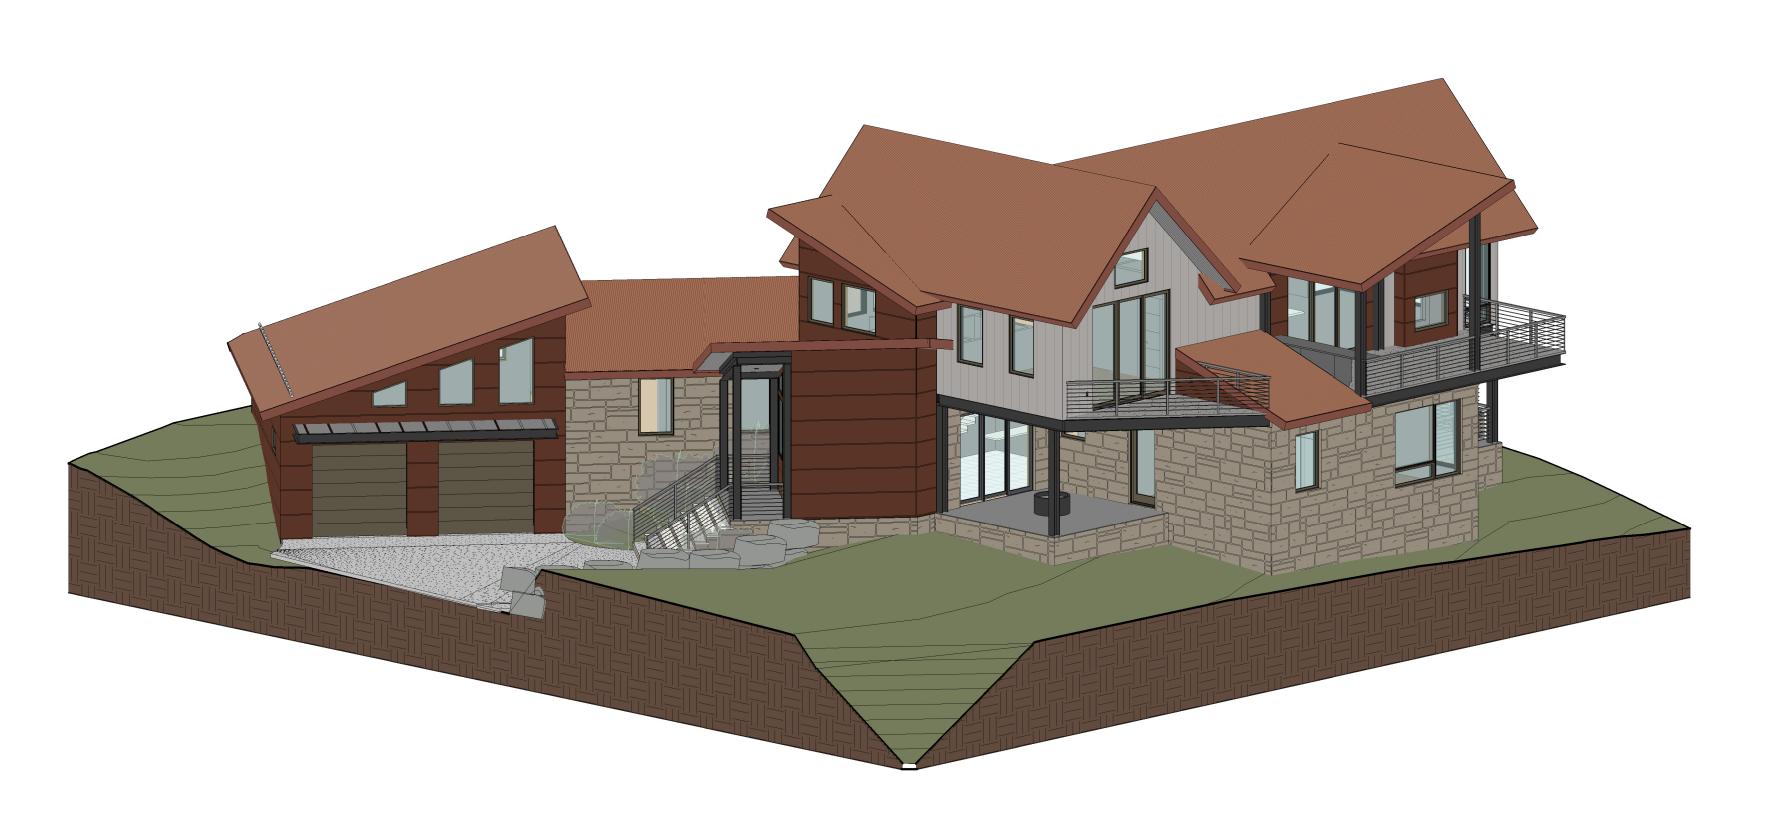


2 SW PERSPECTIVE

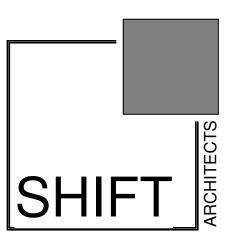

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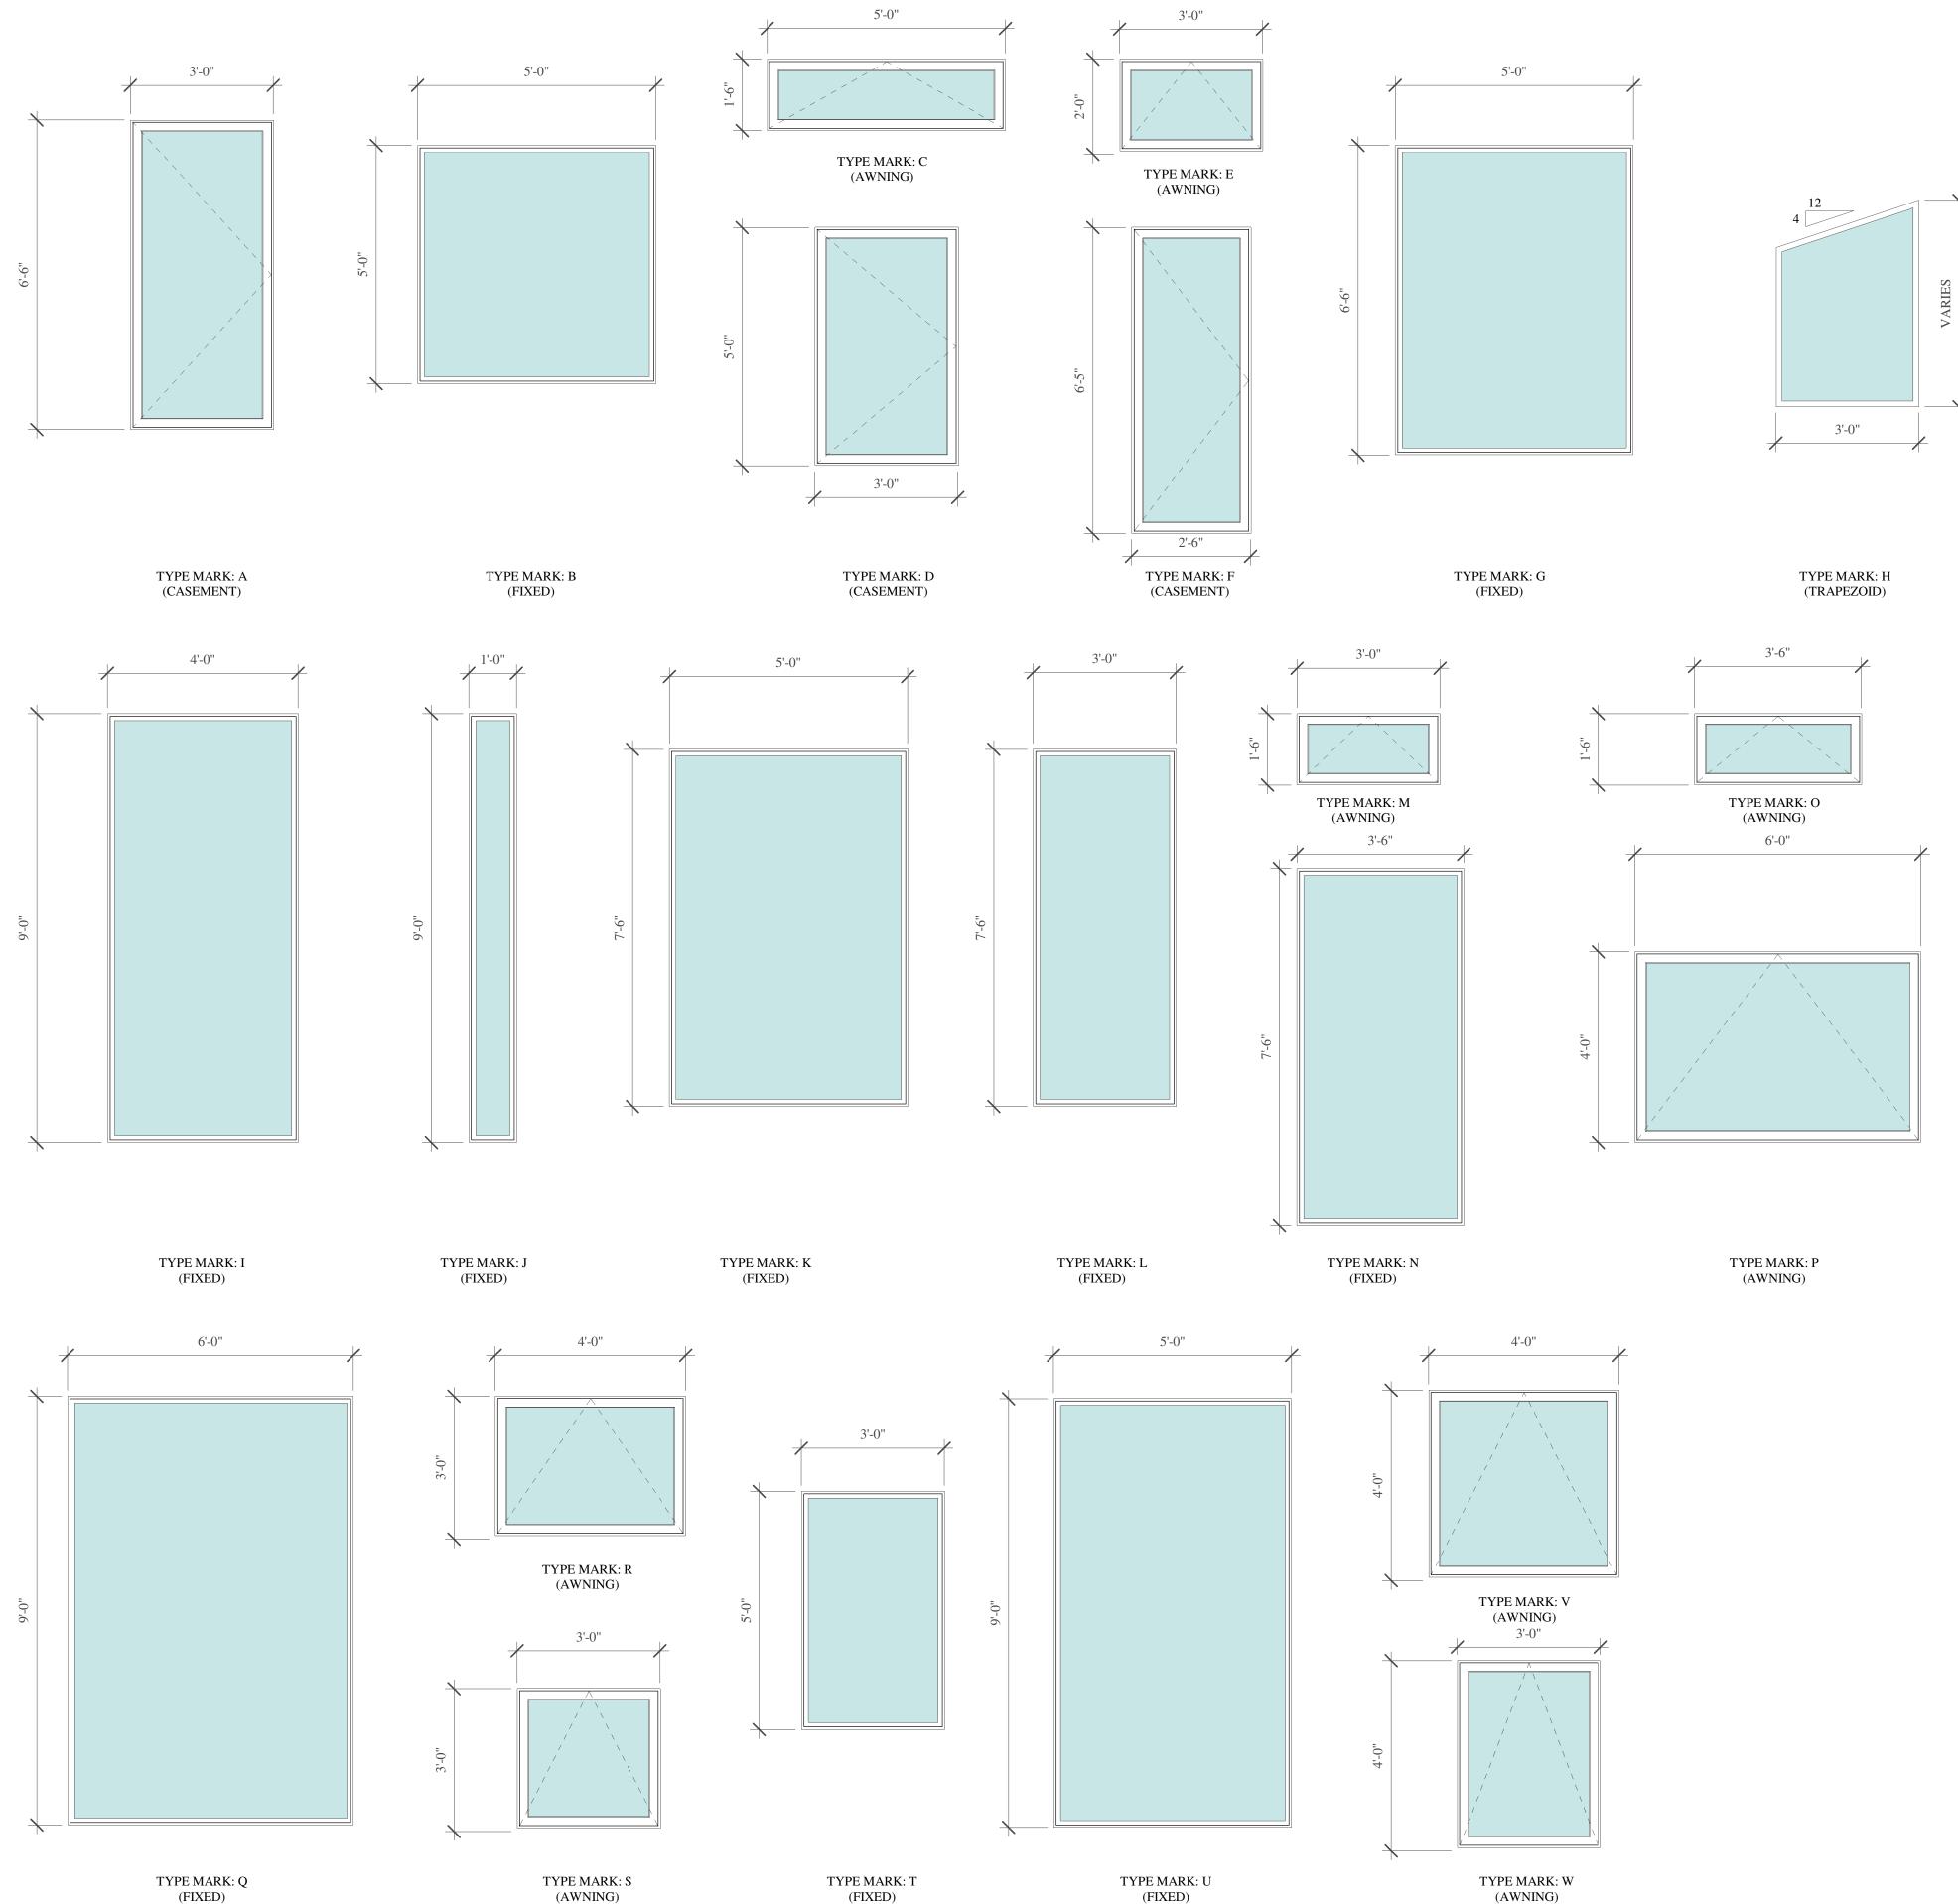
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PERSPECTIVES



WINDOW NOTES:

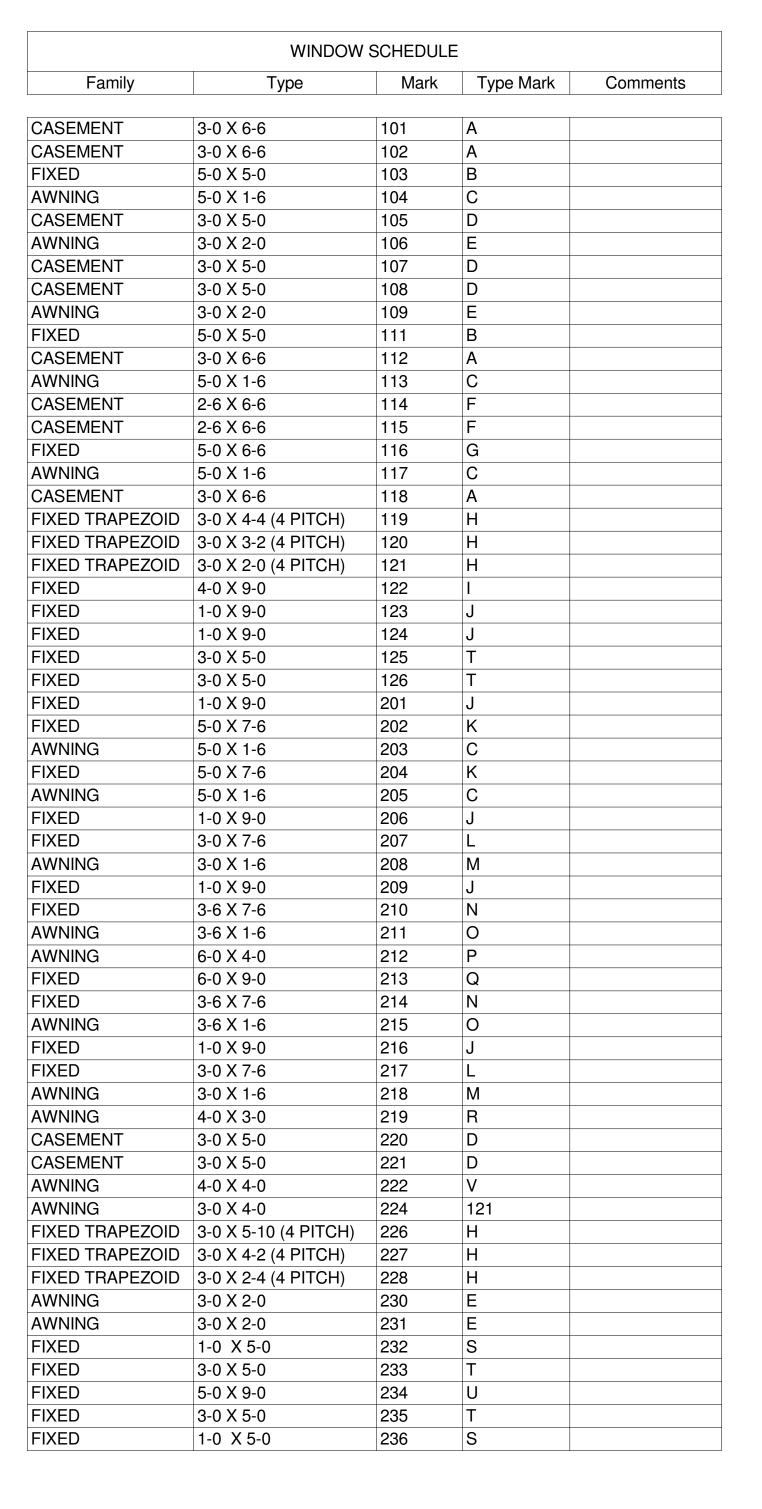- 1. WINDOW INSTALLATION: INSTALL WINDOWS IN ACCORDANCE WITH MANUFACTURER'S INSTALLATION INSTRUCTIONS.
- 2. SEE ELEVATIONS FOR WINDOW MULLION PATTERN.
- 3. WINDOW HARDWARE TO BE BRUSHED NICKEL OR BRUSHED STEEL.
- 4. VERIFY ROUGH OPENINGS WITH MANUFACTURER PRIOR TO FRAMING.
- 5. WINDOW MANUFACTURER TO VERIFY WINDOW SWINGS.
- 6. WINDOW MANUFACTURER TO PROVIDE SHOP DRAWINGS.
- 7. PROVIDE SCREENS FOR ALL OPERABLE WINDOWS.



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3 VANILLA


WINDOW SCHEDULE

> <u>;</u> -

DOOR SCHEDULE						
Family	Mark	Туре	Width	Height	Hardware	Note
ENTRY DOOR	A01	3-0 X 8-0	3' - 0"	8' - 0"		
SINGLE FLUSH	A02	3-0 X 7-0	3' - 0"	7' - 0"		
OVERHEAD GARAGE DOOR	A03	8-0 X 8-0	8' - 0"	8' - 0"		
OVERHEAD GARAGE DOOR	A04	8-0 X 8-0	8' - 0"	8' - 0"		
Door-Double-Flush_Panel	A05	4-6 X 7-0	4' - 6"	7' - 0"		
SINGLE FLUSH	A06	2-8 X 7-0	2' - 8"	7' - 0"		
SINGLE FLUSH	A07	2-6 X 6-8	2' - 6"	6' - 8"		
Single-Pocket-Panel	A08	2-4 X 7-0	2' - 4"	7' - 0"		
Single-Pocket-Panel	A09	2-6 X 7-0	2' - 4"	7' - 0"		
Single-Pocket-Panel	A10	2-4 X 7-0	2' - 4"	7' - 0"		
Single-Pocket-Panel	A11	2-6 X 7-0	2' - 4"	7' - 0"		
Single-Pocket-Panel	A12	2-6 X 7-0	2' - 4"	7' - 0"		
SINGLE FLUSH	A13	2-8 X 7-0	2' - 8"	7' - 0"		
SINGLE GLASS INSWING	A14	3-0 X 8-0	3' - 1 7/16"	7' - 11 1/2"		
SINGLE GLASS INSWING	A15	3-0 X 8-0	3' - 1 7/16"	7' - 11 1/2"		
SINGLE GLASS OUTSWING	A16	3-0 X 8-0	3' - 1 7/16"	7' - 11 1/2"		
Barn Door	A17	2-6 X 7-0	2' - 6"	7' - 0"		
SINGLE FLUSH	A18	3-0 X 7-0	3' - 0"	7' - 0"		
SINGLE GLASS INSWING	A19	3-0 X 8-0	3' - 1 7/16"	7' - 11 1/2"		
SINGLE FLUSH	A20	2-6 X 6-8	2' - 6"	6' - 8"		
THREE PANEL SLIDING	A21	9-0 X 8-0	9' - 0"	7' - 11"		
Single-Pocket-Panel	A22	2-0 X 7-0	2' - 0"	7' - 0"		
THREE PANEL SLIDING	B01	9-0 X 9-0	9' - 2 3/4"	8' - 11 1/2"		
THREE PANEL SLIDING	B02	9-0 X 9-0	9' - 2 3/4"	8' - 11 1/2"		
THREE PANEL SLIDING	B03	9-0 X 9-0	9' - 2 3/4"	8' - 11 1/2"		
Single-Pocket-Panel	B04	2-4 X 7-0	2' - 4"	7' - 0"		
Single-Pocket-Panel	B05	2-6 X 7-0	2' - 4"	7' - 0"		
SINGLE FLUSH	B06	3-0 X 7-0	3' - 0"	7' - 0"		
Single-Pocket-Panel	B07	2-6 X 7-0	2' - 4"	7' - 0"		
Single-Pocket-Panel	B08	2-6 X 7-0	2' - 4"	7' - 0"		
Single-Pocket-Panel	B09	2-6 X 7-0	2' - 4"	7' - 0"		

DOOR NOTES:

- NEW EXTERIOR DOORS TO BE 2/3 LITE PER GS#34. DOOR INSTALLATION: INSTALL DOORS IN ACCORDANCE WITH
- MANUFACTURER'S INSTALLATION INSTRUCTIONS.
 SEE ELEVATIONS FOR DOOR MULLION PATTERN.
 DOOR HARDWARE TO BE BRUSHED NICKEL OR BRUSHED STEEL.
- DOOR & WINDOW MANUFACTURER: LOEWEN OR EQUAL VERIFY ROUGH OPENINGS WITH MANUFACTURER PRIOR TO
 - FRAMING.

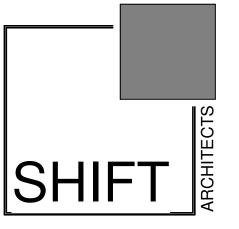

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DOOR SCHEDULE

SHEET NUMBER

A8.2

- 1. FIELD VERIFY ALL LIGHTING LOCATIONS.
- 2. TYPICAL LIGHTING LOCATION AT STAIRS: (1 EA) PER LANDING (2 EA) PER RUN
- 3. CONTRACTOR SHALL TAKE CARE IN PLANNING ROUGH FRAMING LAYOUT AS IT RELATES TO THE NEED TO CENTER FIXTURES IN HALLWAYS, RECESSES AND OTHER AREAS WHERE RELATIONSHIPS DON'T OFFER ANY LATITUDE OR FIELD ADJUSTMENTS.
- 4. ALL RECESSED FIXTURES AT INSULATED CEILINGS TO BE IC RATED AND CERTIFIED AIR TIGHT CONSTRUCTION. ALL EXTERIOR FIXTURES, SHOWER FIXTURES AND FIXTURES OVER TUBS TO BE MARKED "SUITABLE FOR DAMP LOCATIONS".
- 5. LIGHTING SHALL BE IN ACCORDANCE WITH TOWN OF MOUNTAIN VILLAGE COMMUNITY DEVELOPMENT CODE 17.5.12 LIGHTING **REGULATIONS**
- 6. PROVIDE FULL CUT OFF FIXTURES WITH LED 10W 2500K-2700K BULBS PER CDC REQUIREMENTS.
- MOUNT FIXTURES AT 7'-0" AFF MAX PER CDC REQUIREMENTS.
- 8. EXTERIOR LIGHTING ON SECOND AND UPPER FLOORS SHALL REQUIRE EITHER A TIMER OR SENSOR TO REDUCE USAGE AND ENERGY LOSS DURING TIMES OF INACTIVITY.

11.04.21 PRELIMINARY DRB

Revision Schedule

Revision Number Date Description

EXTERIOR E-3:

MEGALUX HD	
FINISH: WARM WHITE	
MANUFACTURER	RIBON STAR
ITEM	RL-DX-MGL-WW-10
MATERIAL	TAPE
GLASS	N/A
LENGTH	1.5'
LAMP TYPE	LED
LUMENS	1317 / FT
COLOR TEMPERATURE	3000K
RATED LIFE	50,000 HRS
CERTIFICATION	CE, RoHS, ETL LISTED
DARK SKY	YES
VOLTAGE	24 VDC

EXTERIOR STEP AND WALL LIGHT

WL-LED 100	
FINISH: BLACK	
MANUFACTURER	WAC LIGHTING
ITEM	WL-LED100-C-BK
MATERIAL	DIE-CAST ALUMINUM
GLASS	ETCHED LENS
WIDTH	5"
HEIGHT	3"
DEPTH	.13"
LAMP TYPE	LED
BULB TYPE	3.9W
LUMENS	31
COLOR TEMPERATURE	3000K
CRI	83
RATED LIFE	40,000 HOURS
CERTIFICATION	IP66, UL & cUL LISTED FOR WET LOCATIONS
DARK SKY	YES
VOLTAGE	120V, DIRECT WIRING

EXTERIOR E-2:

BK-Black Finish

EXTERIOR E-1:

EXTERIOR RECESSED LED CAN

WAC LIGHTING WAC514031

ETCHED LENS

4.25" DIA

4.25" DIA

.13"

LED

535

14.5W

90,000 HOURS

120V, DIRECT WIRING

IP66, UL & cUL LISTED FOR WET LOCATIONS

DIE-CAST ALUMINUM

TESLA PRO 2

MANUFACTURER

MATERIAL

GLASS WIDTH

HEIGHT

DEPTH

LAMP TYPE

BULB TYPE

LUMENS

RATED LIFE

DARK SKY

VOLTAGE

CERTIFICATION

FINISH: BRUSHED NICKLE

COLOR TEMPERATURE 2700K

1 1ST FL EXTERIOR LIGHTING PLAN

1/4" = 1'-0"

1.0 1.0 1.0


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E-1

E1.1


1ST FL EXTERIOR

LIGHTING PLANS

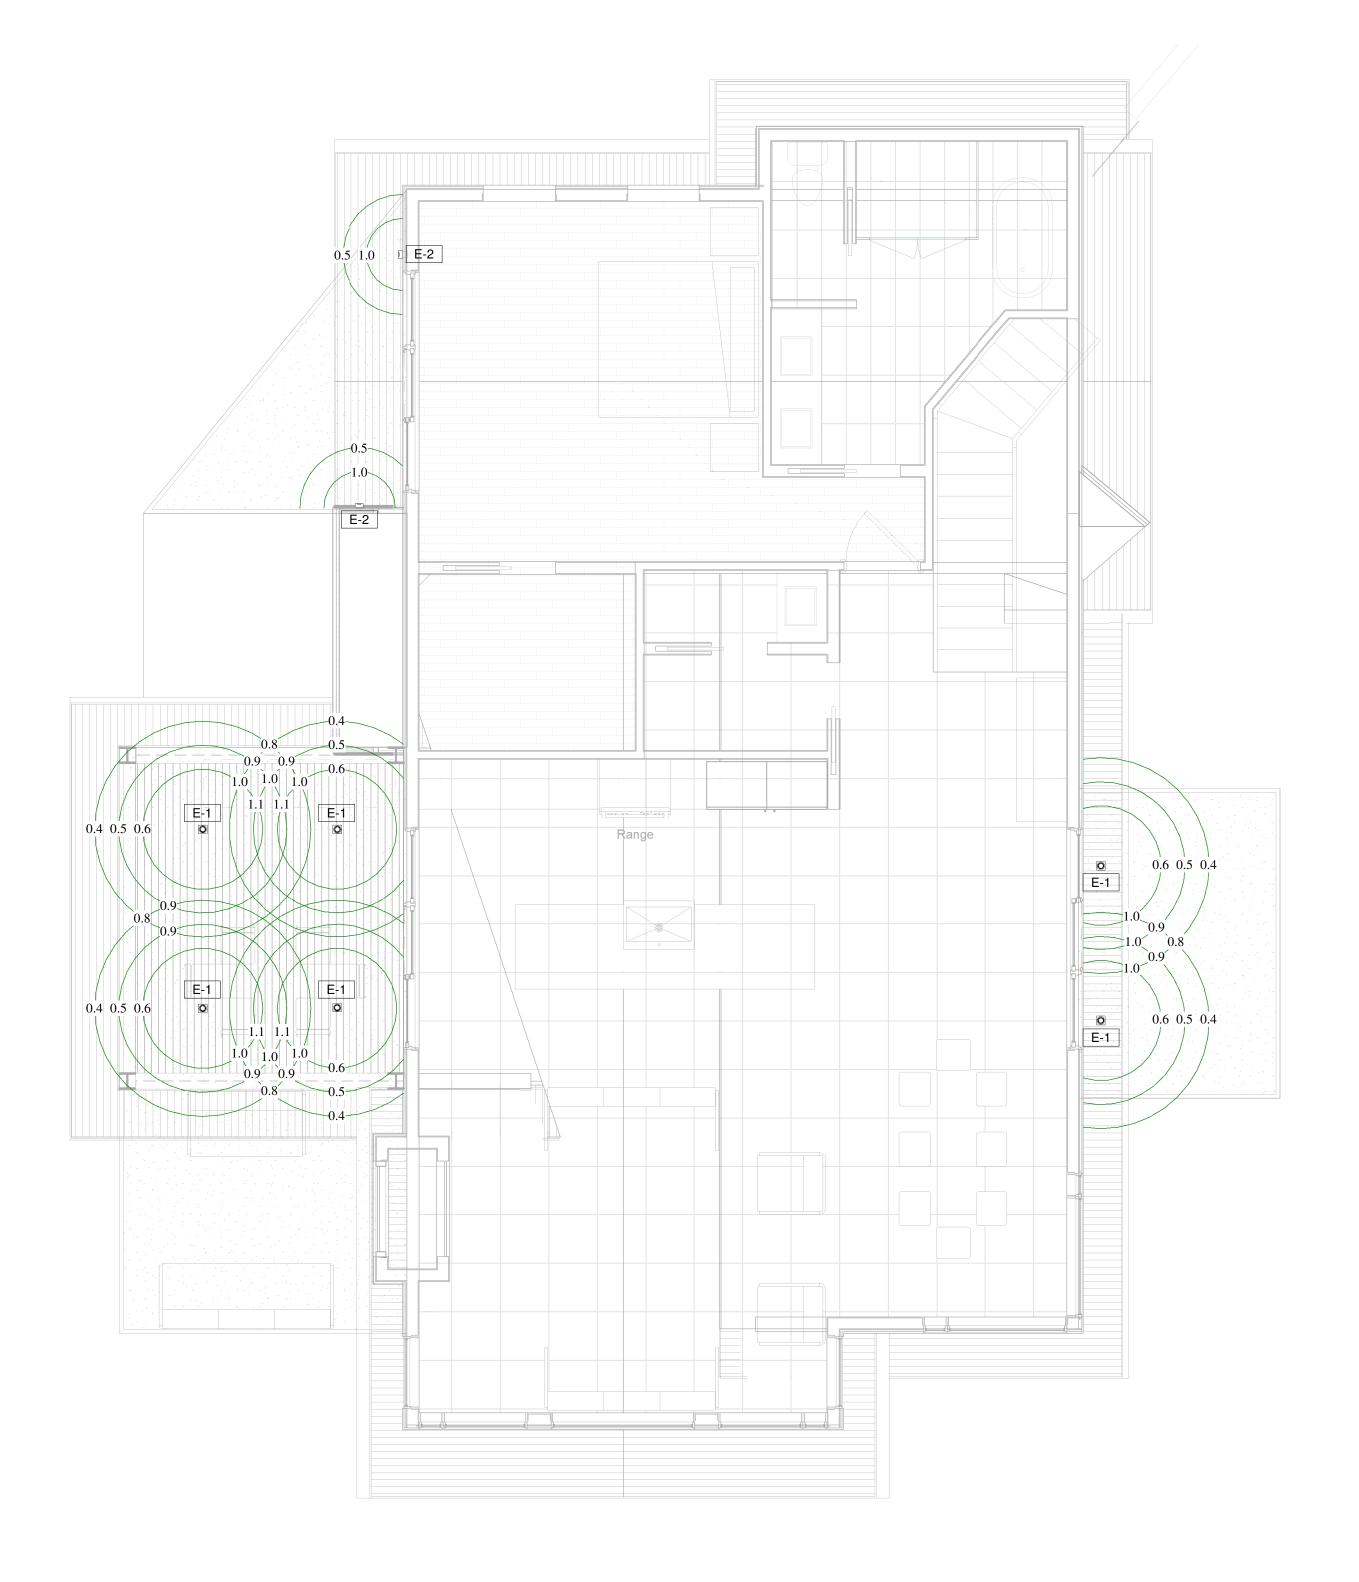

1 2ND FL EXTERIOR LIGHTING PLAN

1/4" = 1'-0"

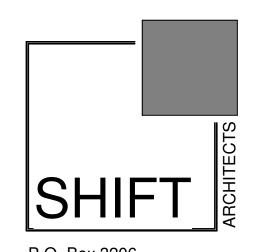

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BIG VANILLA

2ND FL EXTERIOR LIGHTING PLANS

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