DRAWING INDEX

SHEET NUMBER	SHEET NAME	SHEET ISSUE DA
A0.1	RENDERINGS	17 OCT 2022
A0.2	SURVEY	17 OCT 2022
A1.0	SITE PLAN	17 OCT 2022
A2.0	FLOOR PLAN - GARAGE / BASEMENT	17 OCT 2022
A2.1	FLOOR PLAN - MAIN LEVEL	17 OCT 2022
A2.2	FLOOR PLAN - PRIMARY SUITE LEVEL	17 OCT 2022
A2.3	ROOF PLAN	17 OCT 2022
A3.0	HEIGHT & EXT MATERIAL COMPLIANCE	17 OCT 2022
A3.1	HEIGHT & EXT MATERIAL COMPLIANCE	11 NOV 2022
A3.2	EXTERIOR ELEVATIONS	17 OCT 2022
A3.3	EXTERIOR ELEVATIONS	17 OCT 2022
A3.4	EXTERIOR ELEVATIONS	17 OCT 2022
A3.5	EXTERIOR MATERIALS BOARD	17 OCT 2022
A4.0	WINDOW SCHEDULE	17 OCT 2022
A4.1	DOOR SCHEDULE	17 OCT 2022
A5.0	WALL SECTION	17 OCT 2022
A5.1	OPENINGS	11 NOV 2022
C1	NOTES	17 OCT 2022
C2.1	SITE GRADING WITH NO TREES DISPLAYED	17 OCT 2022
C2.2	SITE GRADING WITH TREES DISPLAYED	17 OCT 2022
C3	UTILITIES	17 OCT 2022
C5	FIRE MITIGATION	17 OCT 2022

SITE	ANALYSIS	SCOPE	OF	WORK
------	----------	-------	----	------

ZONING: SINGLE FAMILY GROSS LOT AREA: 30,056 SQ FT

•		
	MAX ALLOWED	MAX PROPOSED
LOT COVERAGE	12,022 SQ FT	2,807 SQ FT
HEIGHT	40 FT	33.9 FT
AVERAGE HEIGHT	30 FT	21.29 FT
PARKING REQUIRED	2 ENCLOSED 2 EXTERIOR	2 ENCLOSED


PROPOSAL TO CONSTRUCT A 3744 SQ FT SINGLE FAMILY HOME WITH AN ATTACHED 708 SQ FT GARAGE AT THE BASEMENT LEVEL ON A 30,056 SQ FT LOT. THE HOME IS TO CONTAIN 3 BEDROOMS,1 BUNK ROOM, 3 1/2 BATHROOMS, AND 1 SKI/MUD ROOM. TOTAL SITE COVERAGE IS 2,807 SQ FT (ALLOWABLE = 12,022 SQ FT).

DRAWING SYMBOLS

DOOR NUMBER

ELEVATION MARK - HEIGHT ABOVE REF. ELEV. (0'-0")

ROOM NAME & NUMBER

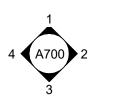


INTERIOR ELEVATION NUMBER & SHEET NUMBER



DETAIL NUMBER SHEET NUMBER



SHEET NUMBER EXTERIOR ELEVATION NUMBER

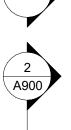

SECTION NUMBER SHEET NUMBER

GENERAL NOTES


- REFER TO COMPLETE SET OF ISSUED CONTRACT DOCUMENTS FOR APPLICABLE NOTES, ABBREVIATIONS, AND SYMBOLS. DO NOT SCALE THE DRAWINGS. IF DIMENSIONS ARE IN QUESTION THE CONTRACTOR SHALL BE RESPONSIBLE FOR OBTAINING CLARIFICATION FROM THE
- ARCHITECT BEFORE CONTINUING.
- ISOLATE DISSIMILAR METALS TO PREVENT GALVANIC CORROSION.
- SEALANTS EXPOSED TO VIEW SHALL BE CUSTOM COLOR AS SELECTED BY THE ARCHITECT. COORDINATE LOCATION OF SEALANT AND COMPATIBILITY OF SEALANTS WITH ADJACENT WORK, BUILDING MATERIALS, AND OTHER CONTINUOUS SEALANTS.
- COMPLY WITH ALL APPLICABLE CODES, LAWS, ORDINANCES, ORDERS, RULES, AND REGULATIONS OF AUTHORITIES HAVING JURISDICTION.
- REVIEW DOCUMENTS, VERIFY DIMENSIONS AND FIELD CONDITIONS AND CONFIRM THAT WORK IS BUILDABLE AS SHOWN. REPORT ANY CONFLICTS OR OMISSIONS TO THE ARCHITECT FOR CLARIFICATION PRIOR TO PERFORMING ANY WORK IN QUESTION.
- COORDINATE WORK WITH THE OWNER, INCLUDING SCHEDULING TIME AND LOCATIONS FOR DELIVERIES, BUILDING ACCESS, USE OF BUILDING SERVICES AND FACILITY. MINIMIZE DISTURBANCE OF BUILDING FUNCTIONS AND OCCUPANTS.
- MAINTAIN WORK AREAS SECURE AND LOCKABLE DURING CONSTRUCTION. COORDINATE WITH OWNER AND/OR PROPERTY MANAGER TO ENSURE SECURITY.
- MAINTAIN EXITS, EXIT LIGHTING, FIRE PROTECTIVE DEVICES, AND ALARMS IN CONFORMANCE WITH APPLICABLE CODES AND ORDINANCES. 10 EXAMINATION OF THE SITE AND PORTIONS THEREOF THAT AFFECT THIS WORK SHALL BE MADE BY THE GENERAL CONTRACTOR PRIOR TO STARTING WORK,
- WHO SHALL COMPARE EXISTING CONDITIONS WITH THE CONTRACT DOCUMENTS AND SATISFY HIM/HERSELF AS TO THE EXISTING CONDITIONS UNDER WHICH WORK IS TO BE PERFORMED. CONTRACTOR SHALL AT SUCH TIME ASCERTAIN AND VERIFY THE LOCATIONS OF EXISTING STRUCTURES AND UTILITIES.
- 11 ALL MANUFACTURED ARTICLES, MATERIALS AND EQUIPMENT SHALL BE INSTALLED, CONNECTED, ERECTED CLEANED, AND CONDITIONED PER THE MANUFACTURER'S INSTRUCTIONS. IN CASE OF DIFFERENCES BETWEEN MANUFACTURER'S INSTRUCTIONS AND THE CONTRACT DOCUMENTS, THE CONTRACTOR SHALL NOTIFY THE ARCHITECT BEFORE PROCEEDING WITH THE WORK IN QUESTION.
- 12 DAMAGE TO NEW AND EXISTING MATERIALS, FINISHES, STRUCTURES AND EQUIPMENT SHALL BE REPAIRED OR REPLACED TO THE SATISFACTION OF THE OWNER AT THE EXPENSE OF THE CONTRACTOR.
- 13 CONTRACTOR SHALL REMOVE ALL RUBBISH AND WASTE MATERIALS OF ALL SUBCONTRACTORS AND TRADES ON A DAILY BASIS AND SHALL EXERCISE STRICT CONTROL OVER JOB CLEANING TO PREVENT ANY DIRT, DEBRIS, OR DUST FROM AFFECTING ANY FINISHED AREAS IN OR OUTSIDE THE JOB SITE. BURNING OF DEBRIS ON SITE SHALL NOT BE PERMITTED.
- 14 CONTRACTOR SHALL NOT PROCEED WITH ANY WORK REQUIRING ADDITIONAL COMPENSATION BEYOND THE CONTRACT AMOUNT WITHOUT AUTHORIZATION FROM THE ARCHITECT OR OWNER. FAILURE TO OBTAIN AUTHORIZATION SHALL INVALIDATE ANY CLAIM FOR ADDITIONAL COMPENSATION.










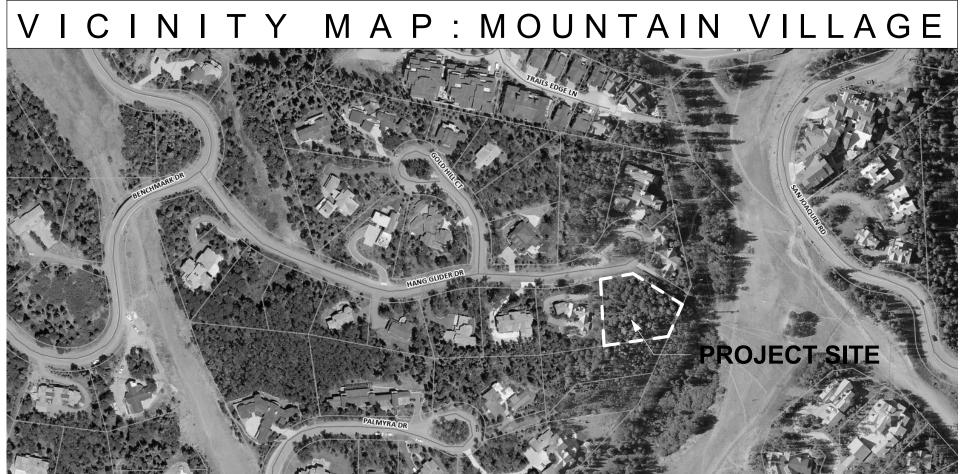


SILVER CAMP

Lot 240-A, Mountain Village, Telluride, CO

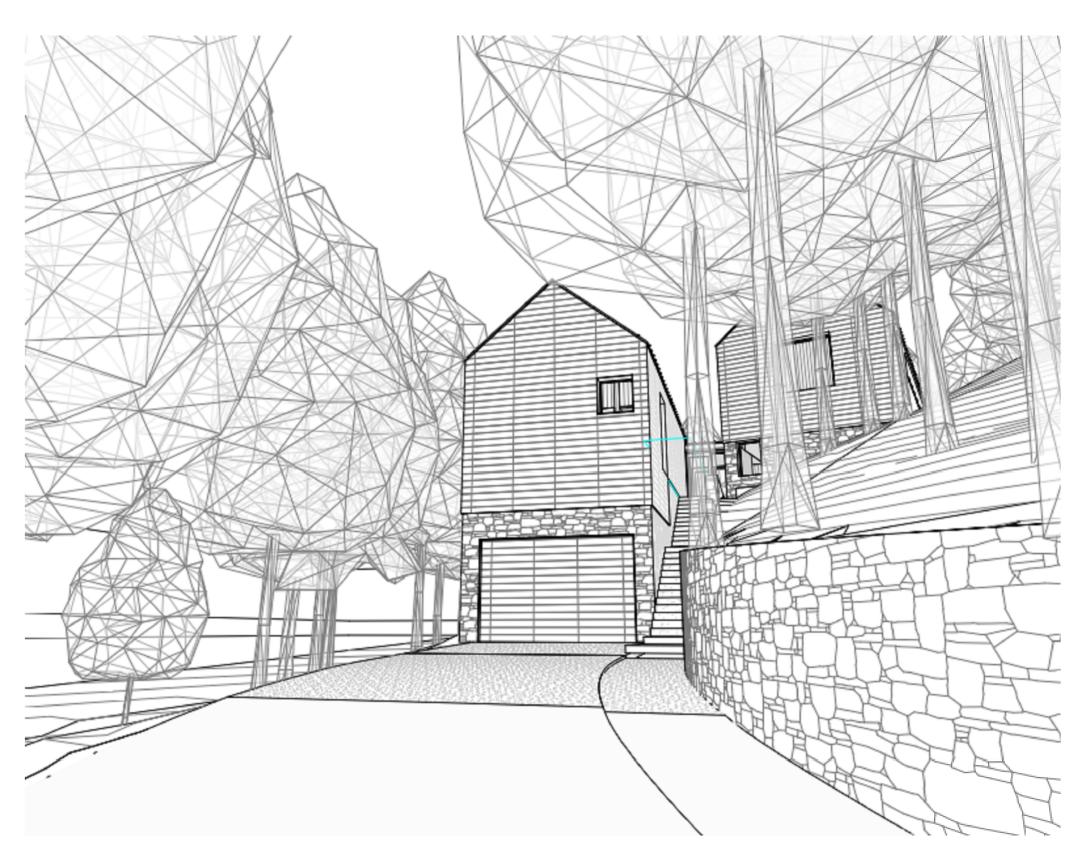


1. PERSPECTIVE AT END OF DRIVEWAY LOOKING AT GARAGE

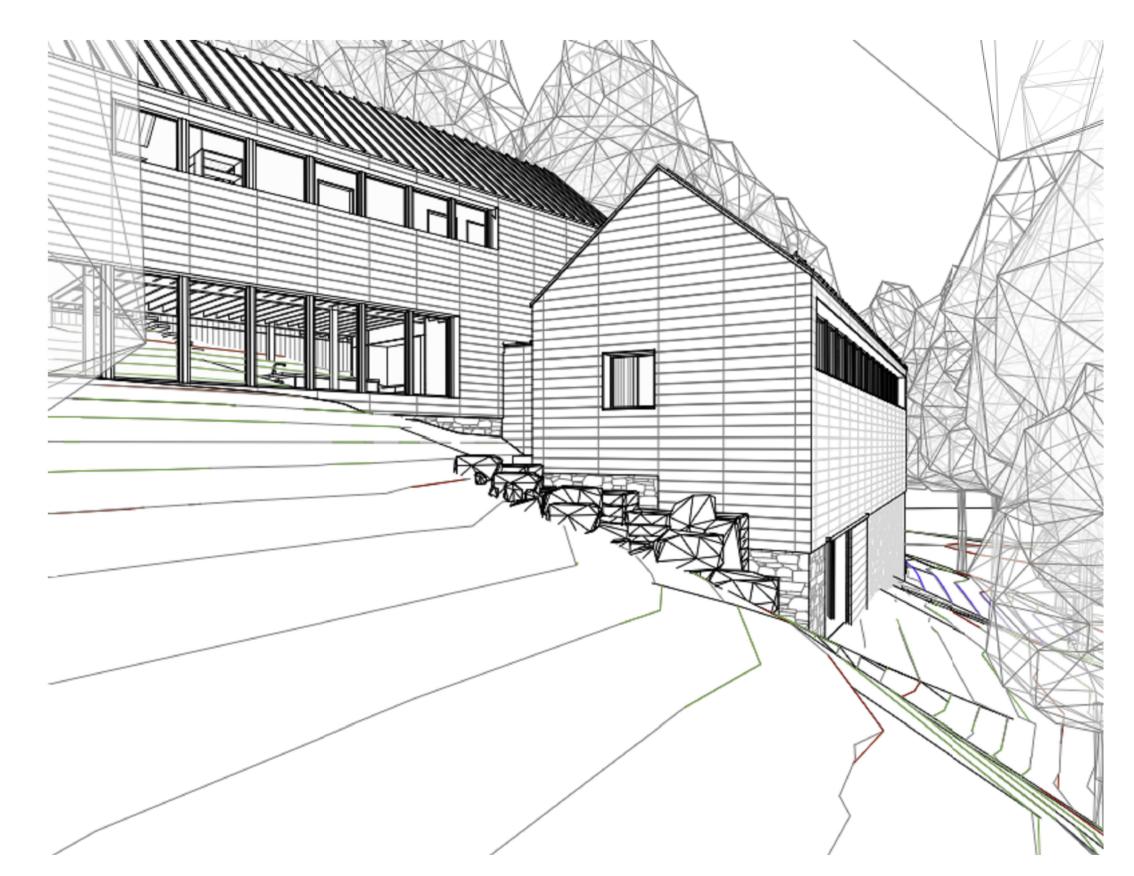

3. PERSPECTIVE LOOKING AT BEDROOM WING




2. PERSPECTIVE LOOKING AT ENTRY VESTIBULE FROM SIDE LANDSCAPE STAIR

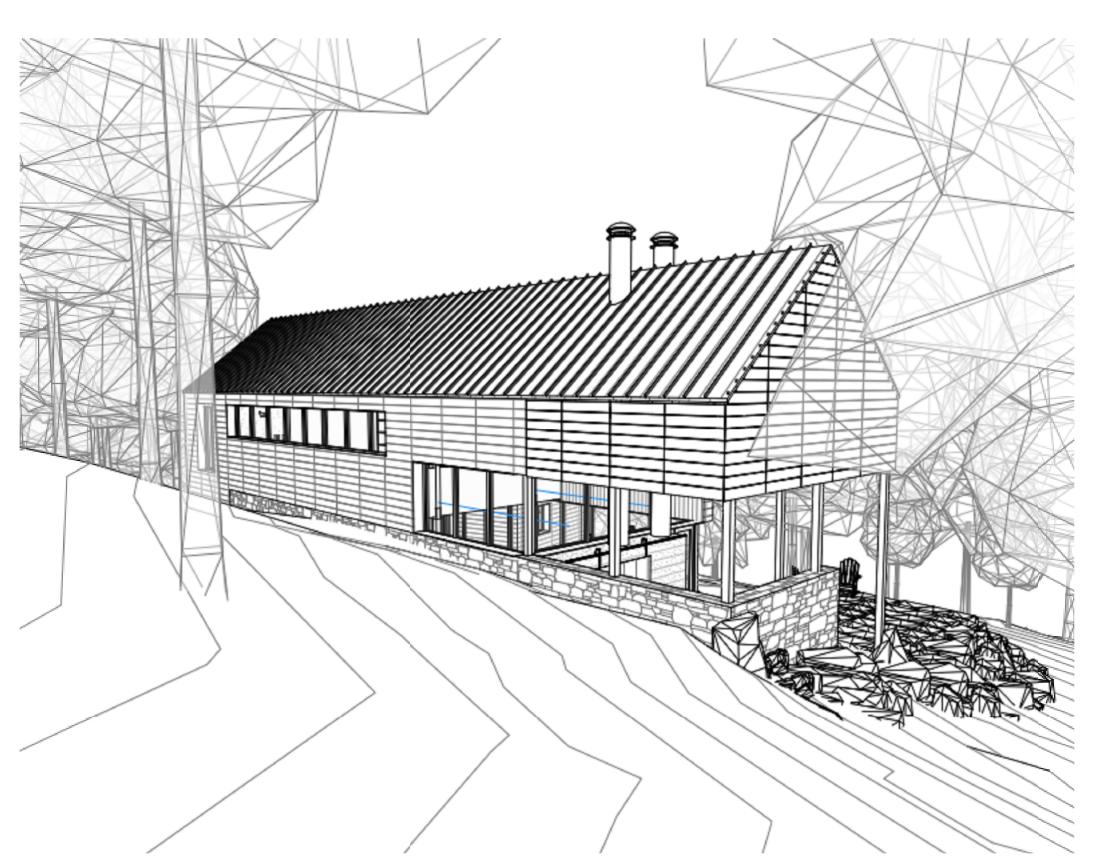

4. PERSPECTIVE LOOKING AT MAIN LIVING BUILDING CORNER UPSLOPE



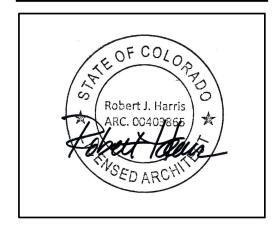

SILVER CAMP

VIEW LEGEND

Lot 240-A, Mountain Village, Telluride, CO

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UNCOMPAGHRE ENGINEERING P.O. BOX 3945, TELLURIDE, CO, 81435

DB STRUCTURAL ENGINEER
1229 SAGE CT, RIFLE, CO, 81650

STUDIO OUTSIDE 824 EXPOSITION AVE STE 5, DALLAS, TX,75226

> THIS SQUARE APEARS 1/2"x1/2" ON FULL SIZE SHEETS

17 OCT 2022 LIF PROJ. NO. 20030
PROJ. ARCHITECT DC DRAWN BY: VM

DATE ISSUE DATES

REVISIONS


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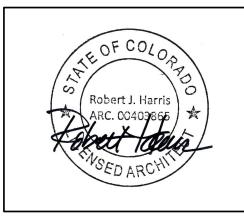
INIITIAL ARCH. & SITE REVIEW

RENDERINGS

A0.1

F:\Bulson Surveying Jobs\Jobs 2022\22052\22050 Lot 240-A TMV Topo 8-24-2022.dwa, 11/11/2022 5:07:12 AN



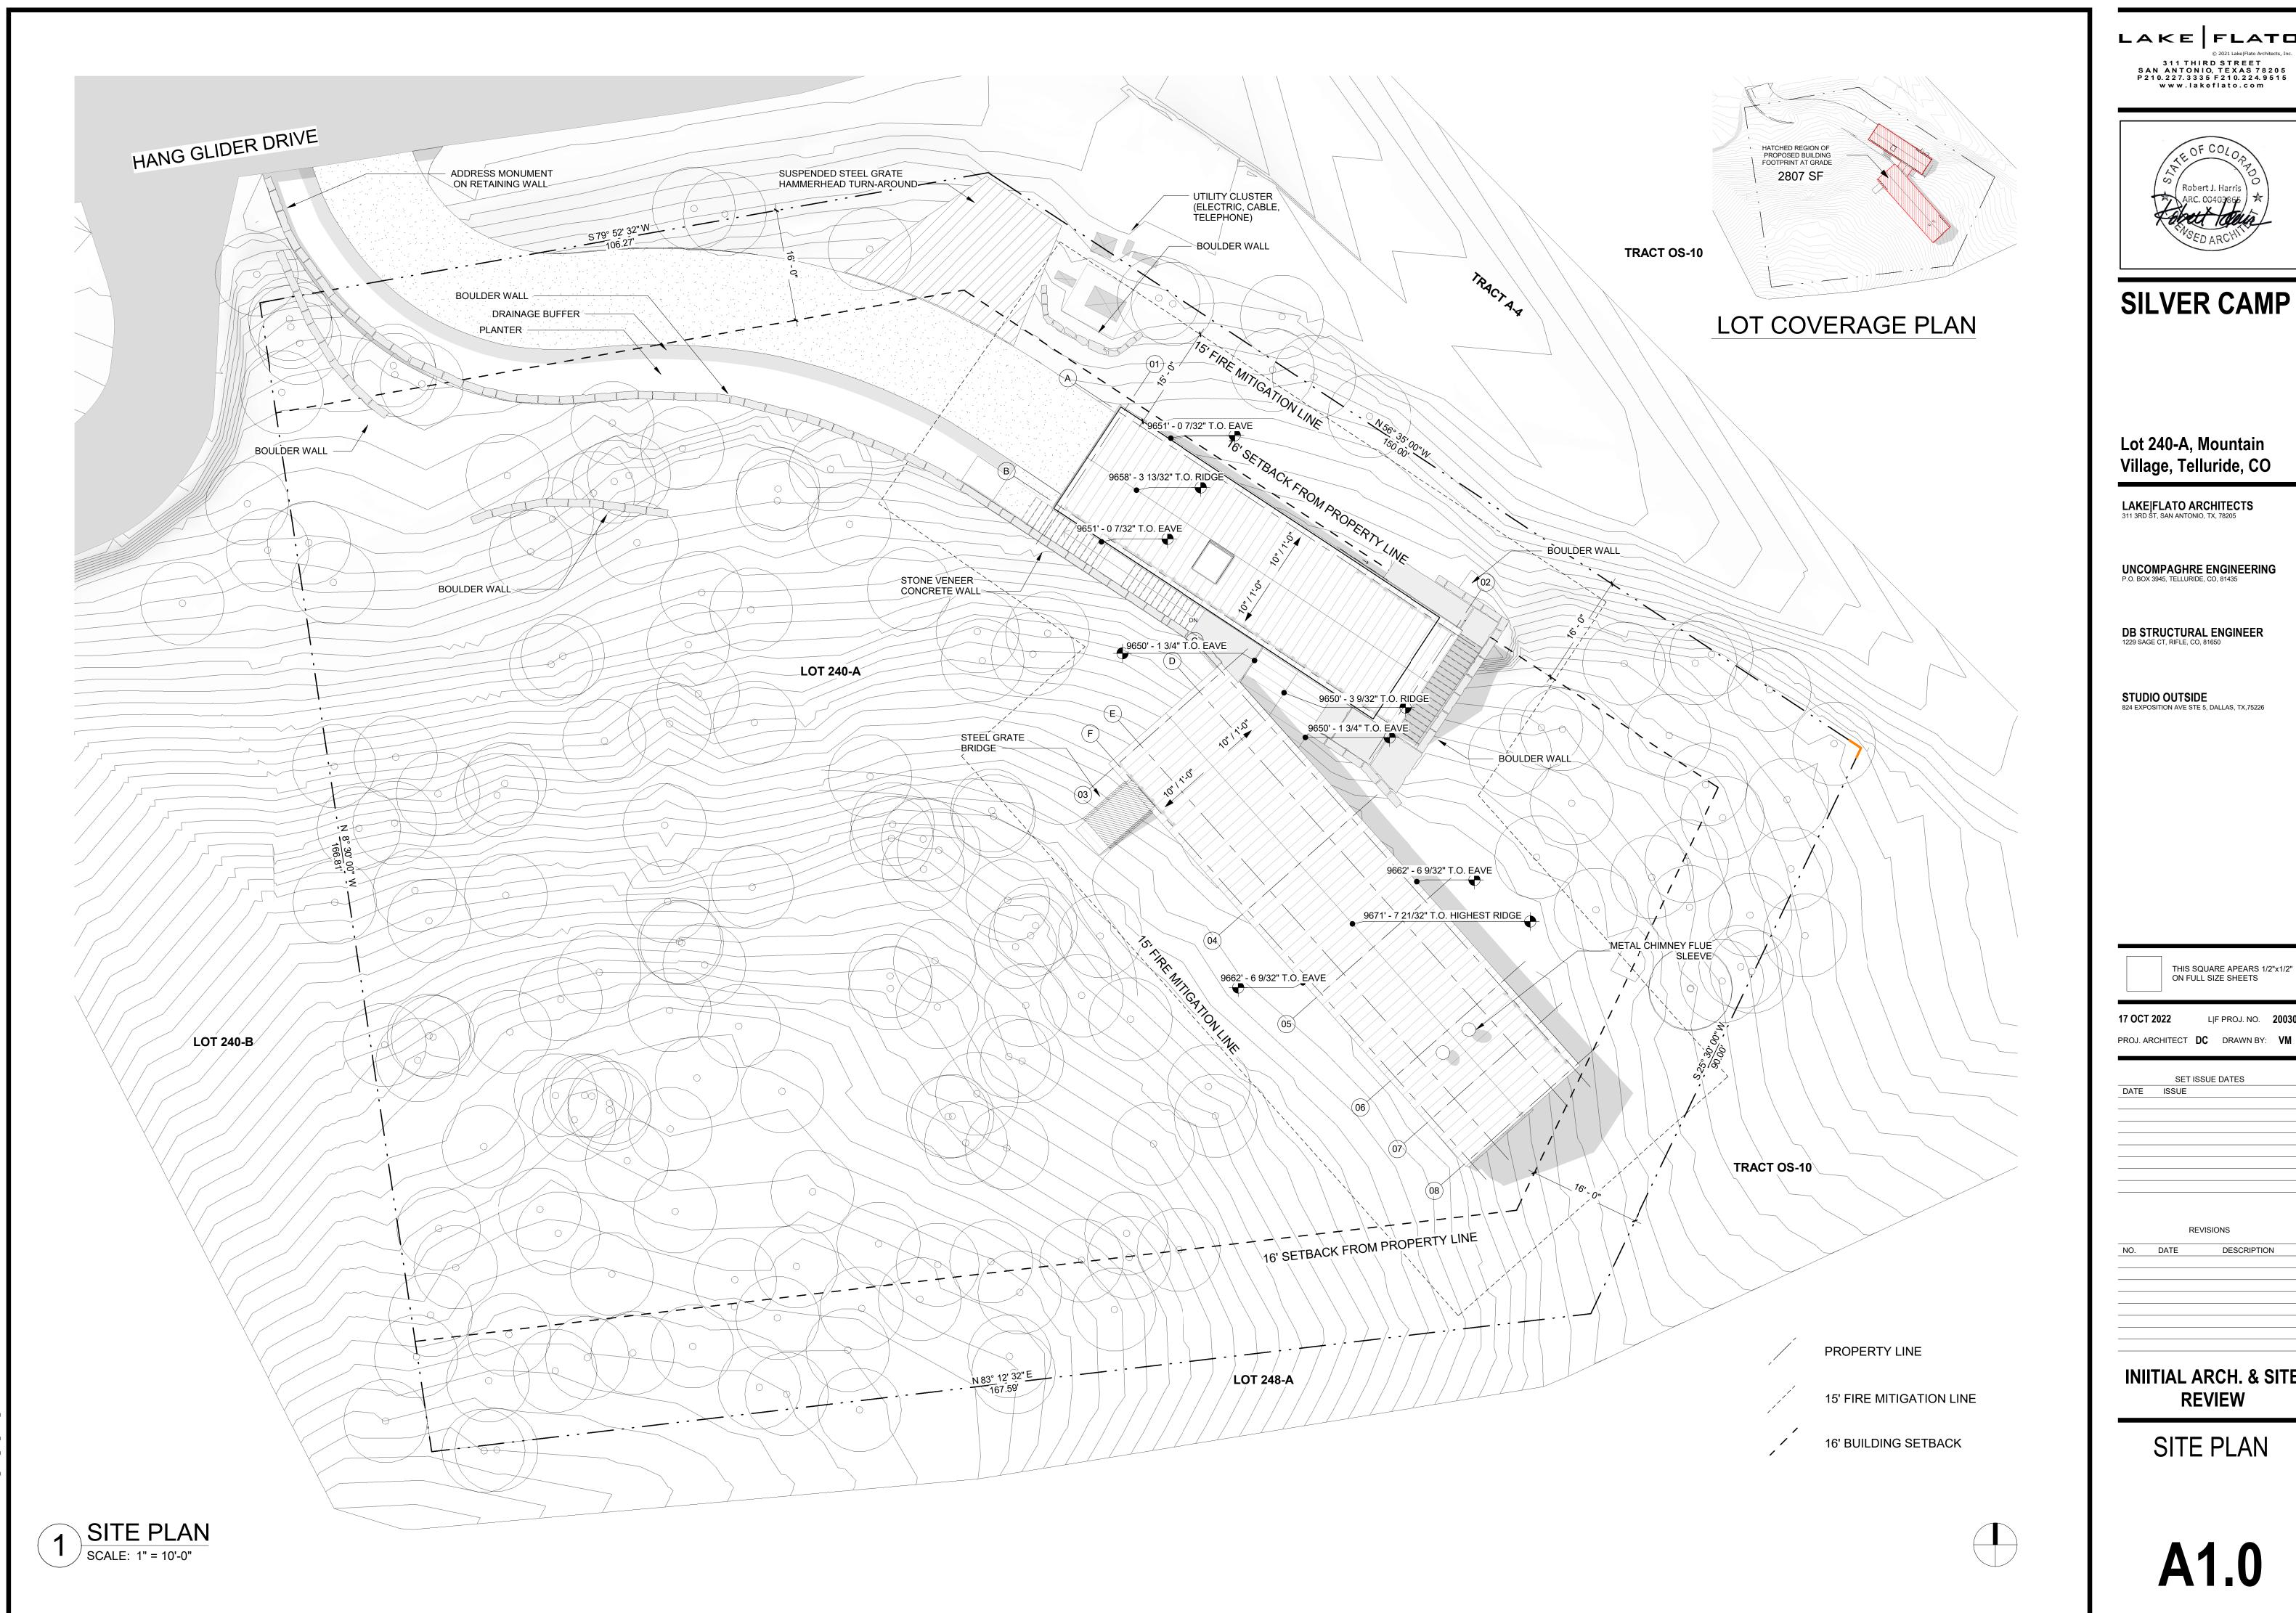

SILVER CAMP

Lot 240-A, Mountain Village, Telluride, CO

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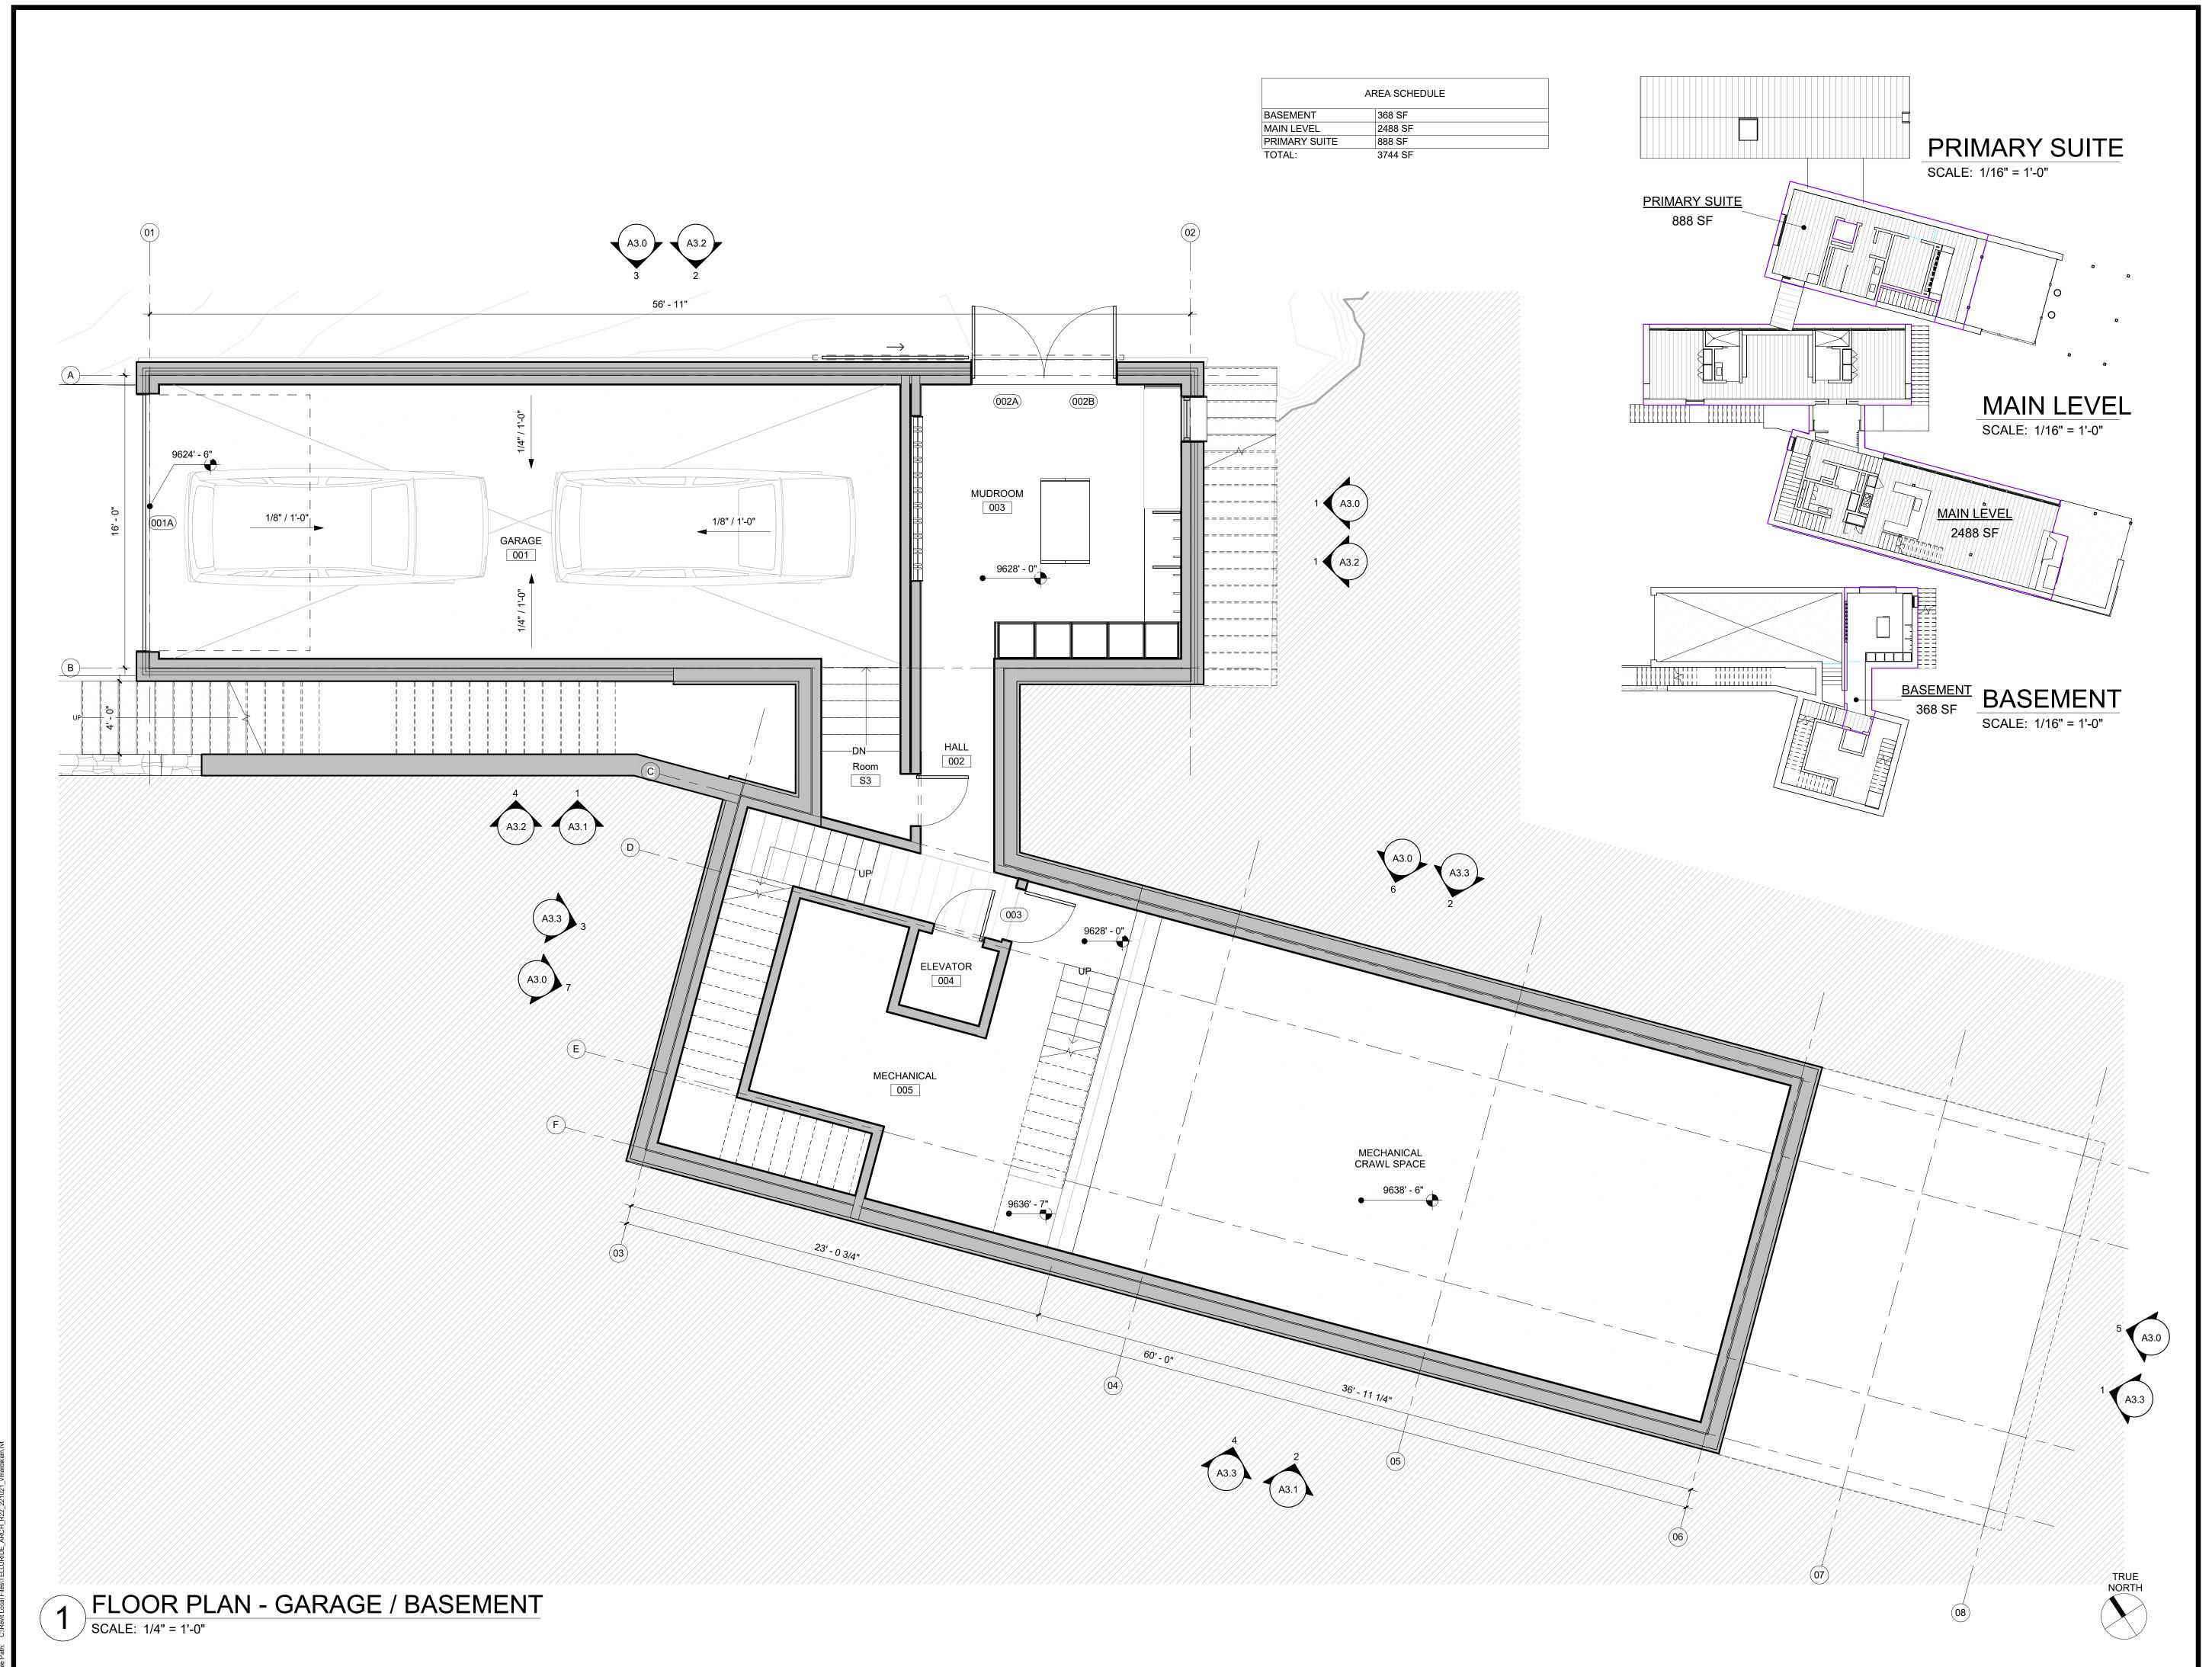
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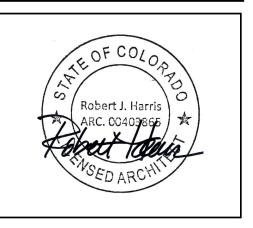
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REVISIONS DESCRIPTION NO. DATE

INIITIAL ARCH. & SITE REVIEW

SITE PLAN





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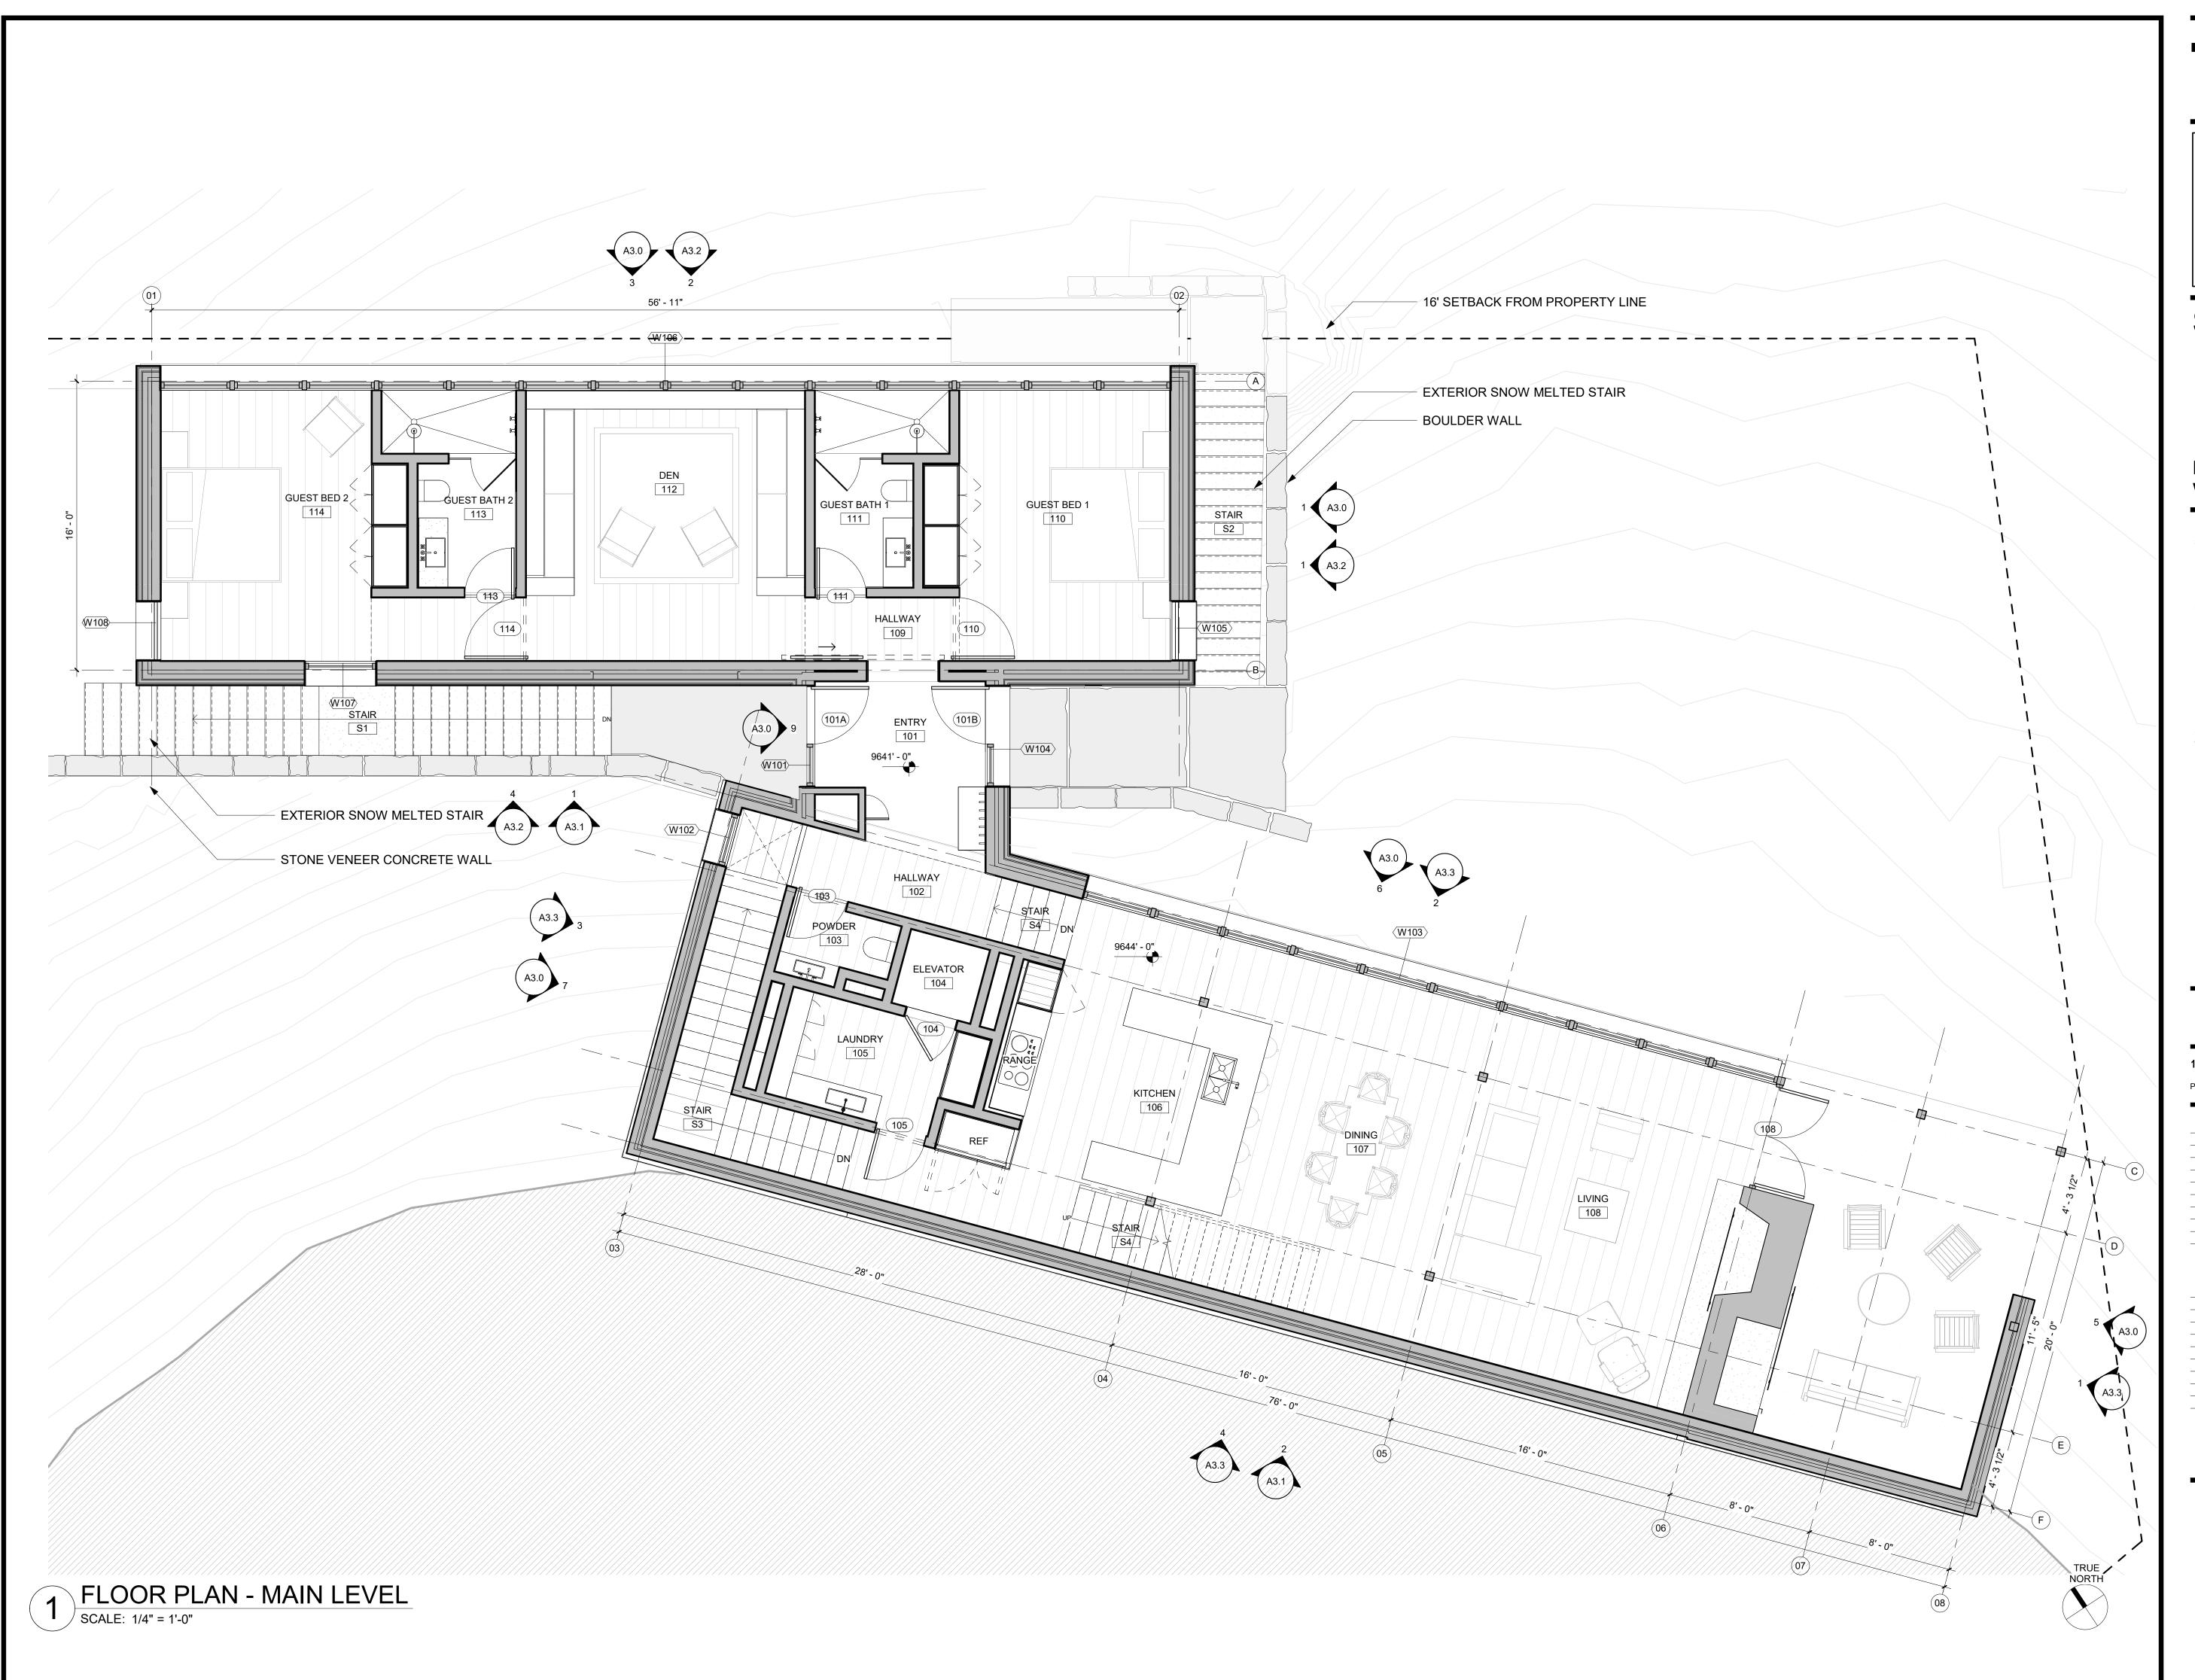
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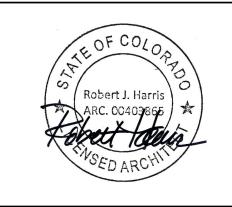
TE DESCRIPTION

INIITIAL ARCH. & SITE REVIEW

FLOOR PLAN -GARAGE /

BASEMENT A 2.0





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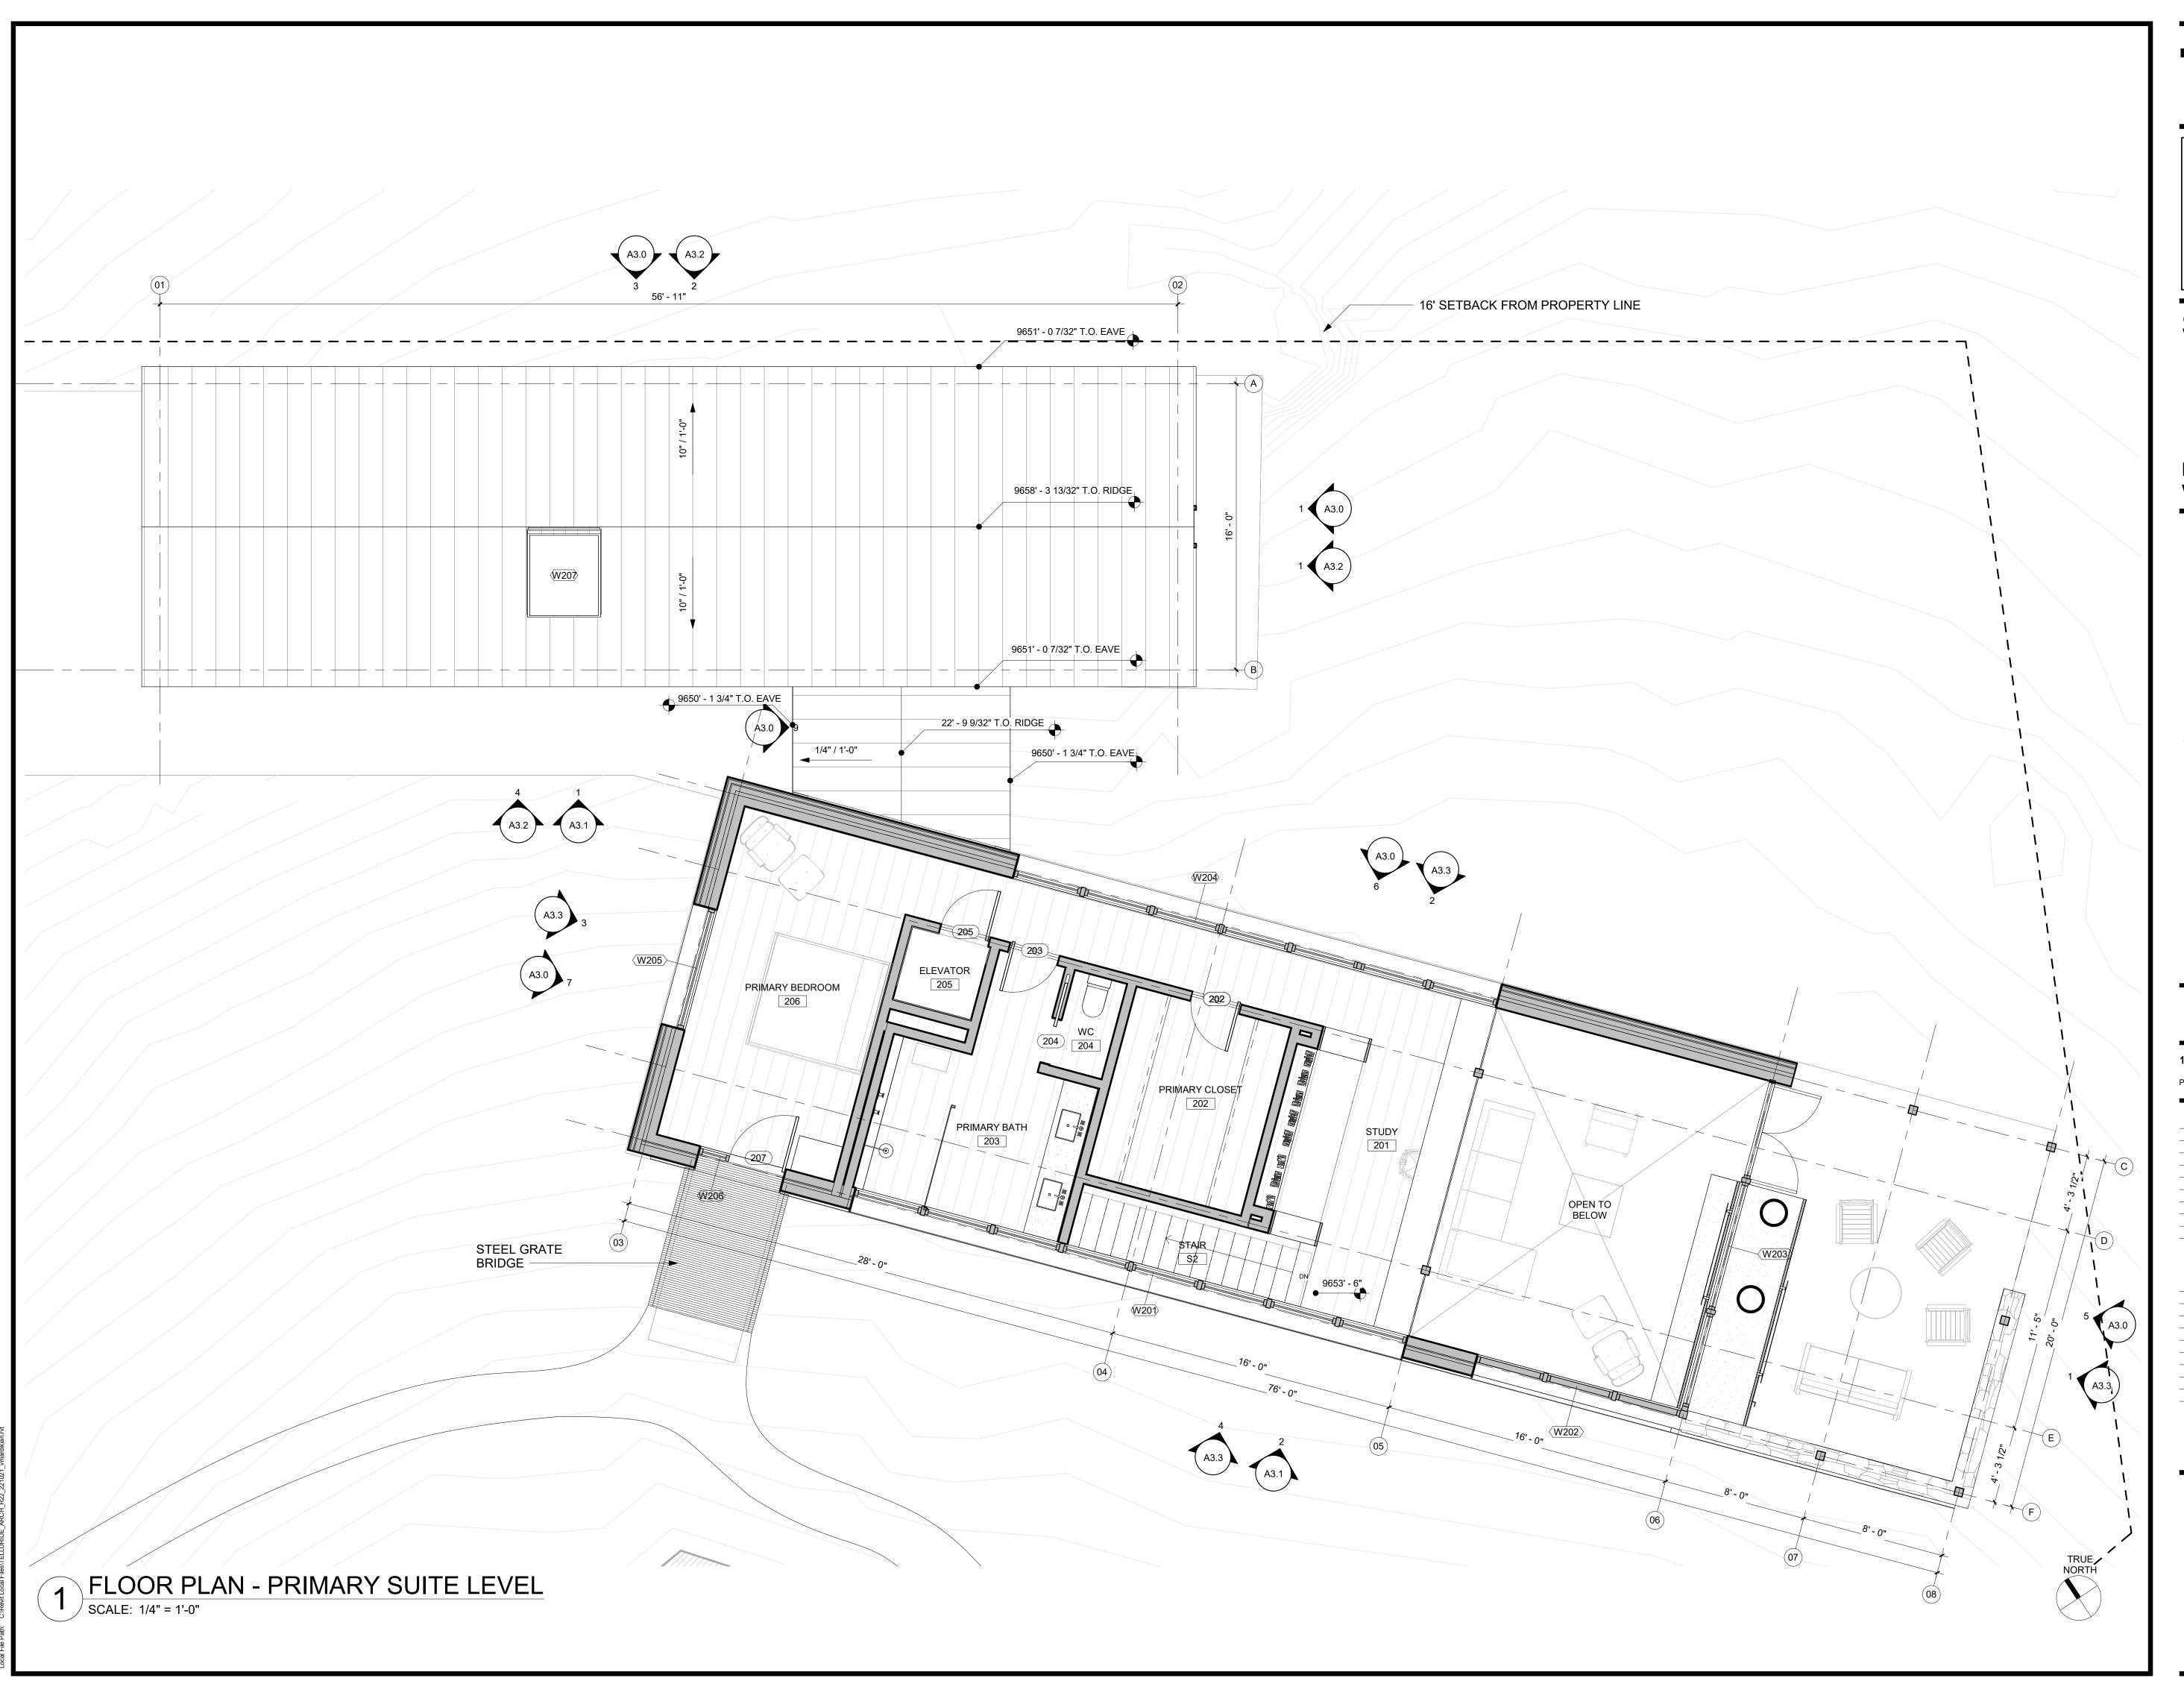
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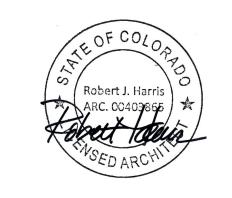
DATE DESCRIPTION

INIITIAL ARCH. & SITE REVIEW

FLOOR PLAN -MAIN LEVEL

A2.1





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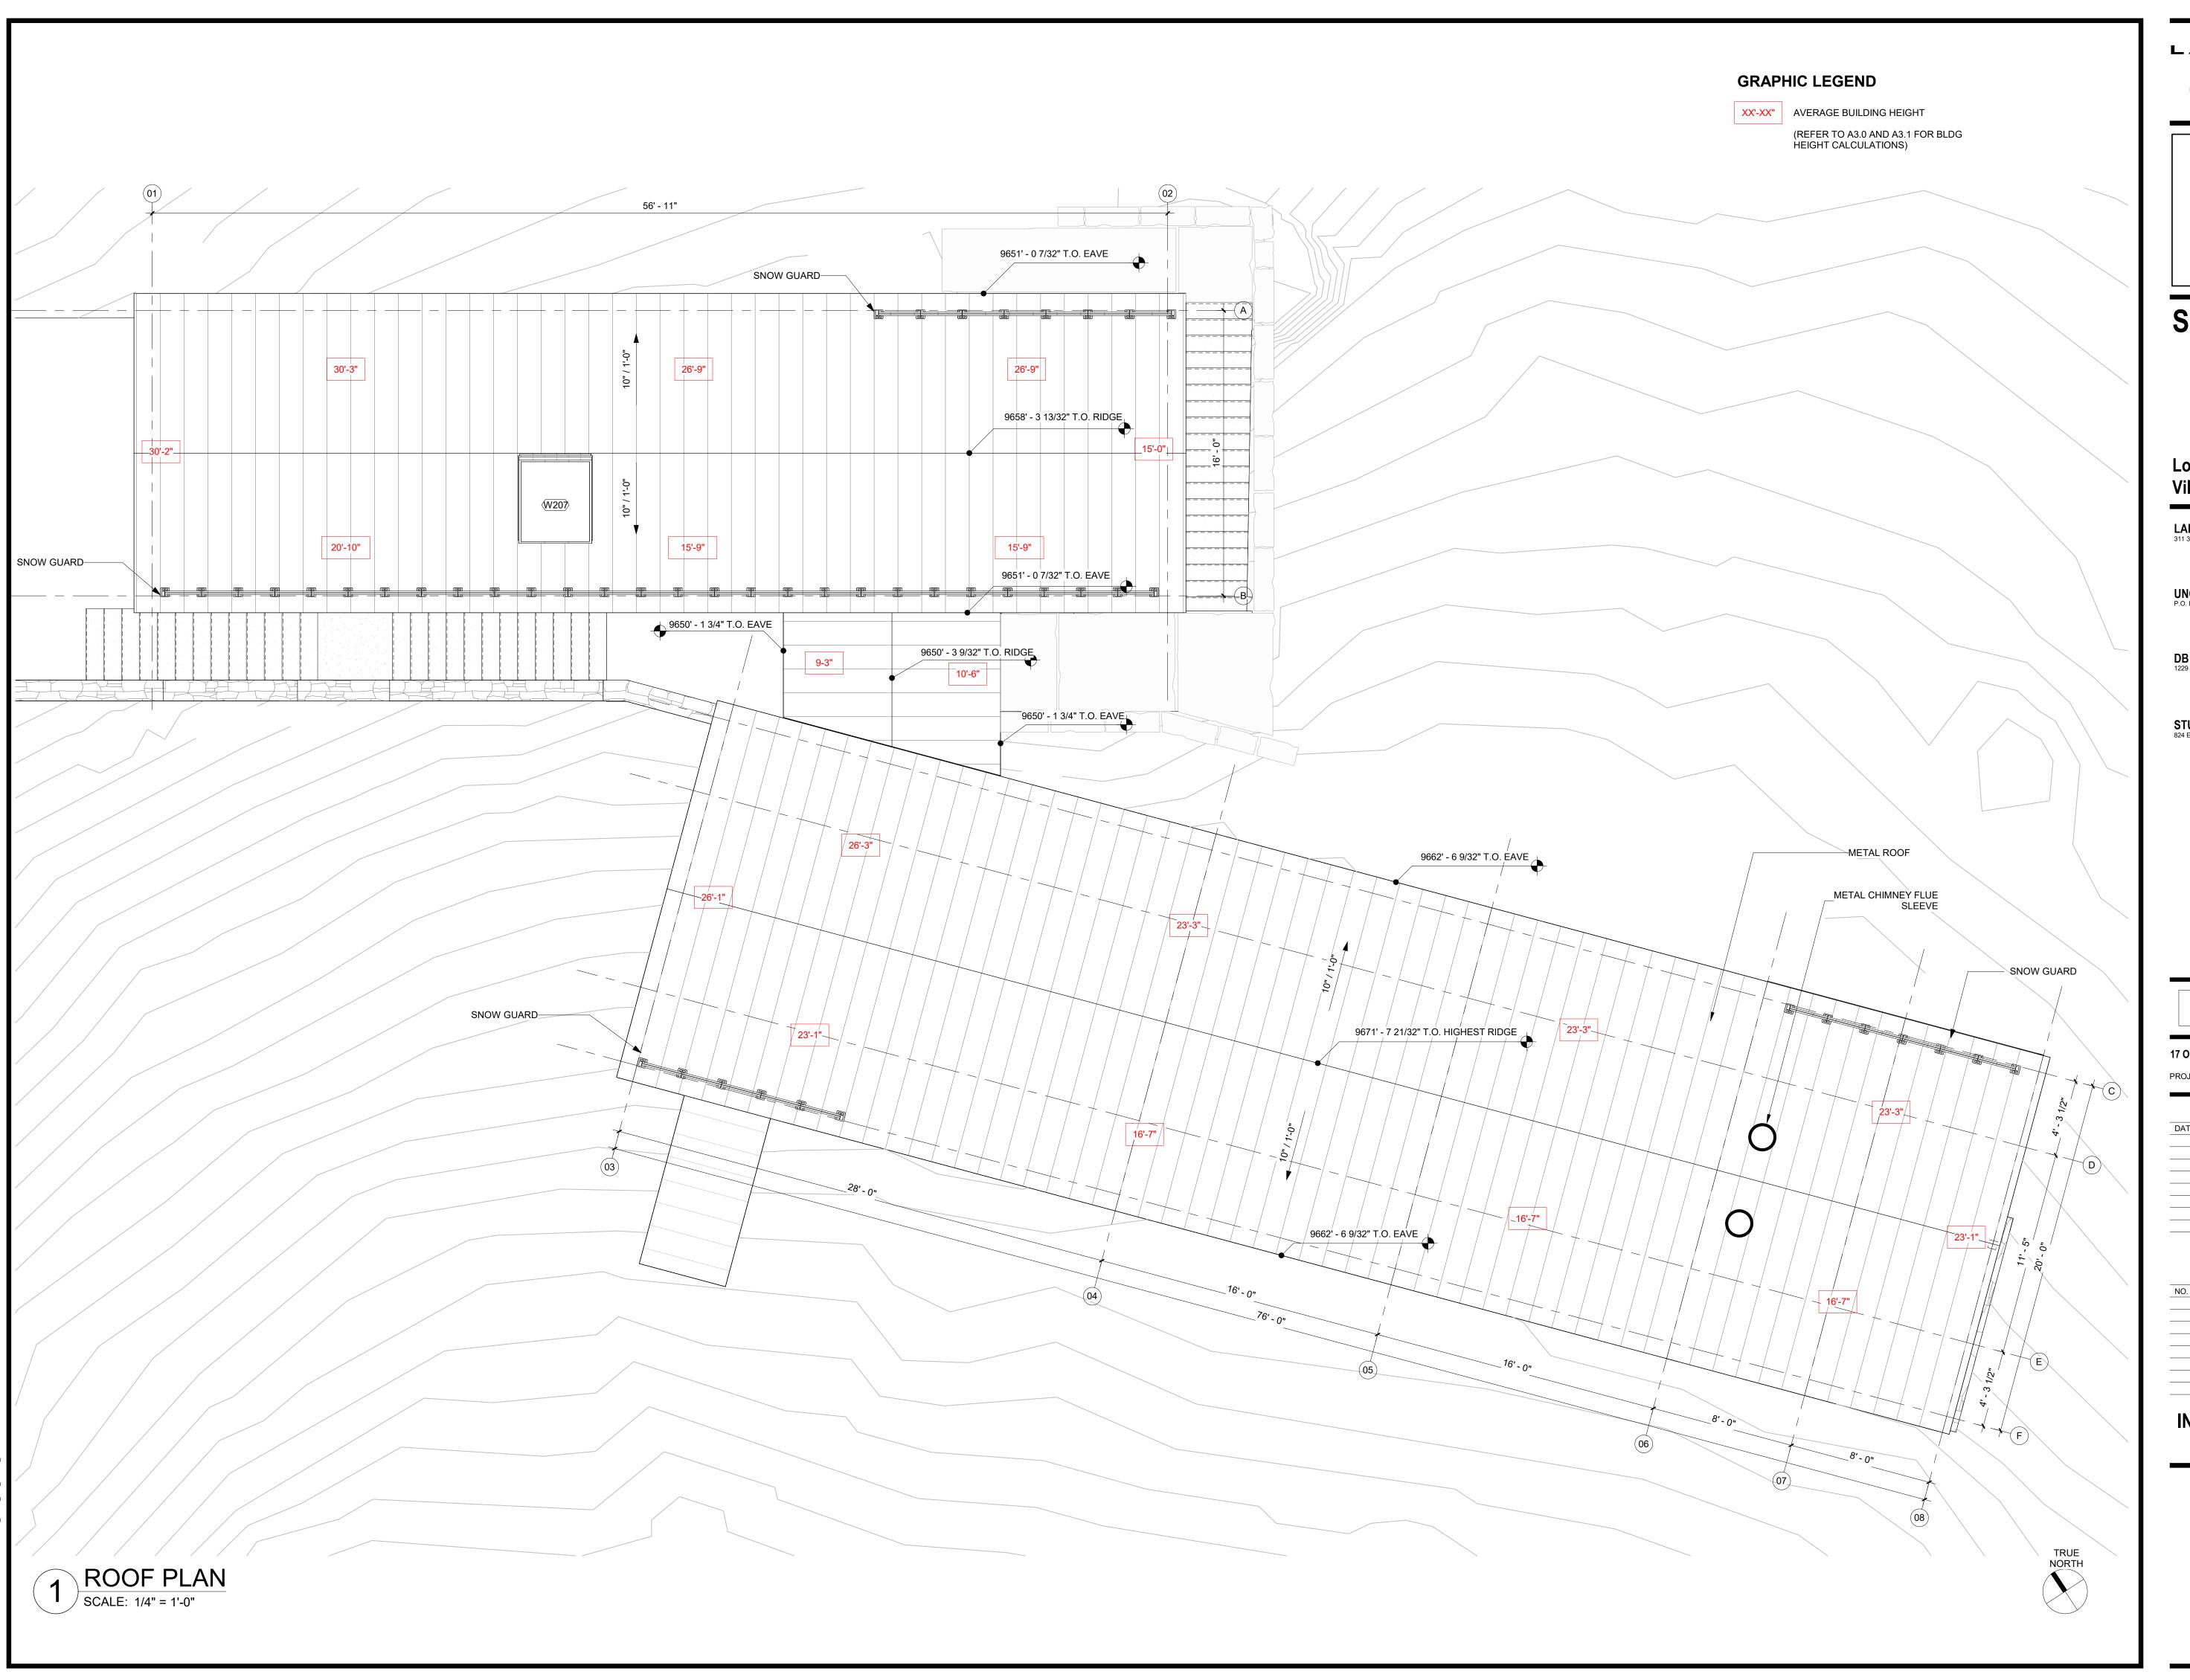
REVISIONS


DATE DESCRIPTION

INIITIAL ARCH. & SITE REVIEW

FLOOR PLAN -PRIMARY SUITE LEVEL

A2.2



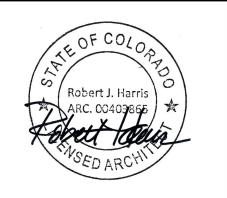

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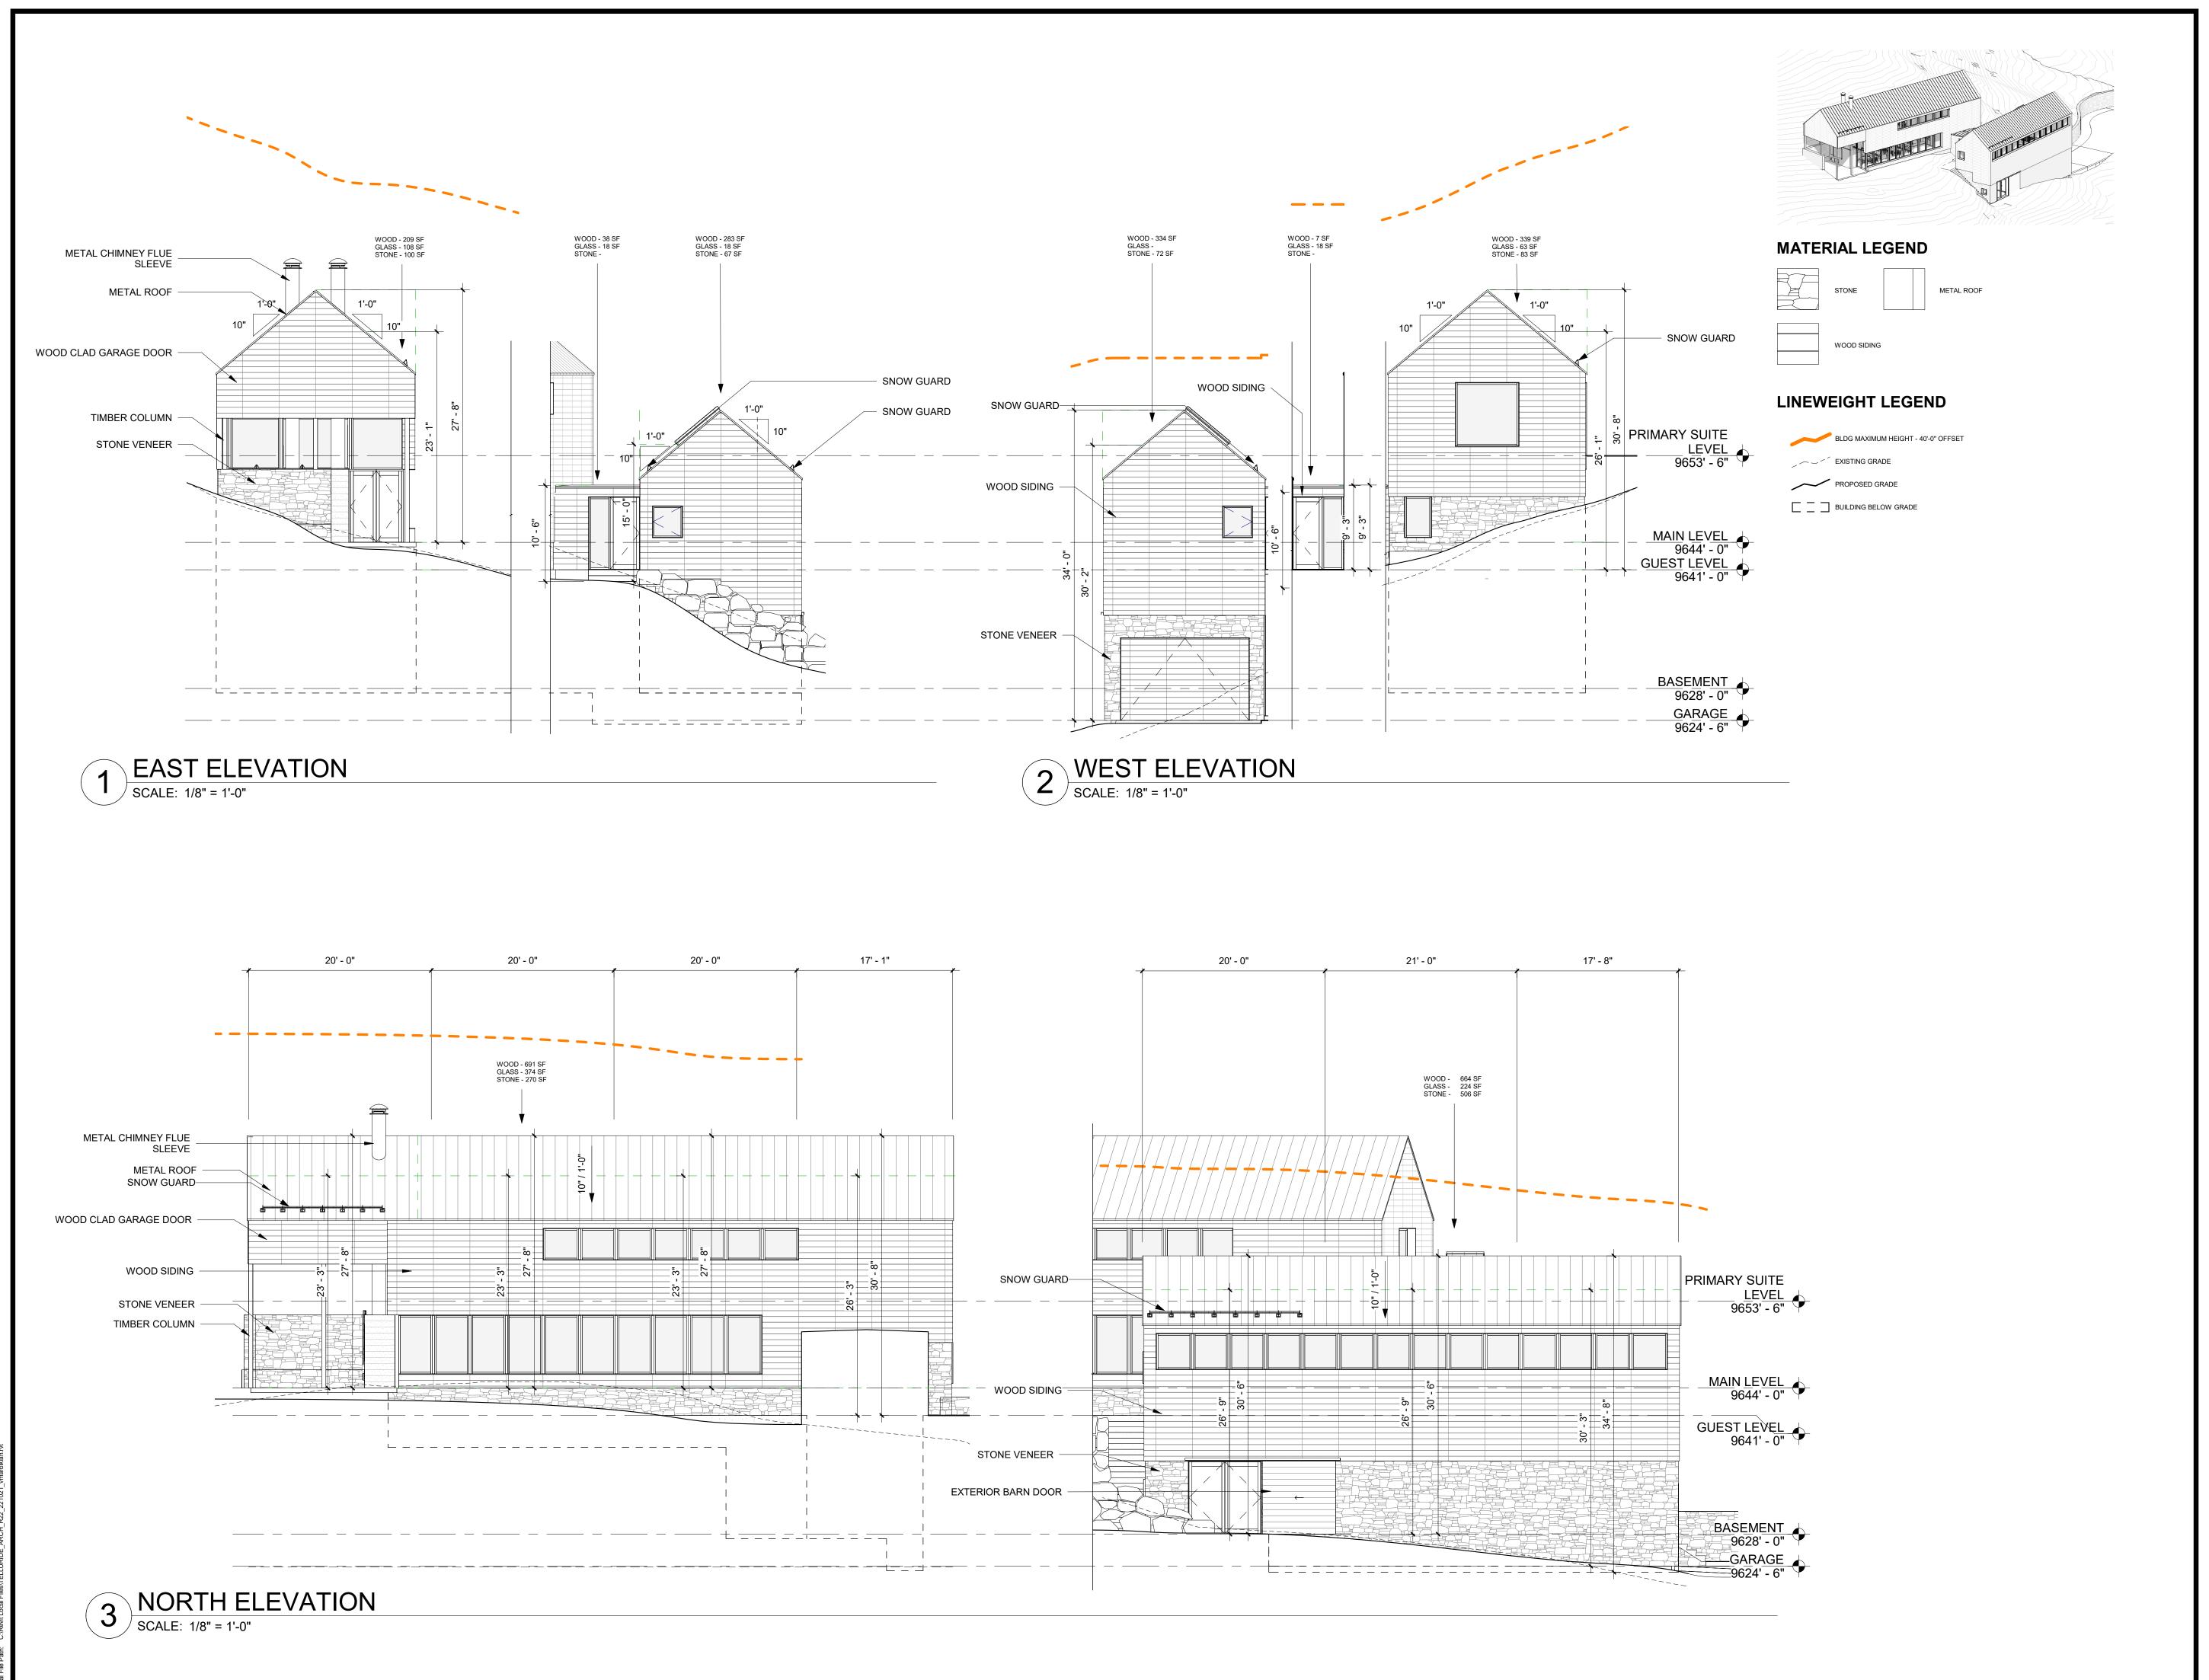
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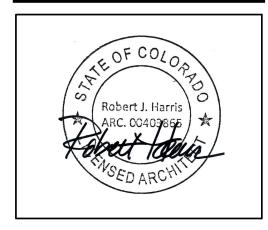
NO. DATE DESCRIPTION

INIITIAL ARCH. & SITE REVIEW

ROOF PLAN

A2.3





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7 OCT 2022 L|F PROJ. NO. 2003

PROJ. ARCHITECT DC DRAWN BY: VM


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DATE ISSUE


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INIITIAL ARCH. & SITE REVIEW


HEIGHT & EXT MATERIAL COMPLIANCE



MATERIAL LEGEND

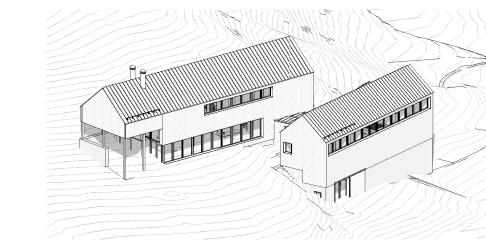

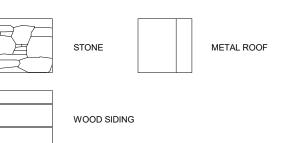LINEWEIGHT LEGEND

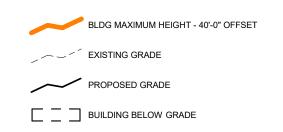

MATERIAL CALCULATIONS

EXTERIOR WALL MATERIAL TOTAL SQUARE FOOTAGE

TOTAL SQ. FT. OF STONE:	2436
TOTAL SQ. FT. OF WOOD:	3537
TOTAL SQ. FT. OF FENESTRATION:	1053

23' + 16'-6" + 16'-6" + 16'-6" +23' + 23' + 23'-2" +23'-2" +26'-2" + 10'-6"+ 15'-0" + 26'-8" + 26'-8" + 30'-2" + 30'-1" + 20'-10" + 15'-8" + 15'-8"

(383'-3" / 18 = 21'-3"

AVERAGE HEIGHT - 21'-3"

LAKE FLATO

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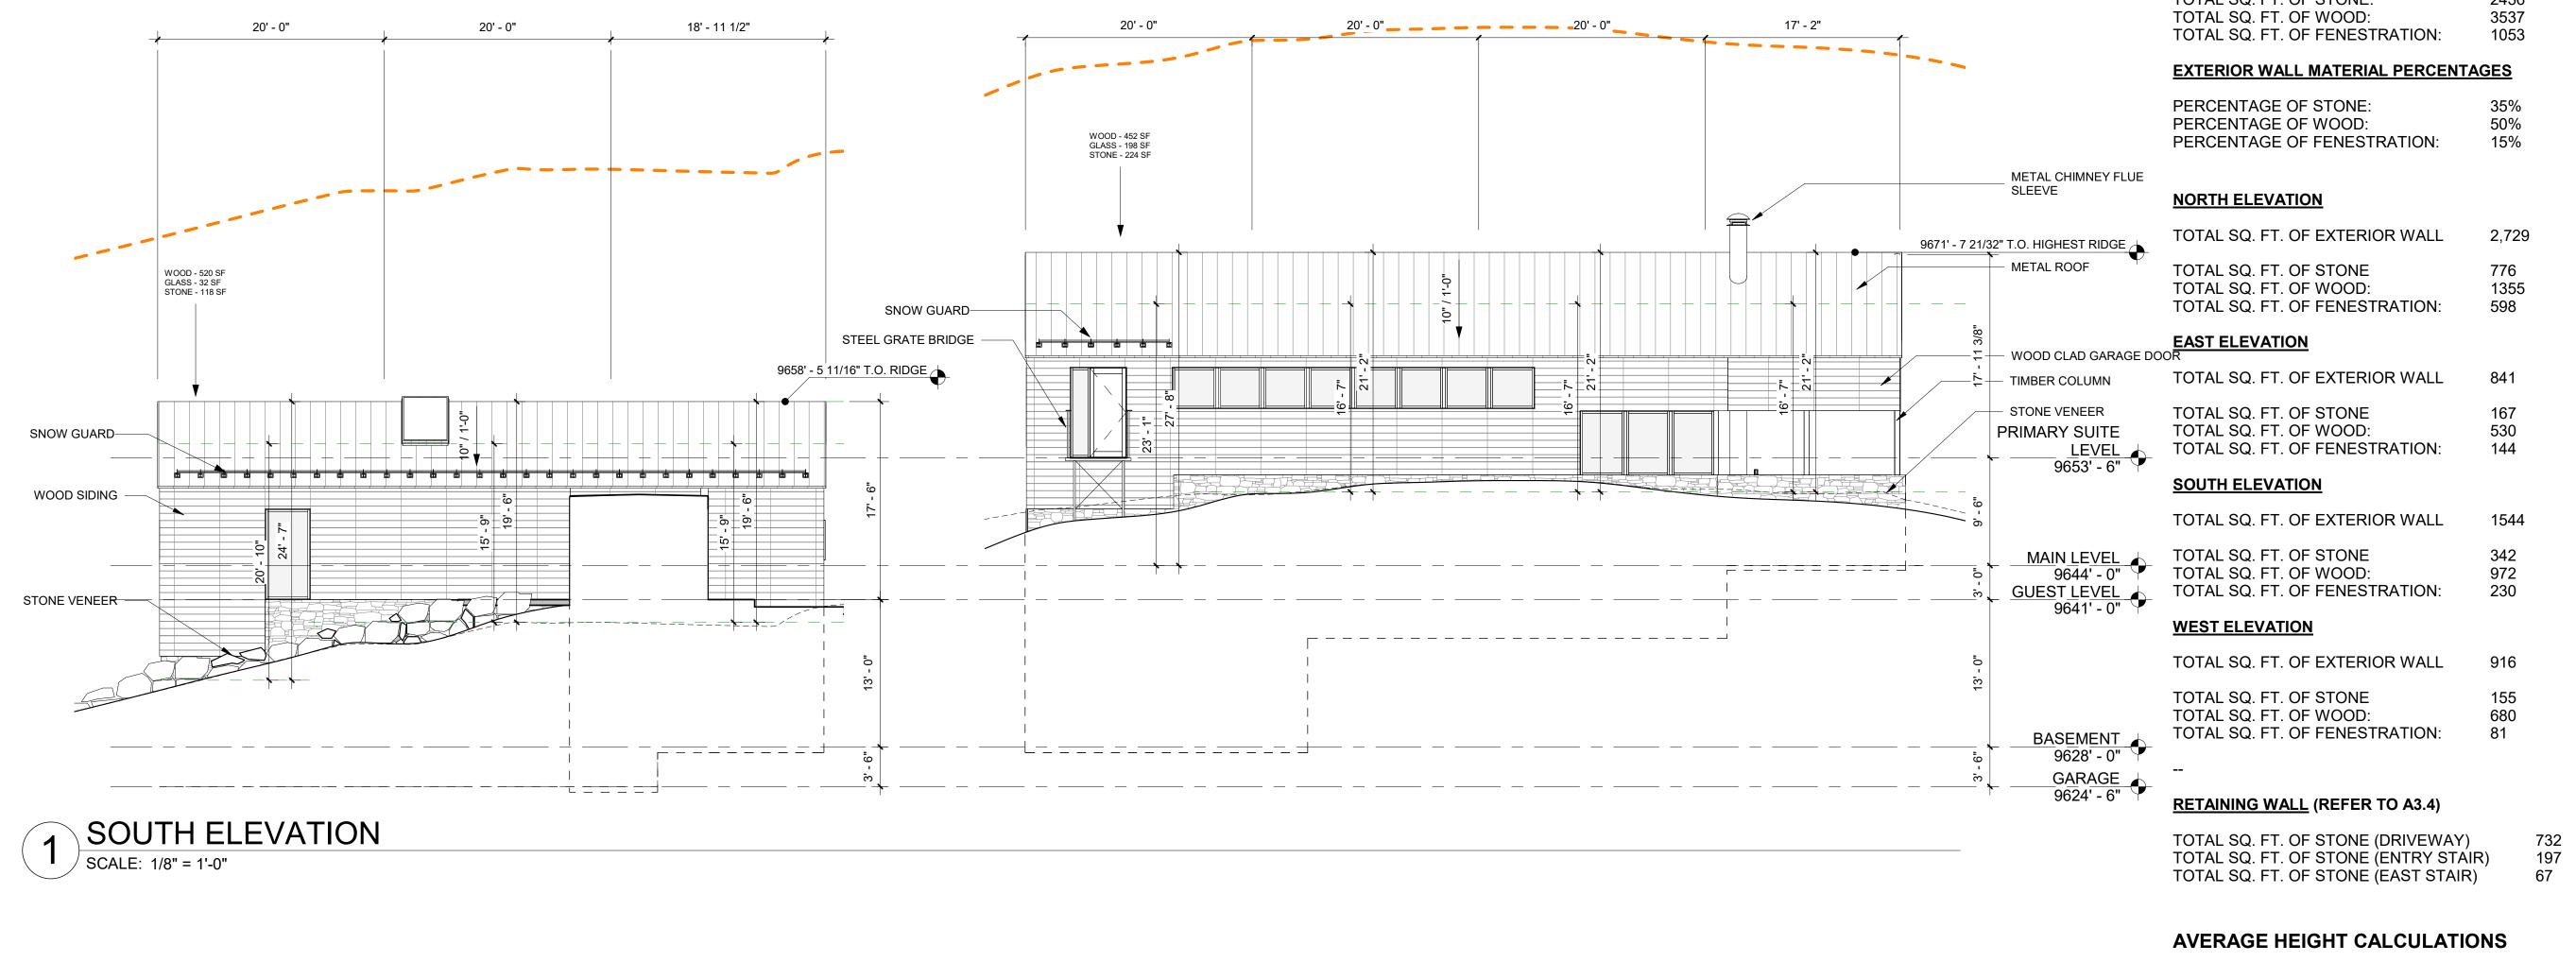
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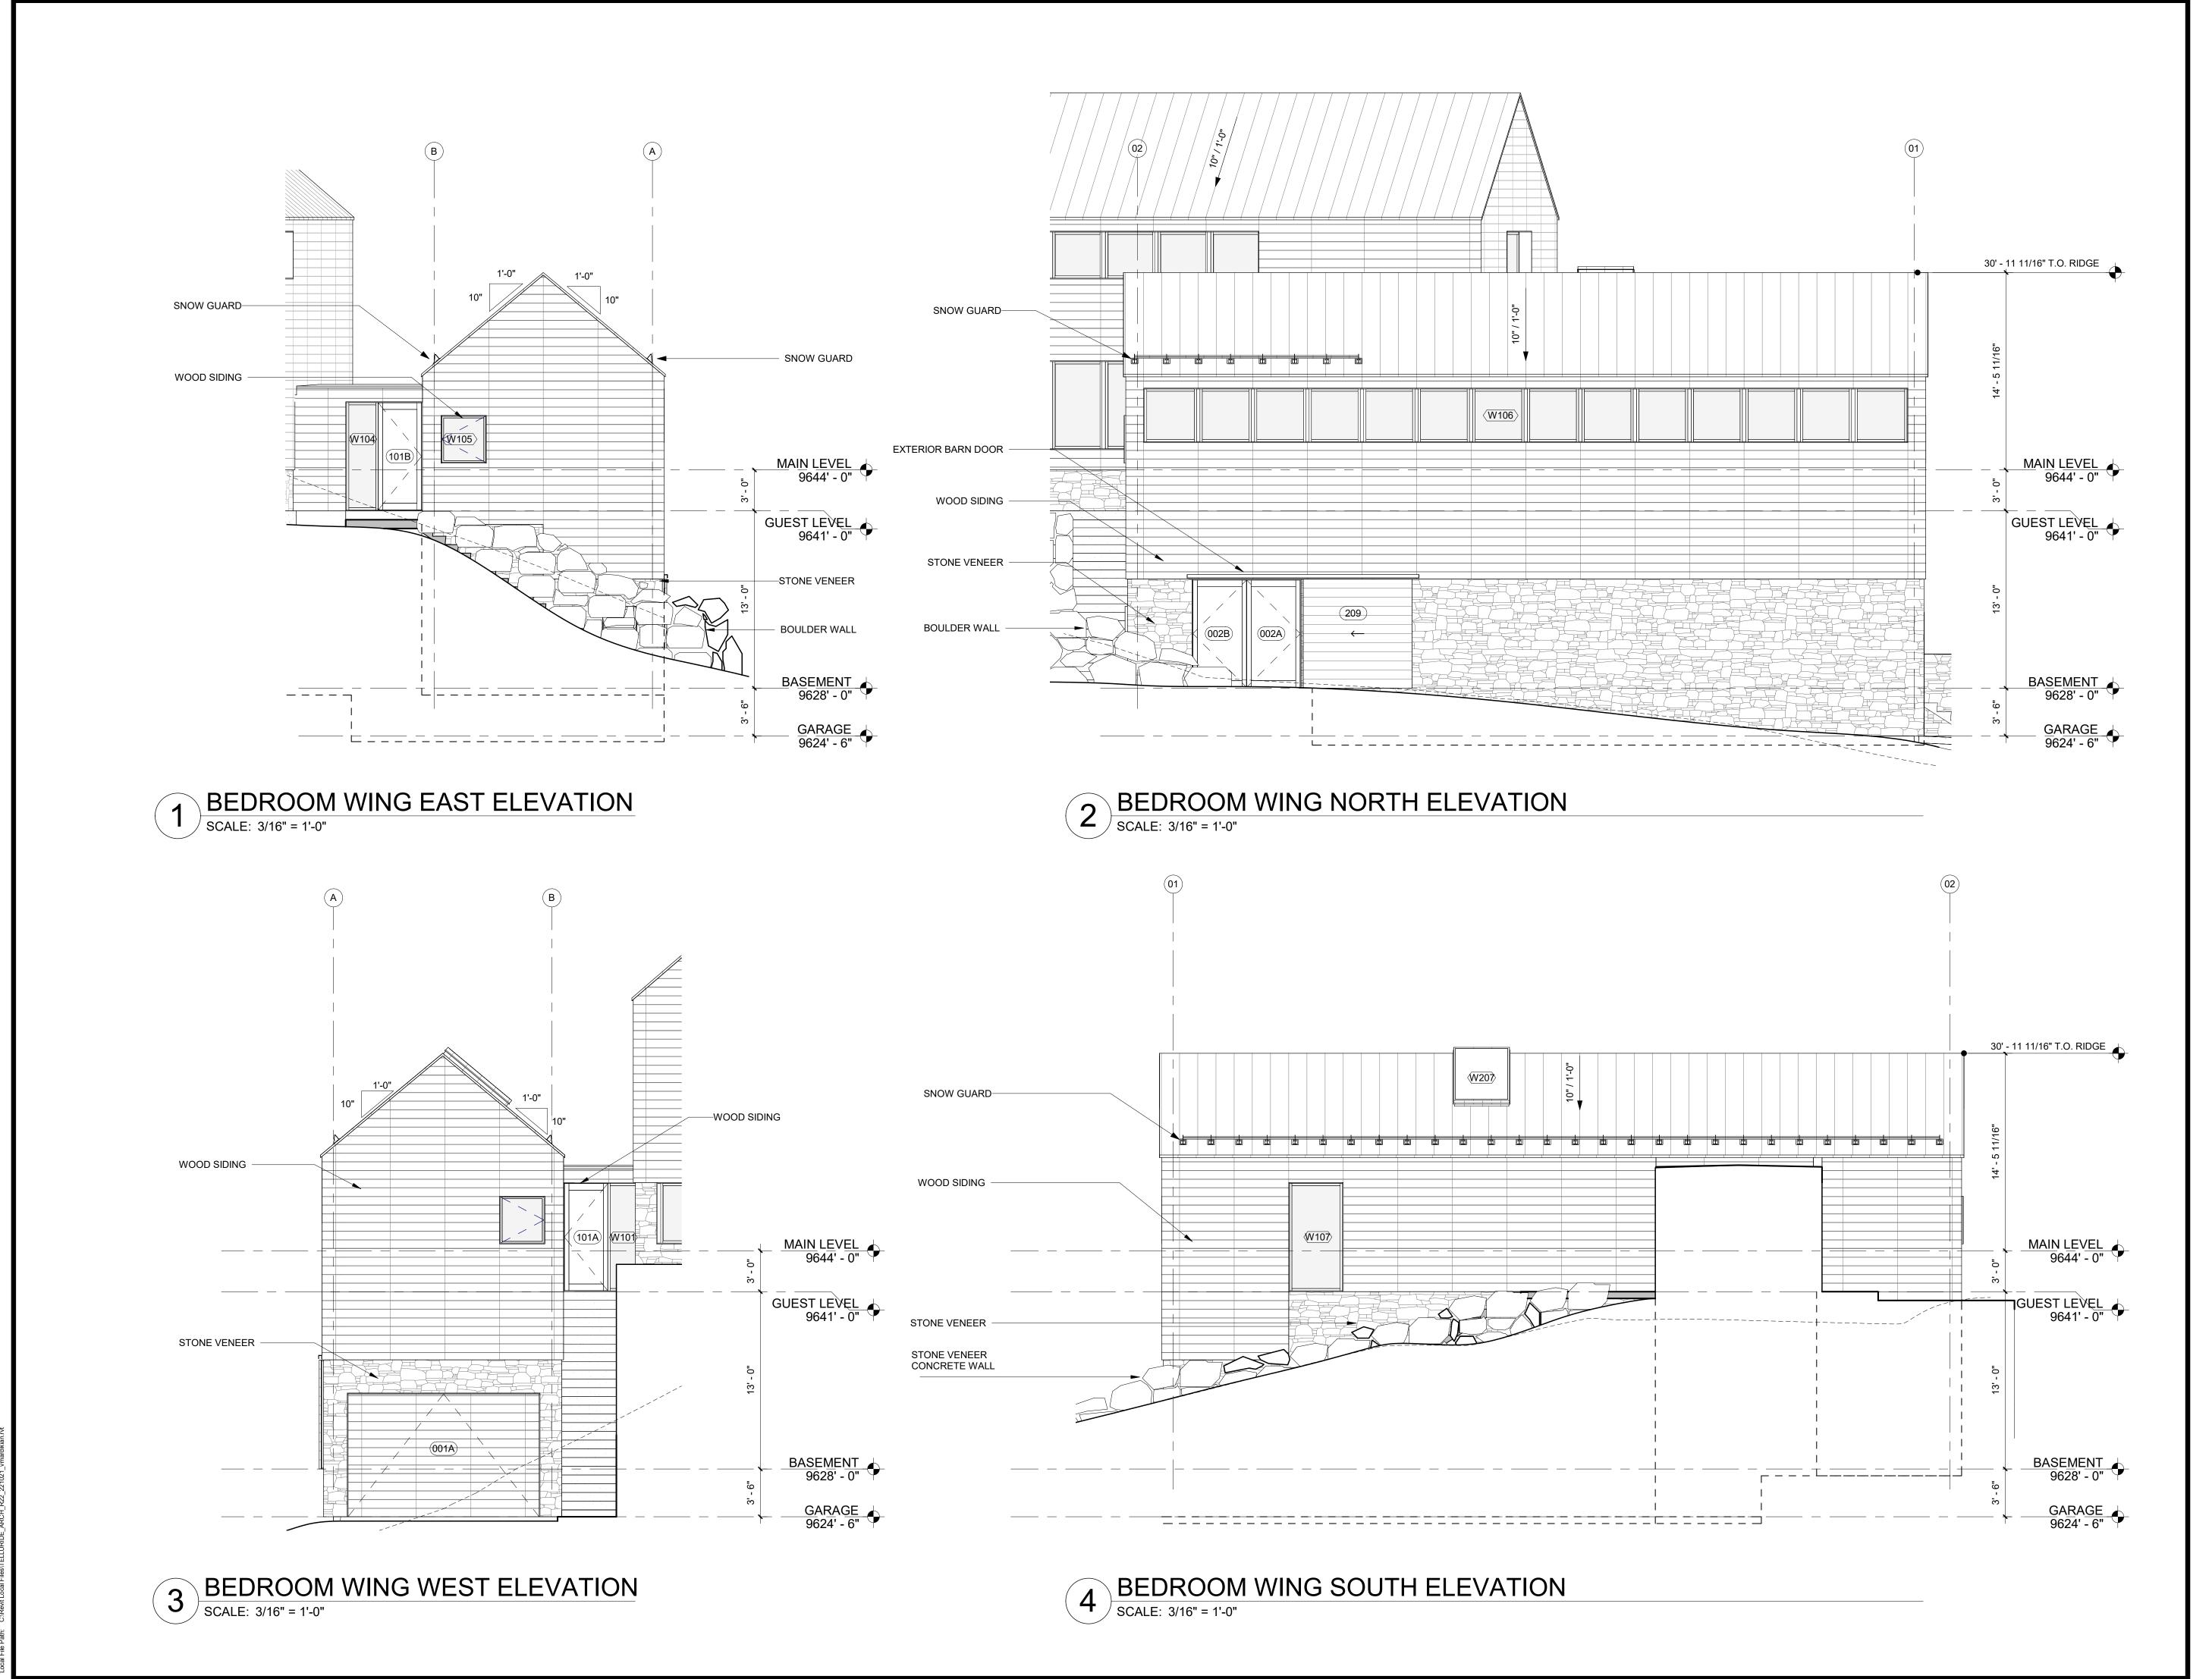
REVISIONS


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INIITIAL ARCH. & SITE REVIEW

HEIGHT & EXT MATERIAL COMPLIANCE





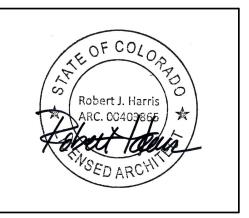

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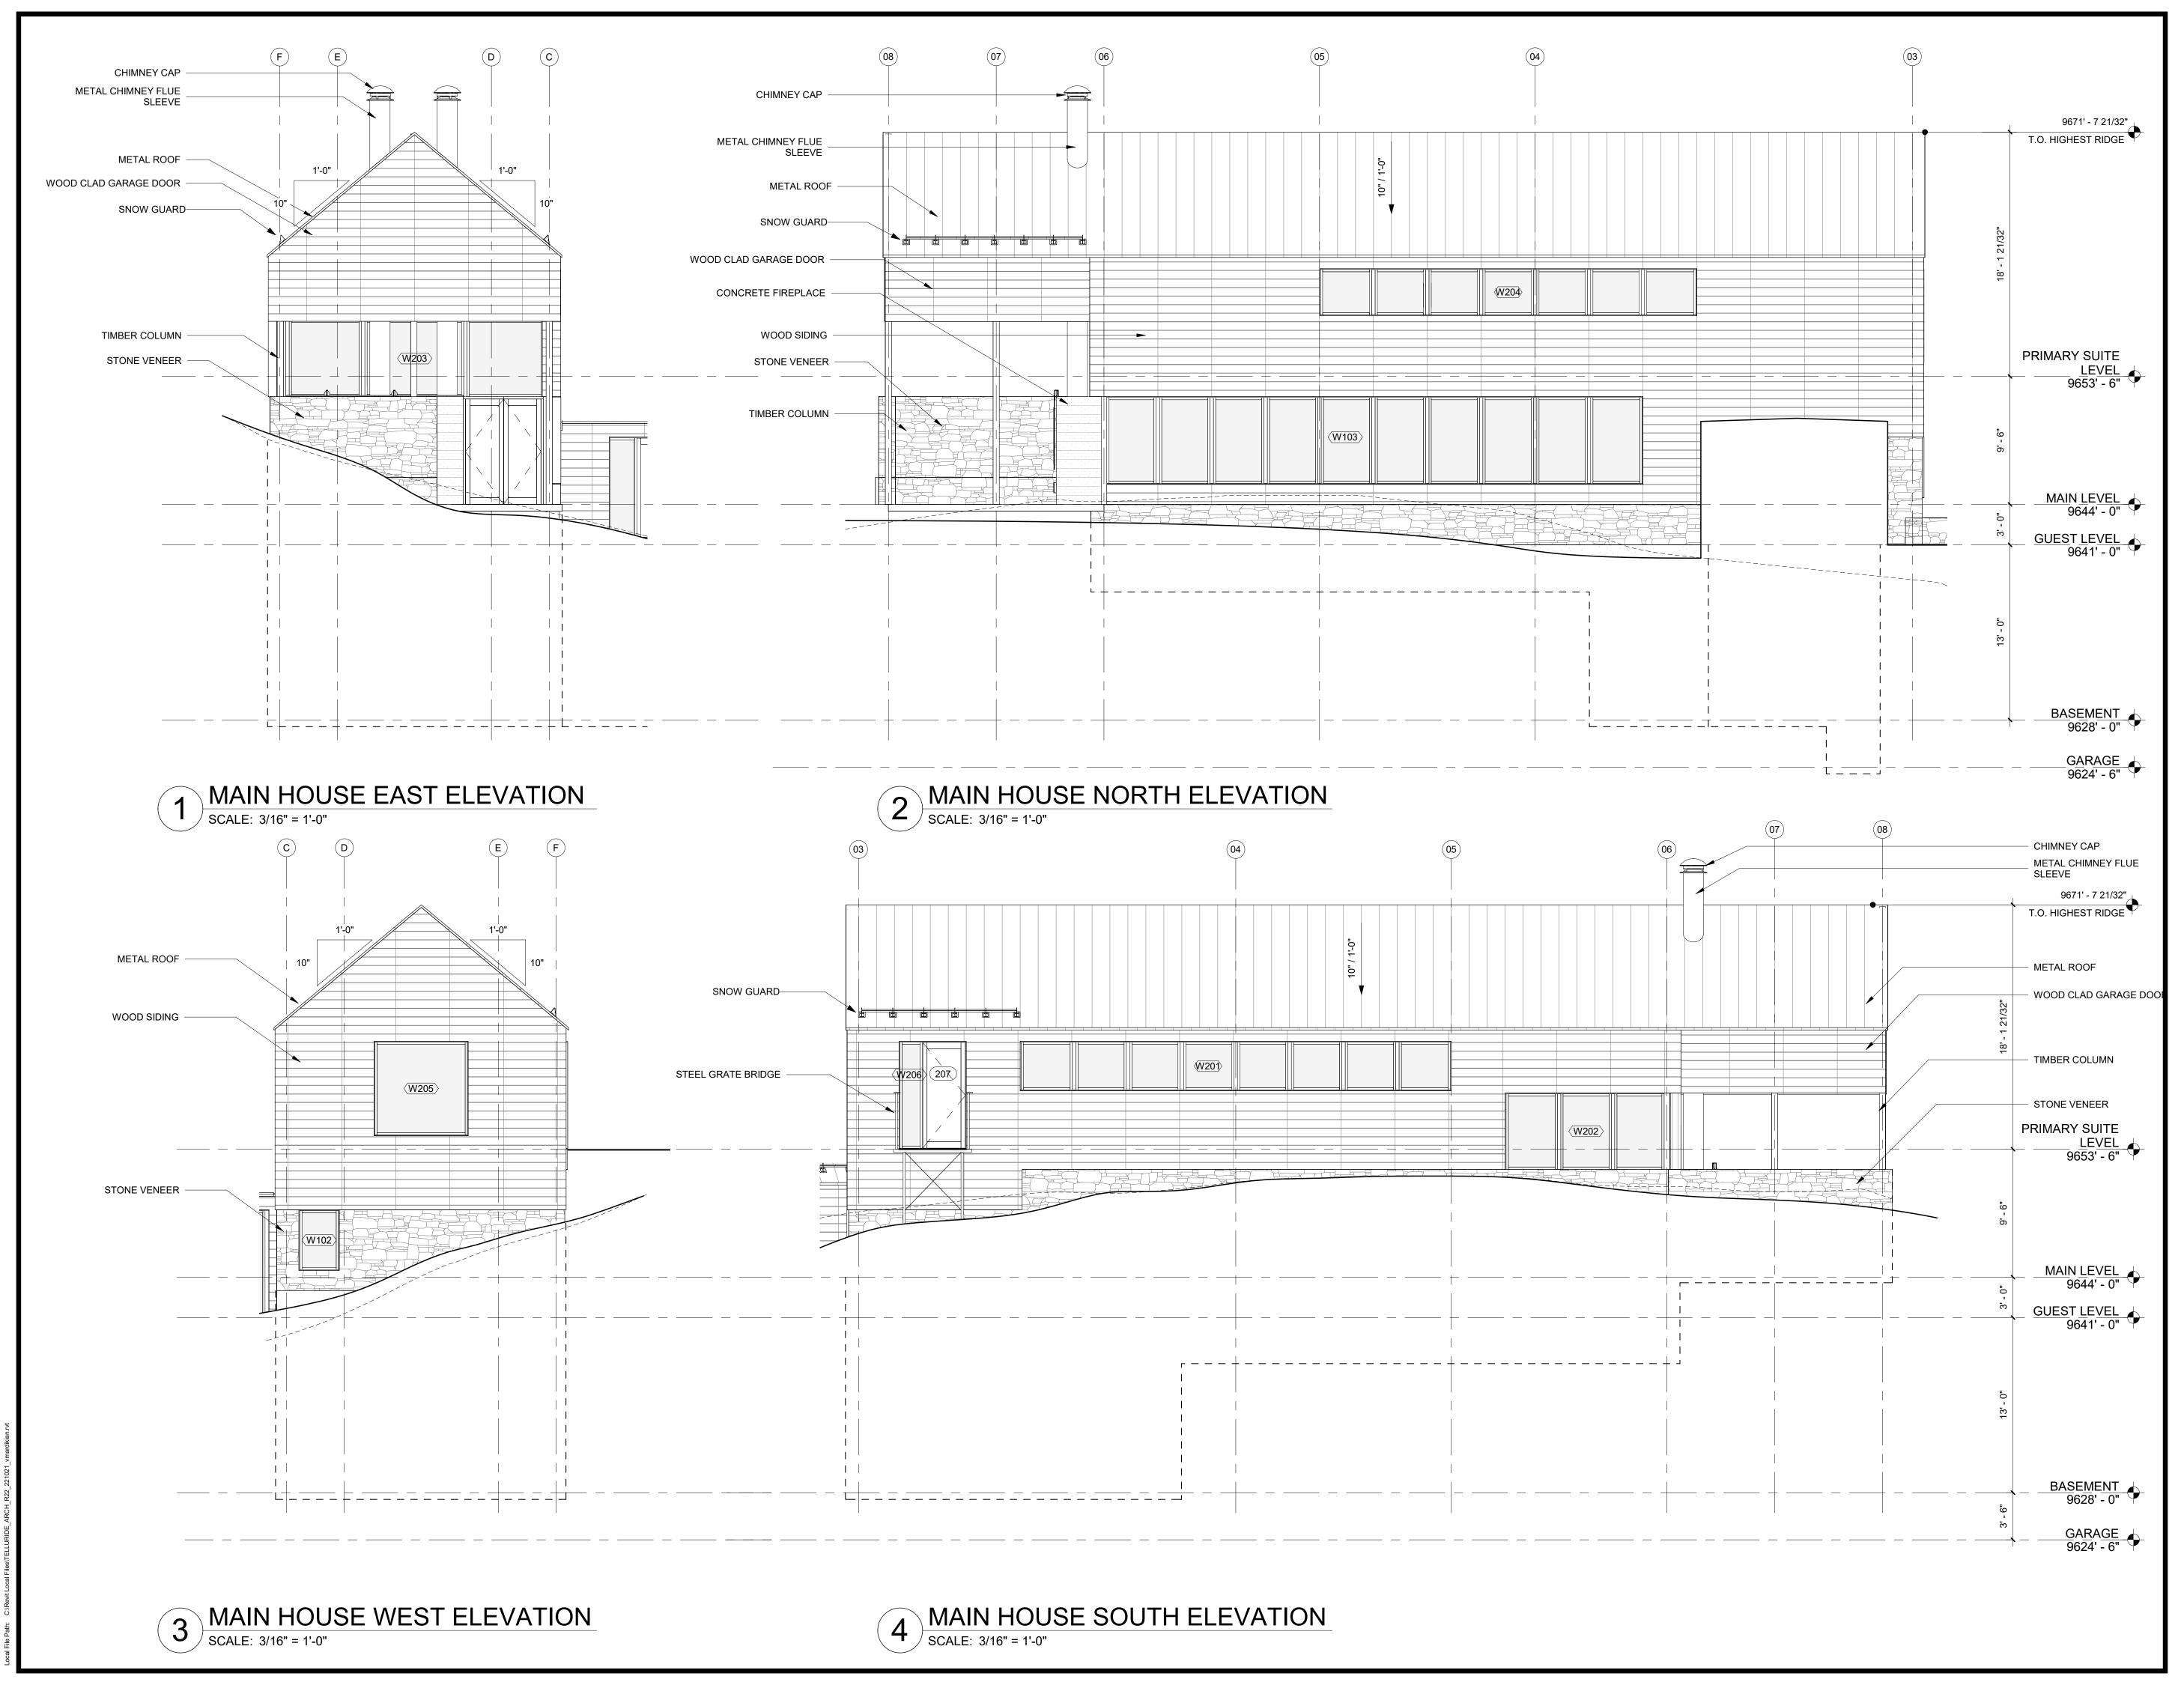
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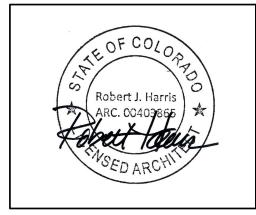
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INIITIAL ARCH. & SITE REVIEW

EXTERIOR ELEVATIONS





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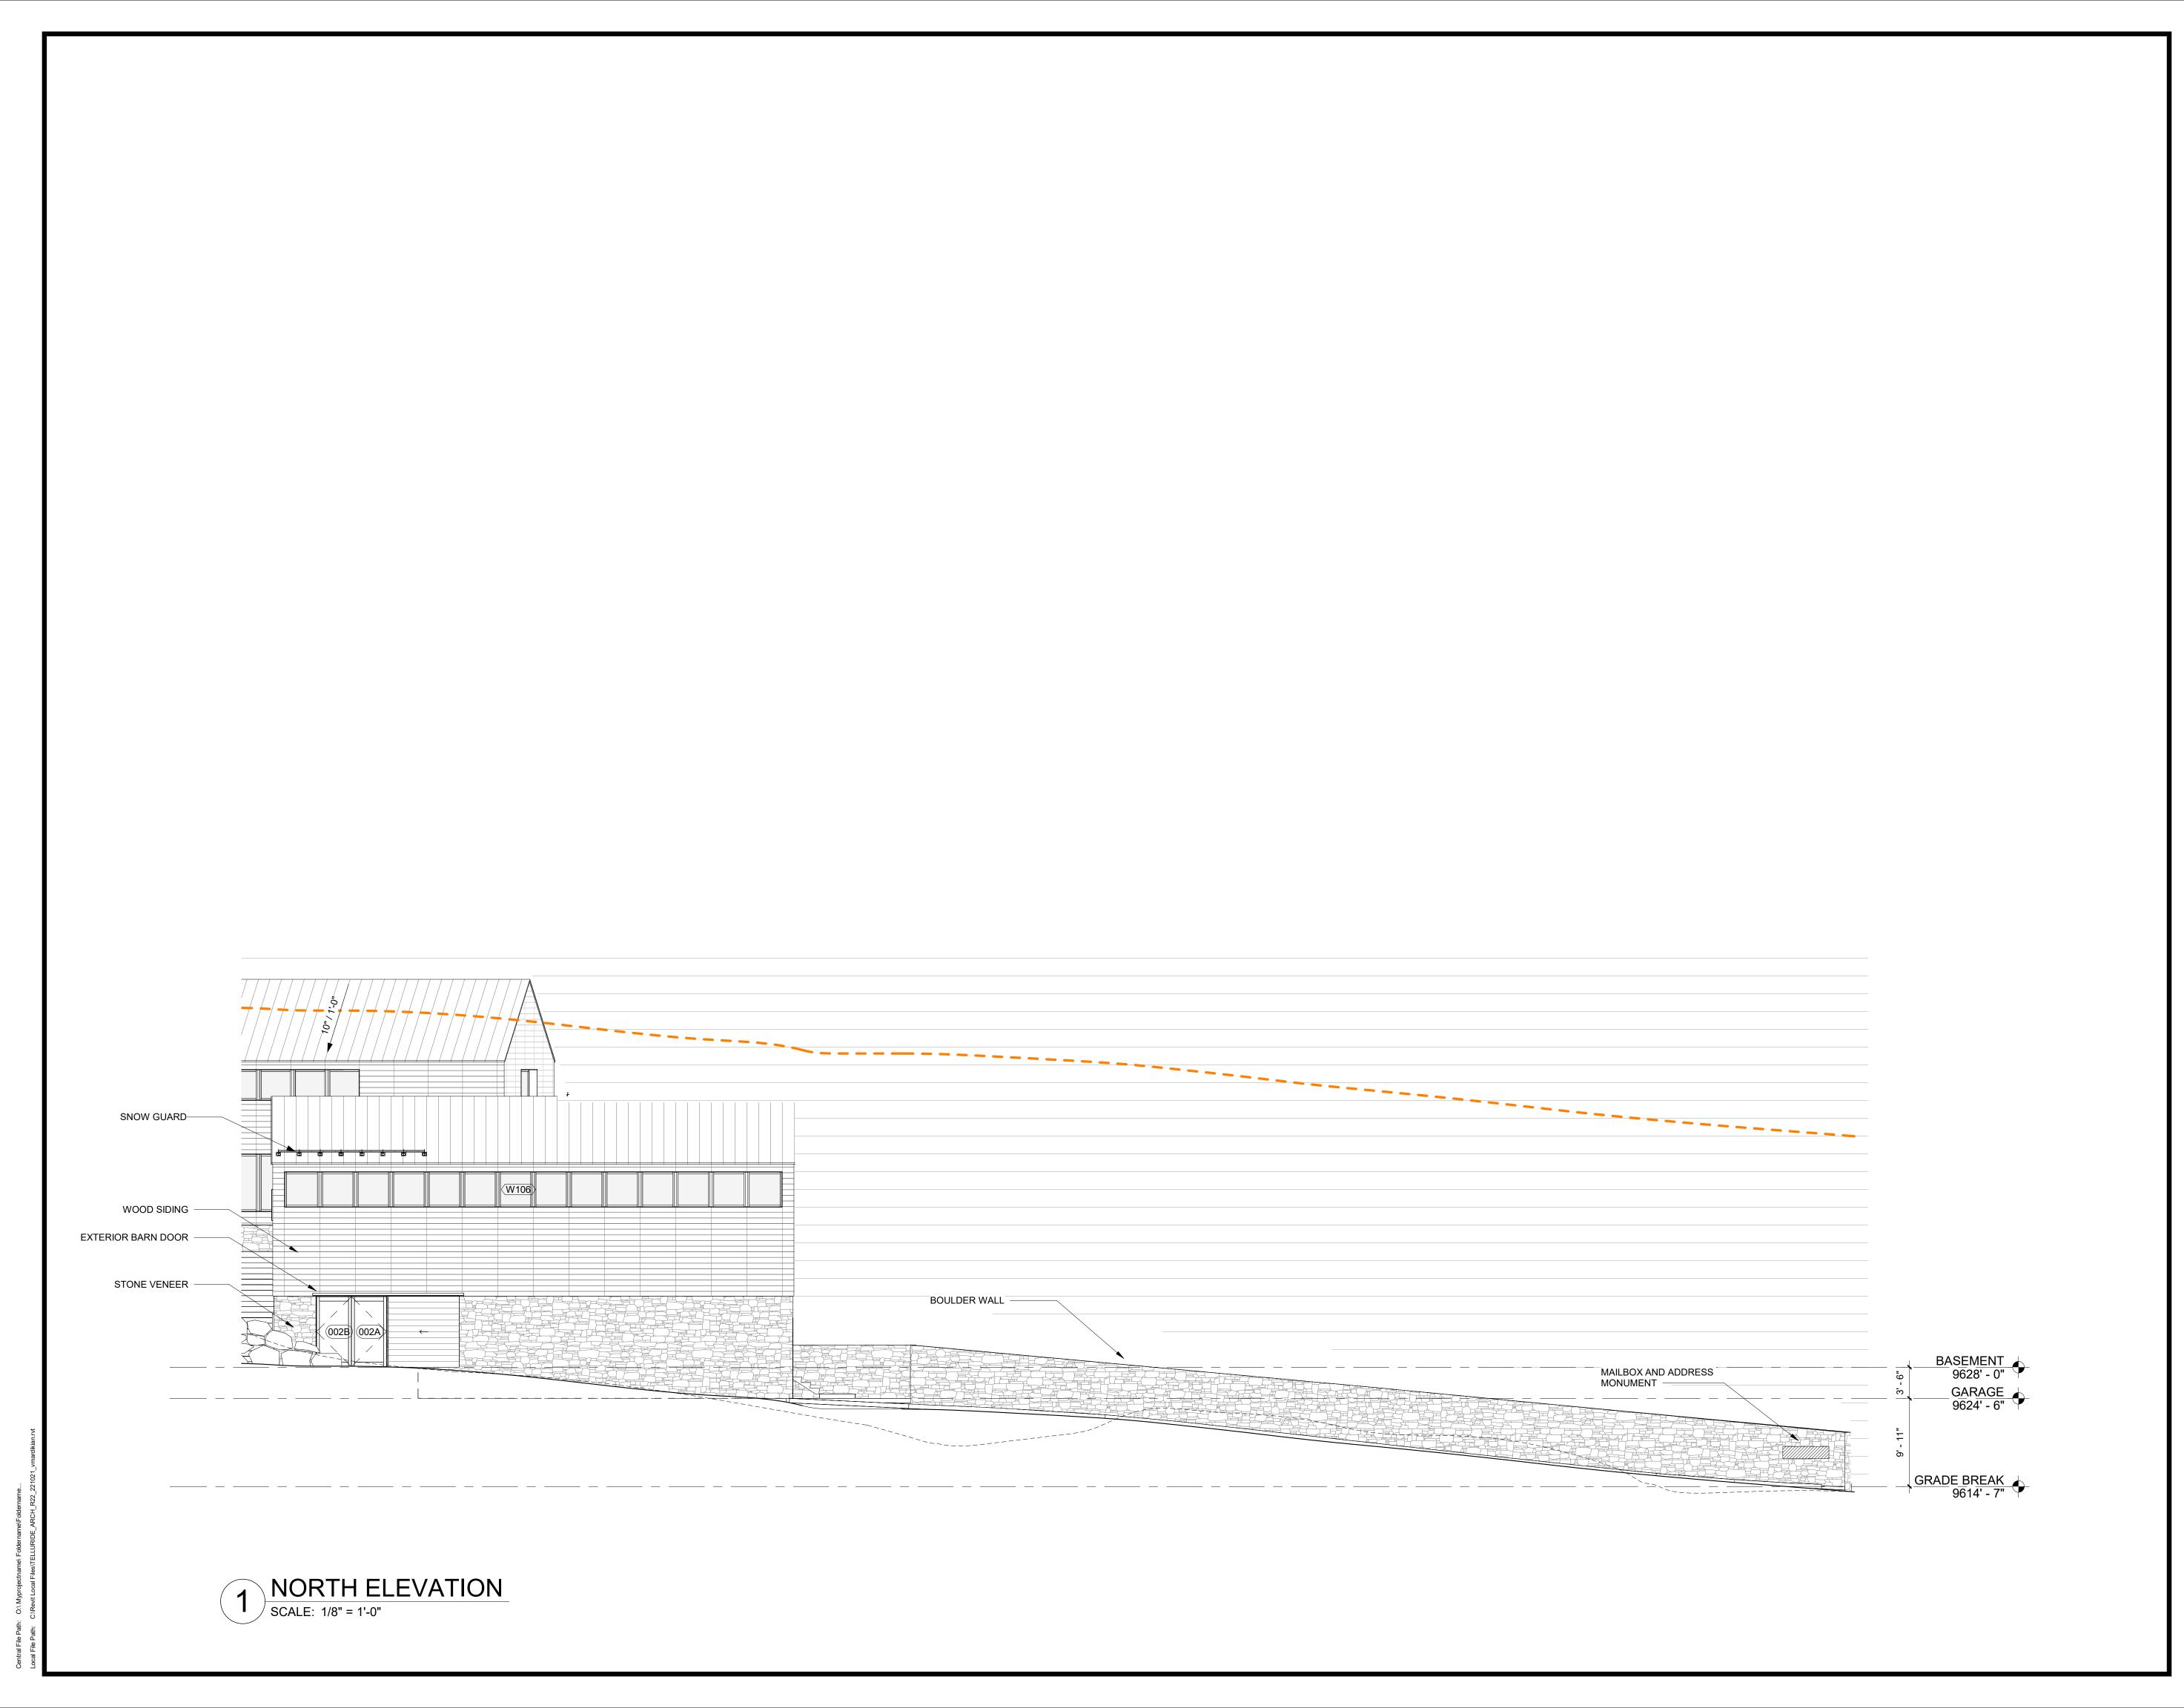
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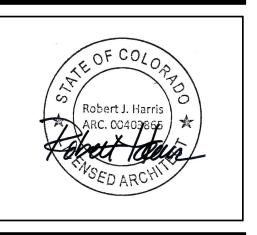
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DESCRIPTION

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EXTERIOR ELEVATIONS





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REVISIONS


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INIITIAL ARCH. & SITE REVIEW

EXTERIOR ELEVATIONS

WOOD SIDING






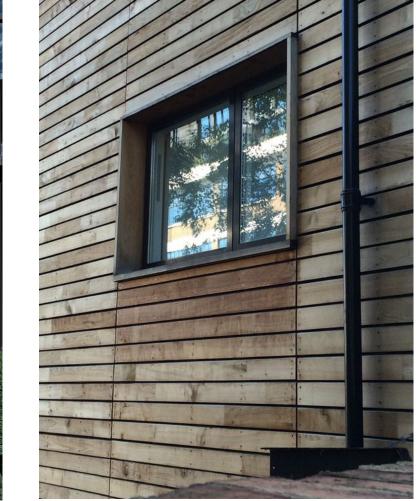

OPENING

STONE BASE / RETAINING

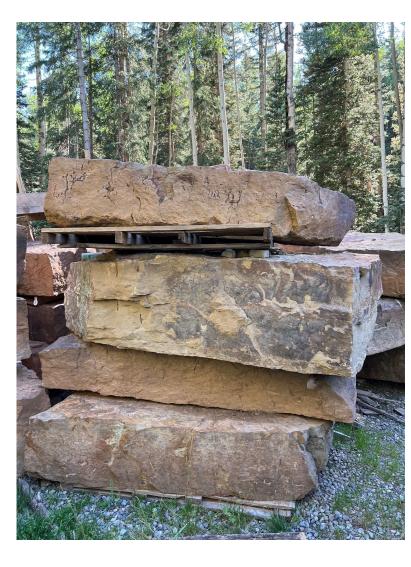






METAL ROOF / METALS






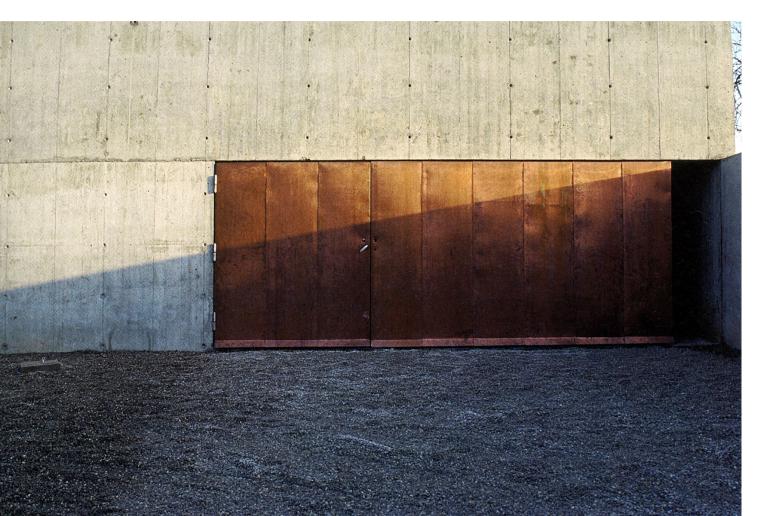

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PROJ. ARCHITECT DC DRAWN BY: VM

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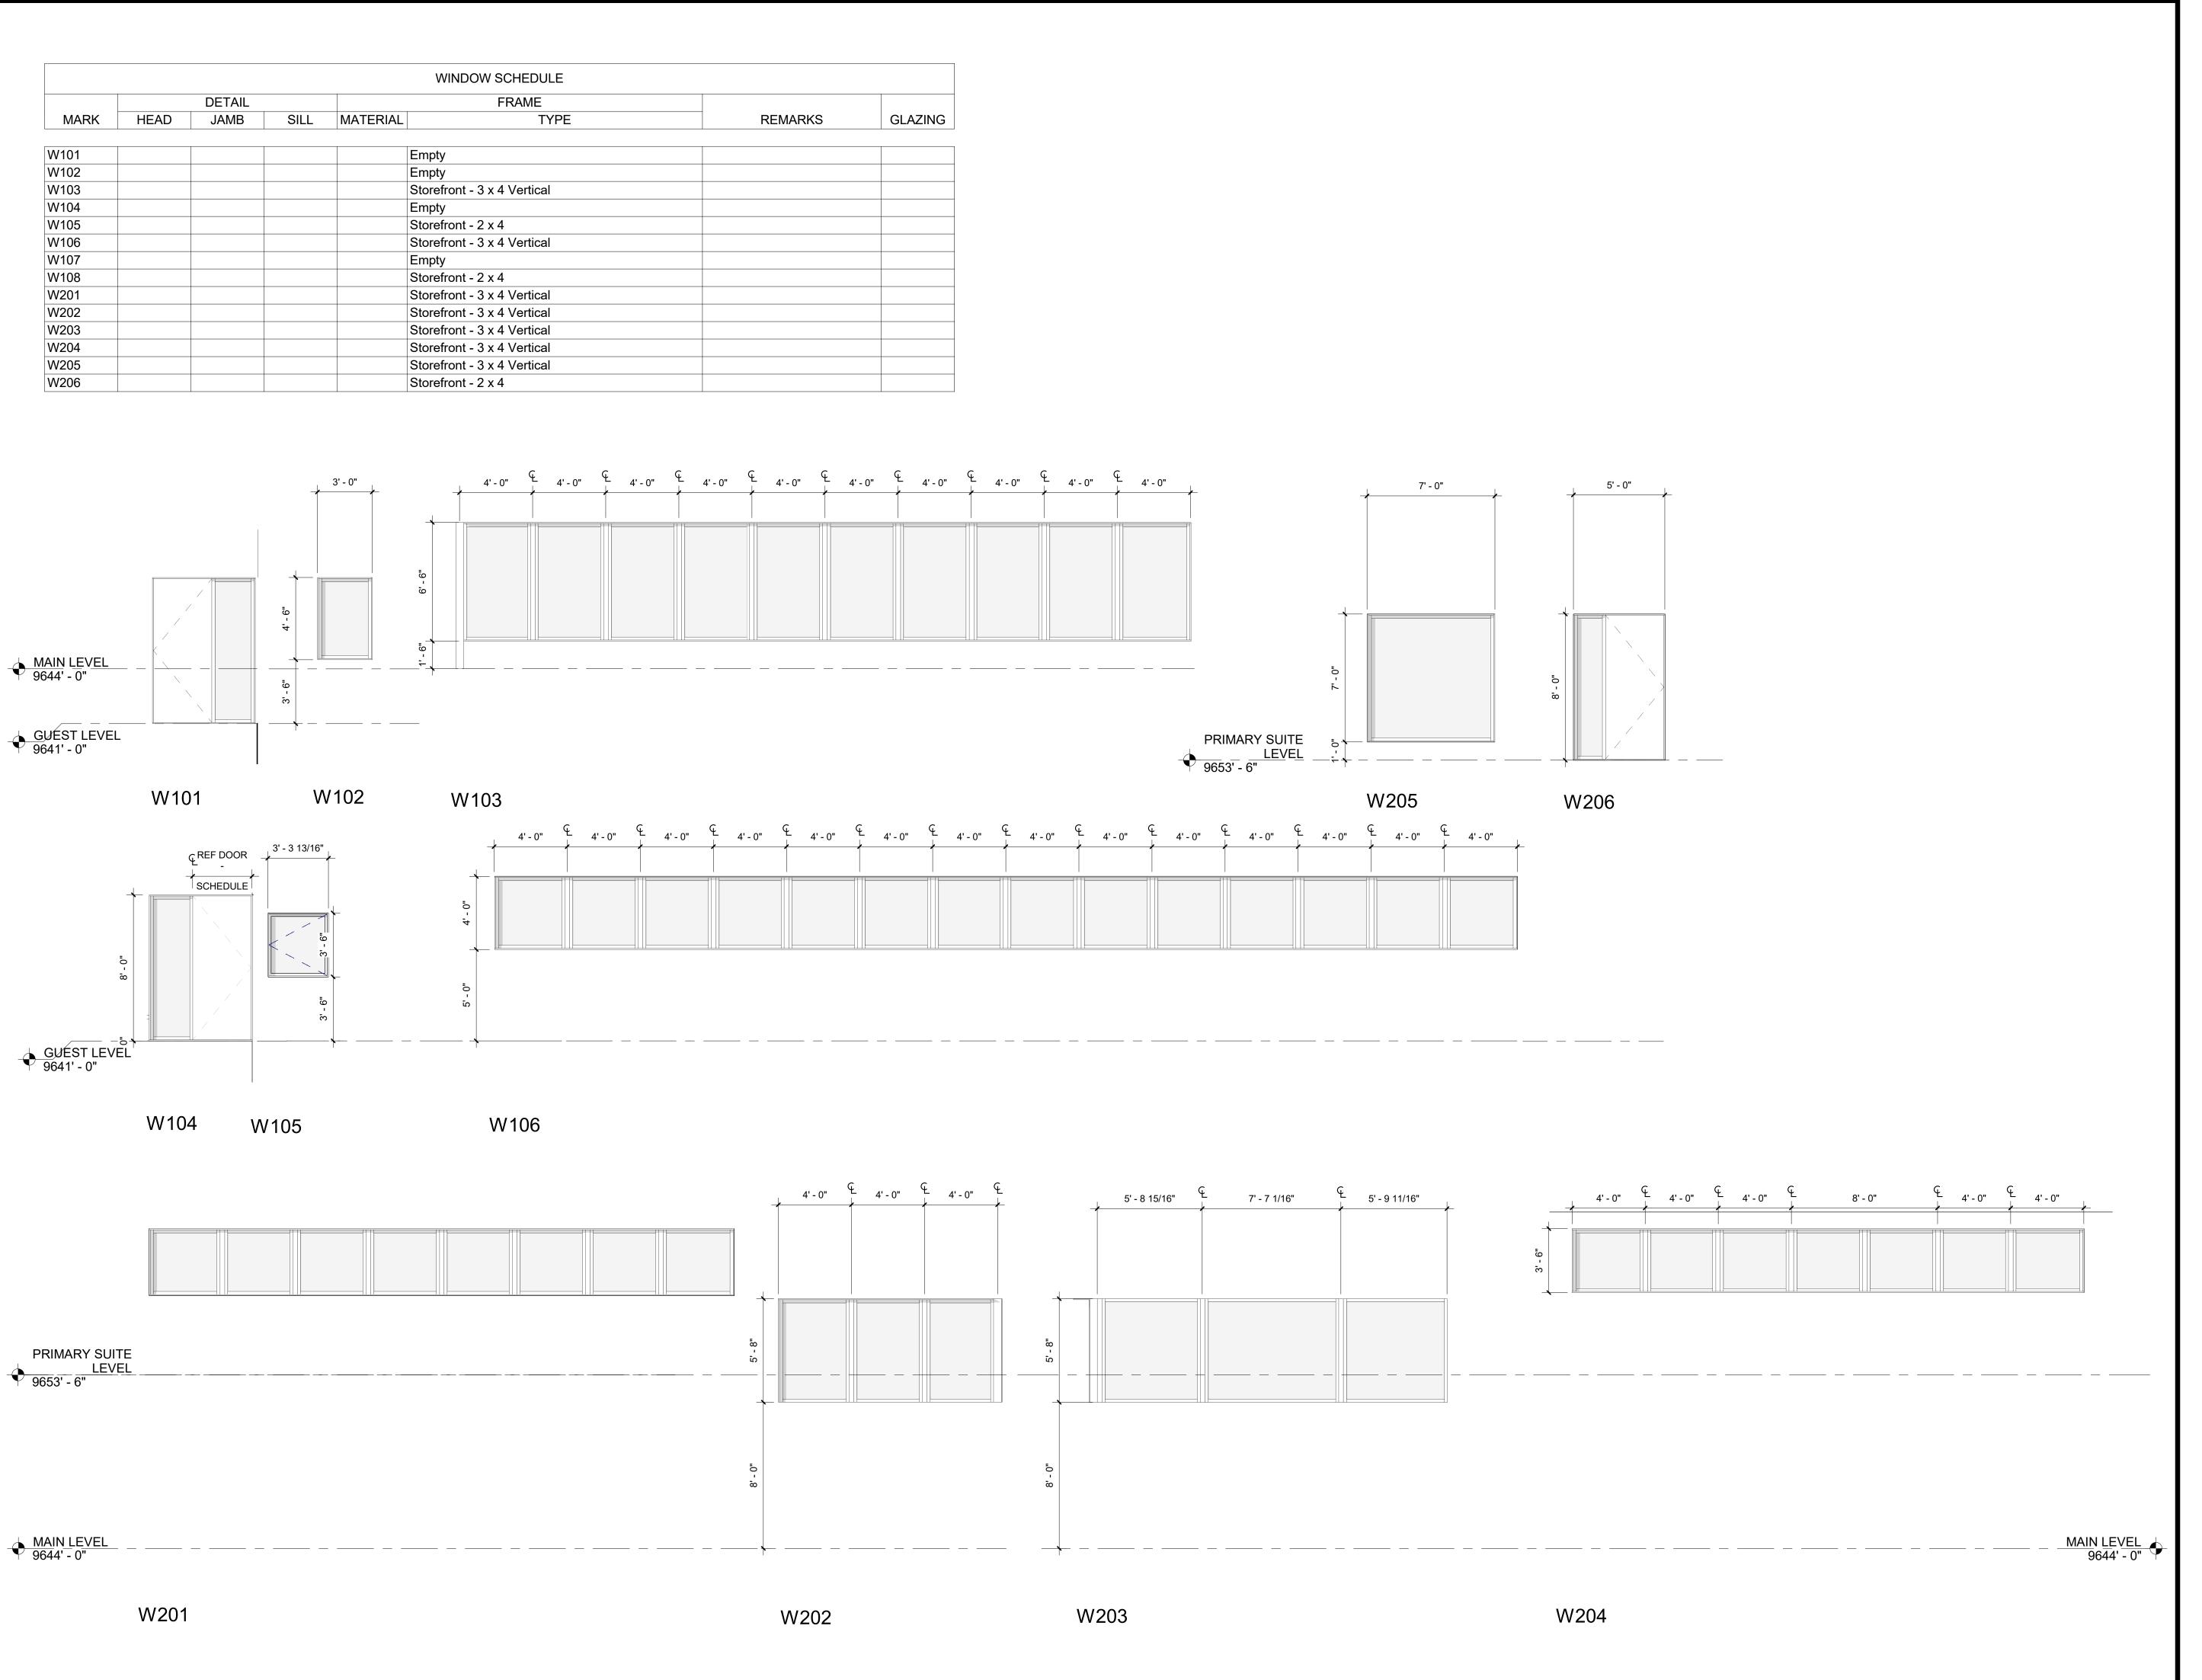
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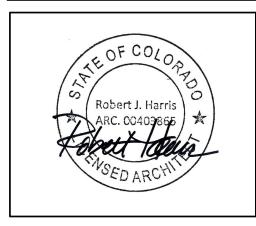
NO. DATE DESCRIPTION

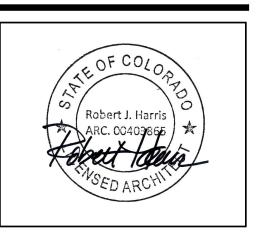REVISIONS

INIITIAL ARCH. & SITE REVIEW

EXTERIOR MATERIALS BOARD





SILVER CAMP

Lot 240-A, Mountain Village, Telluride, CO

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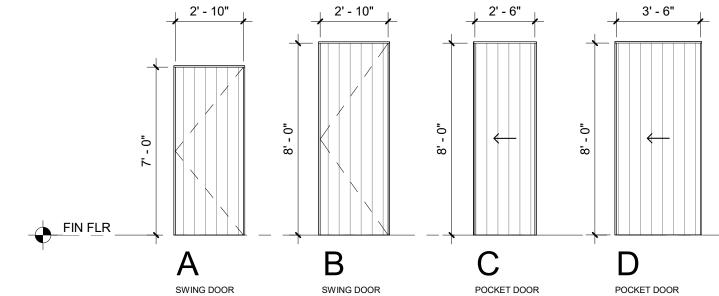
INIITIAL ARCH. & SITE

REVIEW

WINDOW SCHEDULE


A4.0





INTERIOR DOOR LEGEND

SCALE: 1/4" = 1'-0"

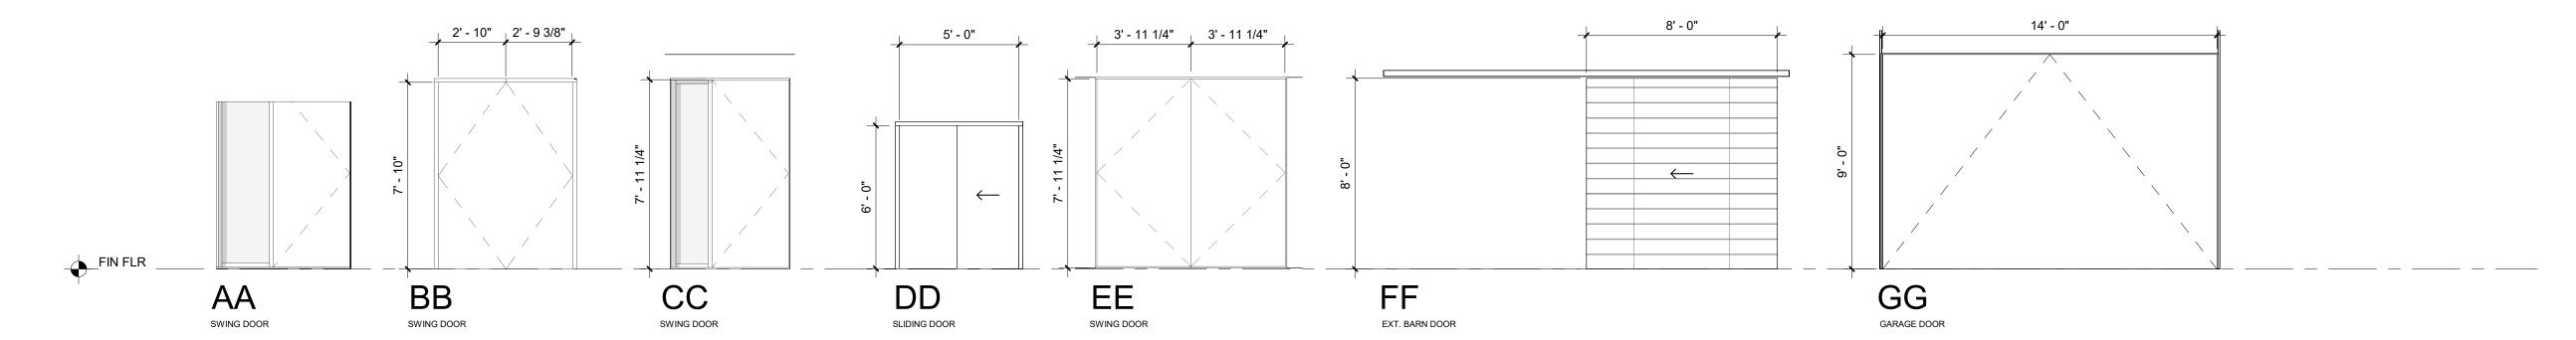


EXTERIOR DOOR LEGEND

SCALE: 1/4" = 1'-0"

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SILVER CAMP

Lot 240-A, Mountain Village, Telluride, CO

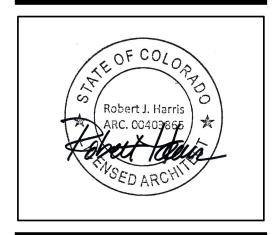LAKE|FLATO ARCHITECTS 311 3RD ST, SAN ANTONIO, TX, 78205

UNCOMPAGHRE ENGINEERING P.O. BOX 3945, TELLURIDE, CO, 81435

DB STRUCTURAL ENGINEER
1229 SAGE CT, RIFLE, CO, 81650

STUDIO OUTSIDE 824 EXPOSITION AVE STE 5, DALLAS, TX,75226

> THIS SQUARE APEARS 1/2"x1/2" ON FULL SIZE SHEETS

 17 OCT 2022
 LJF PROJ. NO.
 20030

 PROJ. ARCHITECT
 DC
 DRAWN BY:
 VM

SET ISSUE DATES

DATE ISSUE


REVISIONS

NO. DATE DESCRIPTION

INIITIAL ARCH. & SITE REVIEW

DOOR SCHEDULE

A4.1

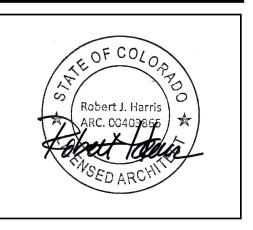

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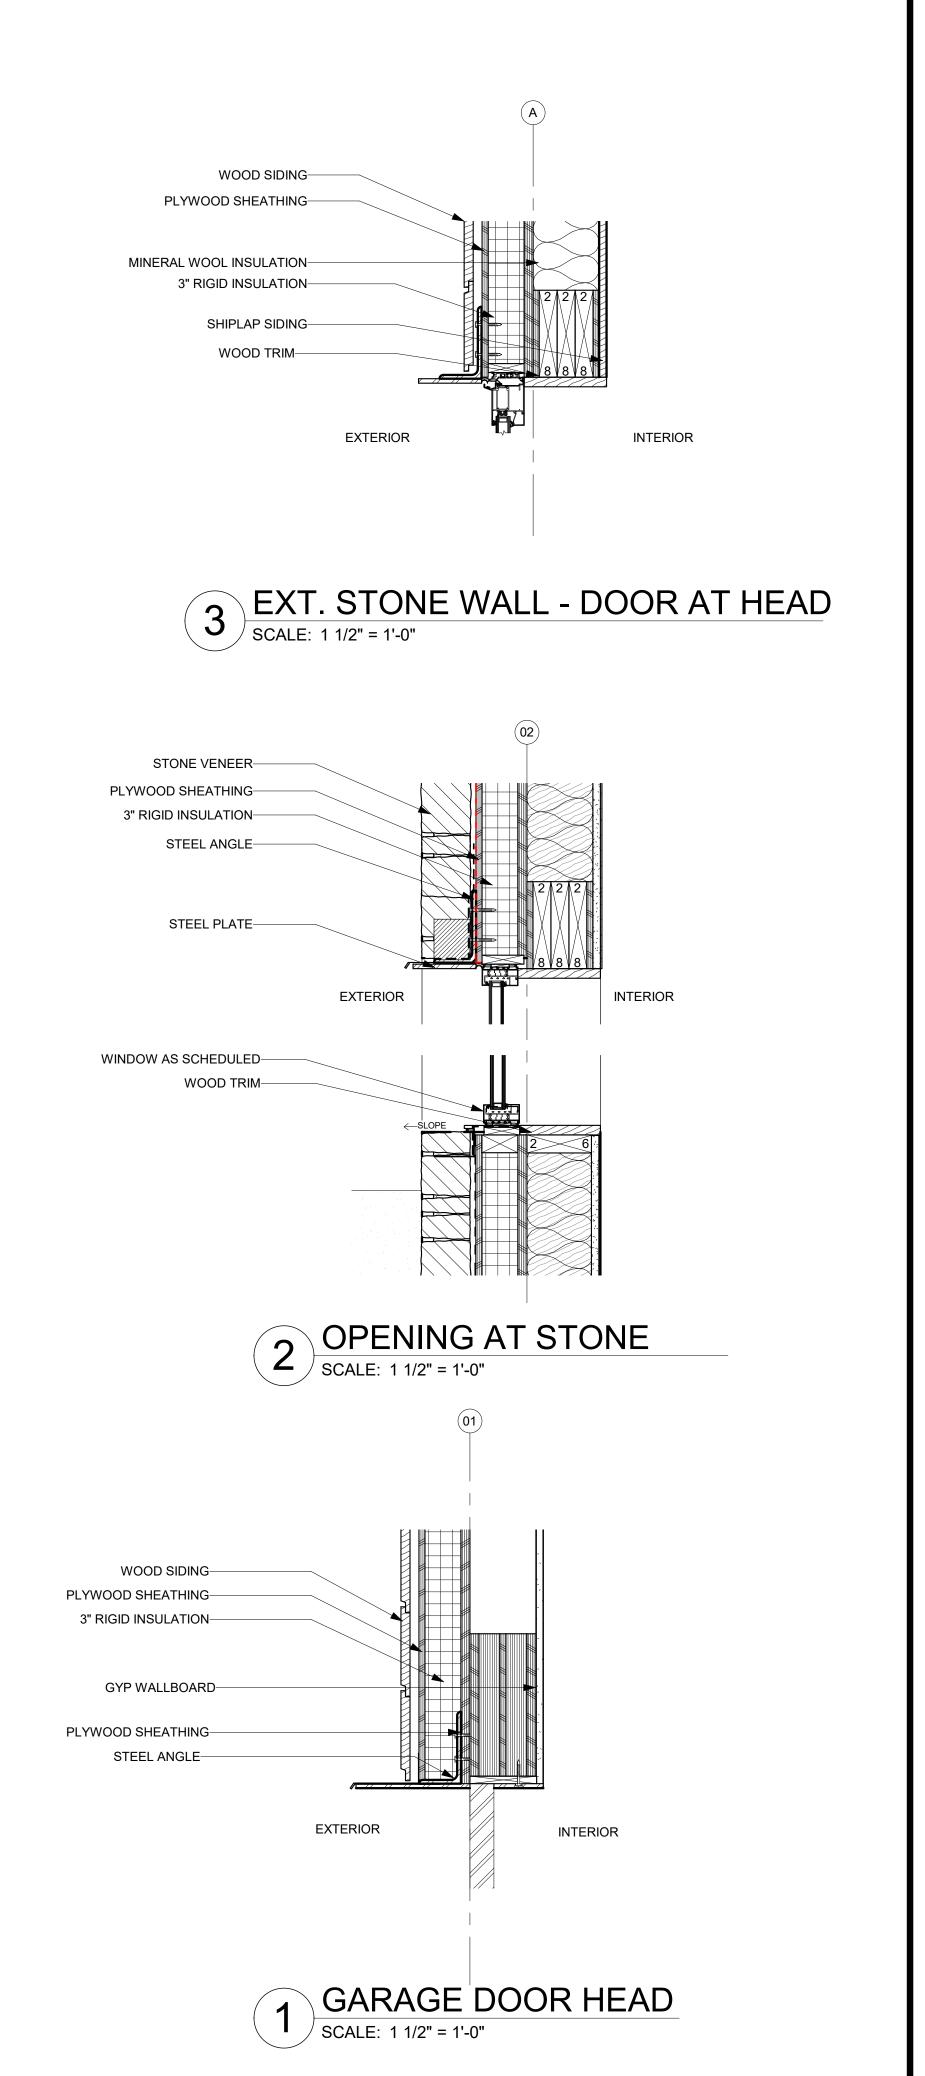
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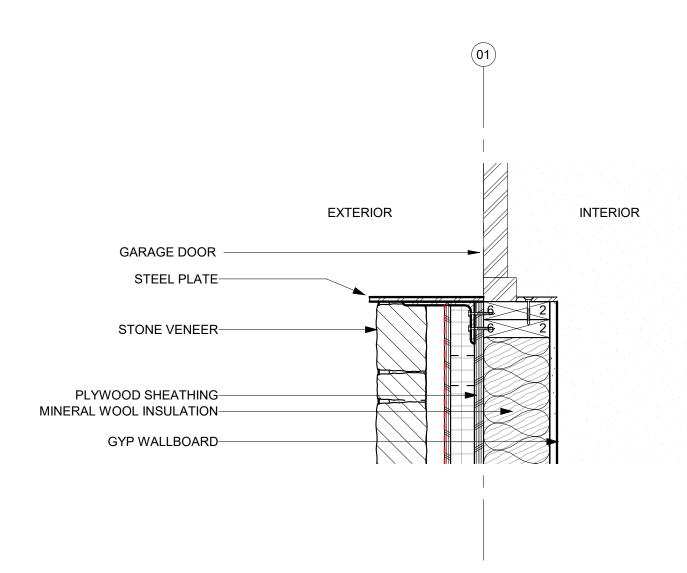
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REVIEW


WALL SECTION

A5.0





5 GARAGE DOOR JAMB
SCALE: 1 1/2" = 1'-0"

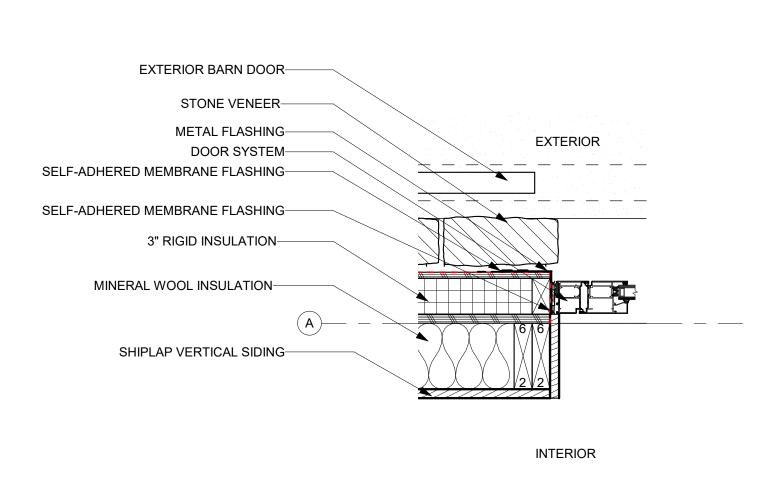

EXT. STONE WALL - DOOR AT JAMB

SCALE: 1 1/2" = 1'-0"

11/7/2022 12:20:12 PM

824 EXPOSITION AVE STE 5, DALLAS, TX,75226

LAKE | FLATO

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311 THIRD STREET
SAN ANTONIO, TEXAS 78205
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Village, Telluride, CO

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STUDIO OUTSIDE

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PROJ. ARCHITECT DC DRAWN BY: VM

SET ISSUE DATES DATE ISSUE

REVISIONS NO. DATE DESCRIPTION

INIITIAL ARCH. & SITE REVIEW

OPENINGS

GENERAL CIVIL ENGINEERING NOTES:

1. THE EXISTING UTILITY LINES SHOWN ON THE PLANS ARE APPROXIMATE. AT LEAST TWO (2) FULL WORKING DAYS PRIOR TO TO COMMENCING CONSTRUCTION, THE CONTRACTOR SHALL CONTACT THE UTILITY NOTIFICATION CENTER OF COLORADO @ 1-800-922-1987 OR 811 TO GET ALL UTILITIES LOCATED. IF ANY OF THESE UNDERGROUND UTILITIES ARE IN CONFLICT WITH THE CONSTRUCTION PLANS, THE CONTRACTOR SHALL NOTIFY THE ENGINEER AND WORK WITH THE ENGINEER TO FIND A SOLUTION BEFORE THE START OF CONSTRUCTION.

INSTALLATION AND SEPARATION REQUIREMENTS SHALL BE COORDINATED WITH THE INDIVIDUAL UTILITY PROVIDERS.

THE UTILITY PROVIDERS ARE:

SEWER, WATER, CABLE TV AND/OR FIBEROPTIC: TOWN OF MOUNTAIN VILLAGE

NATURAL GAS: BLACK HILLS ENERGY

POWER: SAN MIGUEL POWER TELEPHONE: CENTURY LINK

2. PRIOR TO BEGINNING ANY CONSTRUCTION ACTIVITIES, ALL NECESSARY PERMITS SHALL BE OBTAINED BY THE OWNER OR CONTRACTOR.

3. IT IS THE CONTRACTOR'S RESPONSIBILITY TO INSURE THAT EXCAVATED SLOPES ARE SAFE AND COMPLY WITH OSHA REQUIRIEMENTS. REFER TO THE SITE—SPECIFIC REPORT FOR THIS PROJECT FOR ADDITIONAL INFORMATION..

4. ALL TRENCHES SHALL BE ADEQUATELY SUPPORTED OR LAID BACK PER OSHA REGULATIONS.

5. ALL MATERIALS AND CONSTRUCTION SHALL BE IN CONFORMANCE WITH THE TOWN OF MOUNTAIN VILLAGE DESIGN STANDARDS LATEST EDITION. ALL CONSTRUCTION WITHIN EXISTING STREET OR ALLEY RIGHT—OF—WAY SHALL BE SUBJECT TO TOWN OF MOUNTAIN VILLAGE INSPECTION.

6. THE CONTRACTOR SHALL HAVE ONE COPY OF THE STAMPED PLANS ON THE JOB SITE AT ALL TIMES.

7. THE CONTRACTOR SHALL NOTIFY THE TOWN 48 HOURS PRIOR TO THE START OF CONSTRUCTION.

8. THE CONTRACTOR IS RESPONSIBLE FOR IMPLEMENTING AND MAINTAINING EROSION AND SEDIMENT CONTROL MEASURES AT ALL TIMES DURING CONSTRUCTION. THE ADJOINING ROADWAYS SHALL BE FREE OF DEBRIS AT THE END OF CONSTRUCTION ACTIVITIES EACH DAY.

9. THE CONTRACTOR SHALL PROVIDE, ERECT AND MAINTAIN PROPER TRAFFIC CONTROL DEVICES UNTIL THE SITE IS OPEN TO TRAFFIC. ANY TRAFFIC CLOSURES MUST BE COORDINATED WITH THE TOWN OF MOUNTAIN VILLAGE.

10. ALL DAMAGE TO PUBLIC STREETS AND ROADS, INCLUDING HAUL ROUTES, TRAILS, OR STREET IMPROVEMENTS, OR TO PRIVATE PROPERTY, SHALL BE REPAIRED AT THE SOLE EXPENSE OF THE CONTRACTOR TO THE ORIGINAL CONDITIONS.

11. WHEN AN EXISTING ASPHALT STREET IS CUT, THE STREET MUST BE RESTORED TO A CONDITION EQUAL TO OR BETTER THAN ITS ORIGINAL CONDITION. THE FINISHED PATCH SHALL BLEND SMOOTHLY INTO THE EXISTING SURFACE. ALL LARGE PATCHES SHALL BE PAVED WITH AN ASPHALT LAY—DOWN MACHINE.

12. IF DEWATERING IS REQUIRED, THE CONTRACTOR SHALL NOTIFY THE ENGINEER. ANY DISCHARGE REQUIREMENTS SHALL BE COORDINATED WITH THE TOWN OF MOUNTAIN VILLAGE.

13. CONTRACTOR SHALL NOTIFY ALL RESIDENTS IN WRITING 24 HOURS PRIOR TO ANY SHUT—OFF IN SERVICE. THE NOTICES MUST HAVE CONTRACTOR'S PHONE NUMBER AND NAME OF CONTACT PERSON, AND EMERGENCY PHONE NUMBER FOR AFTER HOURS CALLS. ALL SHUT—OFF'S MUST BE APPROVED BY THE TOWN AND TOWN VALVES AND APPURTENANCES SHALL BE OPERATED BY TOWN PERSONNEL.

14. CONTRACTOR SHALL KEEP SITE CLEAN AND LITTER FREE (INCLUDING CIGARETTE BUTTS) BY PROVIDING A CONSTRUCTION DEBRIS TRASH CONTAINER AND A BEAR-PROOF POLY-CART TRASH CONTAINER, WHICH IS TO BE LOCKED AT ALL TIMES.

15. CONTRACTOR MUST BE AWARE OF ALL TREES TO REMAIN PER THE DESIGN AND APPROVAL PROCESS AND PROTECT THEM ACCORDINGLY.

16. THE CONTRACTOR SHALL PROVIDE UNDERGROUND UTILITY AS-BUILTS TO THE TOWN.

17. ALL STRUCTURAL FILL UNDER HARDSCAPE OR ROADS MUST BE COMPACTED TO 95% MODIFIED PROCTOR (MIN.) AT PLUS OR MINUS 2% OF THE OPTIMUM MOISTURE CONTENT. NON—STRUCTURAL FILL SHALL BE PLACED AT 90% (MIN.) MODIFIED PROCTOR.

18. UNSUITABLE MATERIAL SHALL BE REMOVED AS REQUIRED BY THE SOILS ENGINEER. ALL MATERIALS SUCH AS LUMBER, LOGS, BRUSH, TOPSOIL OR ORGANIC MATERIALS OR RUBBISH SHALL BE REMOVED FROM ALL AREAS TO RECEIVE COMPACTED FILL.

19. NO MATERIAL SHALL BE COMPACTED WHEN FROZEN.

20. NATIVE TOPSOIL SHALL BE STOCKPILED TO THE EXTENT FEASIBLE ON THE SITE FOR USE ON AREAS TO BE REVEGETATED.

21. THE CONTRACTOR SHALL BE RESPONSIBLE FOR DUST ABATEMENT AND EROSION CONTROL MEASURES DEEMED NECESSARY BY THE TOWN, IF CONDITIONS WARRANT THEM.


22. ALL DISTURBED GROUND SHALL BE RE-SEEDED WITH A TOWN-APPROVED SEED MIX. REFER TO THE LANDSCAPE PLAN.

23. THE CONTRACTOR IS REQUIRED TO PROTECT ALL EXISTING SURVEY MONUMENTS AND PROPERTY CORNERS DURING GRADING AND CONSTRUCTION.

24. ALL UNDERGROUND PIPE SHALL BE PROTECTED WITH BEDDING TO PROTECT THE PIPE FROM BEING DAMAGED.

25. HOT TUBS SHALL DRAIN TO THE SANITARY SEWER (OR PUMPED TO AA CLEAN-OUT).

26. THE UTILITY PLAN DEPICTS FINAL UTILITY LOCATIONS BUT HAS BEEN COMPLETED AT A PRELIMINARY STAGE. CONTRACTOR SHALL VERIFY ALIGNMENTS WITH THE ARCHITECT PRIOR TO CONSTRUCTION.

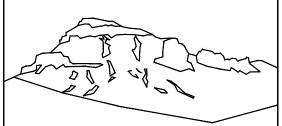

Uncompahgre Engineering, LLC

P.O. Box 3945 Telluride, CO 81435 970-729-0683

2022-10-14

SUBMISSIONS:

DRB SUBMITTAL


Lot 240A Hang Glider Lane Mtn. Village, CO





CONTRACTOR TO REVIEW AND COMPARE ALL CHAPTERS AND INTERDISCIPLINARY DRAWINGS AND REPORT ANY DISCREPANCIES TO THE ARCHITECT PRIOR TO ANY FIELD WORK BEING DONE IN ACCORDANCE WITH AIA DOCUMENT A201

Notes

C1

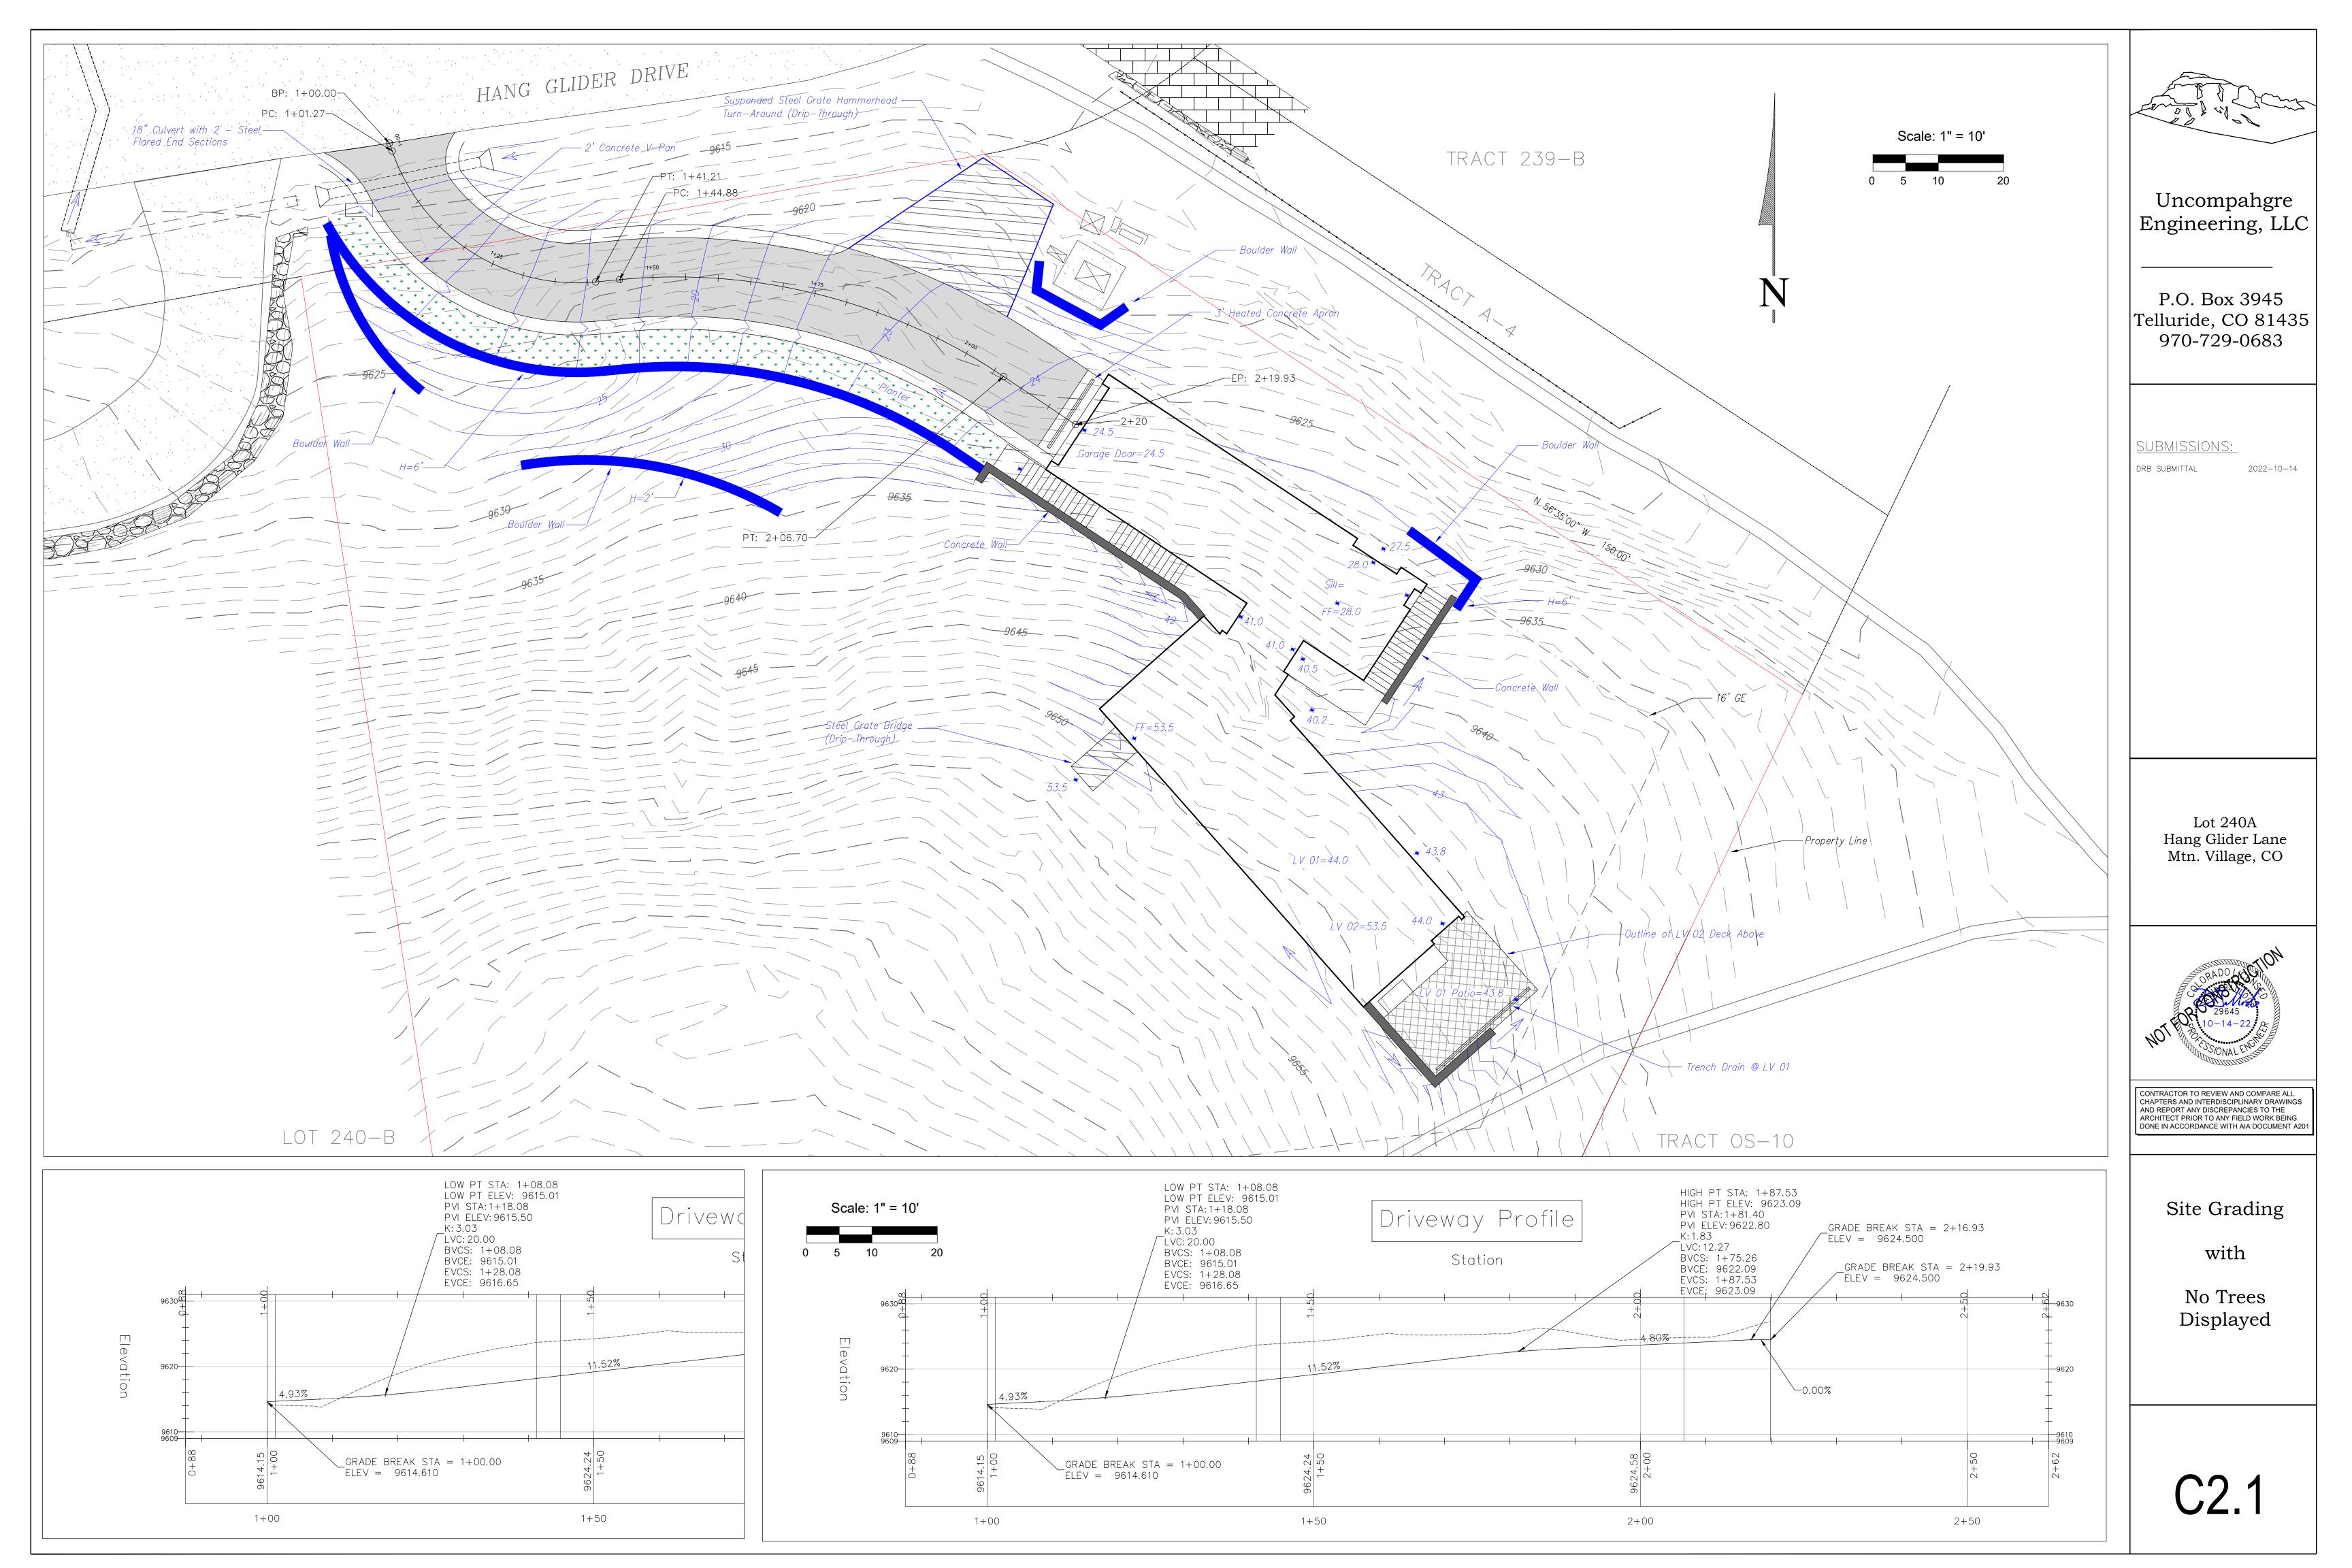

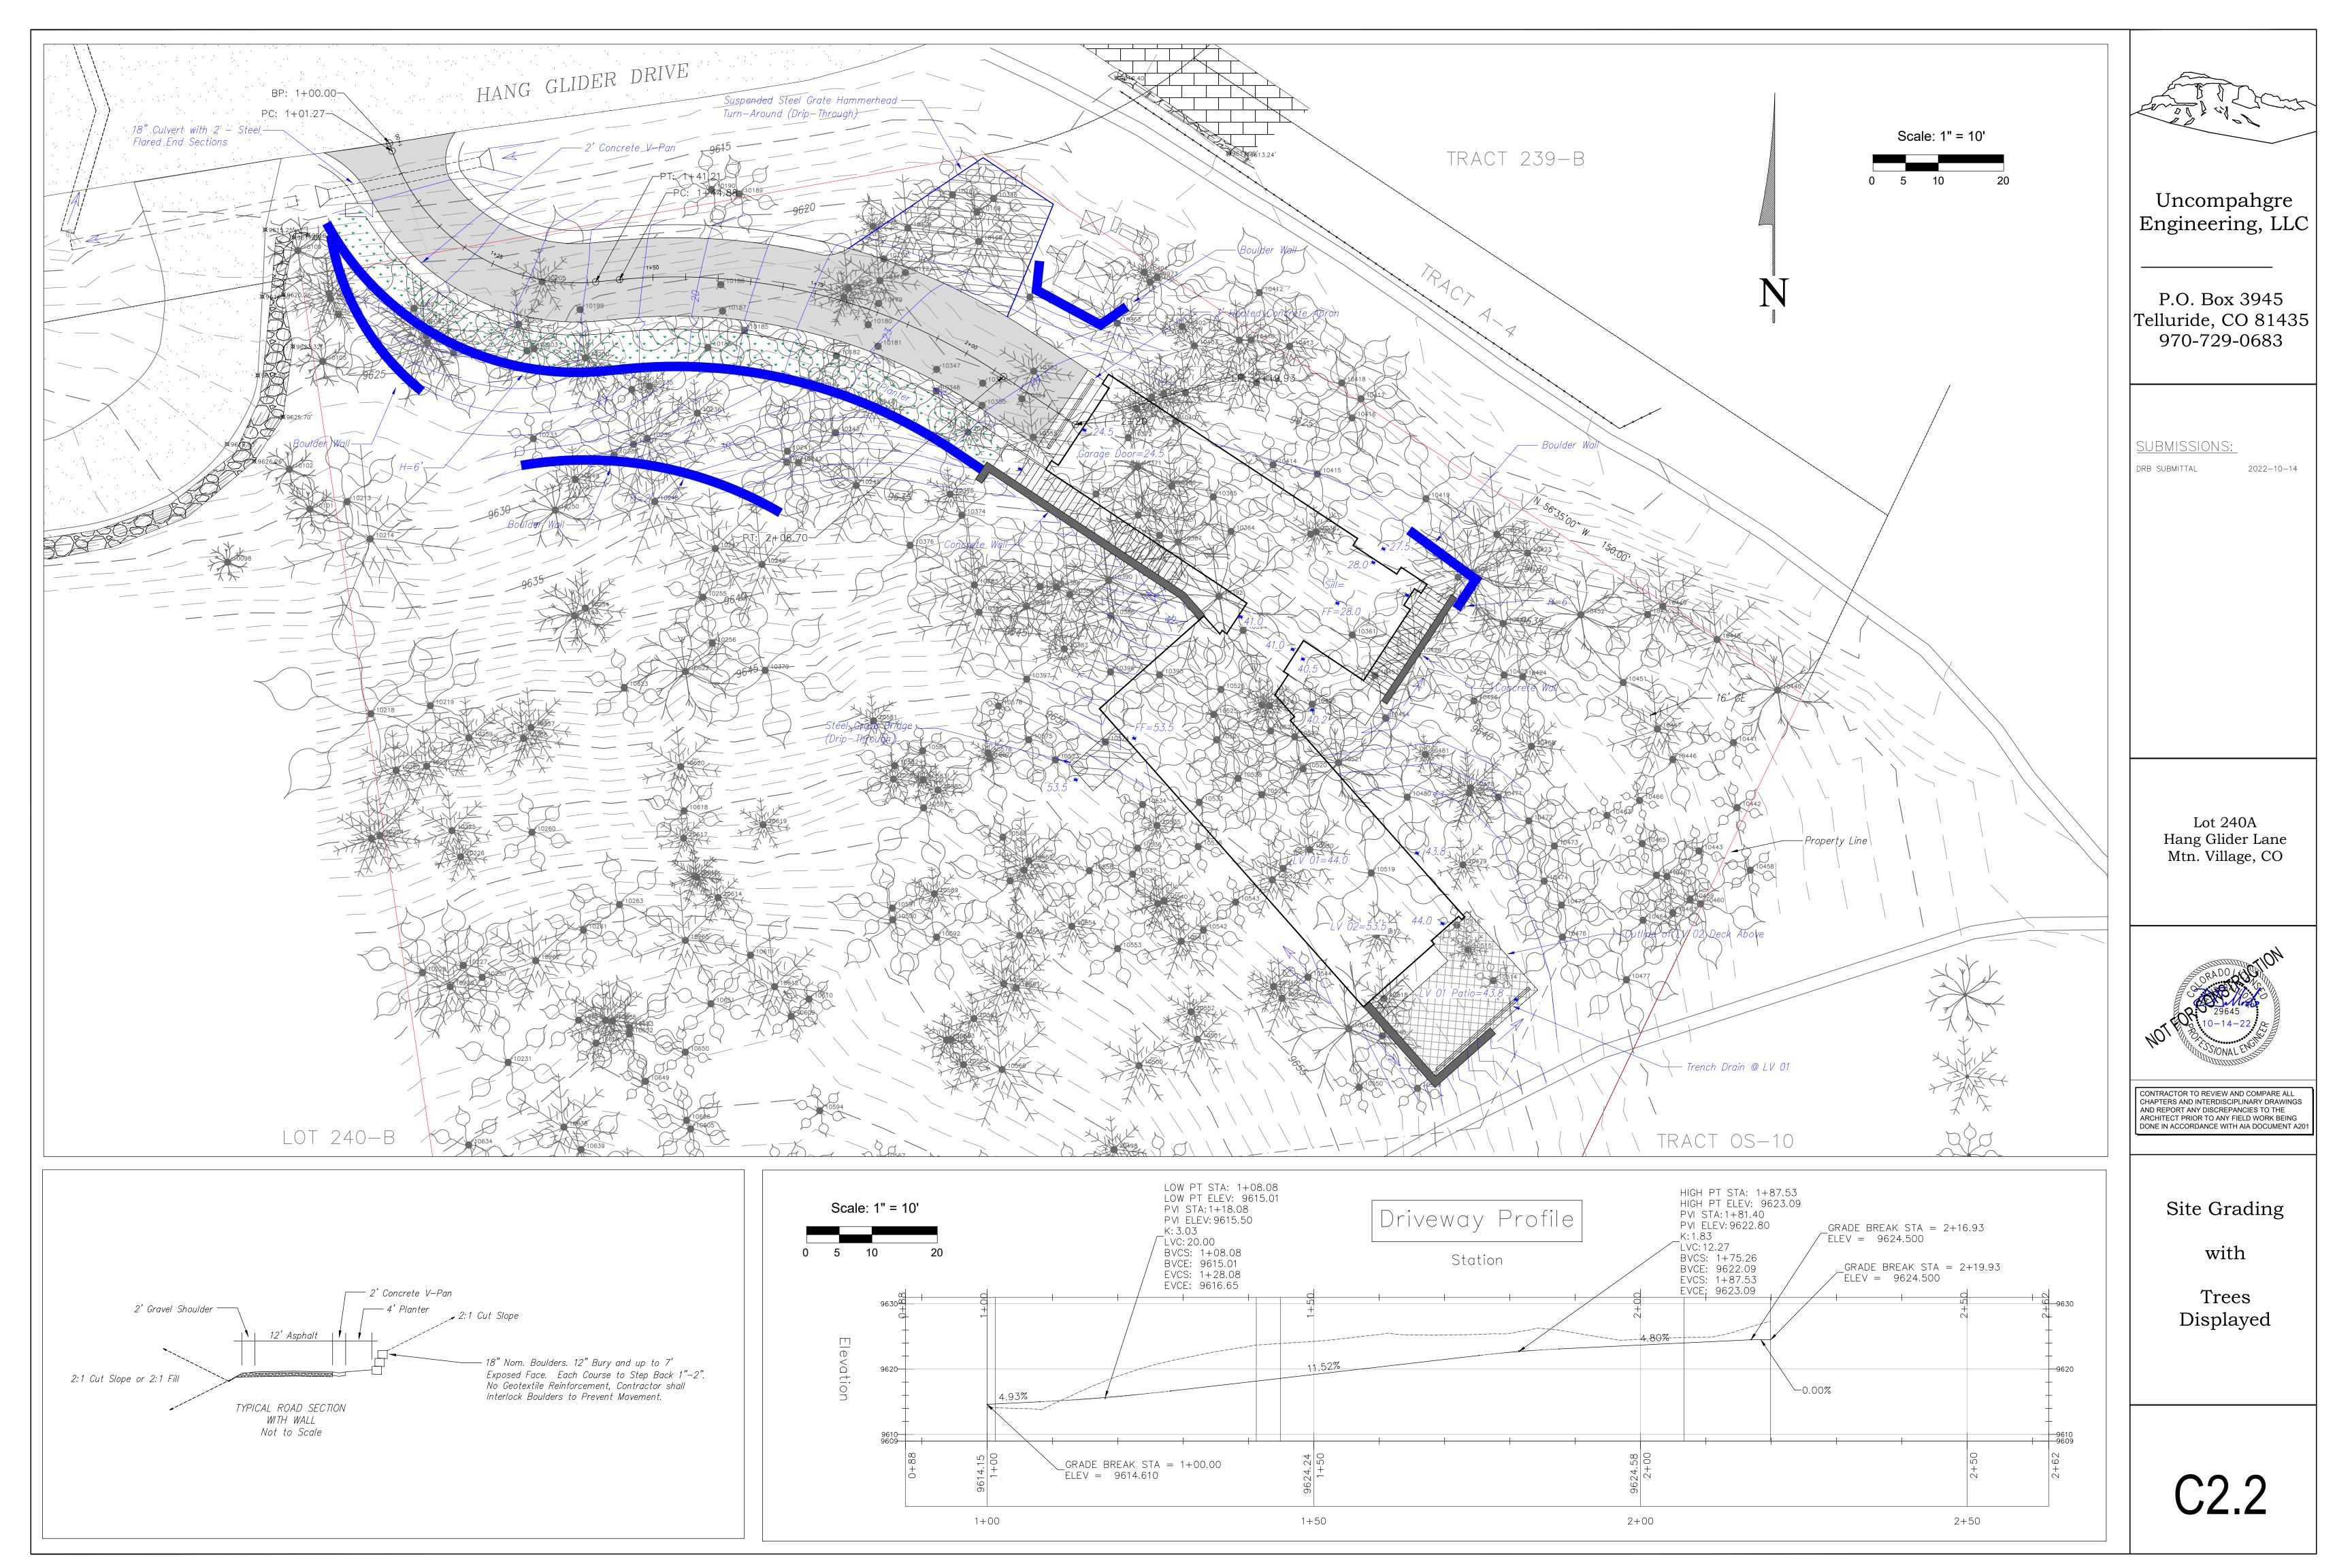

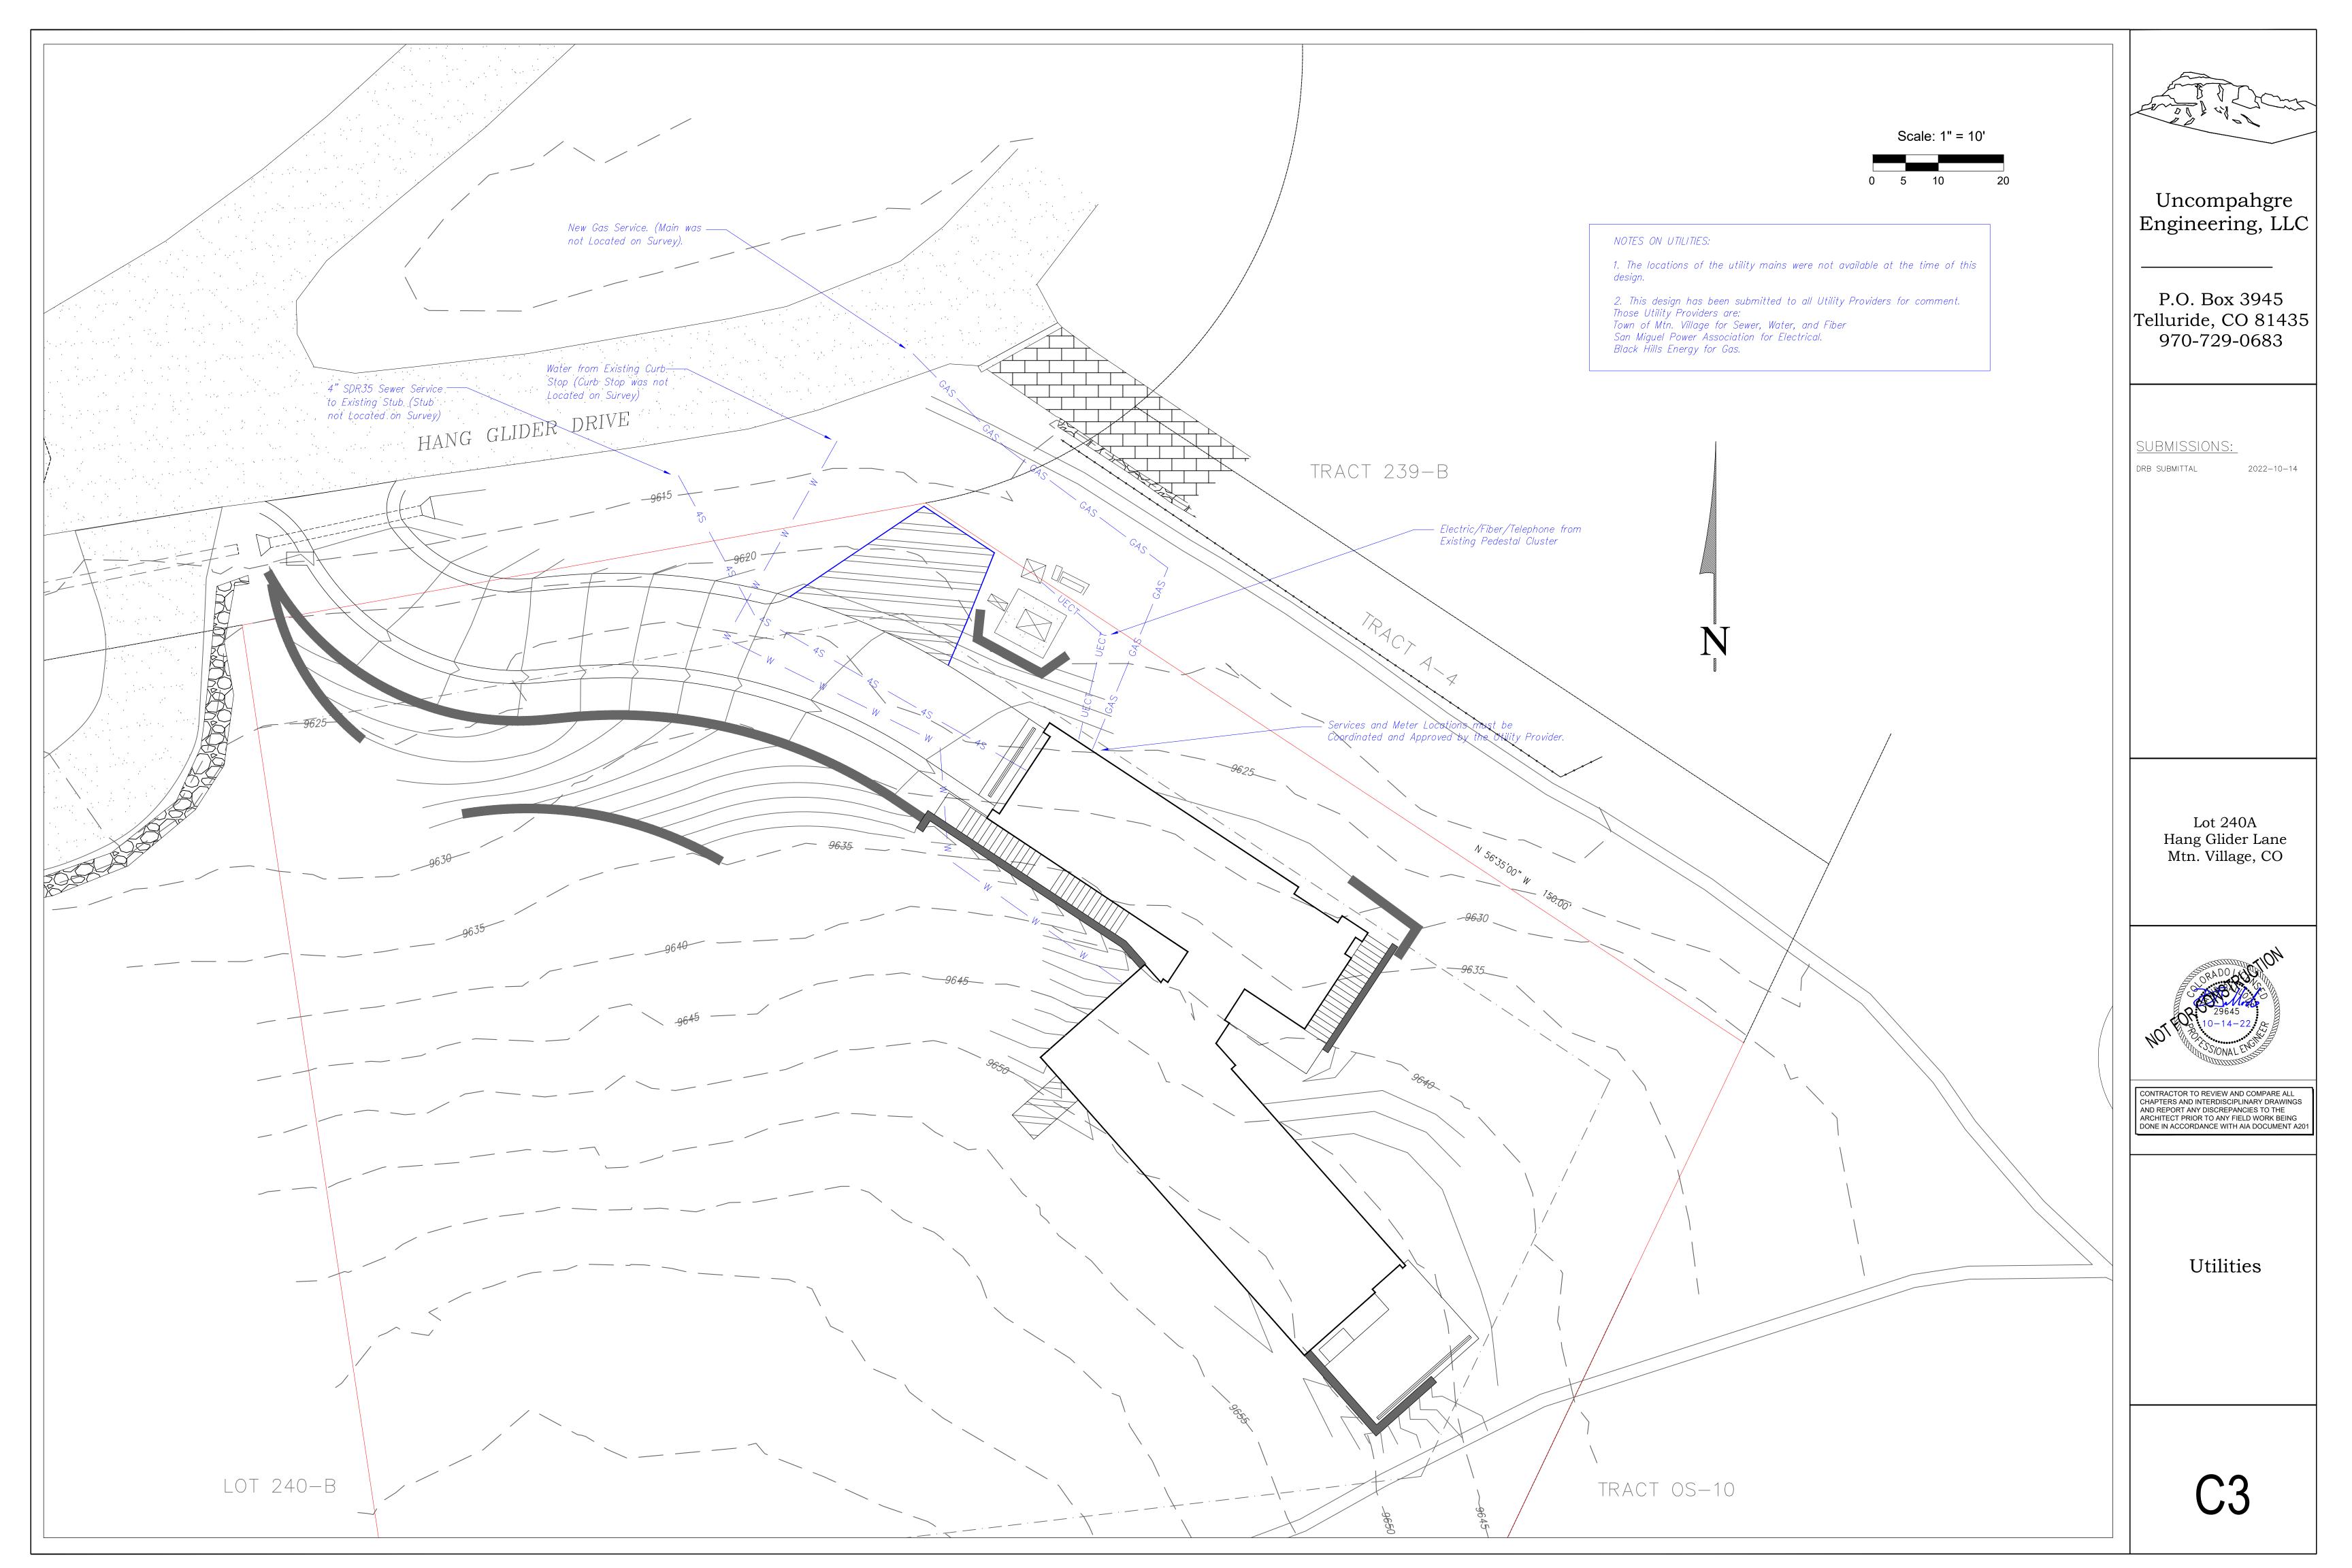

Wildfire Mitigation Notes:

Wildfire Mitigation will be performed according to the Town of Mountain Village requirements, CDC Chapter 17.6. Zones 1, 2, and 3 are identified on the plan.


- D. The following requirements shall be followed in creating the required wildfire mitigation plan:
- i. Zone 1 is the area that consists of fifteen feet (15") around the building as measured from the outside edge of the building's dripline, including decks, planters or patios attached to the building. The following provisions shall apply in Zone 1:
- 1. (a) All slash and flammable vegetation as identified by staff shall be removed from Zone 1.
- 2. (b) All trees and shrubs located within Zone 1 shall be removed.
- 3. (c) The following exceptions apply to Zone 1:
- 1. (i.) A tree or shrub may remain within Zone 1 provided the defensible space distance is measured commencing from the vegetation's drip edge rather than from the building plane (so the tree is considered part of or an extension of the structure), and provided the distance is not limited by a lot
- 2. (ii.) Flammable vegetation shall be allowed in planters attached to the building so long as the planter is within ten feet (10') of a building, and vegetation is not planted directly beneath windows or next to foundation vents.
- 4. (d) In the event Zone 1 encroaches upon the general easement, the review authority shall allow the creation of defensible space as required by this section.
- ii. Zone 2 is the area that extends from the outer edge of Zone 1 for the distance specified in Figure 6-1(Sec. 17.6.1 of the CDC), Fire Mitigation Zones, based on slope, to the lot line, whichever is less.


The following provisions shall apply in Zone 2:

- (iii.) Dominant and co-dominant live trees with a dbh of four inches (4") or greater shall be spaced with a ten foot (10') crown—to— crown separation. All ladder fuels and slash shall be removed from the ten foot (10') crown-to-crown separation area.
- 4. (iv.) All stressed, diseased, dead or dying trees and shrubs, as identified by staff, shall be removed except for standing dead trees that staff indicates need to be maintained since standing dead trees provide important wildlife habitat.
- 5. (v.) Shrubs over five feet (5') tall shall have an average spacing of ten feet (10') from shrub-to-shrub.
- (A) The following exceptions apply to Zone 2:
 - 2. (i.) Groupings of trees or shrubs may be allowed provided that all of the crowns in such group of trees or the edge of the shrubs are spaced ten feet (10') from crown—to— crown or from edge of shrub to any trees or shrubs outside of such grouping.
 - 3. (ii.) Aspens, narrowleaf cottonwoods, willows and other trees and shrubs listed in CSU Cooperative Extension Publication 6.305, Firewise Plant Materials as amended from time to time, may be spaced closer than the ten foot (10') crown—to—crown separation as approved by staff.
 - 4. (iii.) Closer spacing of any trees may be allowed by staff upon a determination that the required ten foot (10') crown-to-crown spacing would put the remaining trees at undue risk of wind-throw or snow breakage.
 - 5. (iv.) Tree removal for the creation of defensible space, if such tree removal is determined to be impractical by the Town due to steep slopes, wetland or other environmental constraints, and other mitigation is provided.
 - 3. (c) Trees remaining within Zone 2 shall have branches pruned to a height of ten feet (10'), but notwithstanding said height requirement, branches need not be pruned to more than one-third (1/3) of the tree height with the following exceptions:
 - 1. (i.) Aspen trees; and
 - 2. (ii.) Isolated spruce and fir trees.

ii. Outdoor storage shall only occur in the rear yard.

- 4. (d) In the event that Zone 1 or 2 extends upon the general easement, the review authority shall allow the removal of trees to implement the wildfire mitigation plan.
- 5. (e) Chipped wood and small timber may be spread throughout either Zone 2 or Zone 3 provided the wood chips have a maximum depth of two to three inches (2"-3") and small timber has a diameter of three inches (3") or less and is cut up into lengths that are three feet (3') or less.
- iii. Zone 3 is the area extending beyond Zone 2 to the edge of the lot subject to development. In Zone 3, all diseased, beetle infested, dead or dying trees, as identified by staff, shall be removed except for standing dead trees (aka tree snags) that staff indicates need to be maintained since standing dead trees provide important wildlife habitat.
- (a) For lots greater than five (5) acres in size, the Town shall only require that Zone 3 be implemented for a distance of 500 feet from the outside edge of Zone 2. A lot owner may propose to implement Zone 3 for all of
- E. Firewood may only be stored on a lot that has a solid fuel burning device permit issued by the Town that meets the following limitations:
- i. Indoor storage can only occur within an enclosed room that is a part of the primary structure on the lot.
- iii. Up to ten (10) cubic feet of outdoor firewood storage may be located in Zone 1 or Zone 2.
- iv. Outdoor firewood storage larger than ten (10) cubic feet shall have a minimum thirty foot (30') distance from the structure.
- v. Outdoor firewood storage shall be screened from view from surrounding lots
- F. Prior to the issuance of any certificate of occupancy or certificated of completion, staff shall inspect the lot affected by the fire mitigation plan to ensure that such plan has been implemented in accordance with the approved wildfire mitigation plan.
- G. The wildfire mitigation plan shall be maintained by the lot owner as required by this section.

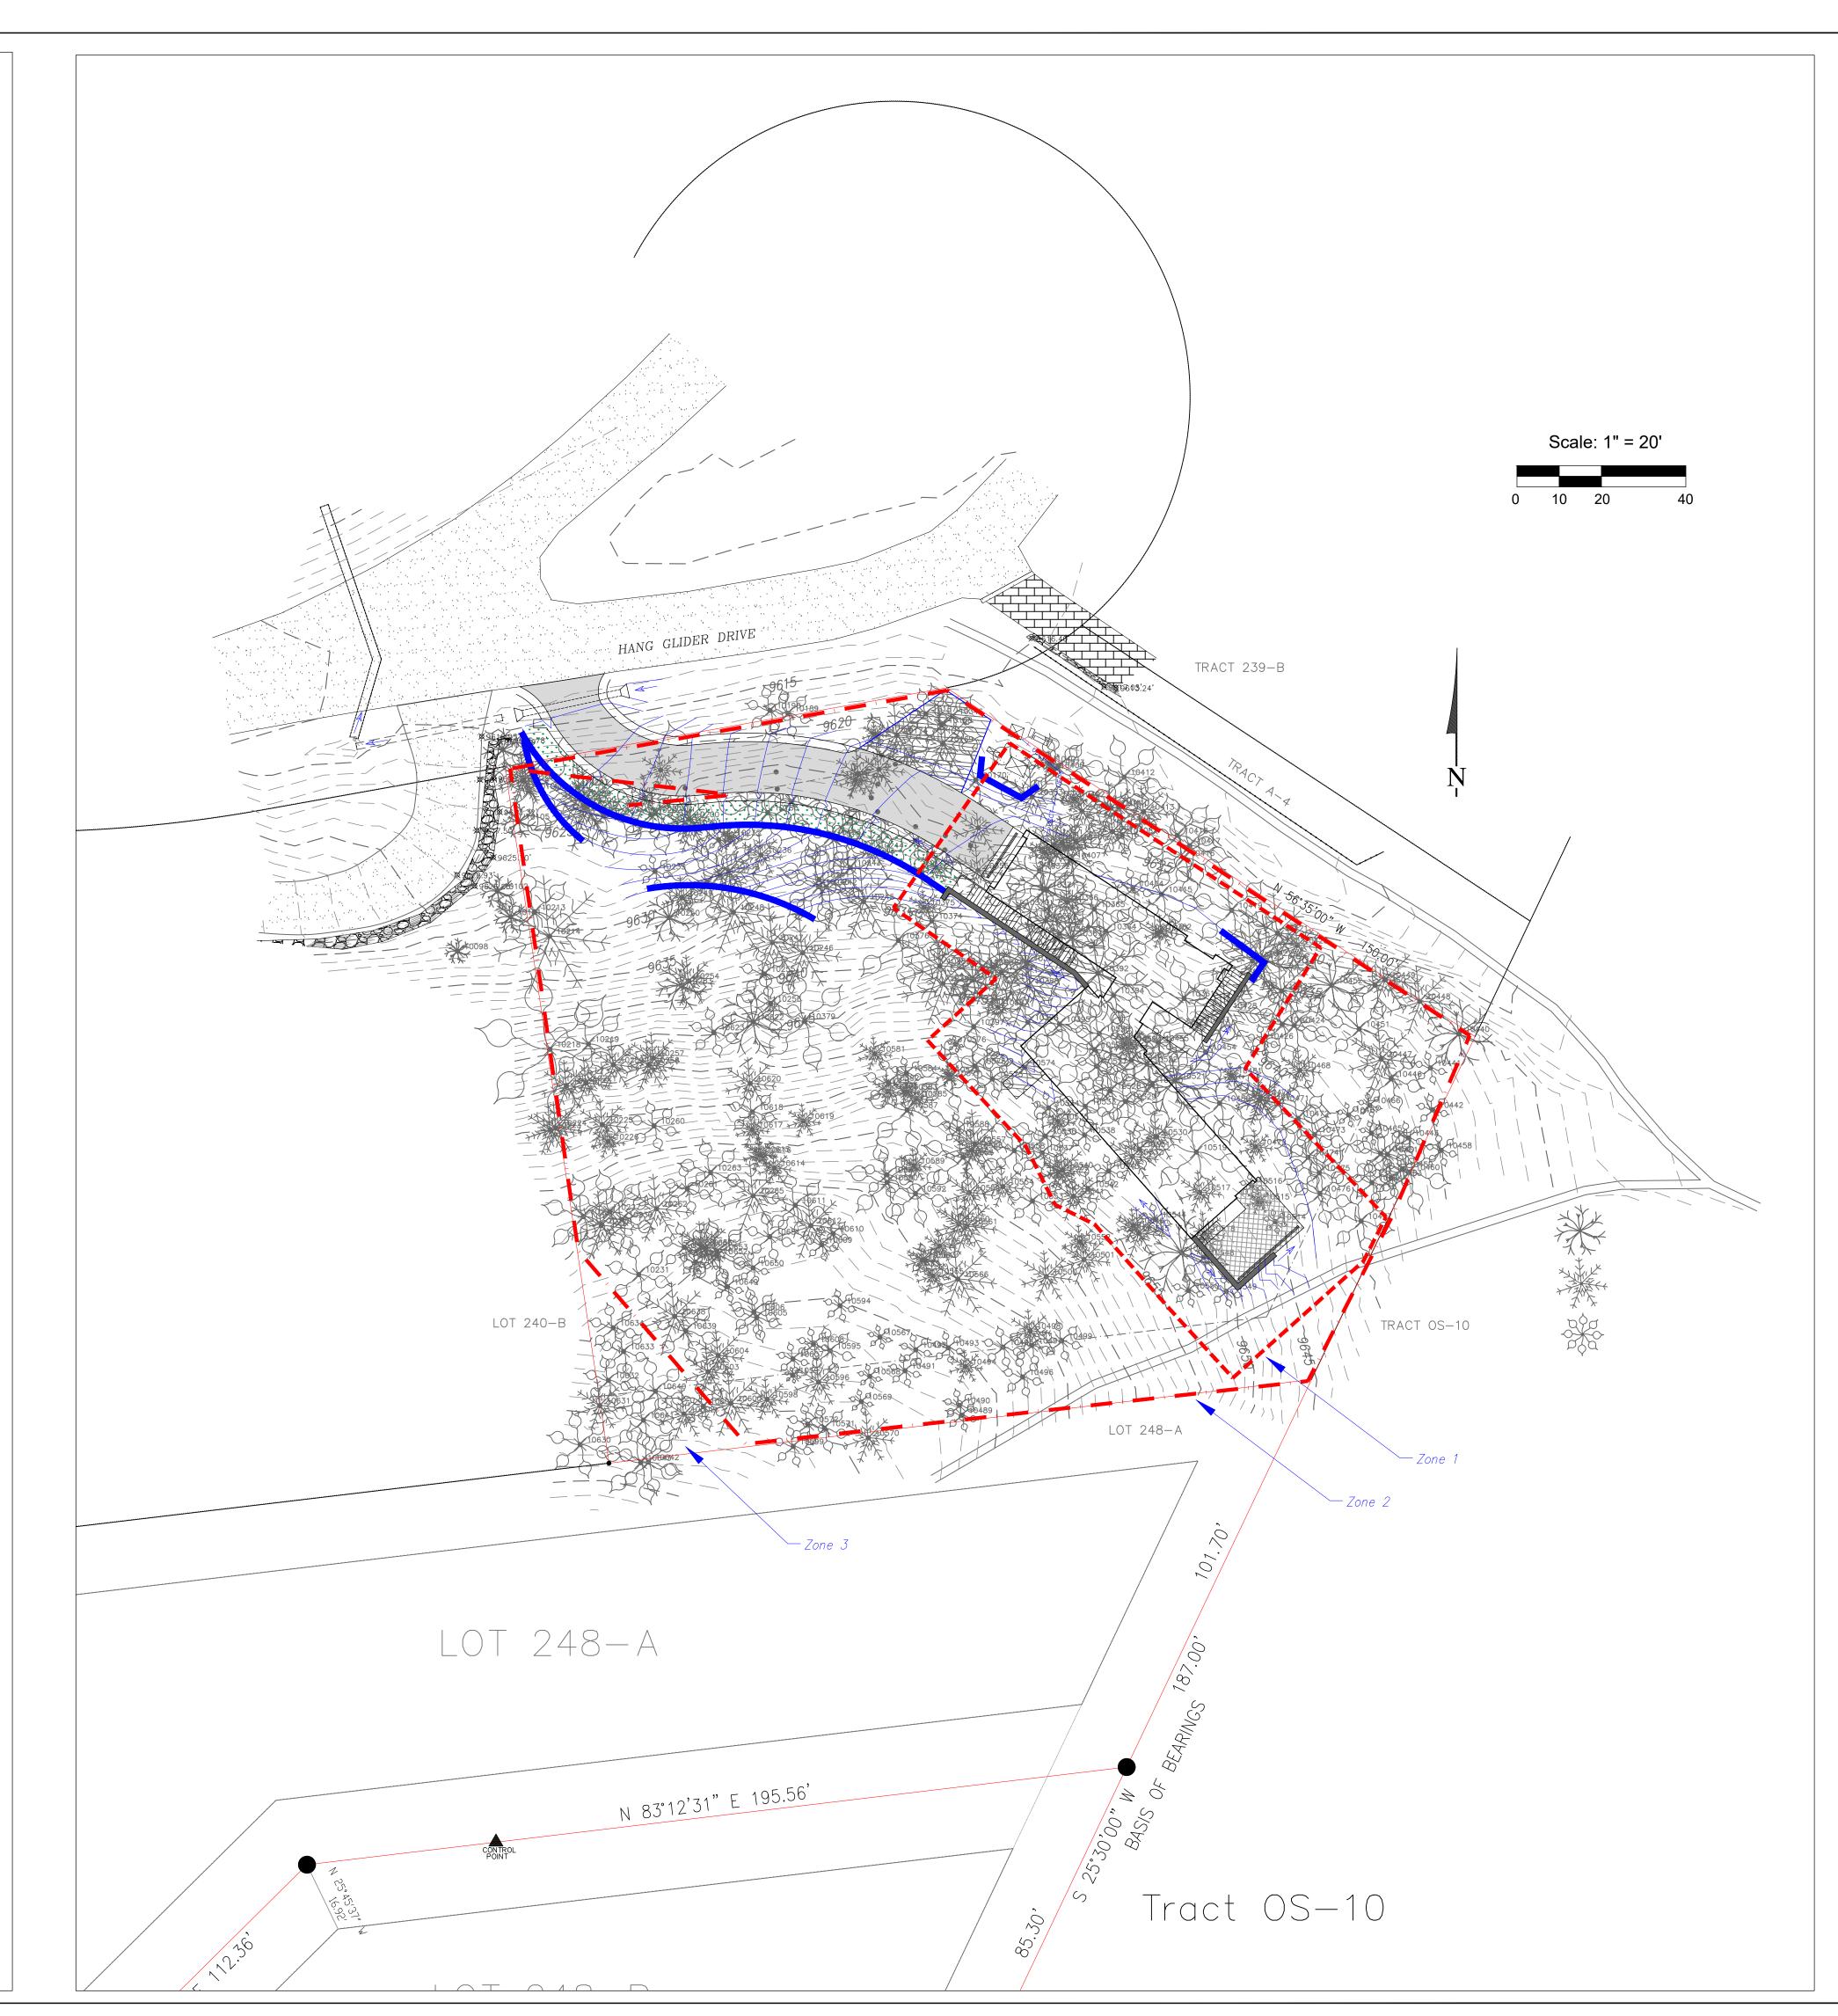

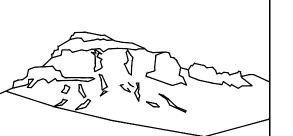

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DRB SUBMITTAL

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Lot 240A Hang Glider Lane Mtn. Village, CO



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> Fire Mitigation