### **Date:** November 26, 2023

By: Kristine Perpar, Architect
Sent to: Mountain Village Planning Staff
Re: Design Review Application Narrative
Property Address: Unit 1, Lot 1 - Knoll Estates, Mountain Village, CO 81435

Dear Mountain Village Design Review Board,

This narrative outlines a request for Design Review Board Initial Architecture and Site Review for Lot 1 - Unit 1, 100 Eagle Drive ("Unit 1") along with the relevant Criteria for Decision provided in the CDC.

### Requests:

1. Initial Architectural and Site Review Approval

### Project Overview:

Legal Description: UNIT 1 THE KNOLL ESTATES LOT 1 TELLURIDE MOUNTAIN VILLAGE FILING 13 ACC TO PLAT BK 1 PG 1023 AND 24 NKA TOWN OF MTN VILLAGE REC 10 6 95 BK 1 PG 1918 Address: 100 Eagle Drive Zoning: Multi-Family outside Village Center Existing Use: Vacant Proposed Use: Single-Family Detached Condominium Lot Size: 0.124 Acres

CDC Provision	Requirement	Proposed
Maximum Building Height	40'-0" (Gable)	39.96'
Maximum Avg. Building Height	35'-0"	25.31'
Maximum Lot Coverage	3,510.9 SF (65%)	2,396 SF
General Easement Setbacks	No GE	No GE
Roof Pitch		
Primary		7:12
Secondary		3:12
Exterior Materials		
Stone	35% Minimum	46%
Glazing	40% Maximum	23%
Parking	2 spaces	2 spaces

### DRB Specific Approvals:

Materials – Black Metal Fascia



# **GENERAL NOTES:**

CONTRACT DOCUMENTS: CONTRACT DOCUMENTS CONSIST OF THE AGREEMENT, GENERAL CONDITIONS, SPECIFICATIONS, DETAIL BOOK AND DRAWINGS, WHICH ARE COOPERATIVE AND CONTINUOUS. WORK INDICATED OR REASONABLY IMPLIED IN ANY ONE OF THE DOCUMENTS SHALL BE SUPPLIED AS THOUGH FULLY COVERED IN ALL. ANY DISCREPANCIES BETWEEN THE PARTS SHALL BE REPORTED TO THE ARCHITECT PRIOR TO THE COMMENCEMENT OF WORK. THESE DRAWINGS ARE PART OF THE CONTRACT DOCUMENTS FOR THIS PROJECT. THESE DRAWINGS ARE THE GRAPHIC ILLUSTRATION OF THE WORK TO BE ACCOMPLISHED. ALL DIMENSIONS NOTED TAKE PRECEDENCE OVER SCALED DIMENSIONS. DIMENSIONS NOTES WITH "N.T.S." DENOTES NOT TO SCALE.

### ORGANIZATION:

THE DRAWINGS FOLLOW A LOGICAL, INTERDISCIPLINARY FORMAT: ARCHITECTURAL DRAWINGS (A SHEETS), CIVIL DRAWINGS (C SHEETS), STRUCTURAL (S SHEETS), MECHANICAL AND PLUMBING (M SHEETS), ELECTRICAL (E SHEETS) AND LIGHTING (LTG SHEETS).

### CODE COMPLIANCE:

ALL WORK, MATERIALS AND ASSEMBLIES SHALL COMPLY WITH APPLICABLE STATE AND LOCAL CODES, ORDINANCES AND REGULATIONS. THE CONTRACTOR, SUBCONTRACTORS AND JOURNEYMEN OF THE APPROPRIATE TRADES SHALL PERFORM WORK TO THE HIGHEST STANDARDS OF CRAFTSMANSHIP AND IN ACCORDANCE WITH AIA DOCUMENT A201-SECTION 3. THE BUILDING INSPECTOR SHALL BE NOTIFIED BY THE CONTRACTOR WHEN THERE IS NEED OF INSPECTION AS REQUIRED BY THE INTERNATIONAL BUILDING CODE OR ANY LOCAL CODE OR ORDINANCE.

### INTENT:

THESE DOCUMENTS ARE INTENDED TO INCLUDE ALL LABOR, MATERIALS, EQUIPMENT AND SERVICES REQUIRED TO COMPLETE THE WORK DESCRIBED HEREIN.

### COORDINATION:

THE CONTRACTOR SHALL CAREFULLY STUDY AND COMPARE THE DOCUMENTS, VERIFY ACTUAL CONDITIONS AND REPORT ANY DISCREPANCIES, ERRORS OR OMISSIONS TO THE ARCHITECT IN A TIMELY MANNER. THE ARCHITECT SHALL CLARIFY OR PROVIDE REASONABLE ADDITIONAL INFORMATION REQUIRED FOR SUCCESSFUL EXECUTION. THE CONTRACTOR SHALL VERIFY AND COORDINATE ALL OPENINGS THROUGH FLOORS, CEILINGS AND WALLS WITH ALL ARCHITECTURAL, INTERIOR, STRUCTURAL, MECHANICAL AND PLUMBING, ELECTRICAL AND LIGHTING DRAWINGS. CONTRACTOR WILL ASSUME RESPONSIBILITY OF ITEMS REQUIRING COORDINATION AND RESOLUTION DURING THE BIDDING PROCESS.

### SUBSTITUTIONS:

ANY MATERIALS PROPOSED FOR SUBSTITUTION OF THOSE SPECIFIED OR THE CALLED-OUT-BY-TRADE-NAME IN THESE DOCUMENTS SHALL BE PRESENTED TO THE ARCHITECT FOR REVIEW. THE CONTRACTOR SHALL SUBMIT SAMPLES WHEN REQUIRED BY THE ARCHITECT AND SUCH SAMPLES SHALL BE REVIEWED BY THE ARCHITECT BEFORE THE WORK IS PERFORMED. WORK MUST CONFORM TO THE REVIEWED SAMPLES. ANY WORK WHICH DOES NOT CONFORM SHALL BE REMOVED AND REPLACED WITH WORK WHICH CONFORMS AT THE CONTRACTOR'S EXPENSE. SUBCONTRACTORS SHALL SUBMIT REQUESTS FOR REVIEW THROUGH THE GENERAL CONTRACTOR WHEN WORK IS LET THROUGH HIM OR HER. REQUIRED VERIFICATION AND SUBMITTALS TO BE MADE IN ADEQUATE TIME AS NOT TO DELAY WORK IN PROGRESS.

SHOP DRAWINGS: SHOP DRAWINGS SHALL BE SUBMITTED TO THE ARCHITECT FOR HIS OR HER REVIEW WHERE CALLED FOR ANYWHERE IN THESE DOCUMENTS. REVIEW SHALL SHOP DRAWINGS SHALL BE SUBMITTED TO THE ARCHITECT FOR HIS OR HER REVIEW WHERE CALLED FOR ANYWHERE IN THESE DOCUMENTS. REVIEW SHALL BE MADE BY THE ARCHITECT BEFORE WORK IS BEGUN, AND WORK SHALL CONFORM TO THE REVIEWED SHOP DRAWINGS, SUBJECT TO REPLACEMENT AS REQUIRED IN PARAGRAPH "SUBSTITUTIONS" ABOVE.

### SAFETY & PROTECTION OF WORK

THE CONTRACTOR SHALL BE RESPONSIBLE FOR THE SAFETY AND CARE OF ADJACENT PROPERTIES DURING CONSTRUCTION FOR COMPLIANCE WITH FEDERAL AND STATE O.S.H.A. REGULATIONS, AND FOR THE PROTECTION OF ALL WORK UNTIL IT IS DELIVERED COMPLETED TO THE OWNER.

# **PROJECT CODE INFORMATION**

ZONING:	MULTI-FAMILY RESIDENCE (KNOLL ESTATES LOT K1)	
BUILDING CODE:	IRC 2018 AND ALL APPLICABLE CODES AS REQUIRED BY THE TOWN OF MOUNTAIN VILLAGE	
	SECOND AMENDED AND RESTATED DECLARATION OF CONDOMINIUM FOR THE KNOLL ESTATES IN ADDITION TO ANY REQUIREMENTS BY THE TOWN OF MOUNTAIN VILLAGE	
DESCRIPTION:	MULTI-STORY DWELLING	
OCCUPANCY CLASSIFICATION:	R-3	
AUTOMATIC FIRE SPRINKLER:	MONITORED NFPA 13D SPRINKLER SYSTEM REQUIRED	
NATIONAL FIRE ALARM & SIGNALING CODE:	MONITORED NFPA 72 ALARM SYSTEM REQUIRED	
EMERGENCY ACCESS:	PROVIDE KNOX BOX FOR EMERGENCY ACCESS	
FIRE RESISTIVE RATING:	GARAGE - 1 HR, MECHANICAL - 1 HR	
CARBON MONOXIDE DETECTION:	PROVIDED MONITORED DETECTION IN ACCORDANCE WITH 2018 IFC 915.2.1	

# VICINITY MAP





LOT K1, KNOLL ESTATES 100 EAGLE DRIVE MOUNTAIN VILLAGE, CO

# **PROJECT INFORMATION**

PROPOSED FLOOP LOWER LEVEL GROUND LEVEL UPPER LEVEL

TOTAL FLOOR ARE GARAGE

TOTAL:

LOT AREA:

**BUILDING FOOTPR** ALLOWABLE PROPOSED

SEE SHEET A2.2 /

# PROJECT

OWNER: CHALETS AT KNOLI A CO LLC 3521 N 32ND TER HOLLYWOOD, FL 33

ARCHITECT: SHIFT ARCHITECT **KRISTINE PERPAR - ARCHITECT** 100 WEST COLORADO STE. 211 TELLURIDE, CO 81435 P. 970.275.0263 kristine@shift-architects.com

**GENERAL CONTRACTOR** HOINS CONSTRUCTION **BILL HOINS 137 SOCIETY DRIVE** TELLURIDE, CO 81435 P. 970.728.9371 hoinsoffice@gmail.com



OR AREA:	1,379.25 SF 1,287.77 SF 1,252.25 SF	MAX BUILDING ALLOWABLE PROPOSED	Ξ	40'-0" (35'-0" + 5'-0" GABLE RIDGE, CDC TABLE 3-3 FOOTNOTE 1) 39.96'
REA:	<u>3,919.27 SF</u> 552.25 SF	MAX AVERAGE ALLOWABLE		35'-0" (30'-0" + 5'-0" GABLE RIDGE, CDC TABLE 3-3 FOOTNOTE 1)
	<u>4,471.52 SF</u>	PROPOSED		25.31"
	.124 ACRES (5401.44 SF)	KNOLL ESTATE ALLOWABLE		NON-PERIMETER LOT (REFER TO MOUNTAIN VILLAGE)
RINT:	2,400 SF 2,396 SF	PARKING REQI	UIRED:	2 SPACES PROVIDED (2 REQUIRED) (2 ENCLOSED IN GARAGE)
A2.3 FOR MAXIM	UM BUILDING HEIGI	łT		
TEAM				
OLL ESTATES LLC	SURVEYOR: FOLEY ASSO 125 W. PACIF P.O. BOX 138	IC, SUITE B-1	HU DIN	IANICAL: GHES CONSULTING ENGINEERING, PA /ITRI MERRILL, P.E. LLURIDE, CO 81435
330212618	TELLURIDE, C P. 970.728.615 F. 970.728.605	CO 81435 53	P. 9 F. 7	970.239.1949 785.842.2492 hitri@hce-pa.com
TS, LLC R - ARCHITECT	<u>CIVIL</u> :		LAND	SCAPING:

UNCOMPAHGRE ENGINEERING LLC DAVID BALLODE P.E. PO BOX 3945 TELLURIDE, CO 81435 P. 970.729.0683 dballode@msn.com

STRUCTURAL: TELLURIDE ENGINEERING JACK GARDNER, P.E. PO BOX 4045 TELLURIDE, CO 81435 P. 970.728.5440 jgardner.pe@gmail.com

SHIFT ARCHITECTS, LLC **KRISTINE PERPAR - ARCHITECT** 100 WEST COLORADO STE. 211 TELLURIDE, CO 81435 P. 970.275.0263 kristine@shift-architects.com

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LTG1.1	EXTERIOR LIGHTING PL

## LEGENDS

GATION PLAN

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**PLAN** 

**ISHIF**<sup>7</sup> P.O. Box 3206 100 W. Colorado Suite 211 Telluride, Colorado 81435 p 970-728-8145 kristine@shift-architects.com www.shift-architects.com PROJECT ISSUE DATE: 12.05.23 DRB PRELIMINARY SUBMITTAL REVISIONS NO. DATE DESC.

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COVER SHEET

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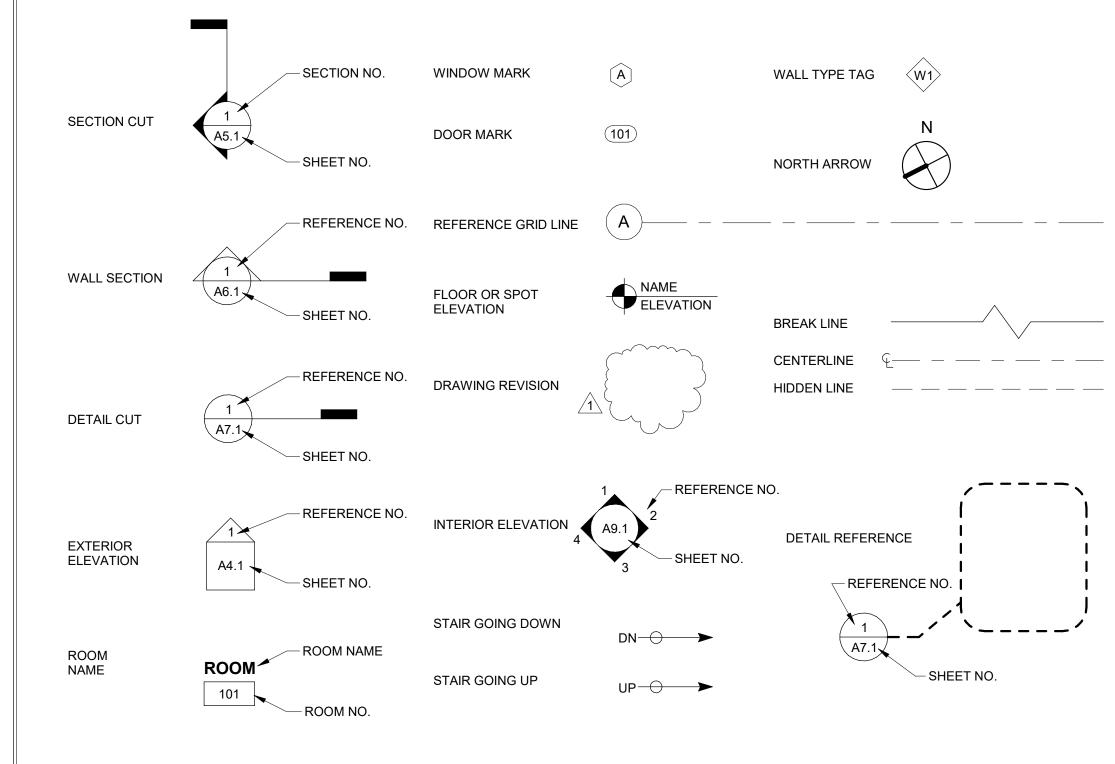
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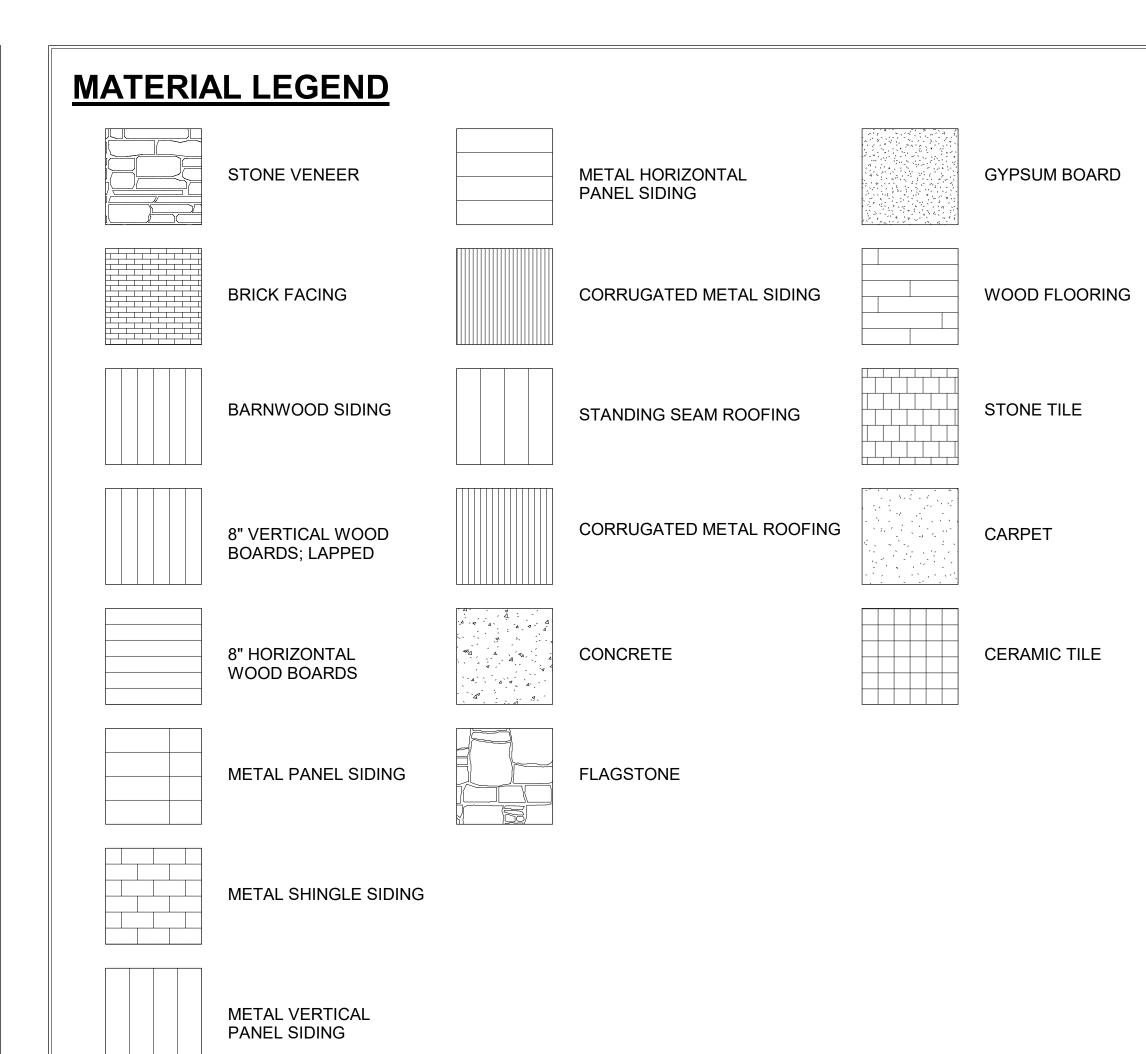
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# SYMBOL LEGEND






WALL LEGEND		DIMEN
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		2. WA
	WOOD STUD FRAMING EXTERIOR	3. DIN AN
		4. INT CO
······································	WOOD STUD FRAMING	
	INTERIOR PARTITION	×
	1 HOUR FIRE WALL	
	STONE VENEER	
<u> </u>	WOOD SIDING	PROJE
		ACTU
	CONCRETE FOUNDATION	T.O. Slab Gro

	VIATIONS
AC	Acres
AFF	Above Finished Floor
AGG	Aggregate
AL	Aluminum
BM	Bench Mark
BSN	Basin
BTH	Bath
CL	Centre Line
CJ	Control Join
CLST	Closet
CP	Carpet
CT	Ceramic Tile
DIA	Diameter
DP	Downpipe
DW	Dishwasher
EX	Existing
FF	Finished Floor
FHR FP	Fire Hose Reel
GAL	Flue Pipe Galvanized
GAL	Ground Line
GE	Ground Fault Circuit Interrupter
GPO	General Power Outlet
IBC	International Building Code
MDF	Medium Density Fibreboard
MR	Metal Roofing
MSB	Main Switch Board
NTS	Not To Scale
PFC	Parallel Flanged Steel Channel
PL	Plastic Laminate
PT	Paint
RC	Reinforced Concrete
REF	Refrigerator
RL	Reduced Level
S	Sanitary Drainage Pipe
SHR	Shower
SK	Sink
SN	Stone
SS	Stainless Steel
ST	S Trap
STF	Steel Trowel Finished Concrete
SW	Stormwater Drainage Line
T&G	Tongue and Grooved
TO TPH	Top Of Toilet Paper Holder
TR	Tiled Roofing
TSF	Timber Strip Floor
TYP	Typical
U	Urinal
UOS	Unless Otherwise Specified
V	Valley
VIF	Verify In Field
VP	Vent Pipe
WC	Water Closet (Toilet)
WM	Washing Machine
WPM	Water Proof Membrane

# ISIONING LEGEND

RIDS ALIGN WITH OUTSIDE FACE OF FOUNDATION WALL AND OUTSIDE ACE OF STUD AT EXTERIOR STRUCTURAL FRAME WALL.

- ALLS AND PARTITIONS SHOWN IN PLAN INCLUDE FINISH MATERIALS.
- MENSIONS ARE SHOWN FROM GRID TO GRID, GRID TO FACE OF STUD, ND FACE OF STUD TO FACE OF STUD AT INTERIOR PARTITIONS, TYPICAL.
- ITERIOR PARTITIONS FLUSH FACE TO FACE WITH THEIR EXTERIOR OUNTERPARTS, TYPICAL.

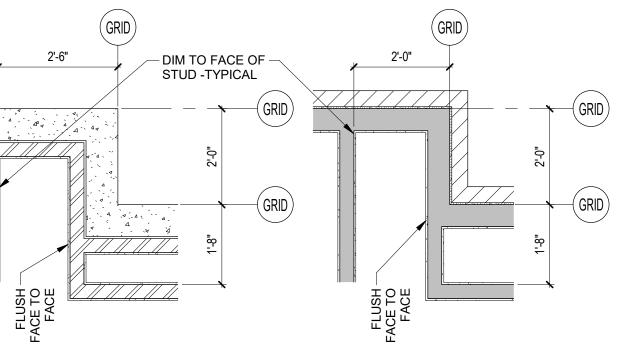

# ECT DATUM LEGEND

UAL ELEVATION ABOVE SEA LEVEL = PROJECT 0'-0"



ound LvI T.O. Ply Ground LvI T.O. Gyp Ground LvI

XXXX.X' USGS 0'-0" PROJECT ELEV

100 W. Colorado Suite 211 Telluride, Colorado 81435 p 970-728-8145 kristine@shift-architects.com www.shift-architects.com PROJECT ISSUE DATE: 12.05.23 DRB PRELIMINARY SUBMITTAL REVISIONS NO. DATE DESC. N S ATE ά S I , MOUNTAIN VILLAGE, ( \_ ESTATES LOT 1 TELLI >G 1918 S ш KNOL DRIVE, N KNOLL I 5 BK 1 PC 100 EAGLE D UNIT 1 THE P REC 10 6 95

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SHEET NUMBER

LEGENDS



### GENERAL CIVIL ENGINEERING NOTES:

1. THE EXISTING UTILITY LINES SHOWN ON THE PLANS ARE APPROXIMATE. AT LEAST TWO (2) FULL WORKING DAYS PRIOR TO TO COMMENCING CONSTRUCTION, THE CONTRACTOR SHALL CONTACT THE UTILITY NOTIFICATION CENTER OF COLORADO @ 1-800-922-1987 OR 811 TO GET ALL UTILITIES LOCATED. IF ANY OF THESE UNDERGROUND UTILITIES ARE IN CONFLICT WITH THE CONSTRUCTION PLANS, THE CONTRACTOR SHALL NOTIFY THE ENGINEER AND WORK WITH THE ENGINEER TO FIND A SOLUTION BEFORE THE START OF CONSTRUCTION.

INSTALLATION AND SEPARATION REQUIREMENTS SHALL BE COORDINATED WITH THE INDIVIDUAL UTILITY PROVIDERS.

THE UTILITY PROVIDERS ARE: SEWER, WATER, CABLE TV AND FIBEROPTIC: TOWN OF MOUNTAIN VILLAGE NATURAL GAS: BLACK HILLS ENERGY POWER: SAN MIGUEL POWER TELEPHONE: CENTURY LINK

2. PRIOR TO BEGINNING ANY CONSTRUCTION ACTIVITIES, ALL NECESSARY PERMITS SHALL BE OBTAINED BY THE OWNER OR CONTRACTOR.

3. IT IS THE CONTRACTOR'S RESPONSIBILITY TO INSURE THAT EXCAVATED SLOPES ARE SAFE AND COMPLY WITH OSHA REQUIRIEMENTS. REFER TO THE SITE—SPECIFIC REPORT FOR THIS PROJECT FOR ADDITIONAL INFORMATION..

4. ALL TRENCHES SHALL BE ADEQUATELY SUPPORTED OR LAID BACK PER OSHA REGULATIONS.

5. ALL MATERIALS AND CONSTRUCTION SHALL BE IN CONFORMANCE WITH THE TOWN OF MOUNTAIN VILLAGE DESIGN STANDARDS LATEST EDITION. ALL CONSTRUCTION WITHIN EXISTING STREET OR ALLEY RIGHT—OF—WAY SHALL BE SUBJECT TO TOWN OF MOUNTAIN VILLAGE INSPECTION.

6. THE CONTRACTOR SHALL HAVE ONE COPY OF THE STAMPED PLANS ON THE JOB SITE AT ALL TIMES.

7. THE CONTRACTOR SHALL NOTIFY THE TOWN 48 HOURS PRIOR TO THE START OF CONSTRUCTION.

8. THE CONTRACTOR IS RESPONSIBLE FOR IMPLEMENTING AND MAINTAINING EROSION AND SEDIMENT CONTROL MEASURES AT ALL TIMES DURING CONSTRUCTION. THE ADJOINING ROADWAYS SHALL BE FREE OF DEBRIS AT THE END OF CONSTRUCTION ACTIVITIES EACH DAY.

9. THE CONTRACTOR SHALL PROVIDE, ERECT AND MAINTAIN PROPER TRAFFIC CONTROL DEVICES UNTIL THE SITE IS OPEN TO TRAFFIC. ANY TRAFFIC CLOSURES MUST BE COORDINATED WITH THE TOWN OF MOUNTAIN VILLAGE.

10. ALL DAMAGE TO PUBLIC STREETS AND ROADS, INCLUDING HAUL ROUTES, TRAILS, OR STREET IMPROVEMENTS, OR TO PRIVATE PROPERTY, SHALL BE REPAIRED AT THE SOLE EXPENSE OF THE CONTRACTOR TO THE ORIGINAL CONDITIONS.

11. WHEN AN EXISTING ASPHALT STREET IS CUT, THE STREET MUST BE RESTORED TO A CONDITION EQUAL TO OR BETTER THAN ITS ORIGINAL CONDITION. THE FINISHED PATCH SHALL BLEND SMOOTHLY INTO THE EXISTING SURFACE. ALL LARGE PATCHES SHALL BE PAVED WITH AN ASPHALT LAY—DOWN MACHINE.

12. IF DEWATERING IS REQUIRED, THE CONTRACTOR SHALL NOTIFY THE ENGINEER. ANY DISCHARGE REQUIREMENTS SHALL BE COORDINATED WITH THE TOWN OF MOUNTAIN VILLAGE.

13. CONTRACTOR SHALL NOTIFY ALL RESIDENTS IN WRITING 24 HOURS PRIOR TO ANY SHUT-OFF IN SERVICE. THE NOTICES MUST HAVE CONTRACTOR'S PHONE NUMBER AND NAME OF CONTACT PERSON, AND EMERGENCY PHONE NUMBER FOR AFTER HOURS CALLS. ALL SHUT-OFF'S MUST BE APPROVED BY THE TOWN AND TOWN VALVES AND APPURTENANCES SHALL BE OPERATED BY TOWN PERSONNEL.

14. CONTRACTOR SHALL KEEP SITE CLEAN AND LITTER FREE (INCLUDING CIGARETTE BUTTS) BY PROVIDING A CONSTRUCTION DEBRIS TRASH CONTAINER AND A BEAR-PROOF POLY-CART TRASH CONTAINER, WHICH IS TO BE LOCKED AT ALL TIMES.

15. CONTRACTOR MUST BE AWARE OF ALL TREES TO REMAIN PER THE DESIGN AND APPROVAL PROCESS AND PROTECT THEM ACCORDINGLY.

16. THE CONTRACTOR SHALL PROVIDE UNDERGROUND UTILITY AS-BUILTS TO THE TOWN.

17. ALL STRUCTURAL FILL UNDER HARDSCAPE OR ROADS MUST BE COMPACTED TO 95% MODIFIED PROCTOR (MIN.) AT PLUS OR MINUS 2% OF THE OPTIMUM MOISTURE CONTENT. NON—STRUCTURAL FILL SHALL BE PLACED AT 90% (MIN.) MODIFIED PROCTOR.

18. UNSUITABLE MATERIAL SHALL BE REMOVED AS REQUIRED BY THE SOILS ENGINEER. ALL MATERIALS SUCH AS LUMBER, LOGS, BRUSH, TOPSOIL OR ORGANIC MATERIALS OR RUBBISH SHALL BE REMOVED FROM ALL AREAS TO RECEIVE COMPACTED FILL.

19. NO MATERIAL SHALL BE COMPACTED WHEN FROZEN.

20. NATIVE TOPSOIL SHALL BE STOCKPILED TO THE EXTENT FEASIBLE ON THE SITE FOR USE ON AREAS TO BE REVEGETATED.

21. THE CONTRACTOR SHALL BE RESPONSIBLE FOR DUST ABATEMENT AND EROSION CONTROL MEASURES DEEMED NECESSARY BY THE TOWN, IF CONDITIONS WARRANT THEM.

22. ALL DISTURBED GROUND SHALL BE RE-SEEDED WITH A TOWN-APPROVED SEED MIX. REFER TO THE LANDSCAPE PLAN.


23. THE CONTRACTOR IS REQUIRED TO PROTECT ALL EXISTING SURVEY MONUMENTS AND PROPERTY CORNERS DURING GRADING AND CONSTRUCTION.

24. ALL UNDERGROUND PIPE SHALL BE PROTECTED WITH BEDDING TO PROTECT THE PIPE FROM BEING DAMAGED.

25. HOT TUBS SHALL DRAIN TO THE SANITARY SEWER (OR PUMPED TO AA CLEAN-OUT).

26. THE UTILITY PLAN DEPICTS FINAL UTILITY LOCATIONS BUT HAS BEEN COMPLETED AT A PRELIMINARY STAGE. CONTRACTOR SHALL VERIFY ALIGNMENTS WITH THE ARCHITECT PRIOR TO CONSTRUCTION.


Uncompahgre Engineering, LLC
P.O. Box 3945 Telluride, CO 81435 970-729-0683
SUBMISSIONS: hoa submittal 2023–10–24 drb submittal 2023–11–29
Lot 1 Knoll Estates Mtn. Village, CO
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CONTRACTOR TO REVIEW AND COMPARE ALL CHAPTERS AND INTERDISCIPLINARY DRAWINGS AND REPORT ANY DISCREPANCIES TO THE ARCHITECT PRIOR TO ANY FIELD WORK BEING DONE IN ACCORDANCE WITH AIA DOCUMENT A201
Notes
C1

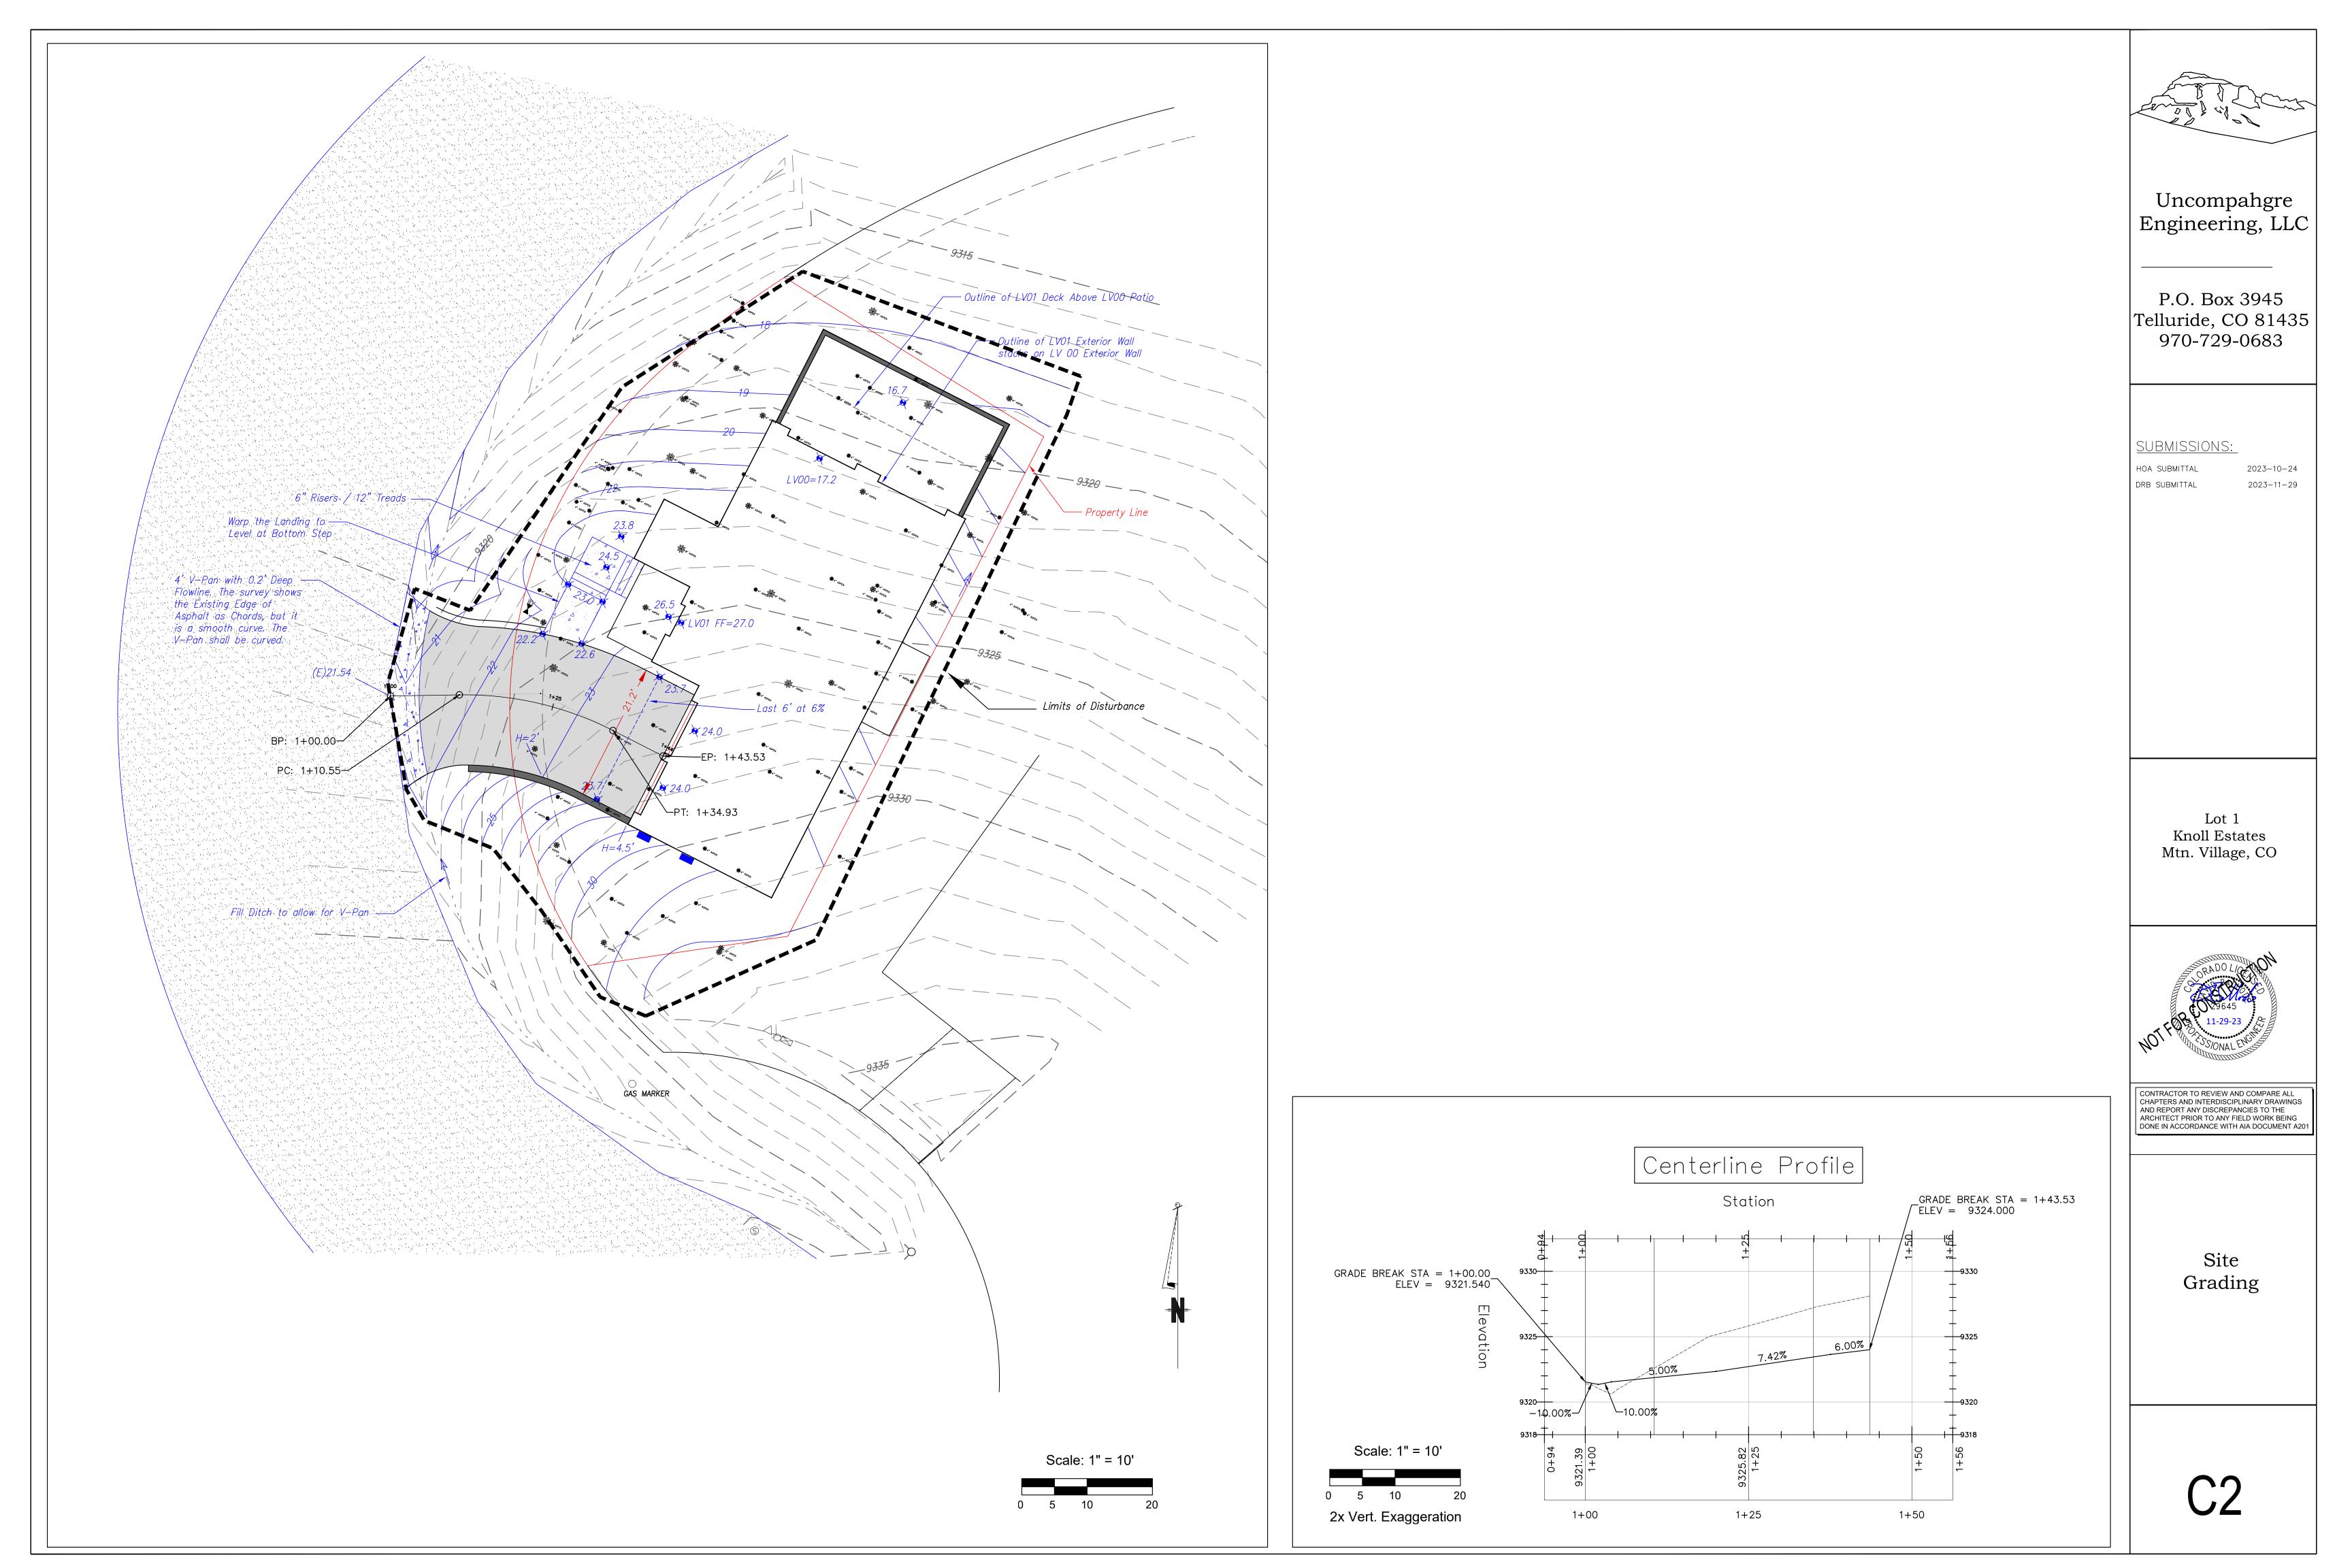






Erosion Logs/Straw Wattles Install Silt Fence on the downhill side of disturbance. Maintain throughout job. No surface water will be allowed to discharge the site without being directed through a silt fence or straw wattle. Post Contractor's Sign with \_\_\_\_\_ Emergency Contact Number Construction Parking will be On-Site or Off Asphalt. Coordinate with Public Works. Open and Close Panels at Access at the Beginning and — End of Each Work Day Construction Dumpster — < 🔶 (

The Contractor may Modify this Plan, but the New Plan must be Coordinated and Approved by the Town of Mountain Village.

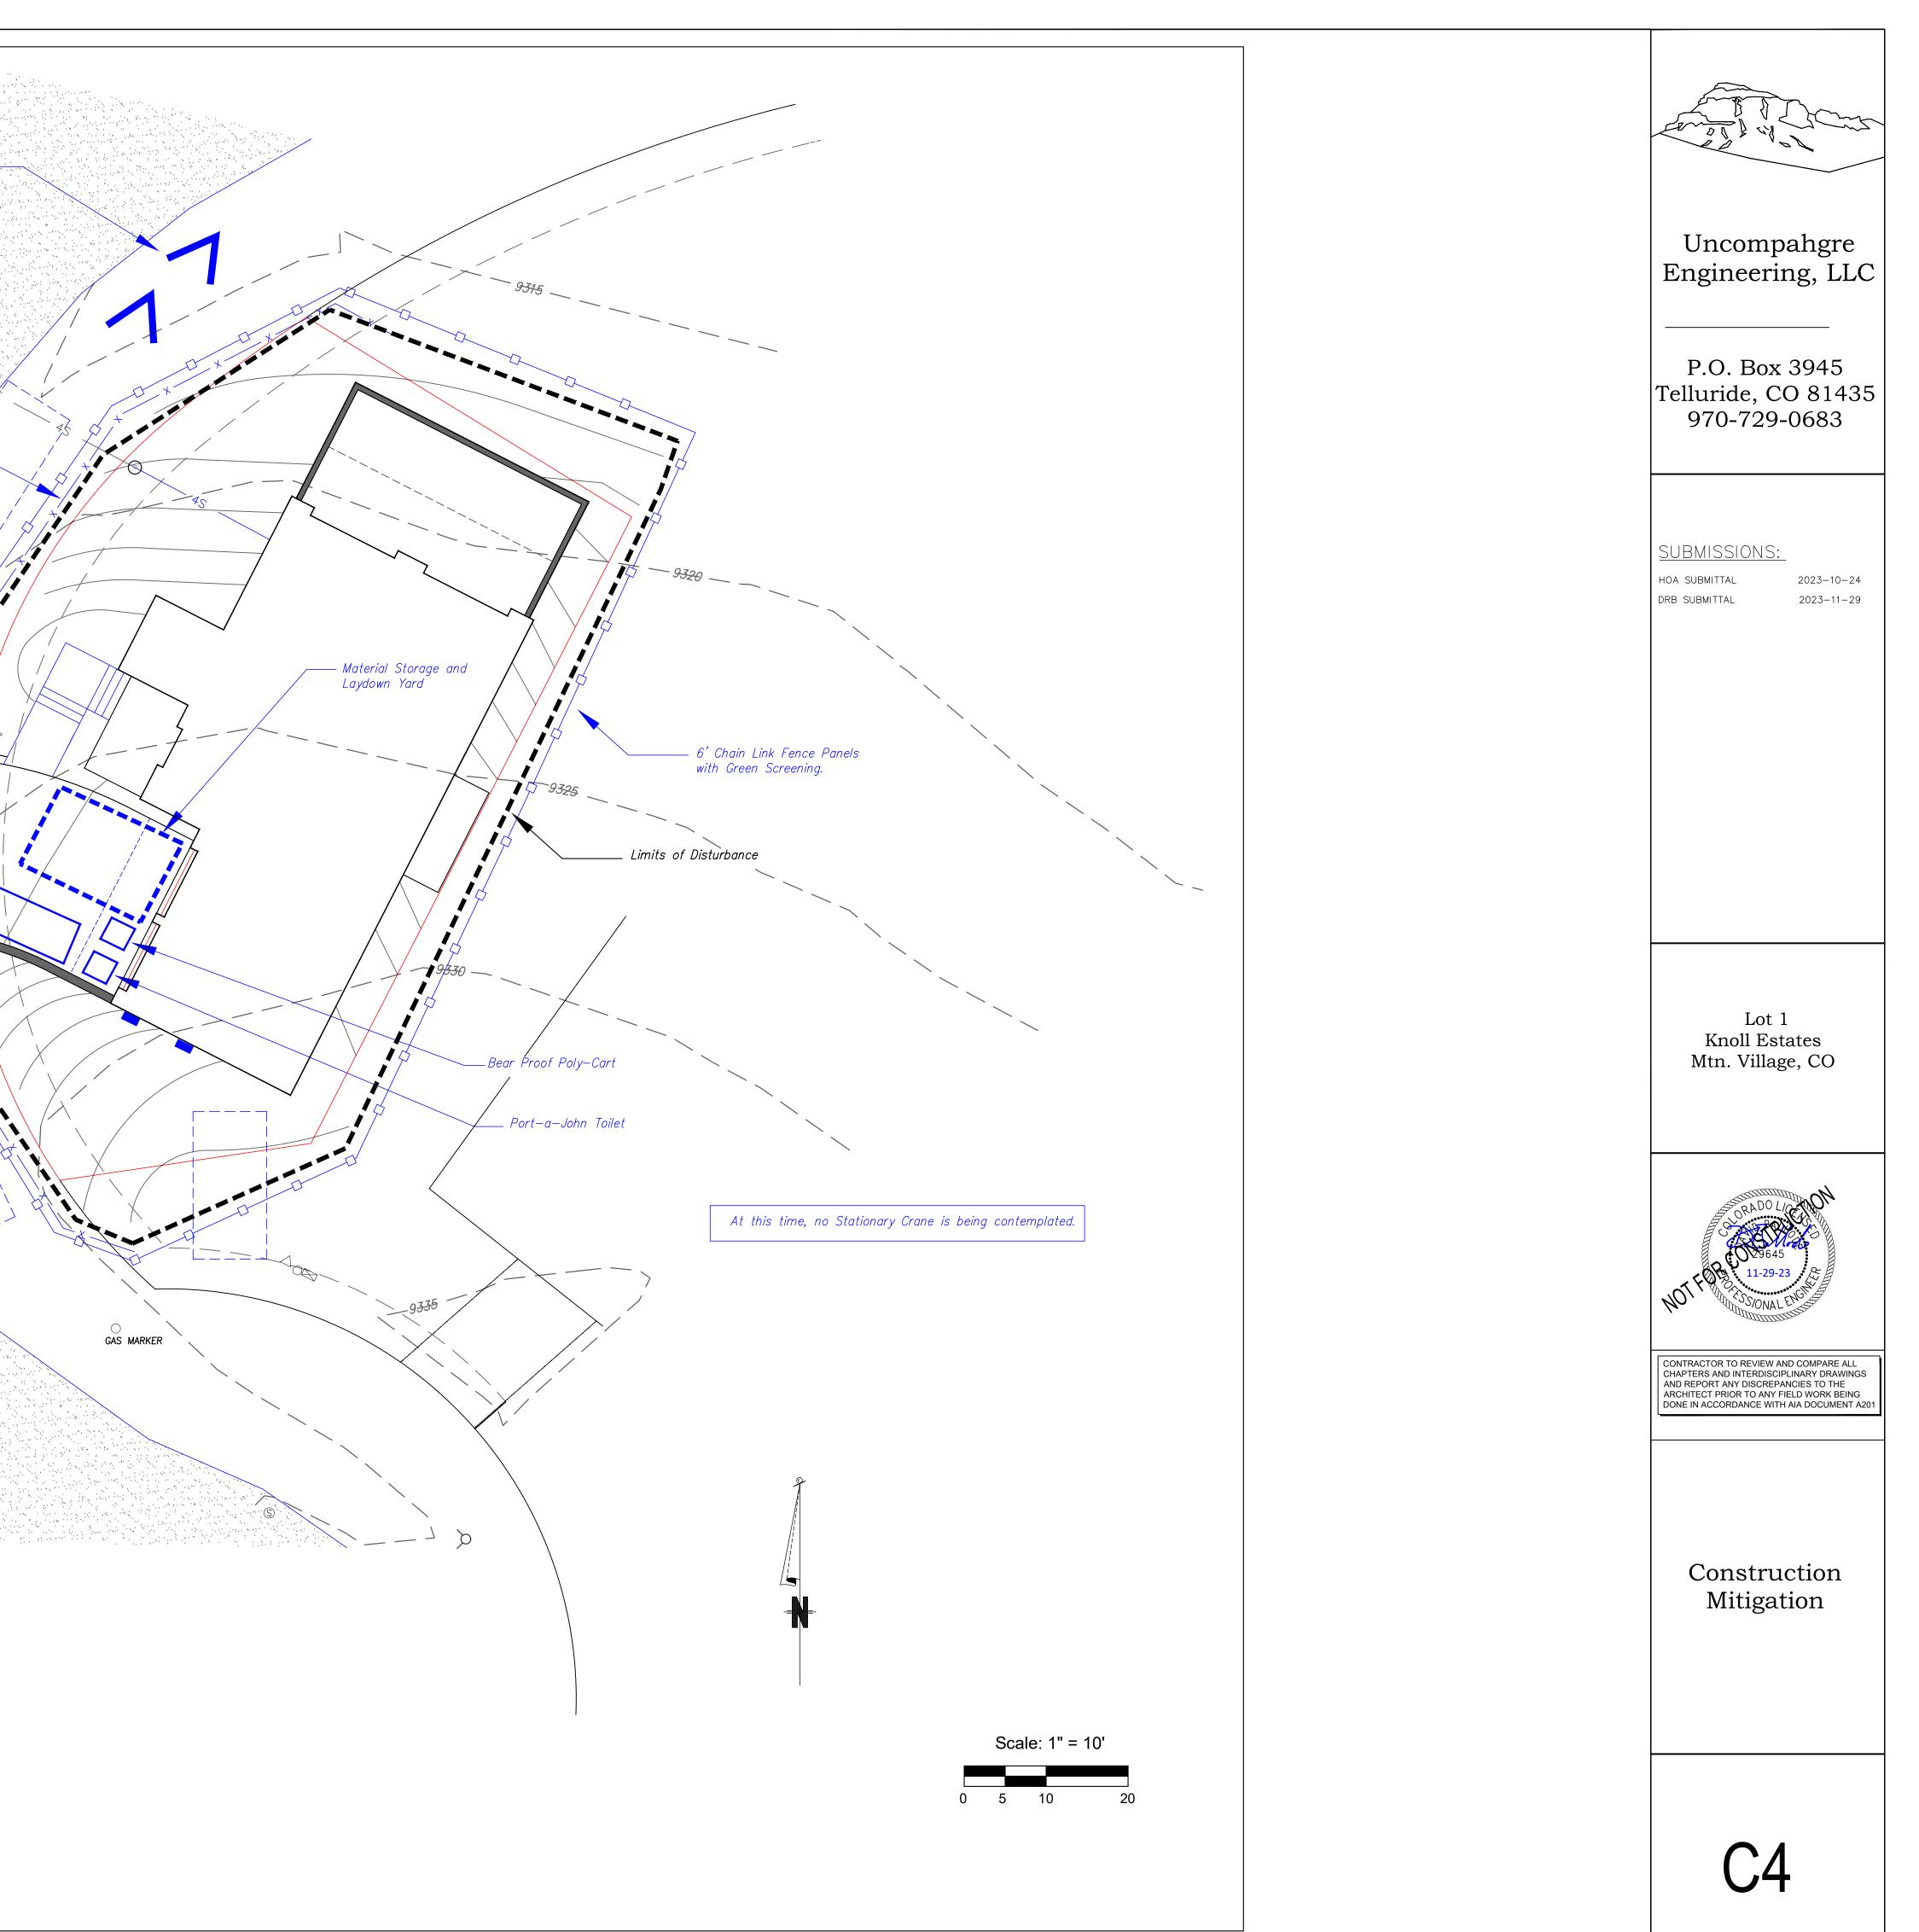

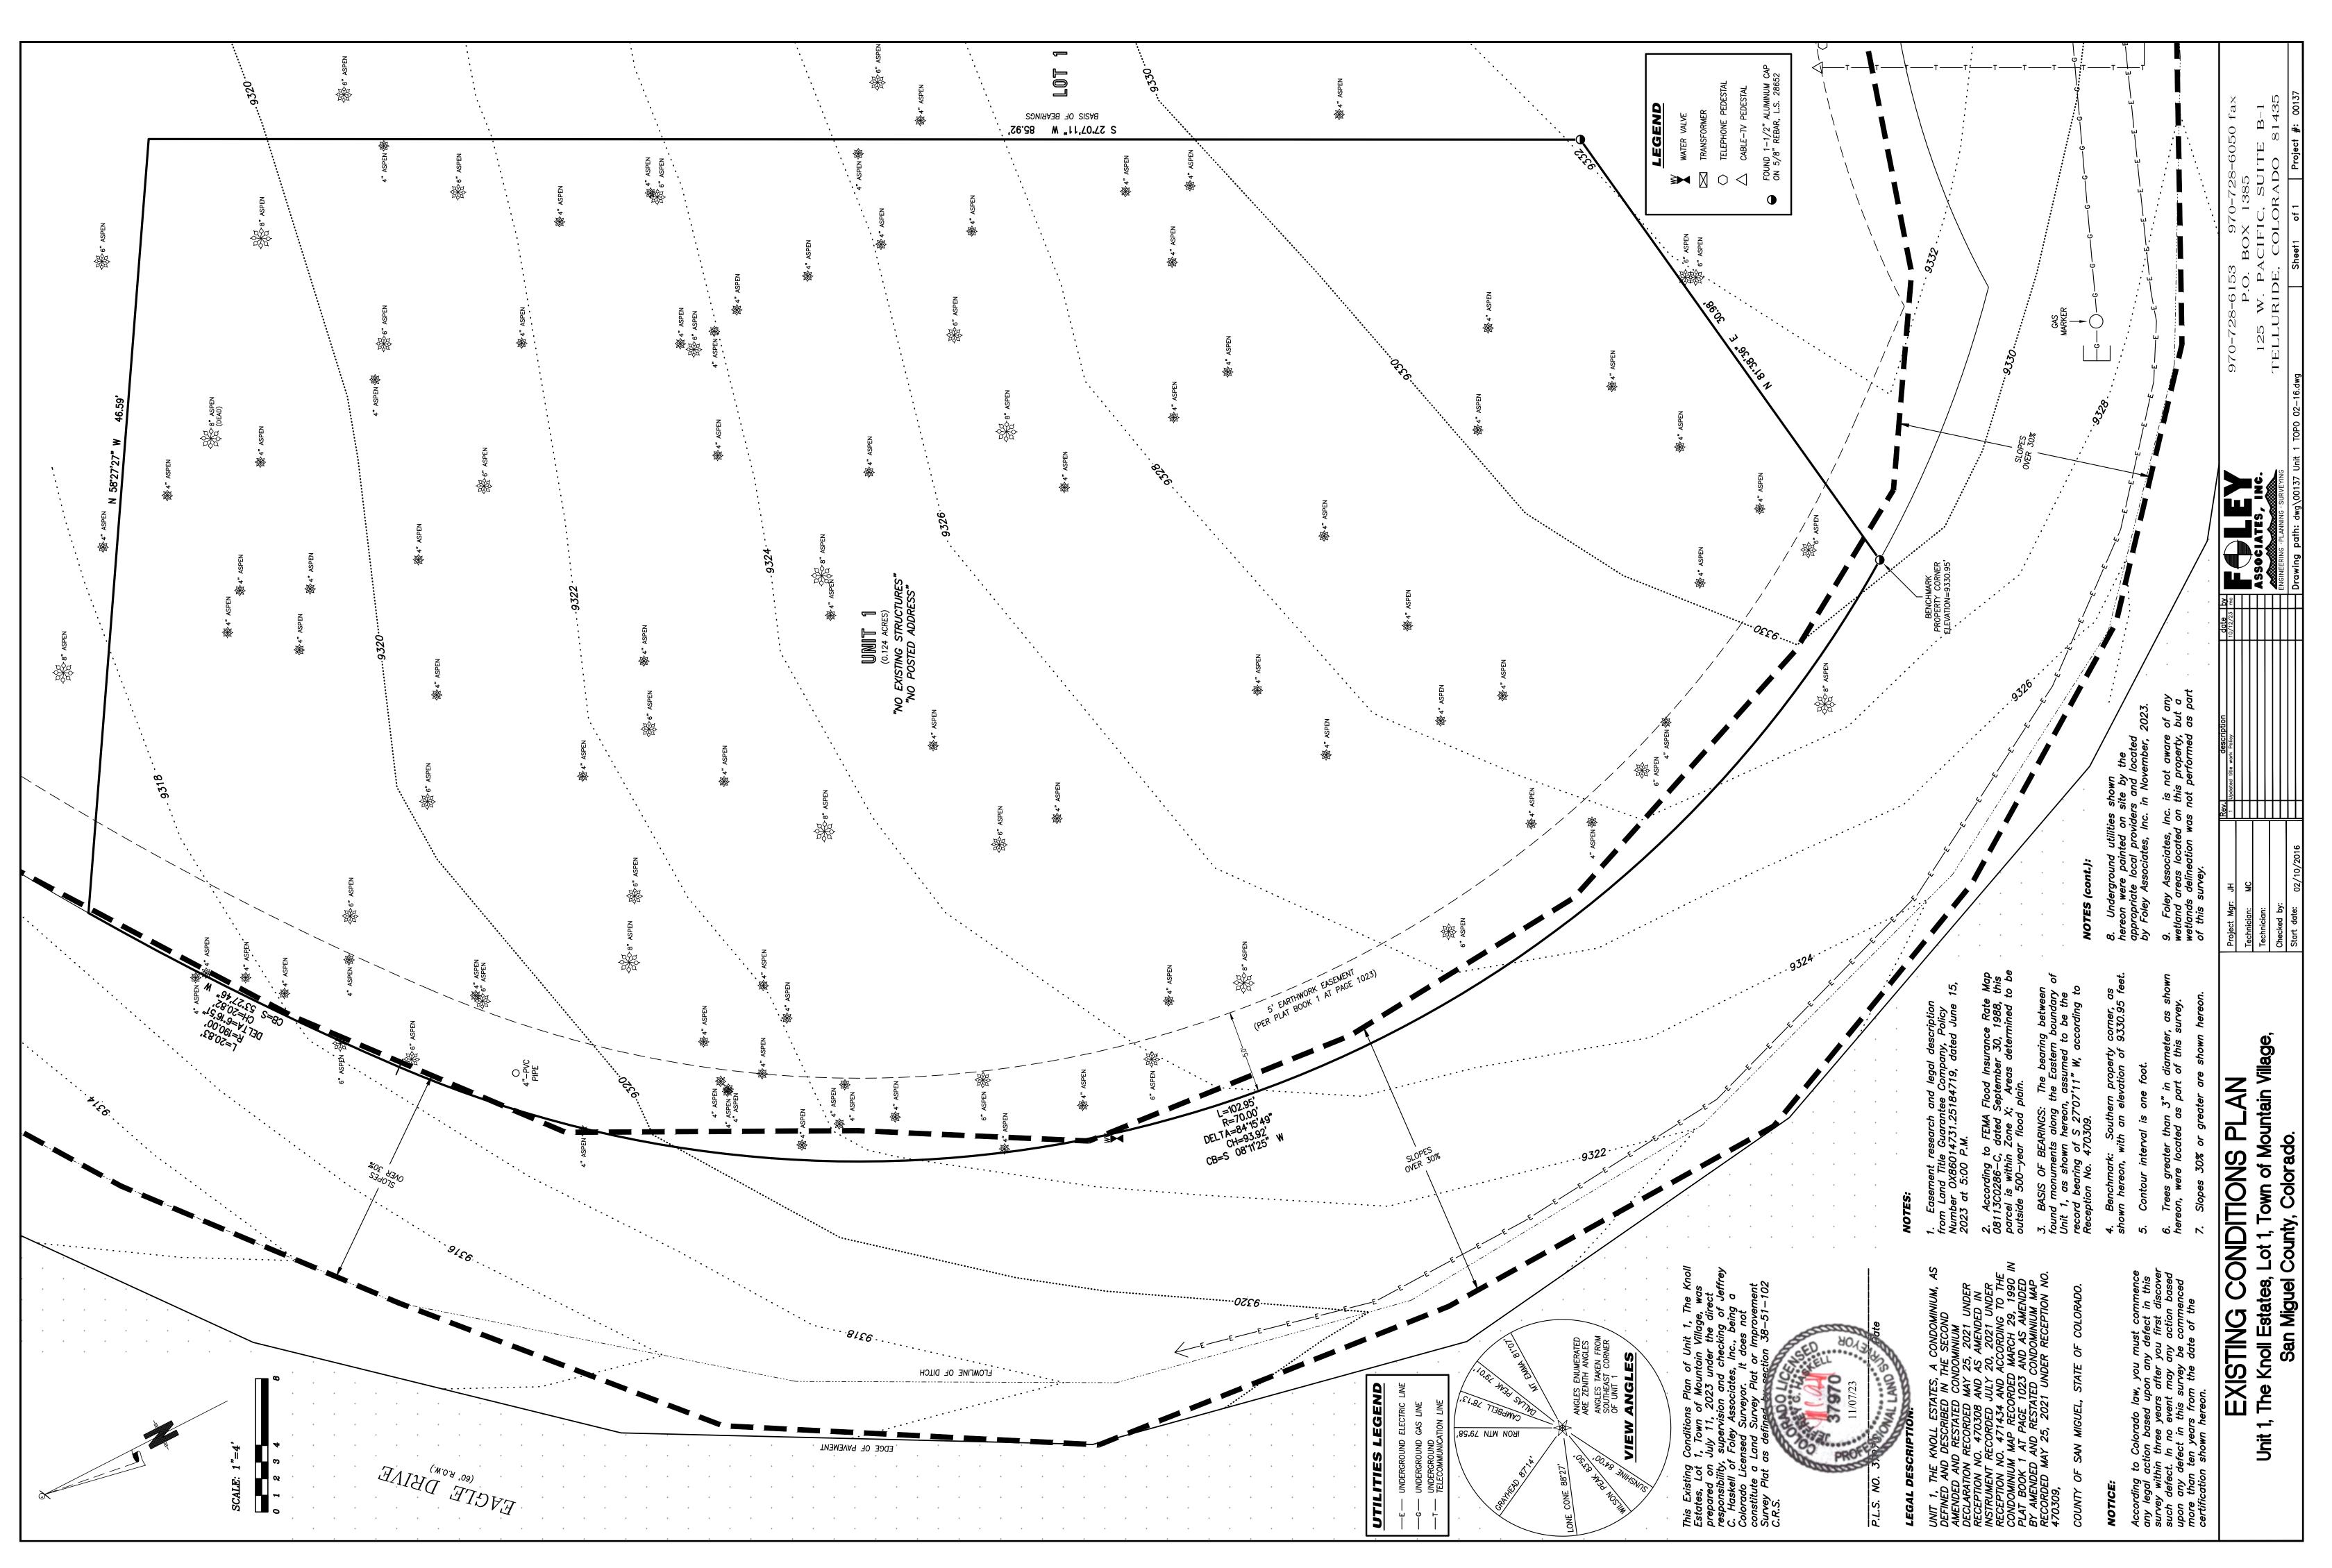

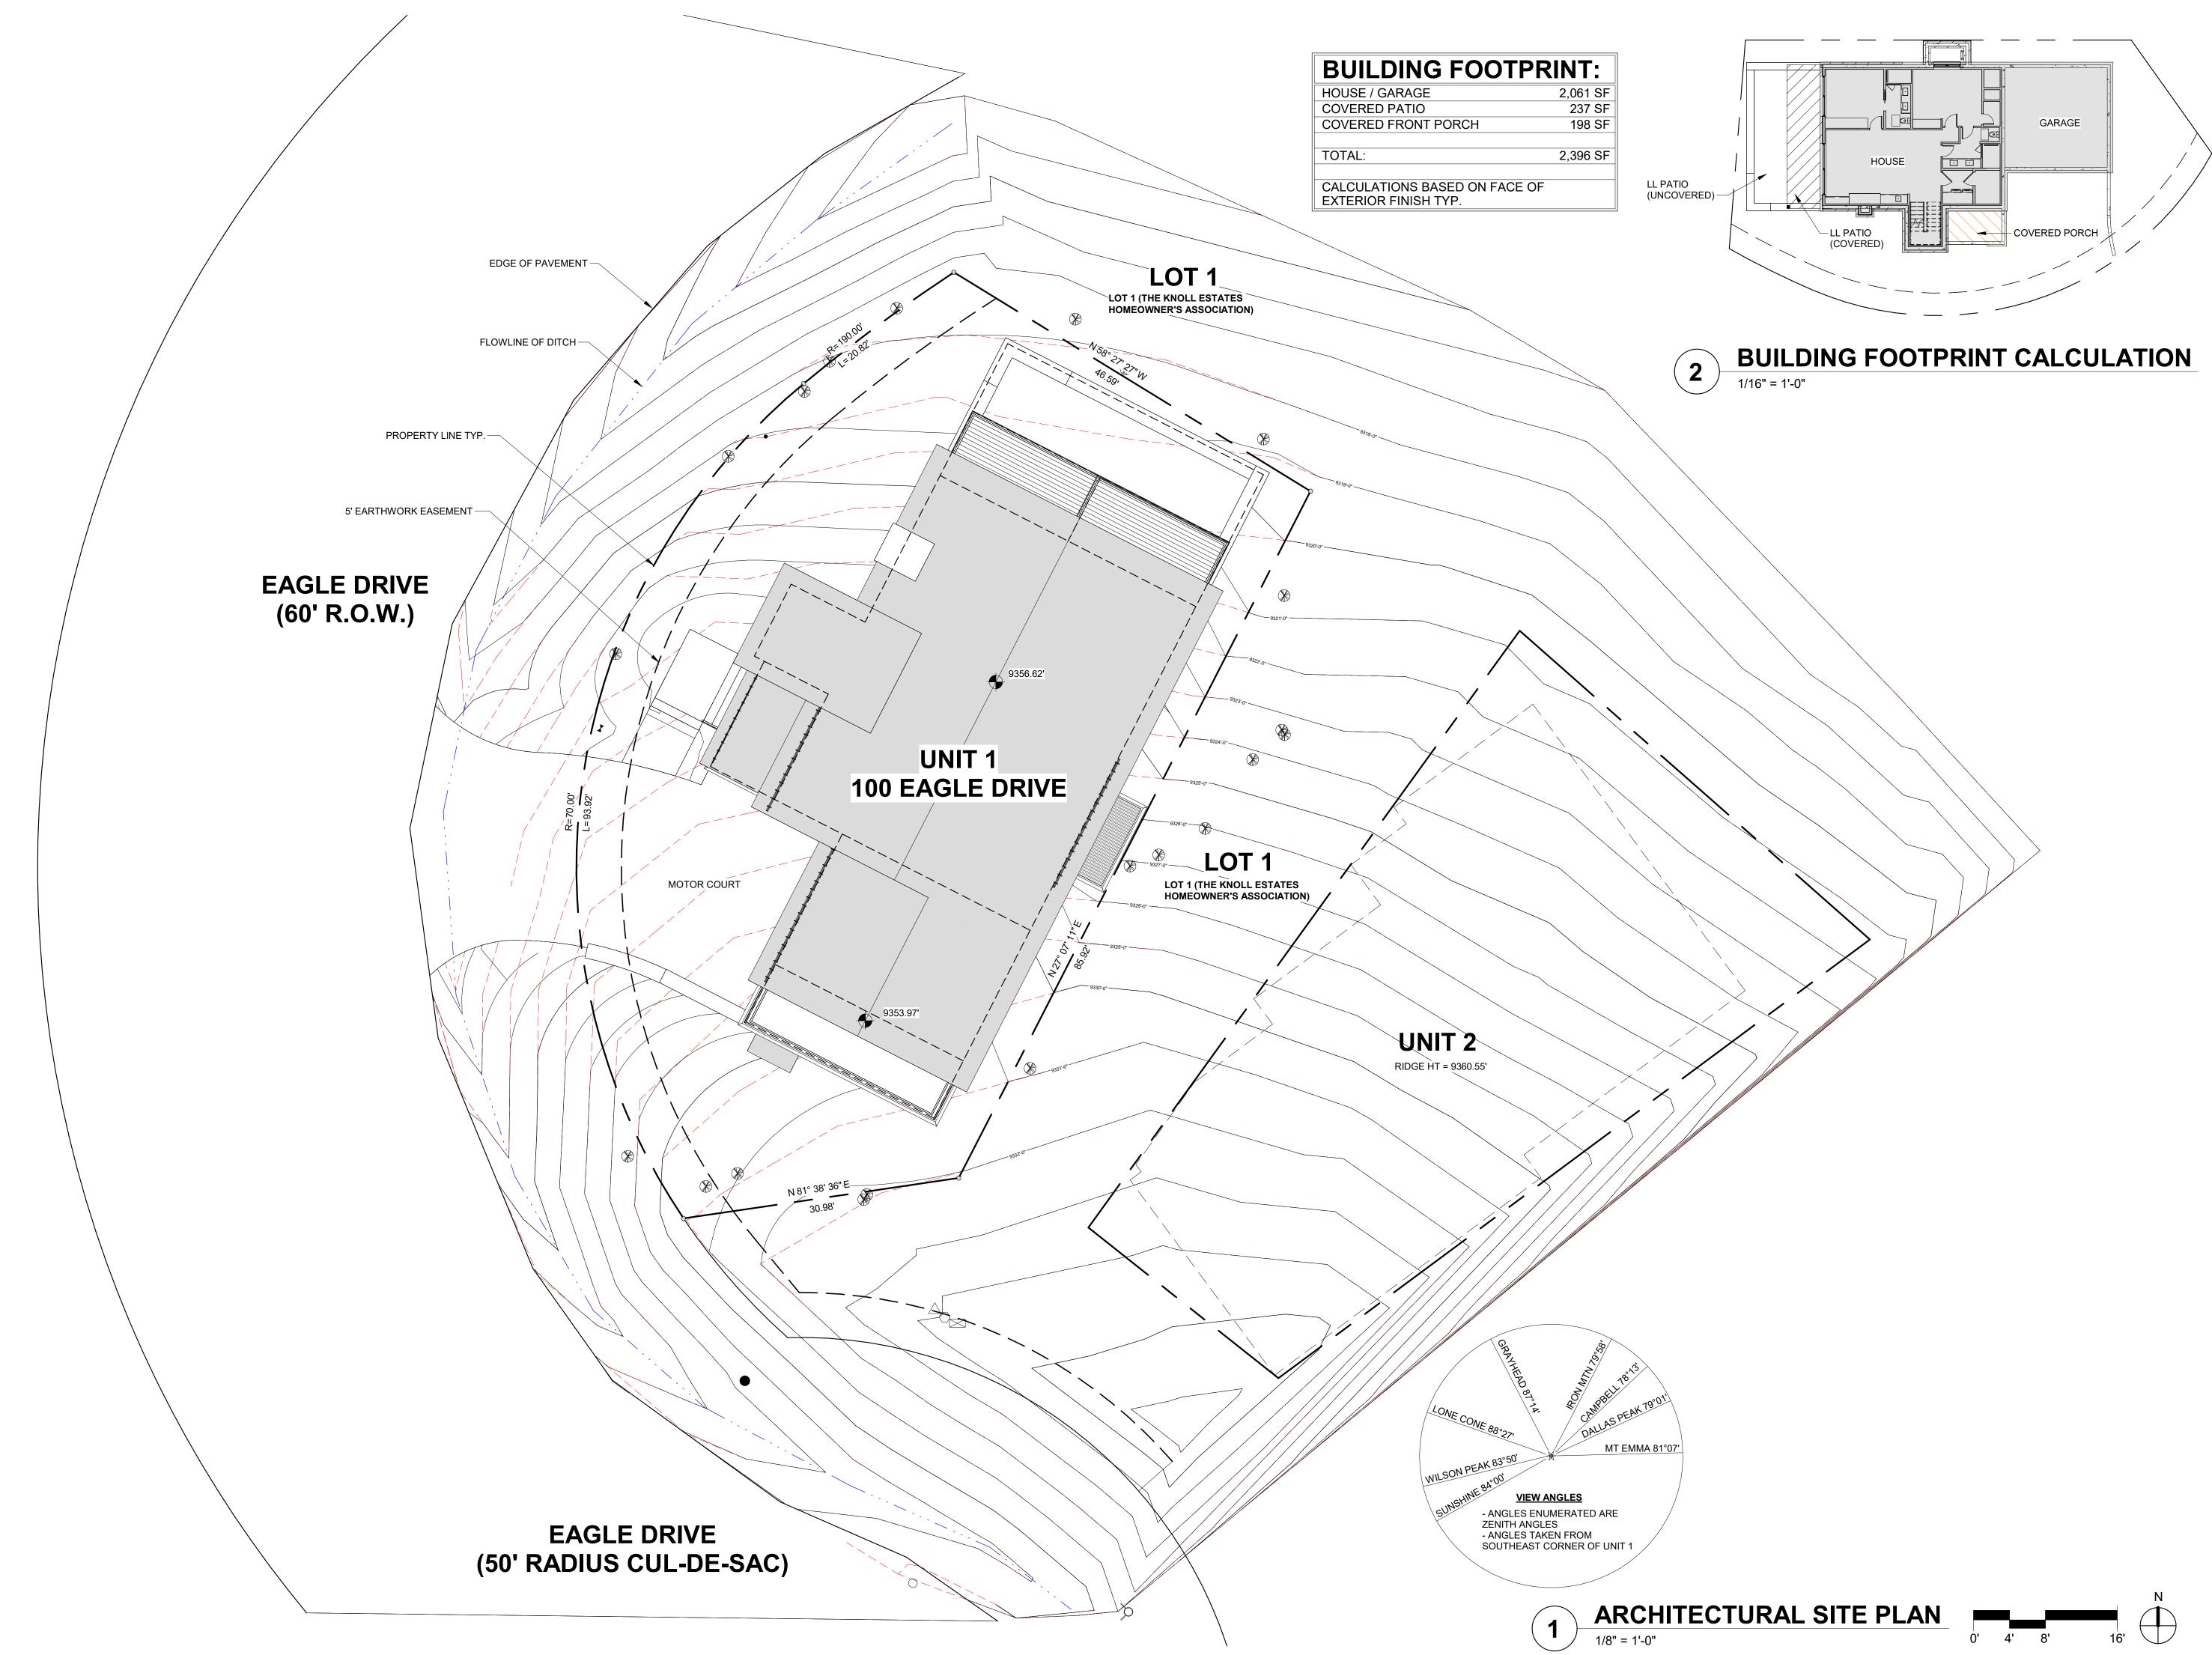

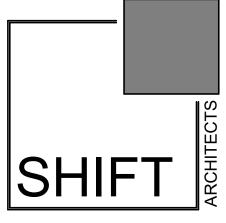

P.O. Box 3206 100 W. Colorado Suite 211 Telluride, Colorado 81435 p 970-728-8145 kristine@shift-architects.com www.shift-architects.com

PROJECT ISSUE DATE: 12.05.23 DRB PRELIMINARY SUBMITTAL REVISIONS NO. DATE DESC.



81435 IDF M 100 EAGLE DRIVE, MOUNTAIN VILLAGE, CO UNIT 1 THE KNOLL ESTATES LOT 1 TELLURI REC 10 6 95 BK 1 PG 1918


ARCHITECTURAL SITE PLAN










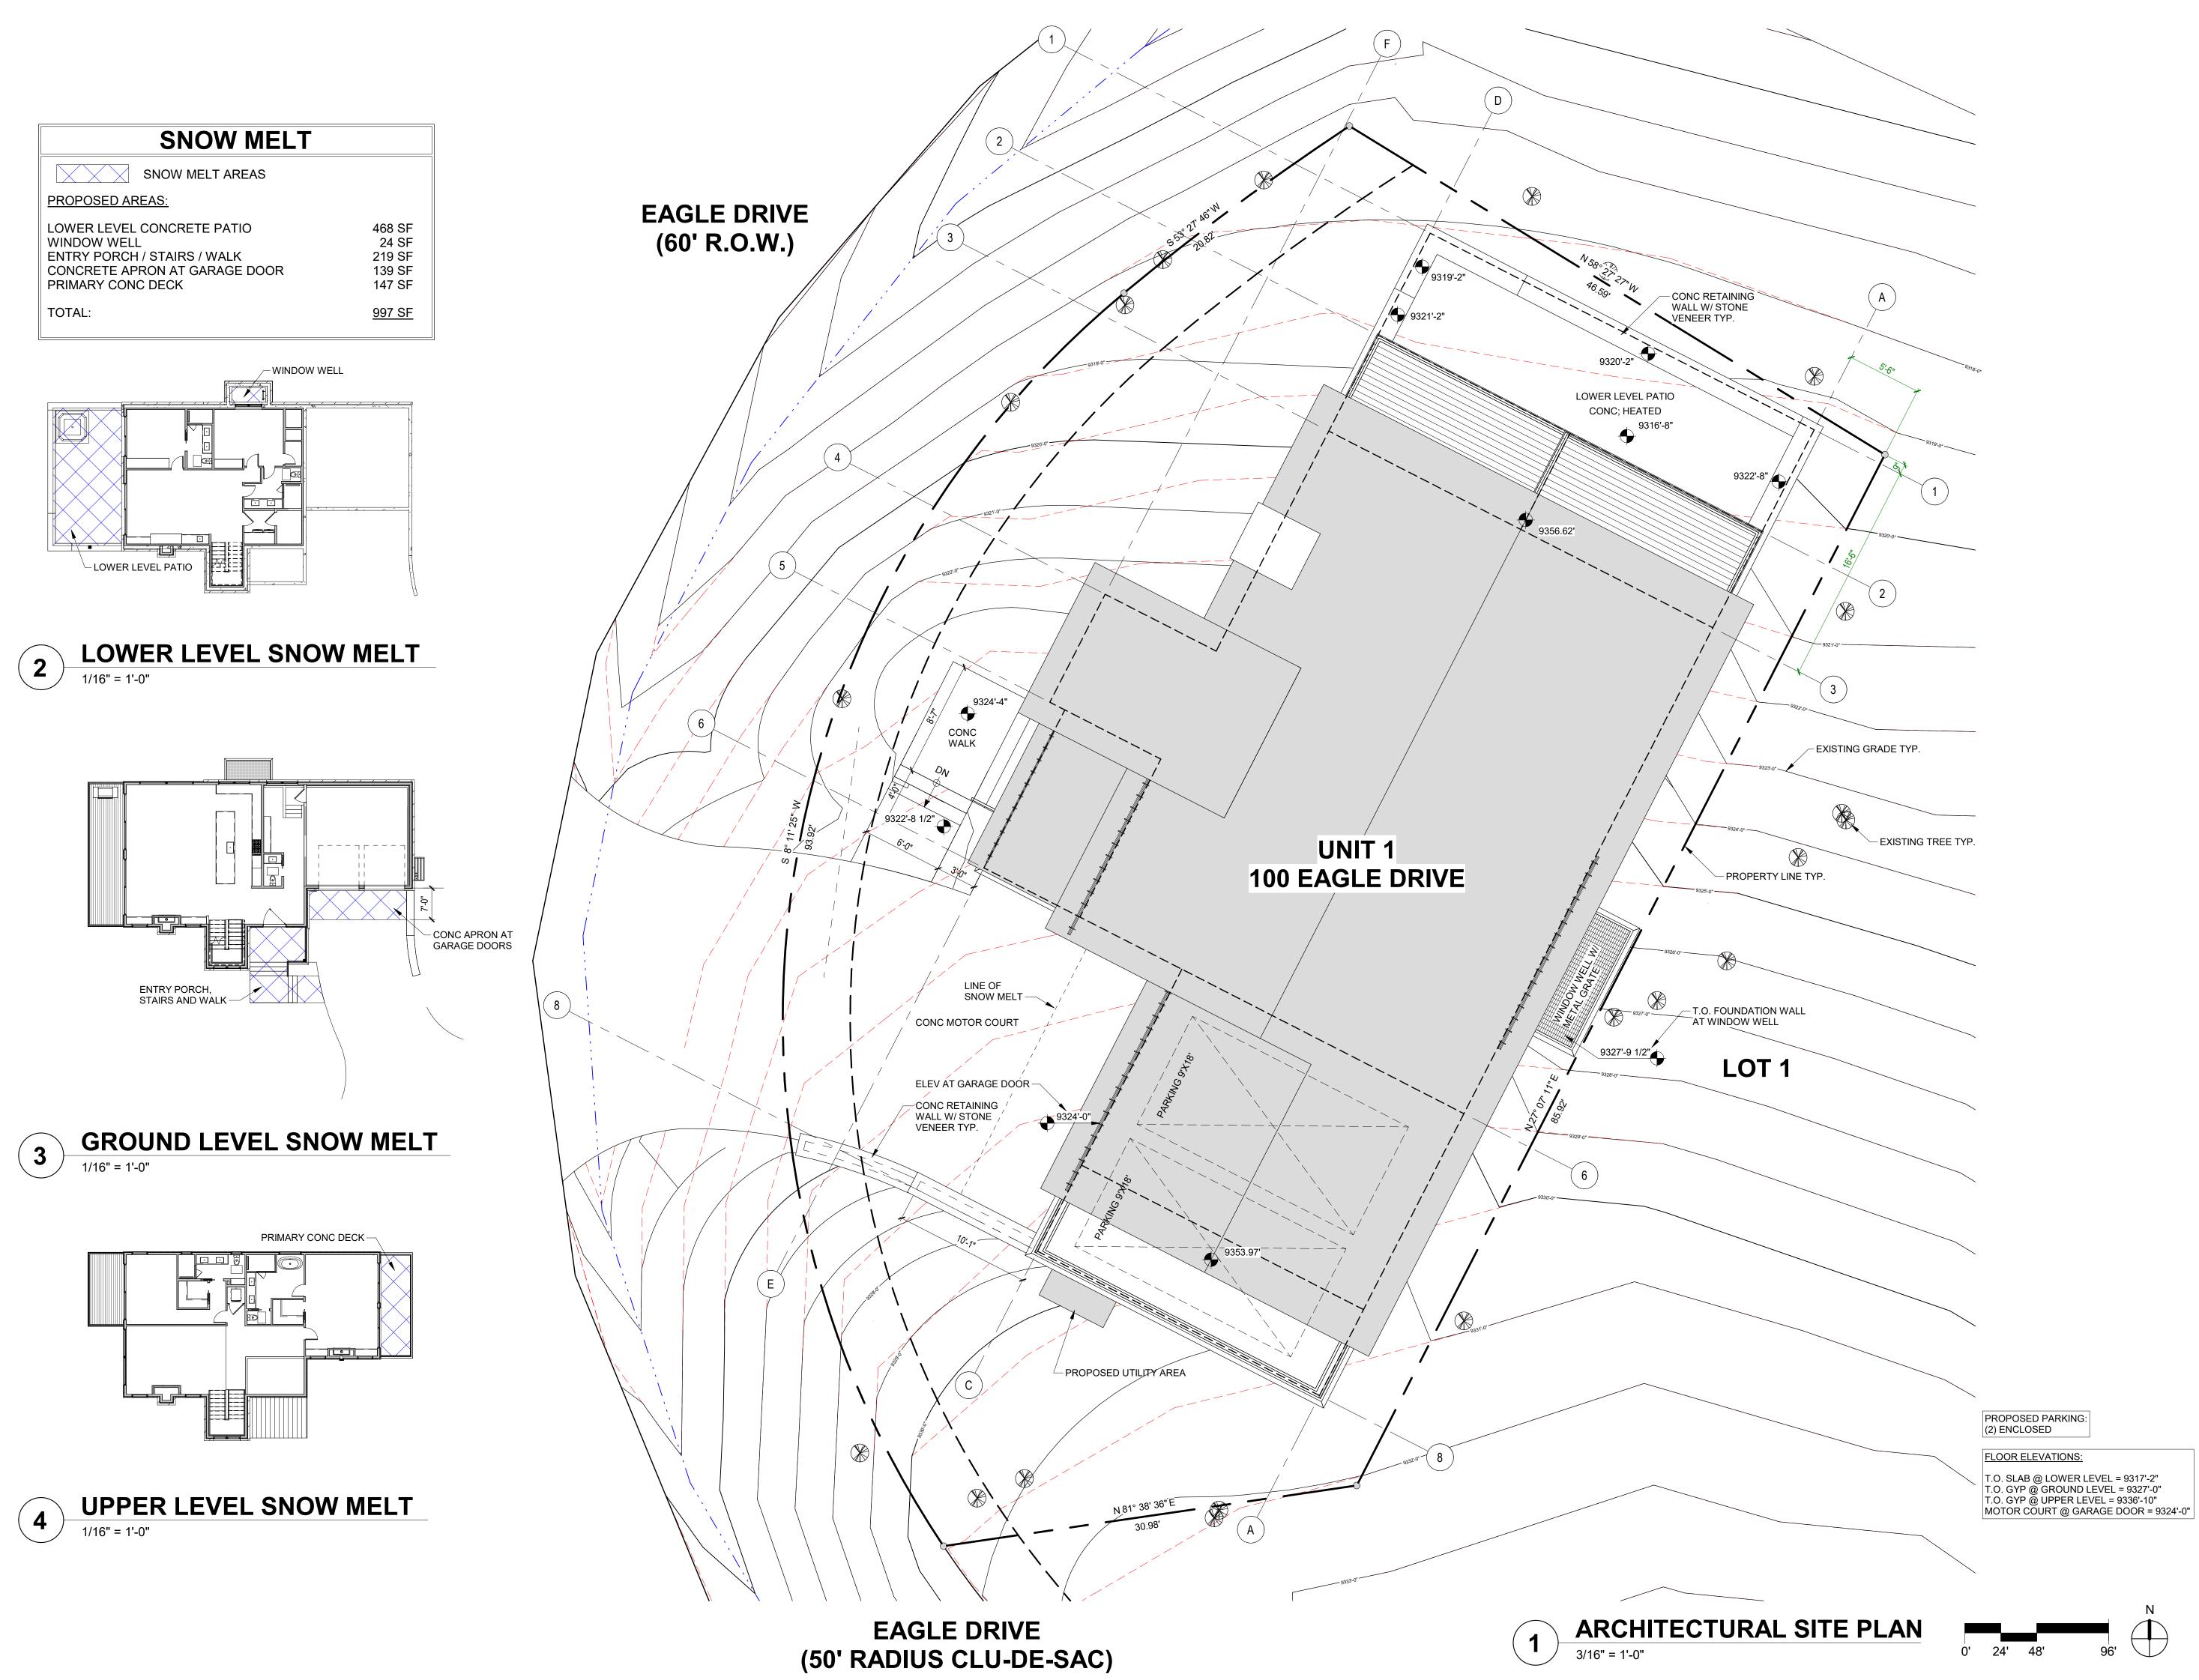

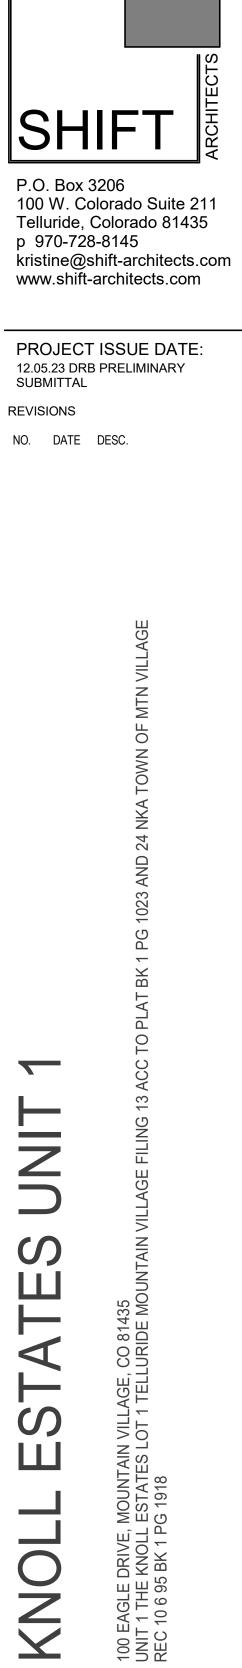

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SHEET NUMBER

A1.2

# FIRE MITIGATION L

ZONE 1 - REMOVE ALL SHRUBS, TREES. SLASH AND FLAMMABLE VEGETATION

ZONE 2 - 10' CROWN TO CROWN SEPARATION, PRUNE BRANCHES TO A HEIGHT OF 10' FROM GROUND

ZONE 3 - REMOVE ALL DISEASED, DEAD OR DYING TREES

- 1. ALL DEVELOPMENT SHALL COMPLY WITH CDC 17.6.1 ENVIRONMENTAL REGULATIONS. ADDITIONAL TREE CLEARING WILL BE DONE PER FIRE MITIGATION REQUIREMENTS.
- 2. CONSISTANT WITH 2018 IRC SECTION R101.4.1 APPENDAGES AND PROJECTIONS: UNENCLOSED ACCESSORY STRUCTURES ATTACHED TO BUILDINGS WITH HABITABLE SPACES AND PROJECTIONS, SUCH AS DECKS. SHALL BE CONSTRUCTED AS EITHER NON COMBUSTIBLE, HEAVY TIMBER OR EXTERIOR GRADE **IGNITITION RESISTANT MATERIALS SUCH AS THOSE** LISTED AS WUIC (WILDLAND URBAN INTERFACE CODE) APPROVED PRODUCTS.
- 3. CONTRACTOR TO SET UP A MEETING WITH TOWN FORESTER ON ZONE 2 REQUIREMENTS PRIOR TO PERMIT.

GEND	P	LANT SCHEDU	ILE	
	BOTANICAL NAME	<u>COMMON NAME</u>	SIZE	
EXISTING DECIDUOUS	POPULUS TREMULOIDES	QUAKING ASPEN	3" CAL. DBH	9 EA
	PRUNUS VIRGINIANA MELANOCARPA	NATIVE CHOKECHERRY SHRUB	5 GAL.	8 EA
EXISTING DECIDUOUS TREE TO BE REMOVED	PERENNIAL BEDDING A			17 SF
	TRE	E PLANTING N	IOTES	
EXISTING EVERGREEN TREE TO BE REMOVED	<ol> <li>IRRIGATED LAWN AREA INCREASE THE WATER ORGANICS, FERTILIZAT ARE ENCOURAGED.</li> <li>TREES AND SHRUBS SH NEEDED TO REDUCE W.</li> <li>TREES AND SHRUB HOL ROOT BALL SIZE TO FAC MATERIAL AND FACILITA</li> <li>TREES SHALL BE STAKE ENSURE SUCCESSFUL I GROWING SEASONS.</li> <li>BURLAP AND WIRE SHA PLANTING. IF ALL OF TH</li> </ol>	LES SHALL BE DUG SIX INCH CILITATE THE PLACEMENT C ATE GROWTH. ED AND HELD IN PLACE BY W ROOT ESTABLISHMENT FOR LL BE REMOVED FROM THE IE WIRE CANNOT BE REMOV THIRDS OF THE WIRE SHALL	O (2) TIMES PER YE ROVIDE A HEALTHY RPORATION AT SAM TIAL PLANTING AND ES (6") DEEPER TH OF APPROPRIATE M VEBBING AND WIRE A PERIOD OF TWO ROOT BALL PRIOR ED DUE TO THE SIZ	AN THE ULCH TO (2) FULL
	1. TREE PROTECTION FEN OR BEYOND THE CROW PROTECTION ZONE) IN A	<b>ECTION / REM</b> ICING IS REQUIRED BY THE 'N DRIPLINE OF EACH TREE ACCORDANCE WITH CDC: 17 ICING MUST BE INSTALLED A	CDC TO BE INSTAL THAT WILL REMAIN 7.6.1.A.4.f.	LED AT A
	TOWN FORESTER BEFC 3. THE TOWN FORESTER MARK OR APPROVE THE PLACEMENT OF THE TR MUST BE OBTAINED FRO OPERATIONS MAY BEGI 4. NO BACKFILL, STORAGE	ORE EXCAVATION MAY BEGIN MUST BE CONTACTED BEFO E TREES TO BE REMOVED A EE PROTECTION FENCING. A OM THE TOWN FORESTER B	N. RE EXCAVATION BI ND TO APPROVE TI A TREE REMOVAL F EFORE TREE REMO D INSIDE THE TREE	EGINS TO HE PERMIT DVAL 1. A 2. A FI

TRE	E REMOVAL	SCHED	OULE
<u>TYPE</u>		<u>SIZE</u>	<u>QTY</u>
A04	QUAKING ASPEN	4"	67 EA
A06	QUAKING ASPEN	6"	16 EA
A08	QUAKING ASPEN	8"	6 EA

1. ALL PLANTED MATERIALS INCLUDING SEEDS, SHALL BE NON NOXIOUS SPECIES AS SPECIFIED IN THE NOXIOUS WEED CDC TABLE 5-5 OR SUBSEQUENTLY DESIGNATED AS A NOXIOUS WEED BY THE STATE OF COLORADO, OR THE TOWN. LANDSCAPE MAINTENANCE NOTES:

1. TURF SHALL BE AERATED 2 TO 3 TIMES PER YEAR TO INCREASE THE WATER ABSORPTION RATE. NECESSARY ORGANIC FERTILIZATION AND AMENDMENT SHALL BE INCORPORATED AT THE SAME TIME.


STRIPS.

3. ALL SHRUBS IN SNOW SHED AREAS TO BE CUT BACK IN FALL TO 12"-18" IN HEIGHT. 4. IRRIGATION SYSTEM TO BE BLOWN OUT BY OCTOBER 31ST EACH FALL AND TURNED ON BY JUNE 1ST EACH SPRING.

# **REVEGETATION NOTES:**

SPECIES WESTERN Y TALL FESCU

**ARIZONA FE** HARD FESC CREEPING F ALPINE BLUI CANADA BLI PERENNIAL SLENDER W MOUNTAIN E

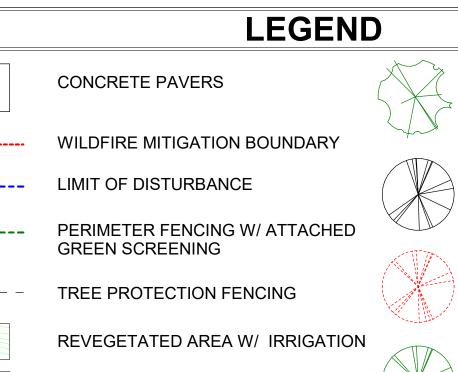


**REVEGETATE W/ NATIVE GRASS** 

DISTURBED AREAS

PERENNIAL BEDDING: PROVIDE LAVA ROCK MULCH

FLAGSTONE

STONE PAVER

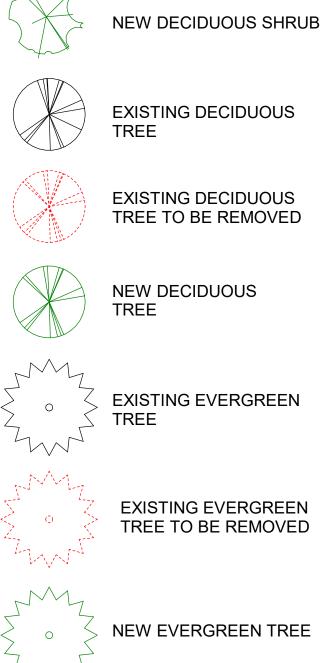

DE TREE PROTECTION FENCING QUIRED BY THE CDC.

# ERAL NOTES:

REES AND SHRUBS TO BE LOCATED BY PROJECT ARCHITECT / OWNER. REES AND SHRUBS SHALL BE BACKED FILLED WITH A TOPSOIL / ORGANIC LIZER MIXTURE AT A 2:1 RATIO.

SSARY TREES SHALL BE STAKED WITH 4' METAL POSTS. TREES SHALL BE GUYED WITH 12 GAUGE GALVANIZED WIRE AND POLYPROPYLENE TREE RACE

4. PERENNIAL PLANTING BEDS SHALL BE TILLED 6" DEPTH AND AMENDED WITH TOPSOIL AND ORGANIC FERTILIZER AT A 2:1 RATIO. 5. SEE PLANTING DETAILS FOR ALL DECIDUOUS AND EVERGREEN TREES.

6. MULCH ALL PERENNIAL BEDS WITH LAVA ROCK. 7. ALL PLANT MATERIAL TO MEET THE AMERICAN STANDARD FOR NURSERY STOCK. 8. LANDSCAPING AND TREE REMOVAL SHALL BE IN ACCORDANCE WITH CDC 17.5.9 LANDSCAPING REGULATIONS AND CDC 17.6.1 ENVIRONMENTAL REGULATIONS.

# NOXIOUS WEEDS:


2. NECESSARY ORGANIC FERTILIZERS AND AMENDMENT SHALL BE ADDED TO PERENNIAL BEDS SEASONALLY ALONG WITH MULCH.

1. SUBSOIL SURFACE SHALL BE TILLED TO A 4" DEPTH ON NON FILL AREAS. 2. TOPSOIL SHALL BE SPREAD AT A MINIMUM DEPTH OF 4" OVER ALL AREAS TO BE REEMITTED (EXCEPT ON SLOPES GREATER THAN 3:1) AND AMENDMENTS ROTOTILLED AT A RATE OF THREE CUBIC YARDS PER THOUSAND SQUARE FEET. 3. BROADCASTING OF SEED SHALL BE DONE IMMEDIATELY AFTER TOPSOIL IS APPLIED (WITHIN 10 DAYS) TO MINIMIZE EROSION AND WEEDS. 4. AREAS WHICH HAVE BEEN COMPACTED OR ARE RELATIVELY UNDISTURBED NEEDING SEEDING, SHALL BE SCARIFIED BEFORE BROADCASTING OF SEED. 5. BROADCASTING WITH SPECIFIED SEED MIX AND FOLLOW WITH DRY MULCHING, STRAW OR HAY SHALL BE UNIFORMLY APPLIED OVER SEEDED AREA AT A RATE OF 1.5 TONS PER ACRE FOR HAY OR 2 TONS PER ACRE FOR STRAW, CRIMP IN.

6. ON SLOPES GREATER THAN 2:1 EROSION CONTROL BLANKET SHALL BE APPLIED IN PLACE OF STRAW MULCH AND PINNED. 7. ALL UTILITY CUTS SHALL BE REVEGETATED WITHIN TWO WEEKS AFTER

INSTALLATION OF UTILITIES TO PREVENT WEED INFESTATION. 8. SEED ALL AREAS LABELED NATIVE GRASS SEED WITH THE FOLLOWING MIXTURE AT A RATE OF 12 LBS. PER ACRE.

PURE LIVE SEED PER ACRE	
YARROW 5%	
UE 10%	
ESCUE 5%	
CUE 5%	
RED FESCUE 10%	
JEGRASS 15%	
UEGRASS 10%	
RYEGRASS 15%	
VHEATGRASS 10%	
BROME 15%	

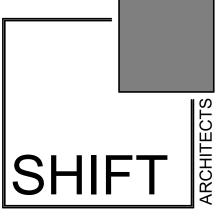

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PROJECT ISSUE DATE: 12.05.23 DRB PRELIMINARY SUBMITTAL REVISIONS NO. DATE DESC.

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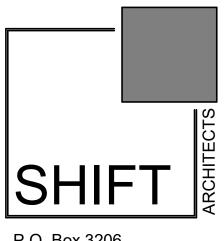
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100 E/ UNIT REC 1

LANDSCAPE PLAN NOTES / LEGENDS 





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81435 IDE MC

100 EAGLE DRIVE, MOUNTAIN VILLAGE, CO UNIT 1 THE KNOLL ESTATES LOT 1 TELLURI REC 10 6 95 BK 1 PG 1918

LANDSCAPE PLAN

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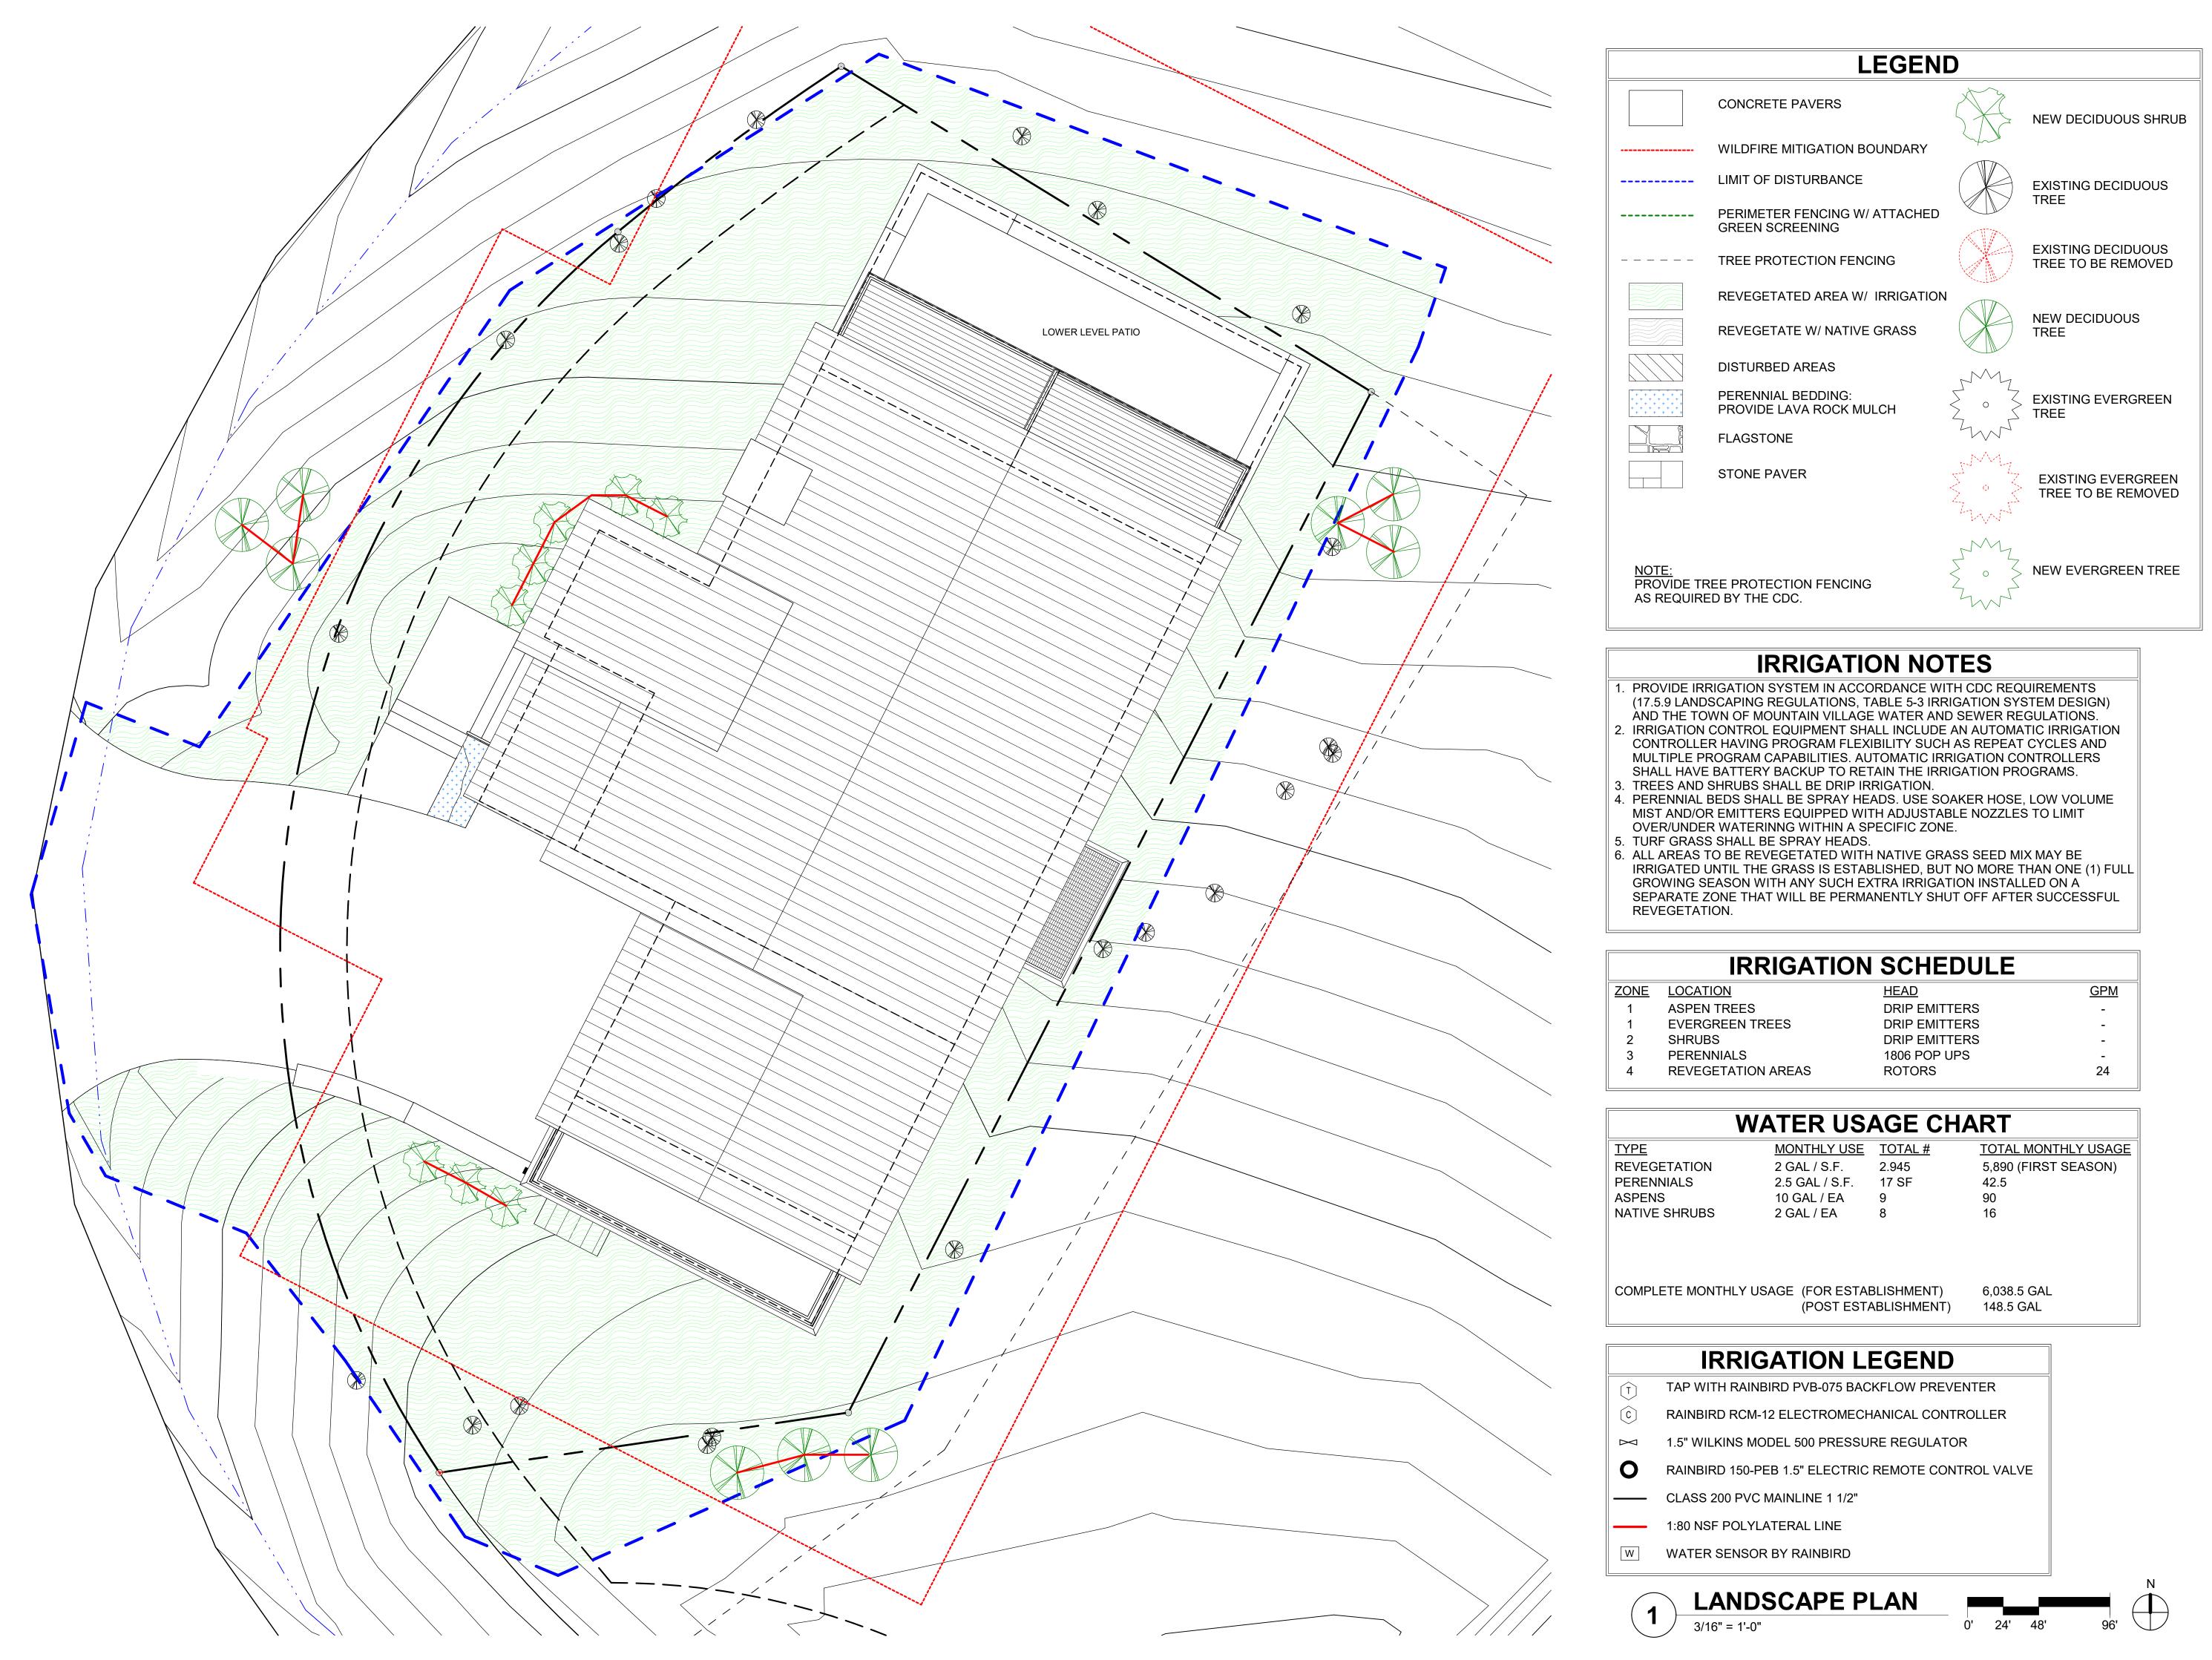












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**IRRIGATION PLAN** 

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DRIVE, MOUNTAIN VILLAGE, CO KNOLL ESTATES LOT 1 TELLURI BK 1 PG 1918

100 EAGLE D UNIT 1 THE P REC 10 6 95










NOT FOR CONSTRUCTION

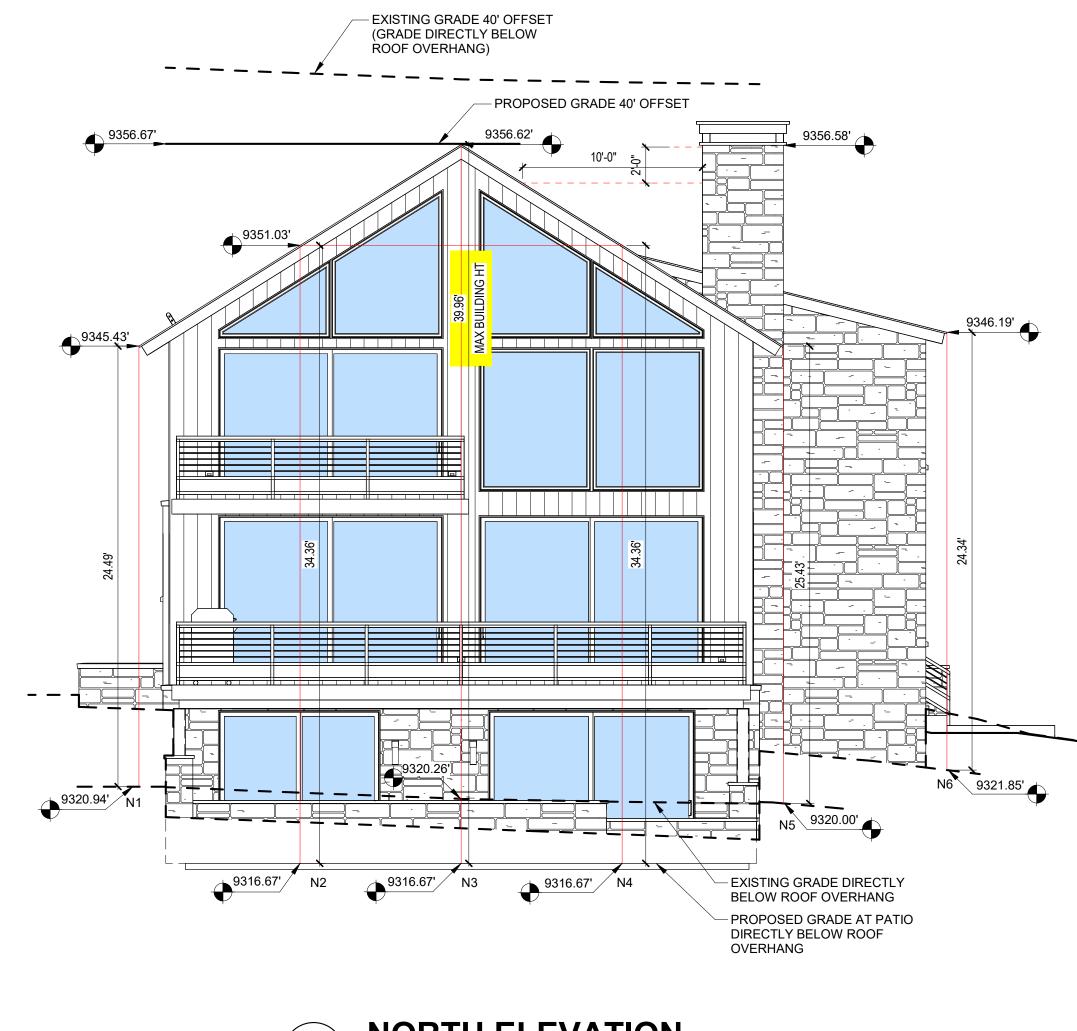




# MAX BUILDING HT :

HIGHEST POINT RELATIVE TO GRADE: LOCATION: N3 39.96' MAX BUILDING HT ALLOWABLE 40.00' ROOF HEIGHT 9356.62' MOST RESTRICTIVE GRADE BELOW 9316.67'


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<b>AVG ROOF</b>	HT :				
NORTH ELEVATION		SOUTH AT ENTRY F	PORCH	WEST ELEVATION	
N1	24.49'	SE1	21.43'	W1	31.05'
N2	34.36'	SE2	21.71'	W2	29.32'
N3	39.96'	SE3	27.03'	W3	28.22'
N4	34.36'	SUB-TOTAL:	70.17'	W4	26.70'
N5	25.43'	# OF LOCATIONS:	3	W5	27.03'
N6	24.34'	AVERAGE:	23.39'	W6	25.70'
SUB-TOTAL:	182.94'			W7	25.70'
# OF LOCATIONS:	6	EAST ELEVATION		SUB-TOTAL:	193.70'
AVERAGE:	30.49'	E1	18.84'	# OF LOCATIONS:	7
		E2	19.64'	AVERAGE:	27.67'
SOUTH ELEVATION		E3	21.84'		
S1	16.38'	E4	23.94'	TOTAL:	683.54'
S2	19.90'	E5	26.08'	NUMBER OF LOCATION	S: 27
S3	18.78'	E6	28.13'	AVERAGE:	25.31'
S4	13.99'	E7	30.21'		
SUB-TOTAL:	69.05'	SUB-TOTAL:	168.68'		
# OF LOCATIONS:	4	# OF LOCATIONS:	7		
AVERAGE:	17.26'	AVERAGE:	24.09'		





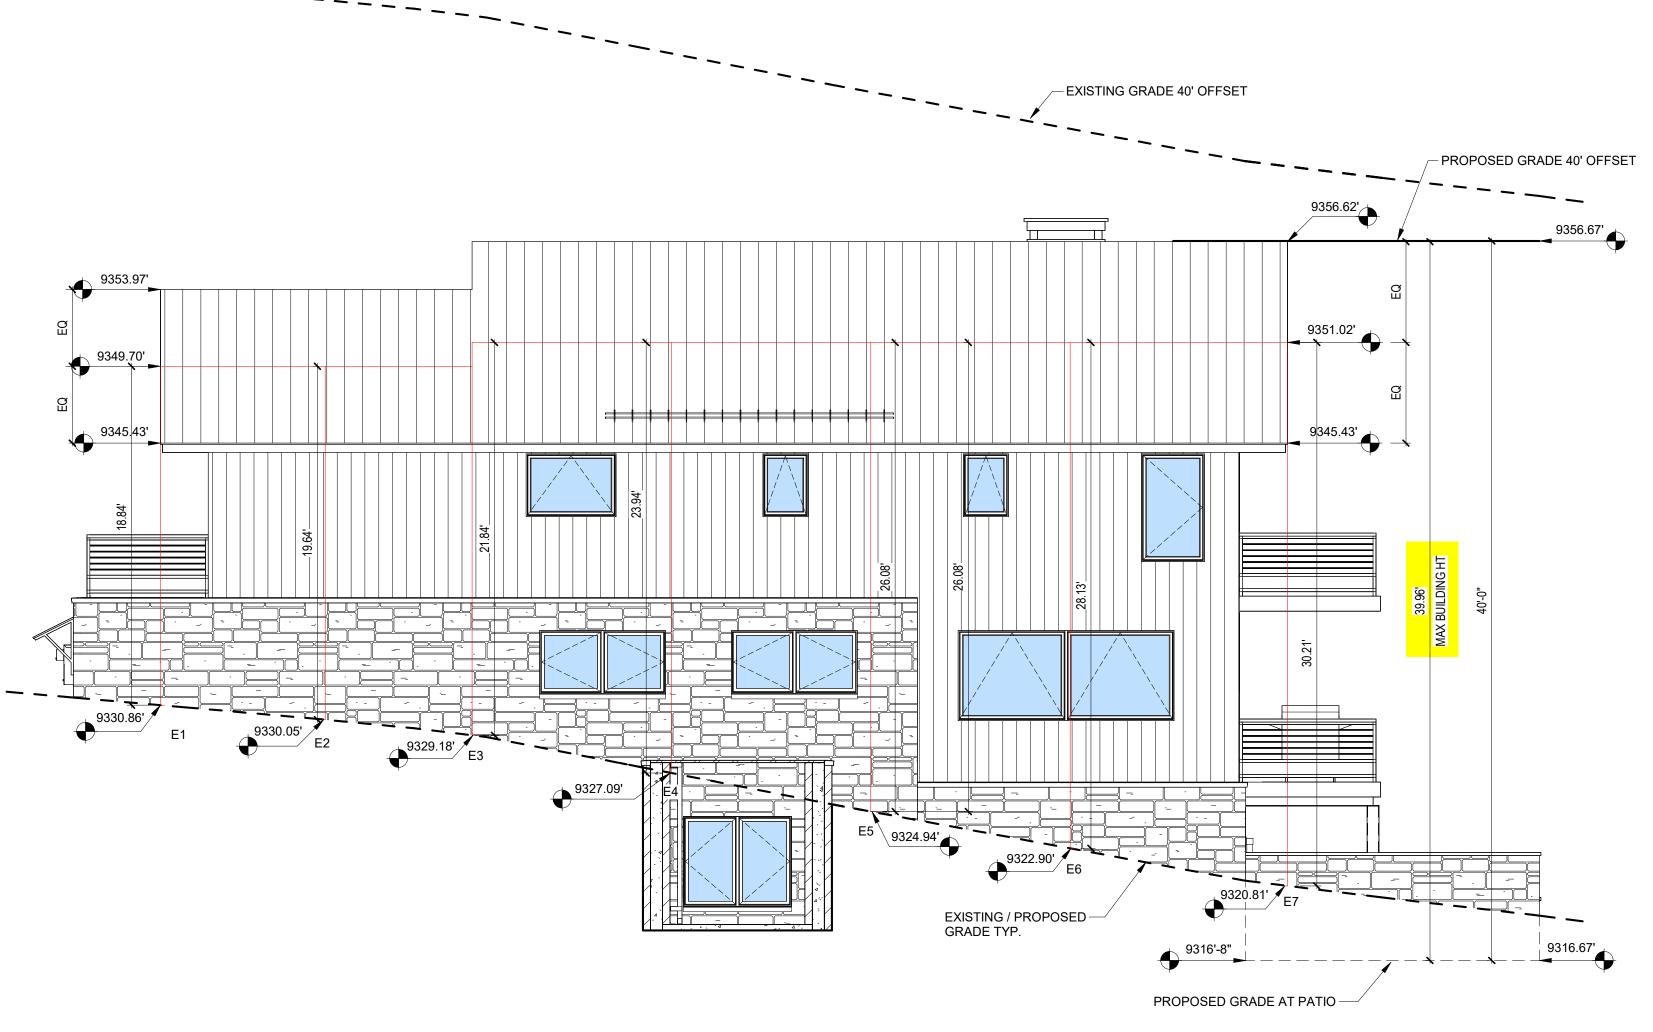

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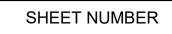
PROJECT ISSUE DATE: 12.05.23 DRB PRELIMINARY SUBMITTAL

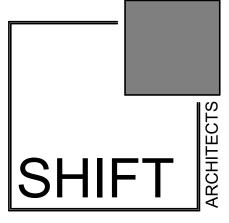REVISIONS

NO. DATE DESC.





# MAX BUILDING HEIGHT








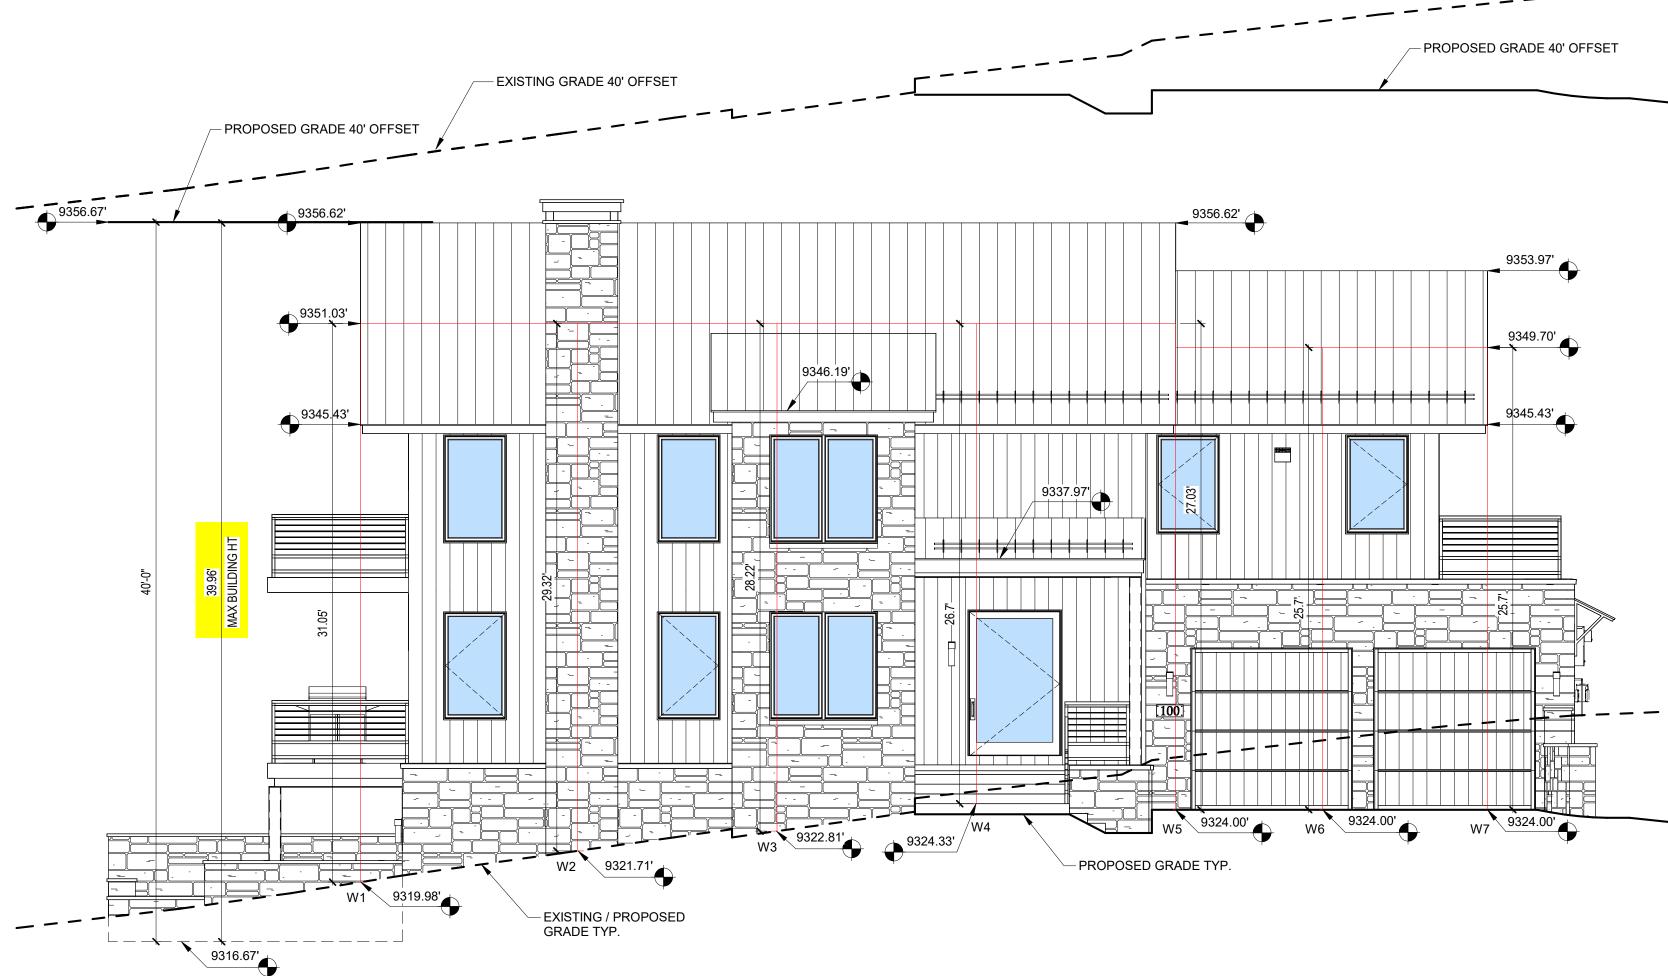

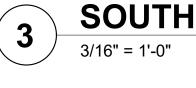

SOUTH AT ENTRY PORCH

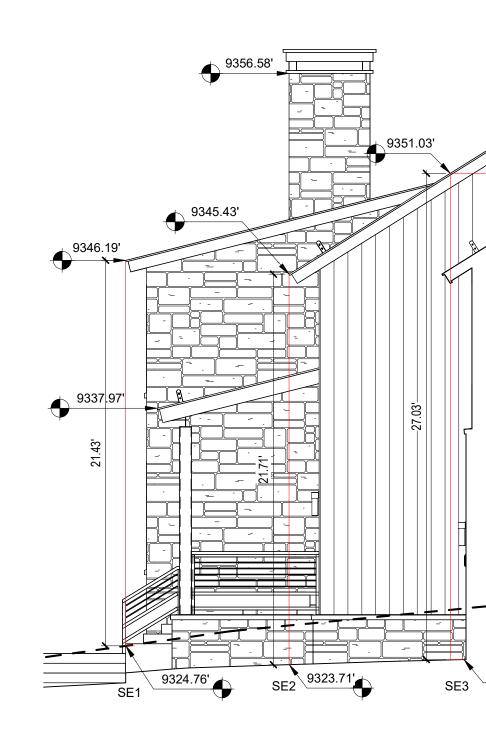

# MAX BUILDING HT :


HIGHEST POINT RELATIVE TO GRADE: LOCATION: N3 39.96' MAX BUILDING HT ALLOWABLE 40.00' ROOF HEIGHT 9356.62' MOST RESTRICTIVE GRADE BELOW 9316.67'

<b>AVG ROOF</b>	HT:				
NORTH ELEVATION		SOUTH AT ENTRY PO	ORCH	WEST ELEVATION	
N1	24.49'	SE1	21.43'	W1	31.05'
N2	34.36'	SE2	21.71'	W2	29.32'
N3	39.96'	SE3	27.03'	W3	28.22'
N4	34.36'	SUB-TOTAL:	70.17'	W4	26.70'
N5	25.43'	# OF LOCATIONS:	3	W5	27.03'
N6	24.34'	AVERAGE:	23.39'	W6	25.70'
SUB-TOTAL:	182.94'			W7	25.70'
# OF LOCATIONS:	6	EAST ELEVATION		SUB-TOTAL:	193.70'
AVERAGE:	30.49'	E1	18.84'	# OF LOCATIONS:	7
		E2	19.64'	AVERAGE:	27.67'
SOUTH ELEVATION		E3	21.84'		
S1	16.38'	E4	23.94'	TOTAL:	683.54'
S2	19.90'	E5	26.08'	NUMBER OF LOCAT	TIONS: 27
S3	18.78'	E6	28.13'	AVERAGE:	25.31'
S4	13.99'	E7	30.21'		
SUB-TOTAL:	69.05'	SUB-TOTAL:	168.68'		
# OF LOCATIONS:	4	# OF LOCATIONS:	7		
AVERAGE:	17.26'	AVERAGE:	24.09'		

NORTH ELEVATION		SOUTH AT ENTRY P	ORCH	WEST ELEVATION	
N1	24.49'	SE1	21.43'	W1	31.05'
N2	34.36'	SE2	21.71'	W2	29.32'
N3	39.96'	SE3	27.03'	W3	28.22'
N4	34.36'	SUB-TOTAL:	70.17'	W4	26.70'
N5	25.43'	# OF LOCATIONS:	3	W5	27.03'
N6	24.34'	AVERAGE:	23.39'	W6	25.70'
SUB-TOTAL:	182.94'			W7	25.70'
# OF LOCATIONS:	6	EAST ELEVATION		SUB-TOTAL:	193.70'
AVERAGE:	30.49'	E1	18.84'	# OF LOCATIONS:	7
		E2	19.64'	AVERAGE:	27.67'
SOUTH ELEVATION		E3	21.84'		
S1	16.38'	E4	23.94'	TOTAL:	683.54'
S2	19.90'	E5	26.08'	NUMBER OF LOCAT	ONS: 27
S3	18.78'	E6	28.13'	AVERAGE:	25.31'
S4	13.99'	E7	30.21'		
SUB-TOTAL:	69.05'	SUB-TOTAL:	168.68'		
# OF LOCATIONS:	4	# OF LOCATIONS:	7		
AVERAGE:	17.26'	AVERAGE:	24.09'		




9324.00'

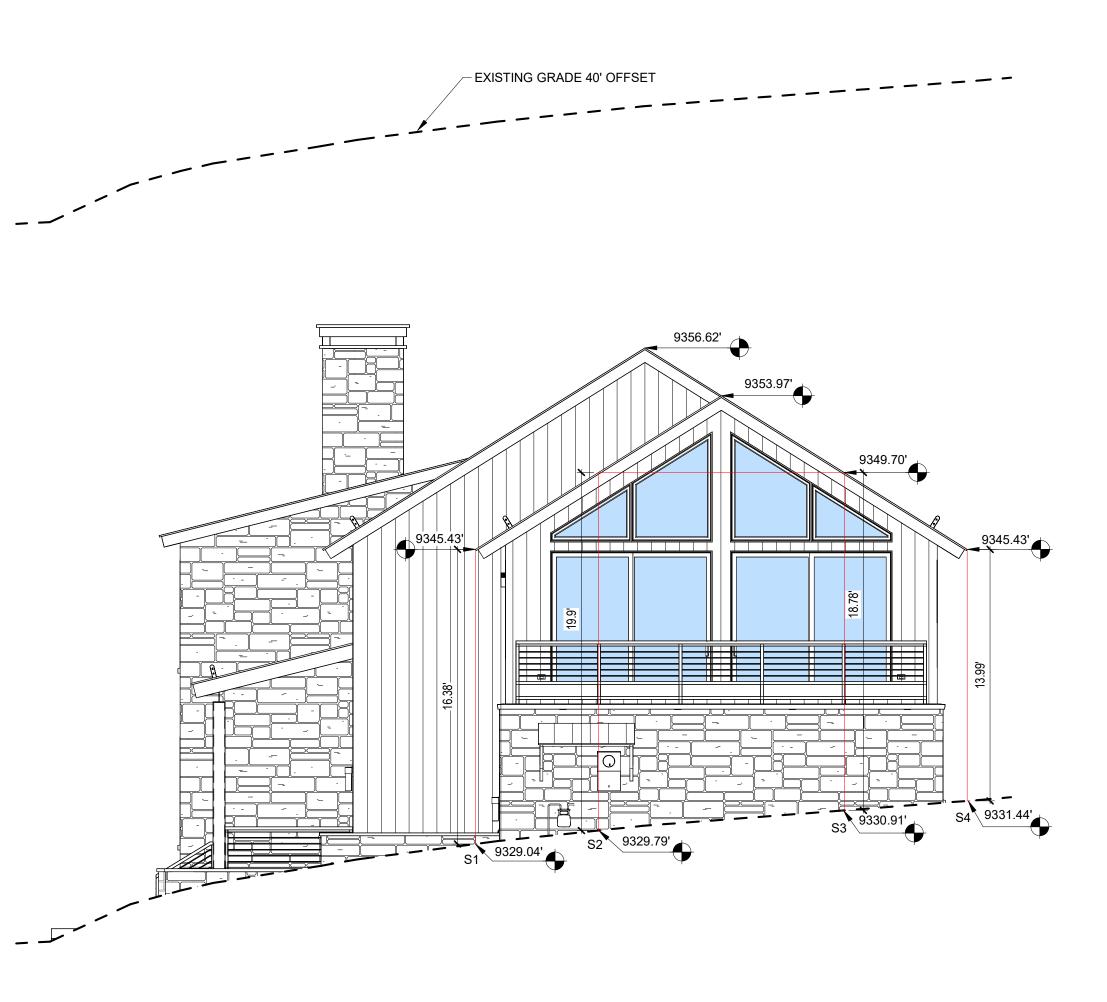

**SOUTH ELEVATION** 3/16" = 1'-0"

2

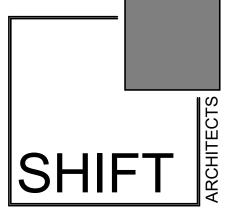

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REVISIONS

NO. DATE DESC.

# UNIT ESTATES 100 EAGLE DRIVE, MOUNTAIN VILLAGE, CO UNIT 1 THE KNOLL ESTATES LOT 1 TELLUR REC 10 6 95 BK 1 PG 1918 KNOLL

MAX BUILDING HEIGHT


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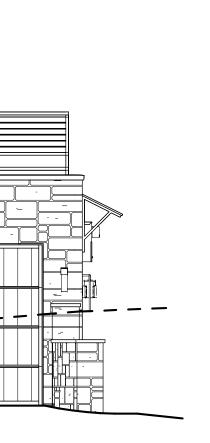







STONE AT RETAINING WALL



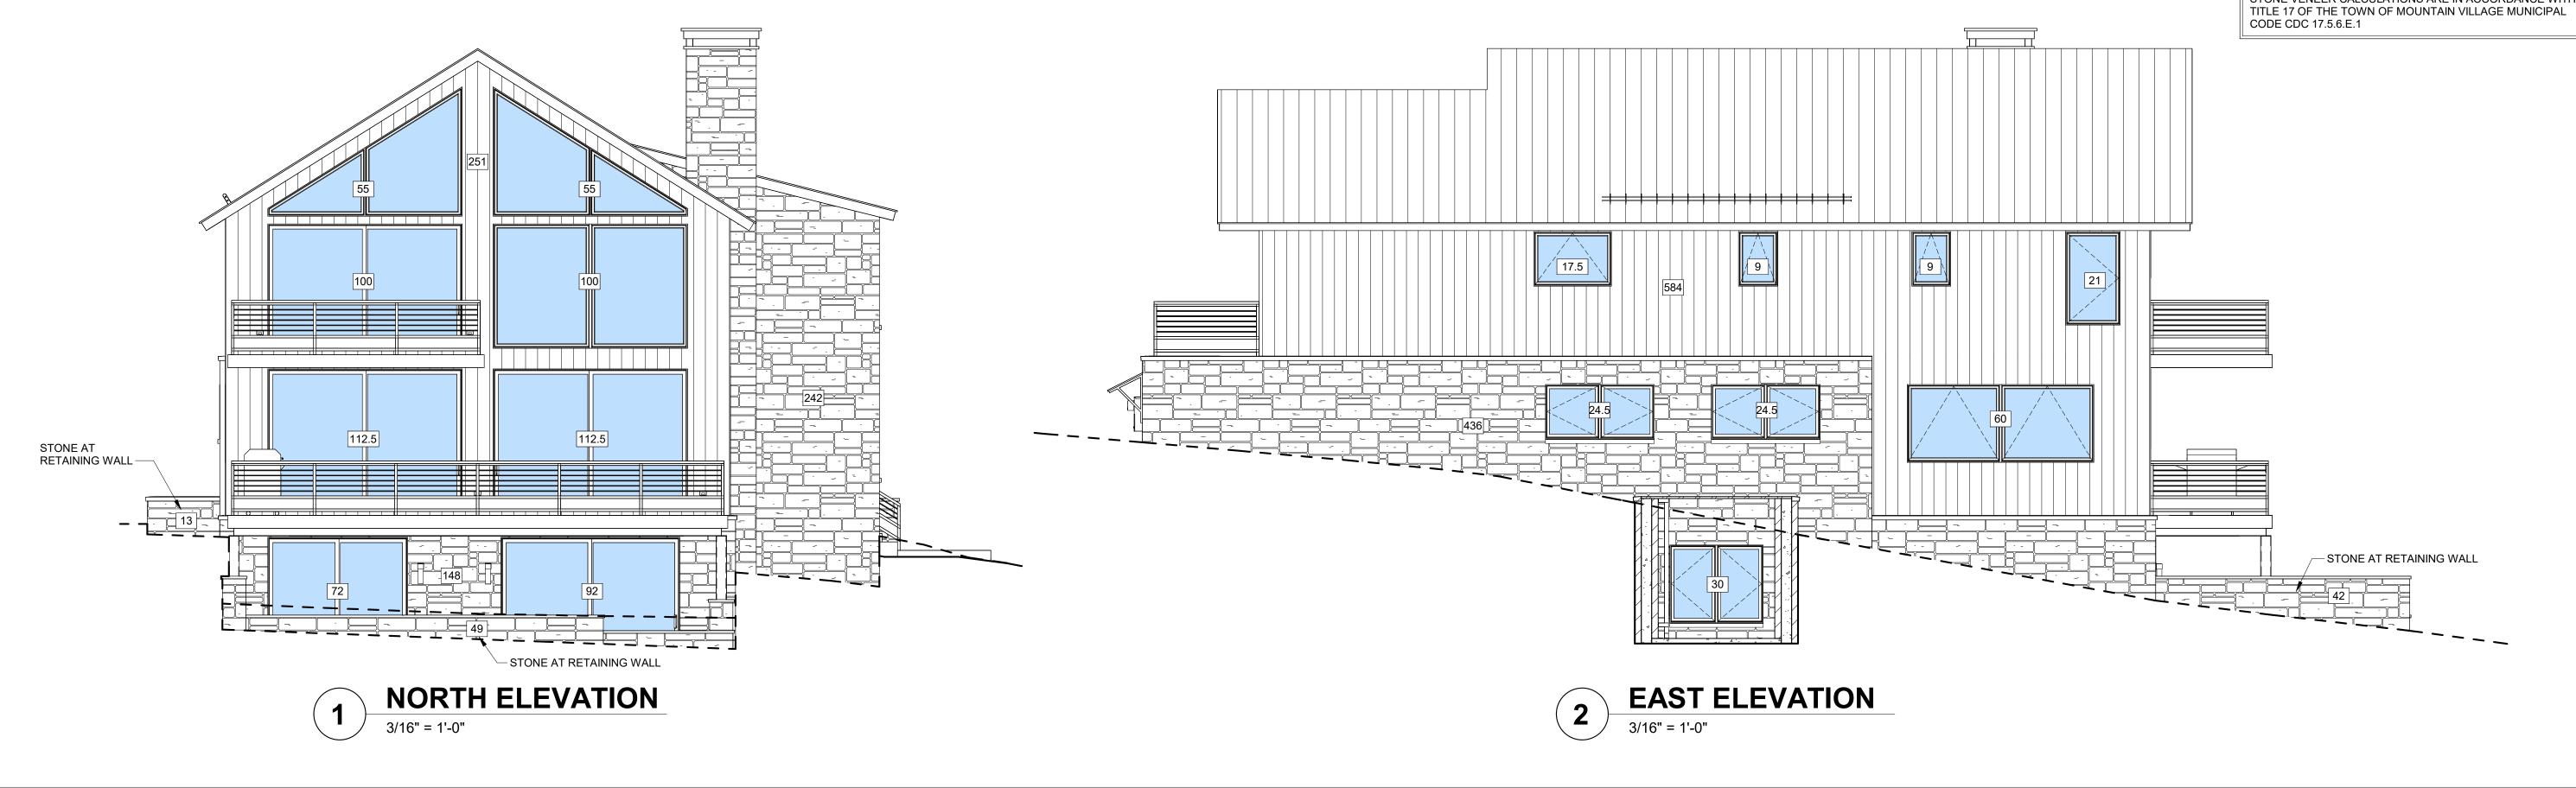

MATERIAL CAL	. <b>ULA</b>		
NORTH			
STONE	390	SF	28%
STONE @ RETAINING WALL	62	SF	4%
WOOD SIDING	251		18%
WINDOW/DOOR GLAZING		SF	50%
SUBTOTAL:	1402		100%
	1102	01	1007
SOUTH			
STONE	160	SF	18%
STONE @ RETAINING WALL		SF	20%
WOOD SIDING		SF	38%
WINDOW/DOOR GLAZING		SF	24%
SUBTOTAL:	867		100%
EAST			
STONE	436		35%
STONE @ RETAINING WALL	42	SF	3%
WOOD SIDING	584	SF	46%
WINDOW/DOOR GLAZING	195.5	SF	16%
SUBTOTAL:	1257.5	SF	100%
WEST			
STONE	380		30%
STONE @ RETAINING WALL		SF	2%
WOOD SIDING	496	SF	38%
WINDOW/DOOR GLAZING	234.5	SF	18%
WOOD GARAGE DOORS	162	SF	12%
SUBTOTAL:	1296.5	SF	100%
NORTH PATIO / DECK			
STONE @ RETAINING WALL		SF	100%
SUBTOTAL:	250	SF	100%
WINDOW WELL			
	450	05	1000
STONE @ RETAINING WALL SUBTOTAL:		SF SF	100% 100%
SUBTUTAL.	155	эг	100%
SOUTH @ ENTRY PORCH			
	0.11	05	1000
STONE	241		100%
SUBTOTAL:	241	SF	100%
CHIMNEY (STONE)			
NORTH		SF	26%
SOUTH		SF	11%
EAST		SF	19%
WEST	139	SF	44%
SUB-TOTAL:	318	SF	100%
TOTALS			
STONE	1607 SF		
STONE @ RETAINING WALL	701 SF		
CHIMNEY (STONE)			
	318 SF		
	1664 SF		
WINDOW/DOOR GLAZING	1333 SF		
WOOD GARAGE DOORS TOTAL:	162 SF 5785 SF		
PERCENTAGES			
STONE	29 %		
STONE @ RETAINING WALL	12 %	4F	5 %
CHIMNEY (STONE)	5 %	-+(	
WOOD SIDING	28 %		
WINDOW/DOOR GLAZING	23 %		
WOOD GARAGE DOORS TOTAL:	<u> </u>		

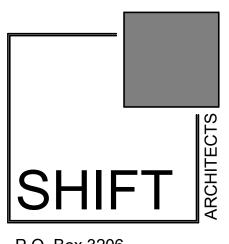

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REVISIONS NO. DATE DESC.

> -AIN VIL ES LOT MOUNT ESTAT G 1918 DRIVE, KNOLL 100 EAGLE [ UNIT 1 THE I REC 10 6 95

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KNOLL

# MATERIAL CALCULATIONS






STONE AT RETAINING WALL







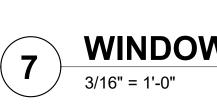

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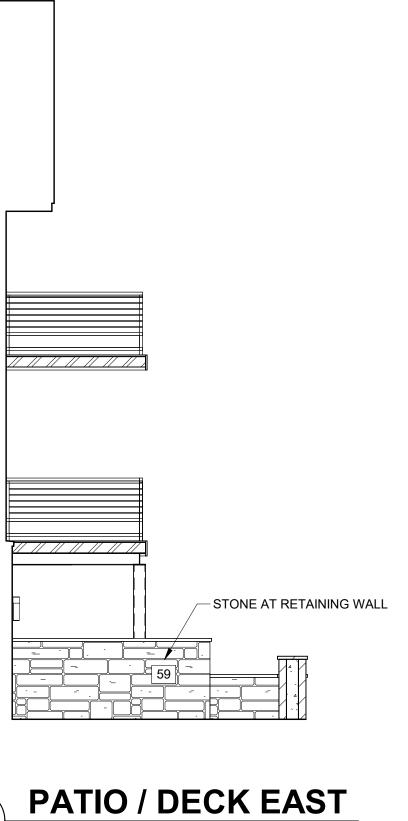
3/16" = 1'-0"




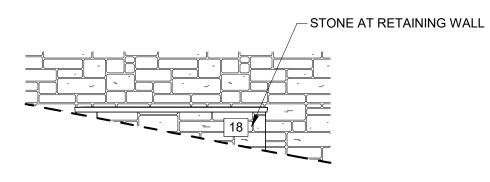

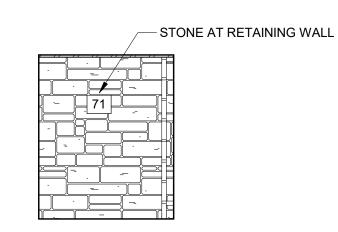

# **WINDOW WELL EAST** 3/16" = 1'-0"



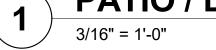



STONE AT RETAINING WALL



# WINDOW WELL NORTH

# WINDOW WELL WEST

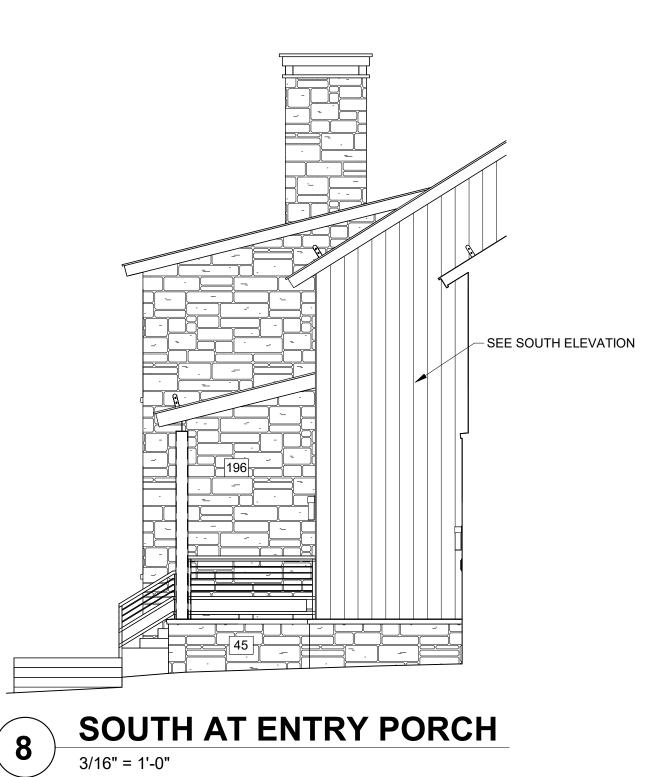

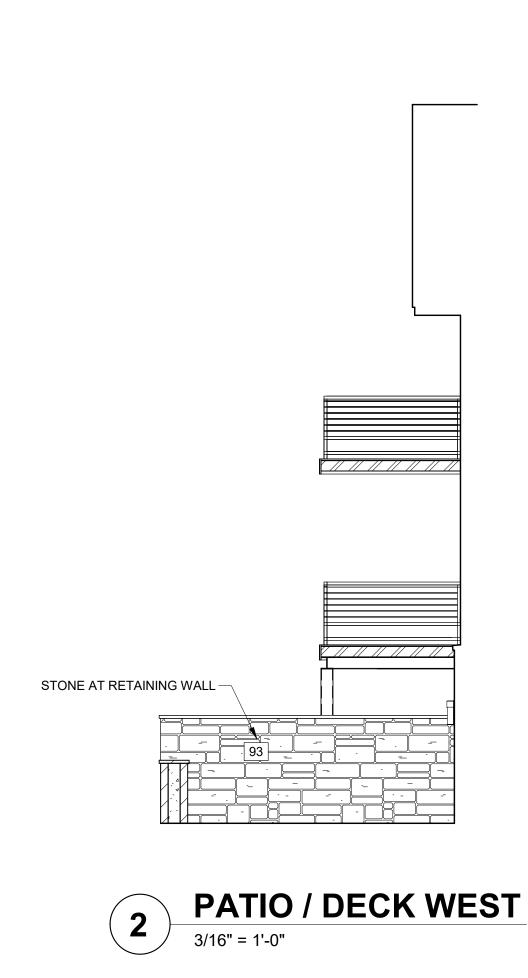




**3 LOVVE** 3/16" = 1'-0"

NORTH			
STONE	390	SF	28%
STONE @ RETAINING WALL		SF	4%
	251		18%
WINDOW/DOOR GLAZING SUBTOTAL:	699 1402		50% 100%
	1402		100 /
SOUTH			
STONE		SF	18%
STONE @ RETAINING WALL		SF	20%
WOOD SIDING WINDOW/DOOR GLAZING	333		38% 24%
SUBTOTAL:	867		100%
EAST			
	436		35%
STONE @ RETAINING WALL	42 584	SF	3% 46%
WINDOW/DOOR GLAZING	195.5		16%
SUBTOTAL:	1257.5	SF	100%
WEOT.			
WEST			
	380		30%
STONE @ RETAINING WALL WOOD SIDING	496	SF	2% 38%
WINDOW/DOOR GLAZING	234.5		18%
WOOD GARAGE DOORS		SF	12%
SUBTOTAL:	1296.5	SF	100%
NORTH PATIO / DECK STONE @ RETAINING WALL	250		100%
SUBTOTAL:	250		1007
STONE @ RETAINING WALL SUBTOTAL:	153 153	SF SF	100% 100%
SOUTH @ ENTRY PORCH			
STONE	241	SE	100%
SUBTOTAL:	241		100%
CHIMNEY (STONE)			
NORTH		SF	26%
SOUTH EAST		SF	11% 19%
WEST		SF	44%
SUB-TOTAL:	318		100%
TOTALS			
STONE	1607 SF		
STONE @ RETAINING WALL	701 SF		
CHIMNEY (STONE)	318 SF		
WOOD SIDING	1664 SF		
WINDOW/DOOR GLAZING	1333 SF		
WOOD GARAGE DOORS	162 SF		
TOTAL:	5785 SF		
PERCENTAGES			
STONE	29 %		
STONE @ RETAINING WALL	12 %	46 %	6
CHIMNEY (STONE)	5 %		
WOOD SIDING	28 %		
WINDOW/DOOR GLAZING	23 %		
WOOD GARAGE DOORS	3 %		

STONE VENEER CALCULATIONS ARE IN ACCORDANCE WITH TITLE 17 OF THE TOWN OF MOUNTAIN VILLAGE MUNICIPAL CODE CDC 17.5.6.E.1

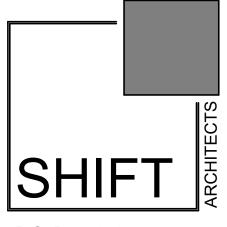

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REVISIONS

NO. DATE DESC.

100 EAGLE DRIVE, MOUNTAIN VILLAGE, CO 81435 UNIT 1 THE KNOLL ESTATES LOT 1 TELLURIDE MOUNTAIN VILLAGE FILING 13 ACC TO PLAT BK 1 PG 1023 A REC 10 6 95 BK 1 PG 1918

UNIT


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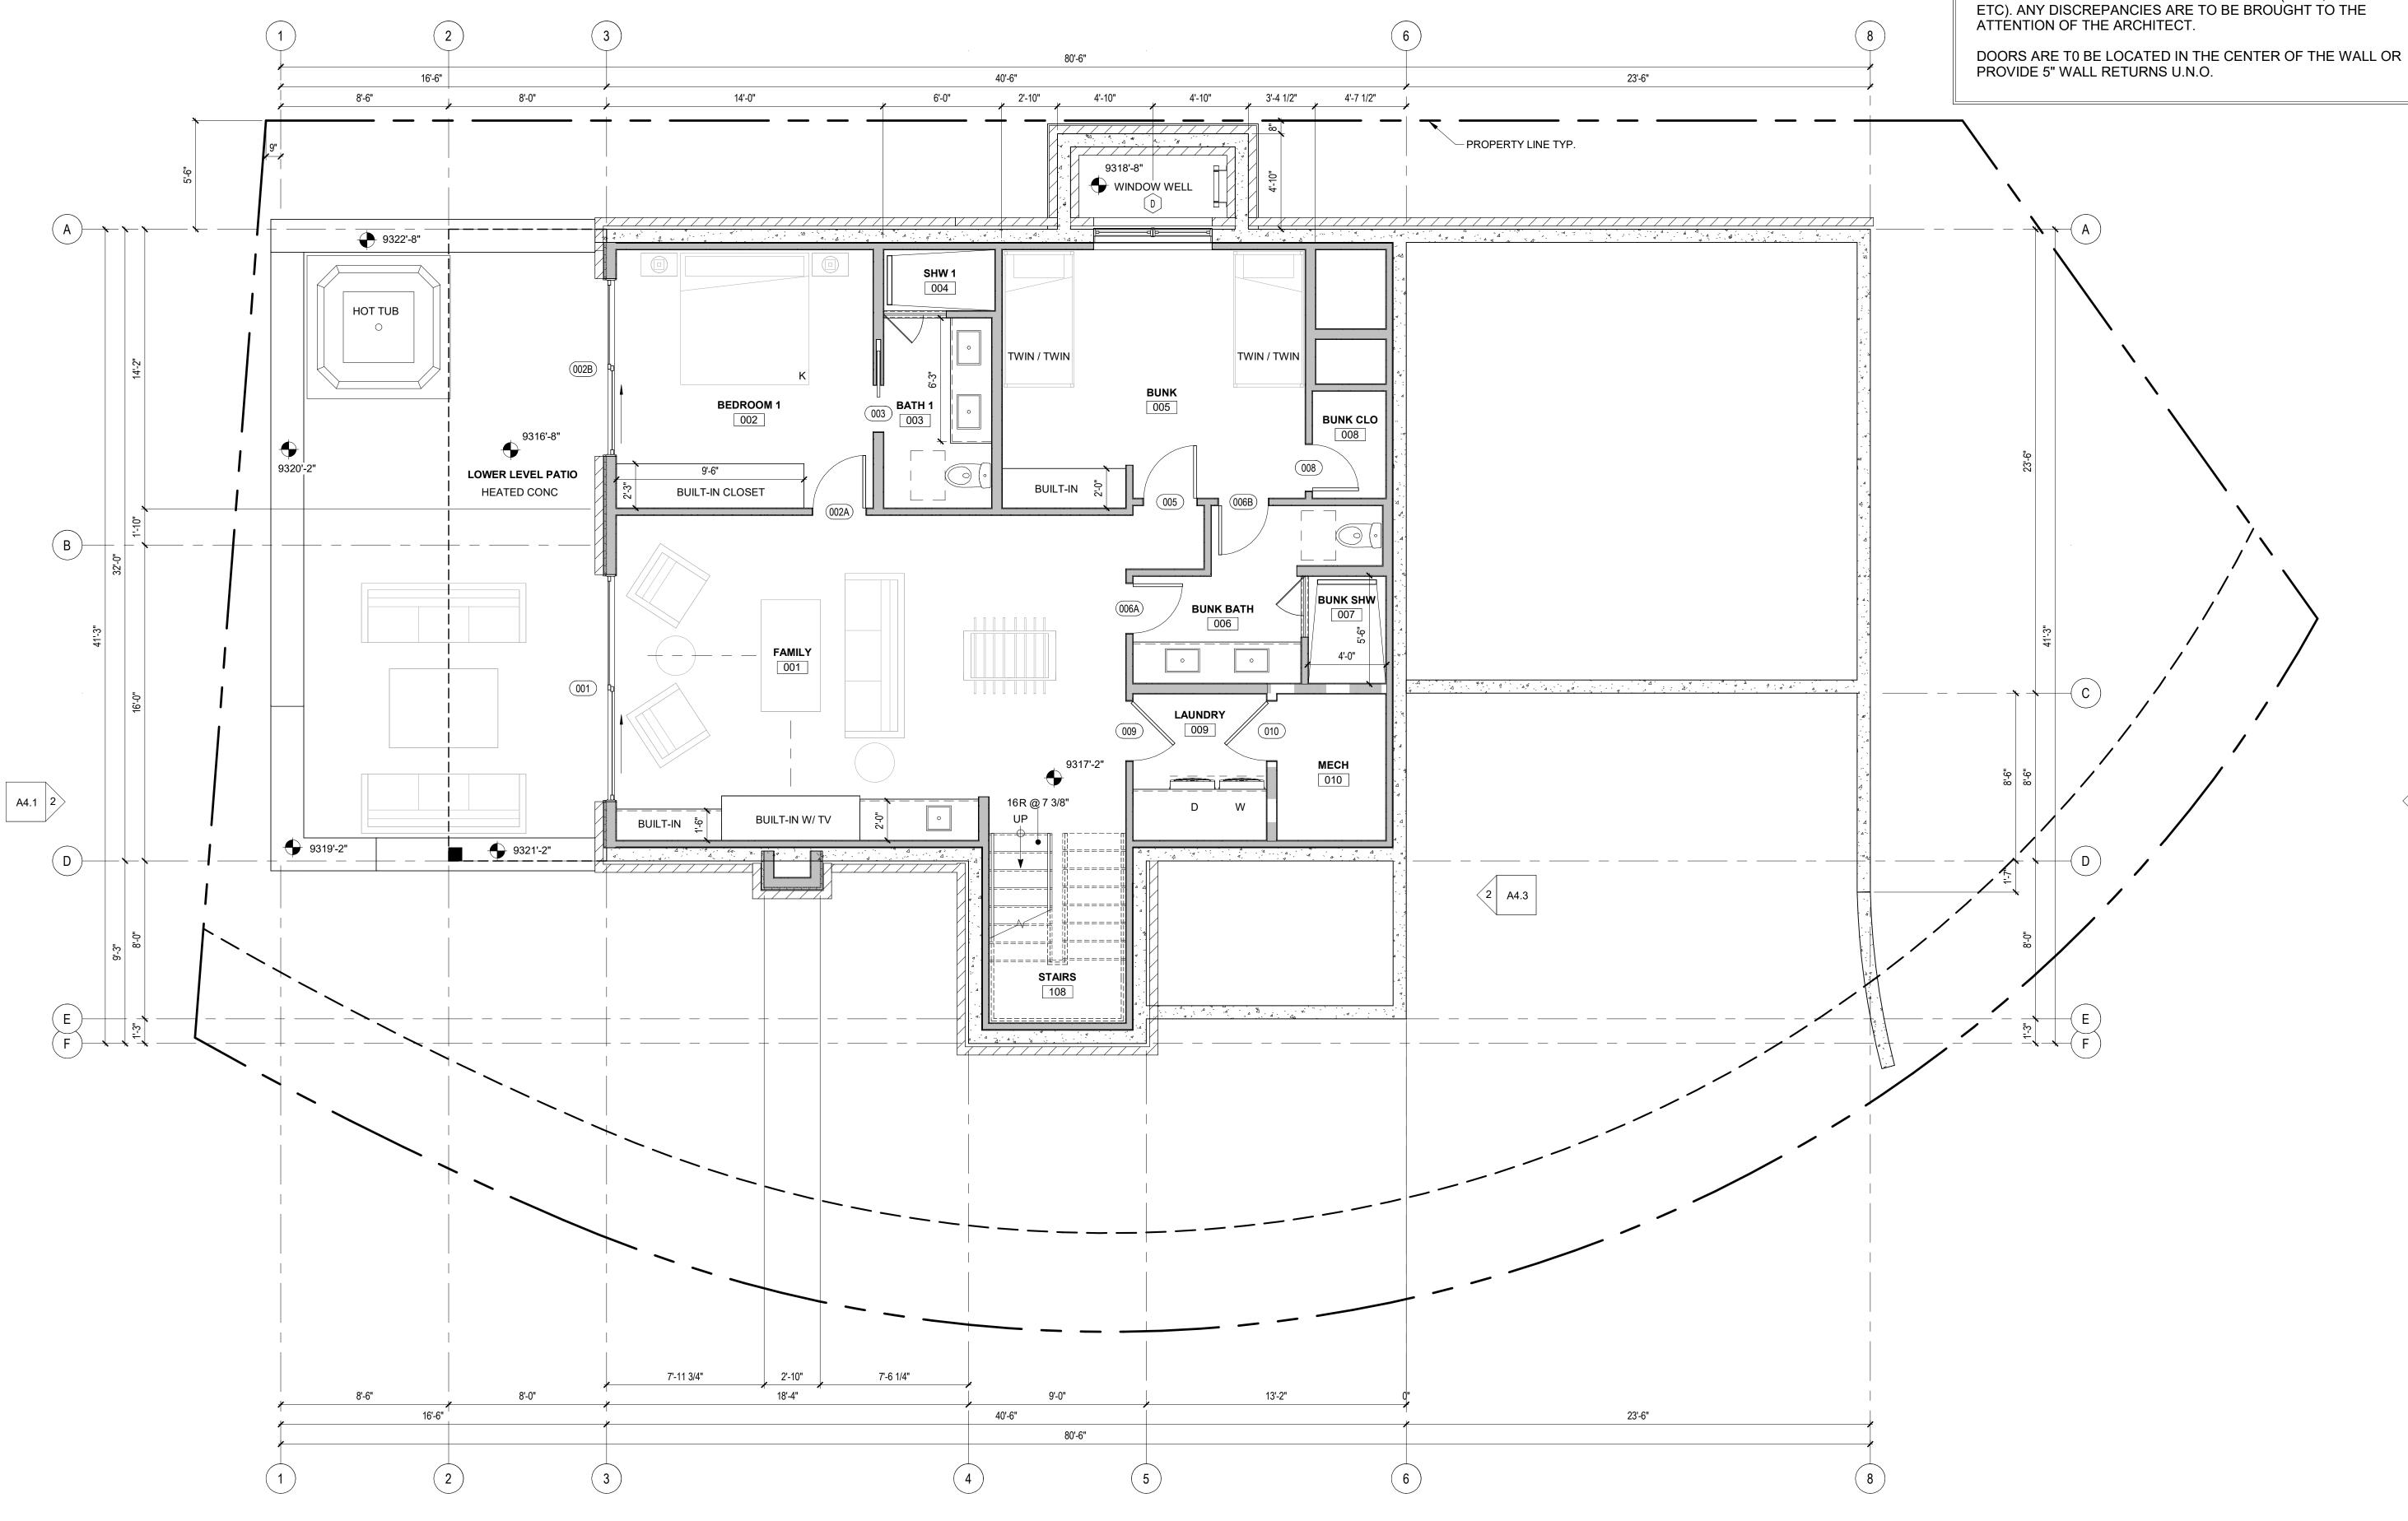
KNOLL

MATERIAL CALCULATIONS



LOWER LEVEL PATIO SOUTH



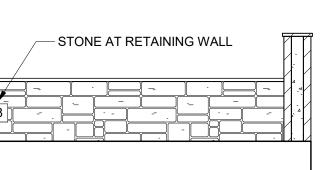


A4.2 

# **FLOOR PLAN GENERAL NOTES:**

DIMENSIONS:

ALL PLAN DIMENSIONS ARE TO STRUCTURE (STUD, CONCRETE,

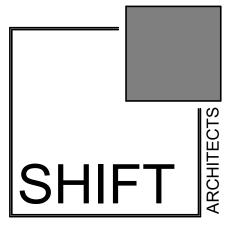

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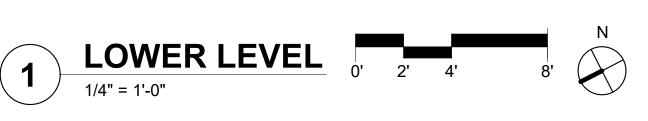
PROJECT ISSUE DATE: 12.05.23 DRB PRELIMINARY SUBMITTAL REVISIONS NO. DATE DESC.




<1 A4.1

FLOOR PLAN

NO S Z O r 





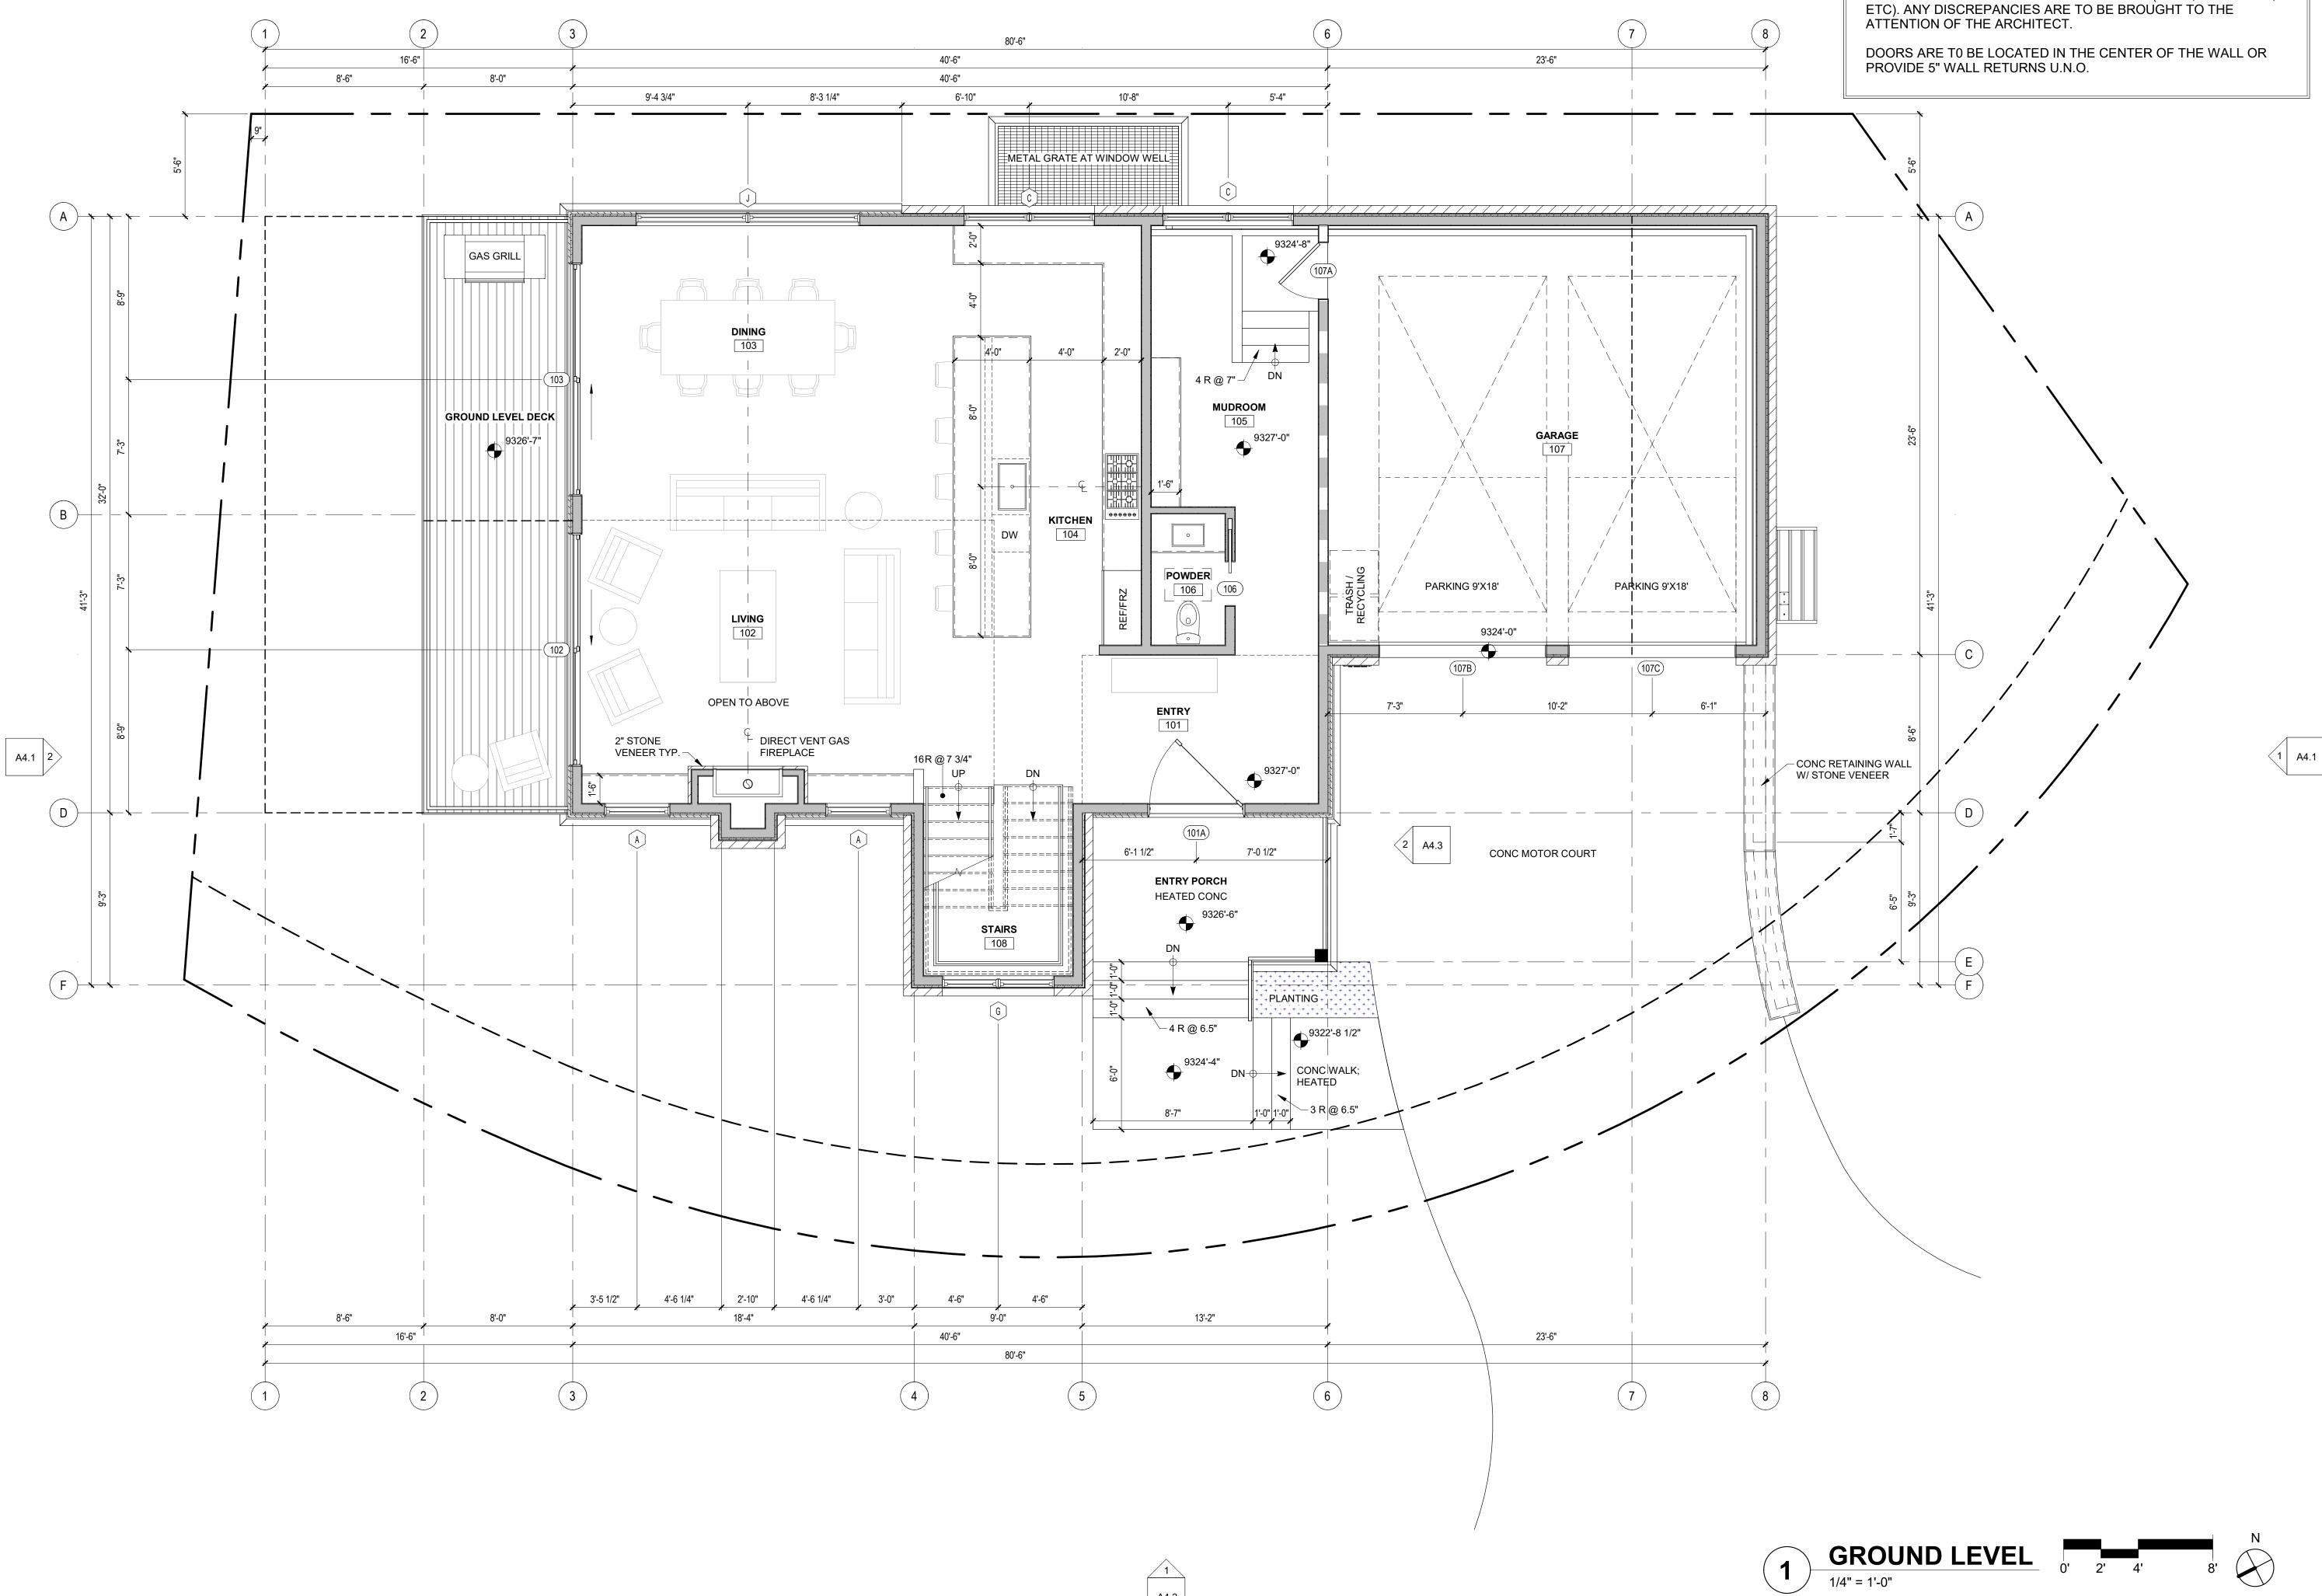






DIMENSIONS:

ALL PLAN DIMENSIONS ARE TO STRUCTURE (STUD, CONCRETE,

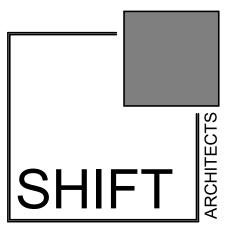

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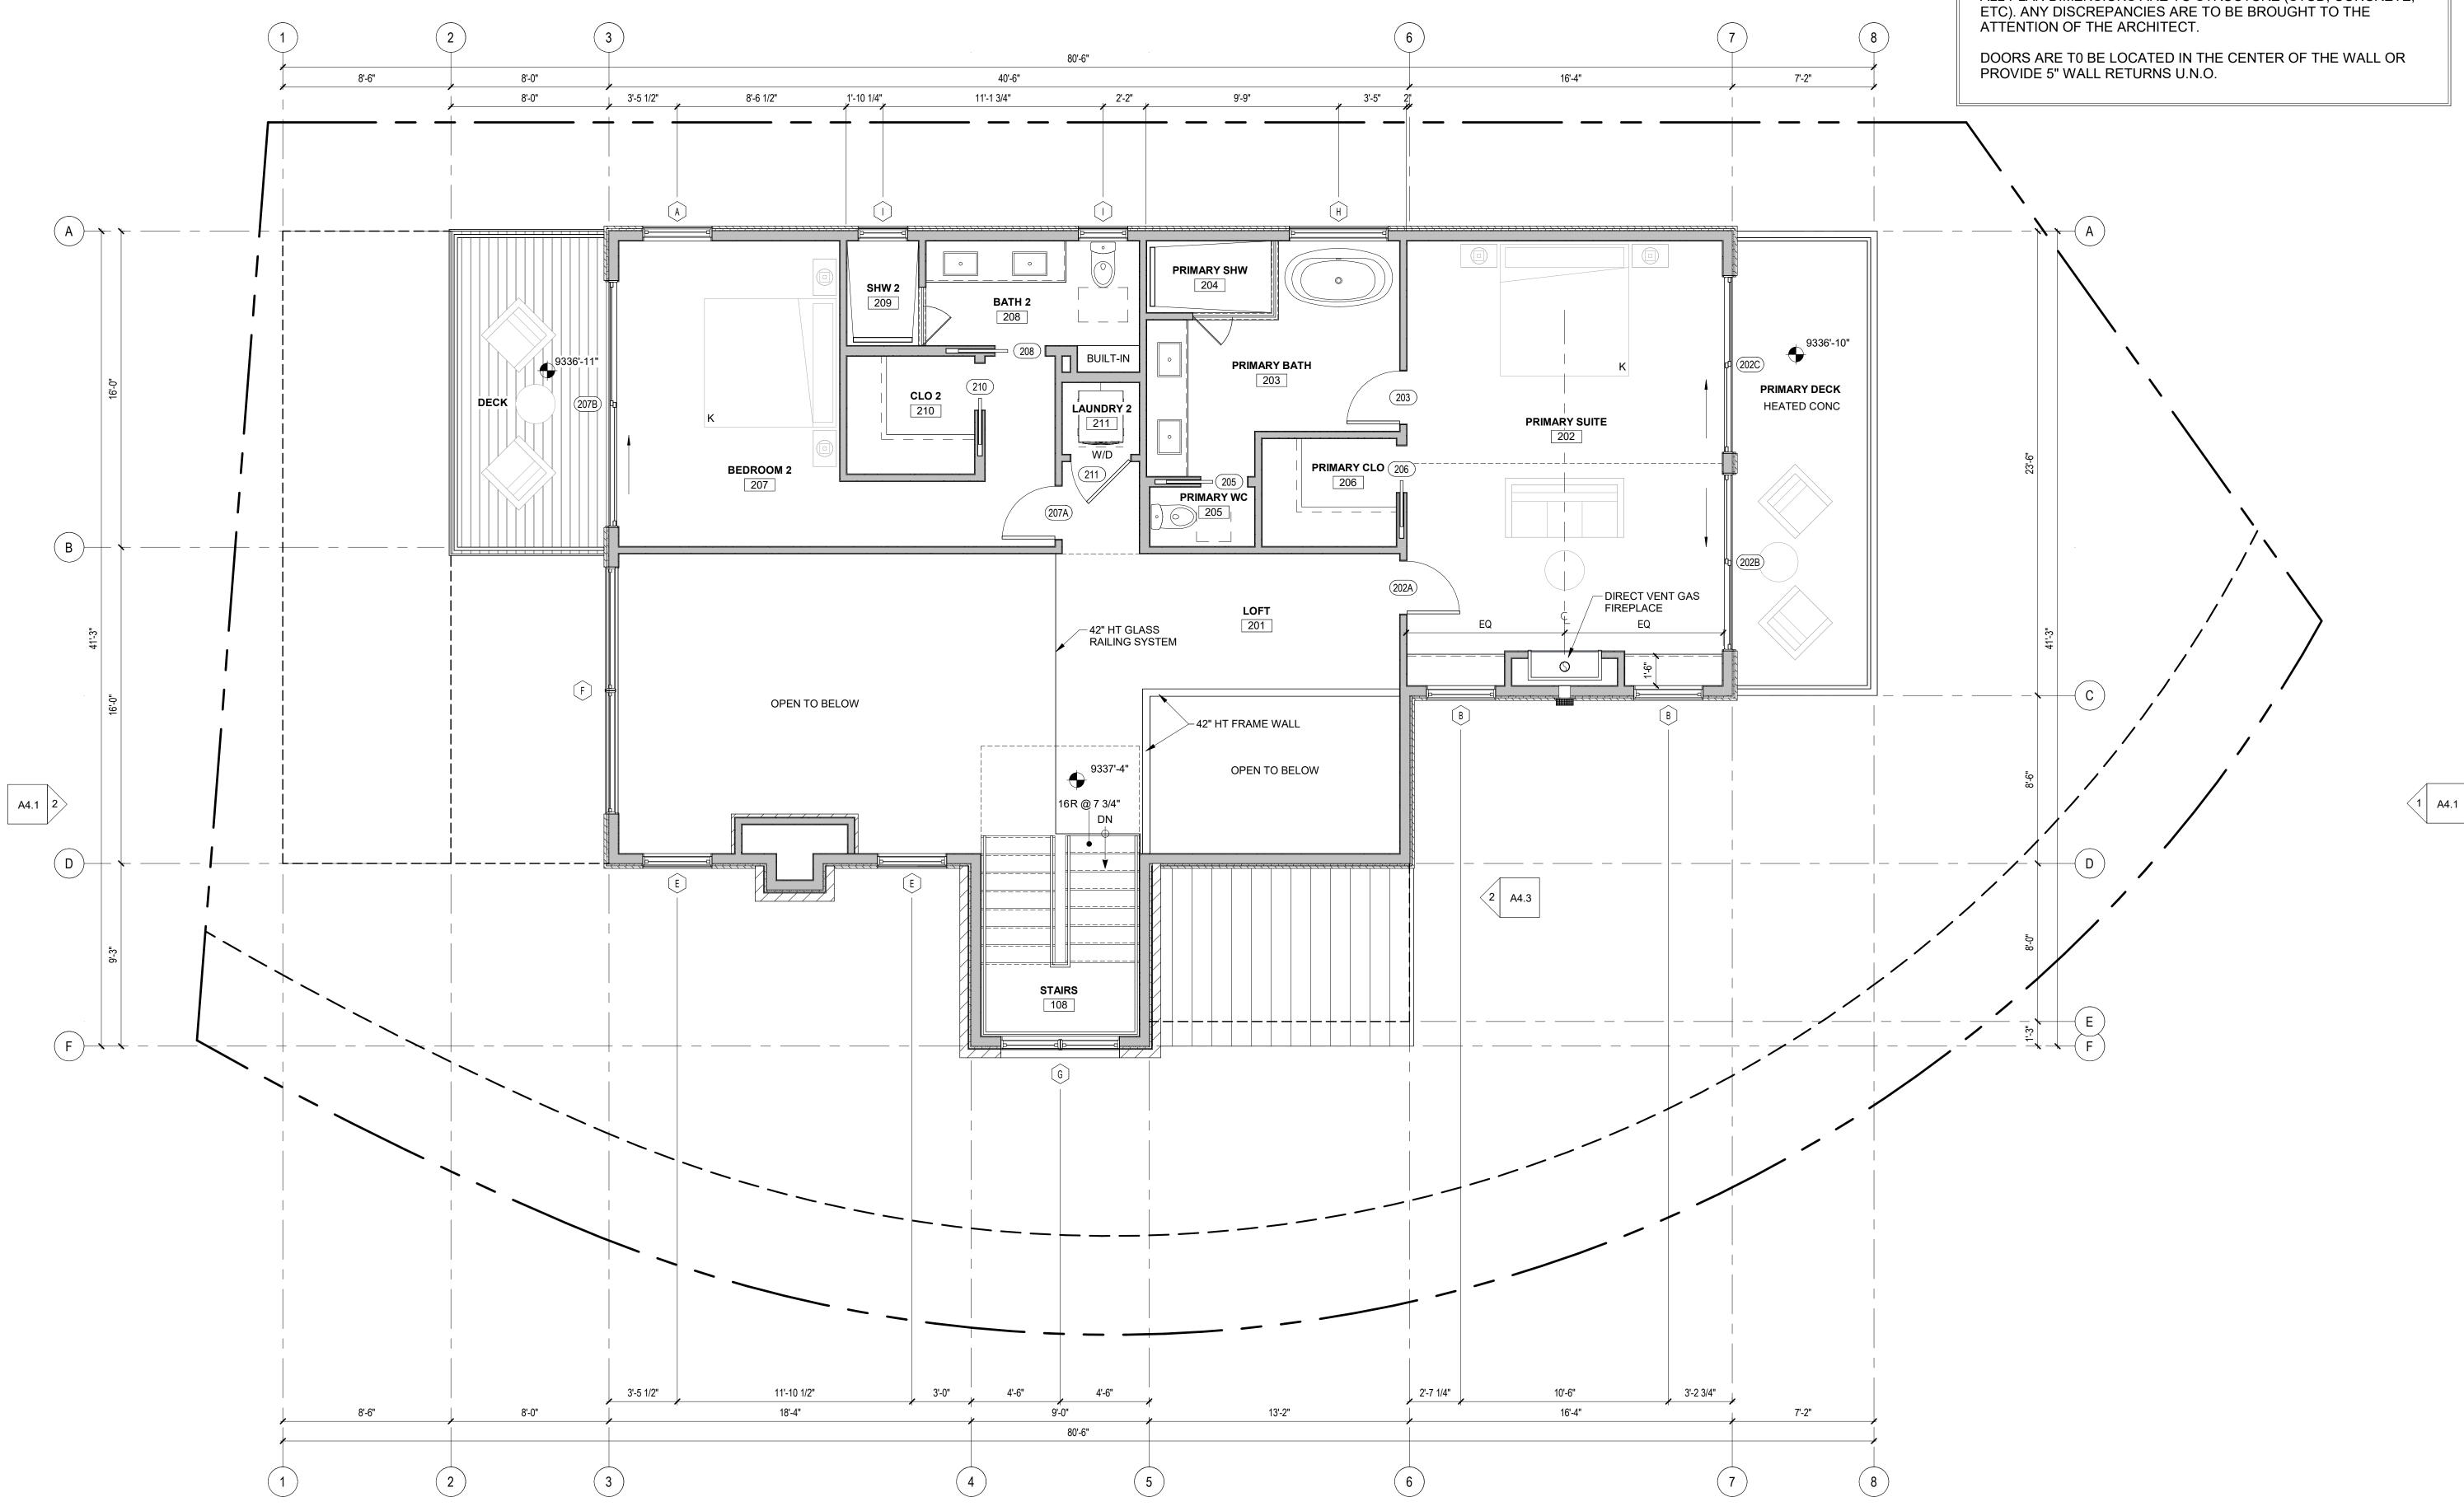


FLOOR PLAN

SHEET NUMBER

A3.2

**LION** S ZO r **L**O






# **FLOOR PLAN GENERAL NOTES:**

DIMENSIONS:

ALL PLAN DIMENSIONS ARE TO STRUCTURE (STUD, CONCRETE,

UPPER LEVEL 0' 2' 4' 8' N

1)

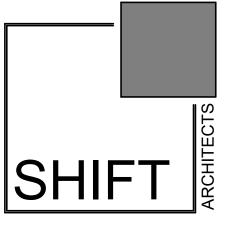

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SHEET NUMBER

A3.3

100 EAGLE DRIVE, MOUNTAIN VIL UNIT 1 THE KNOLL ESTATES LOT REC 10 6 95 BK 1 PG 1918


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**IATES** 


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KNOLL


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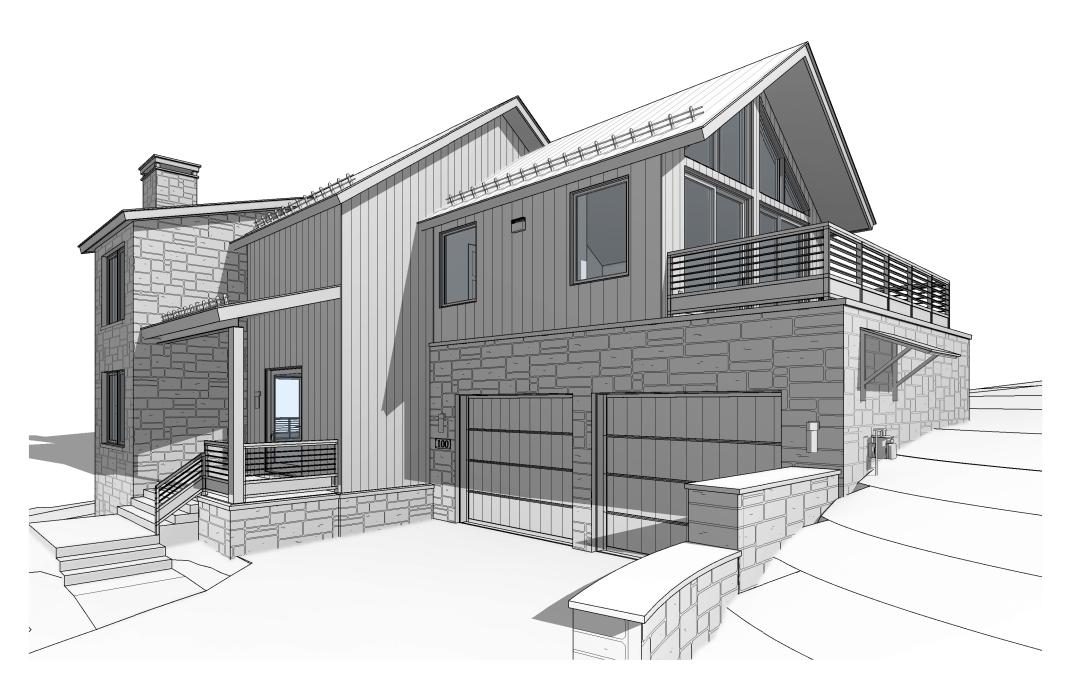
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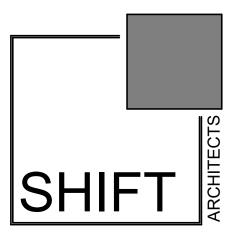






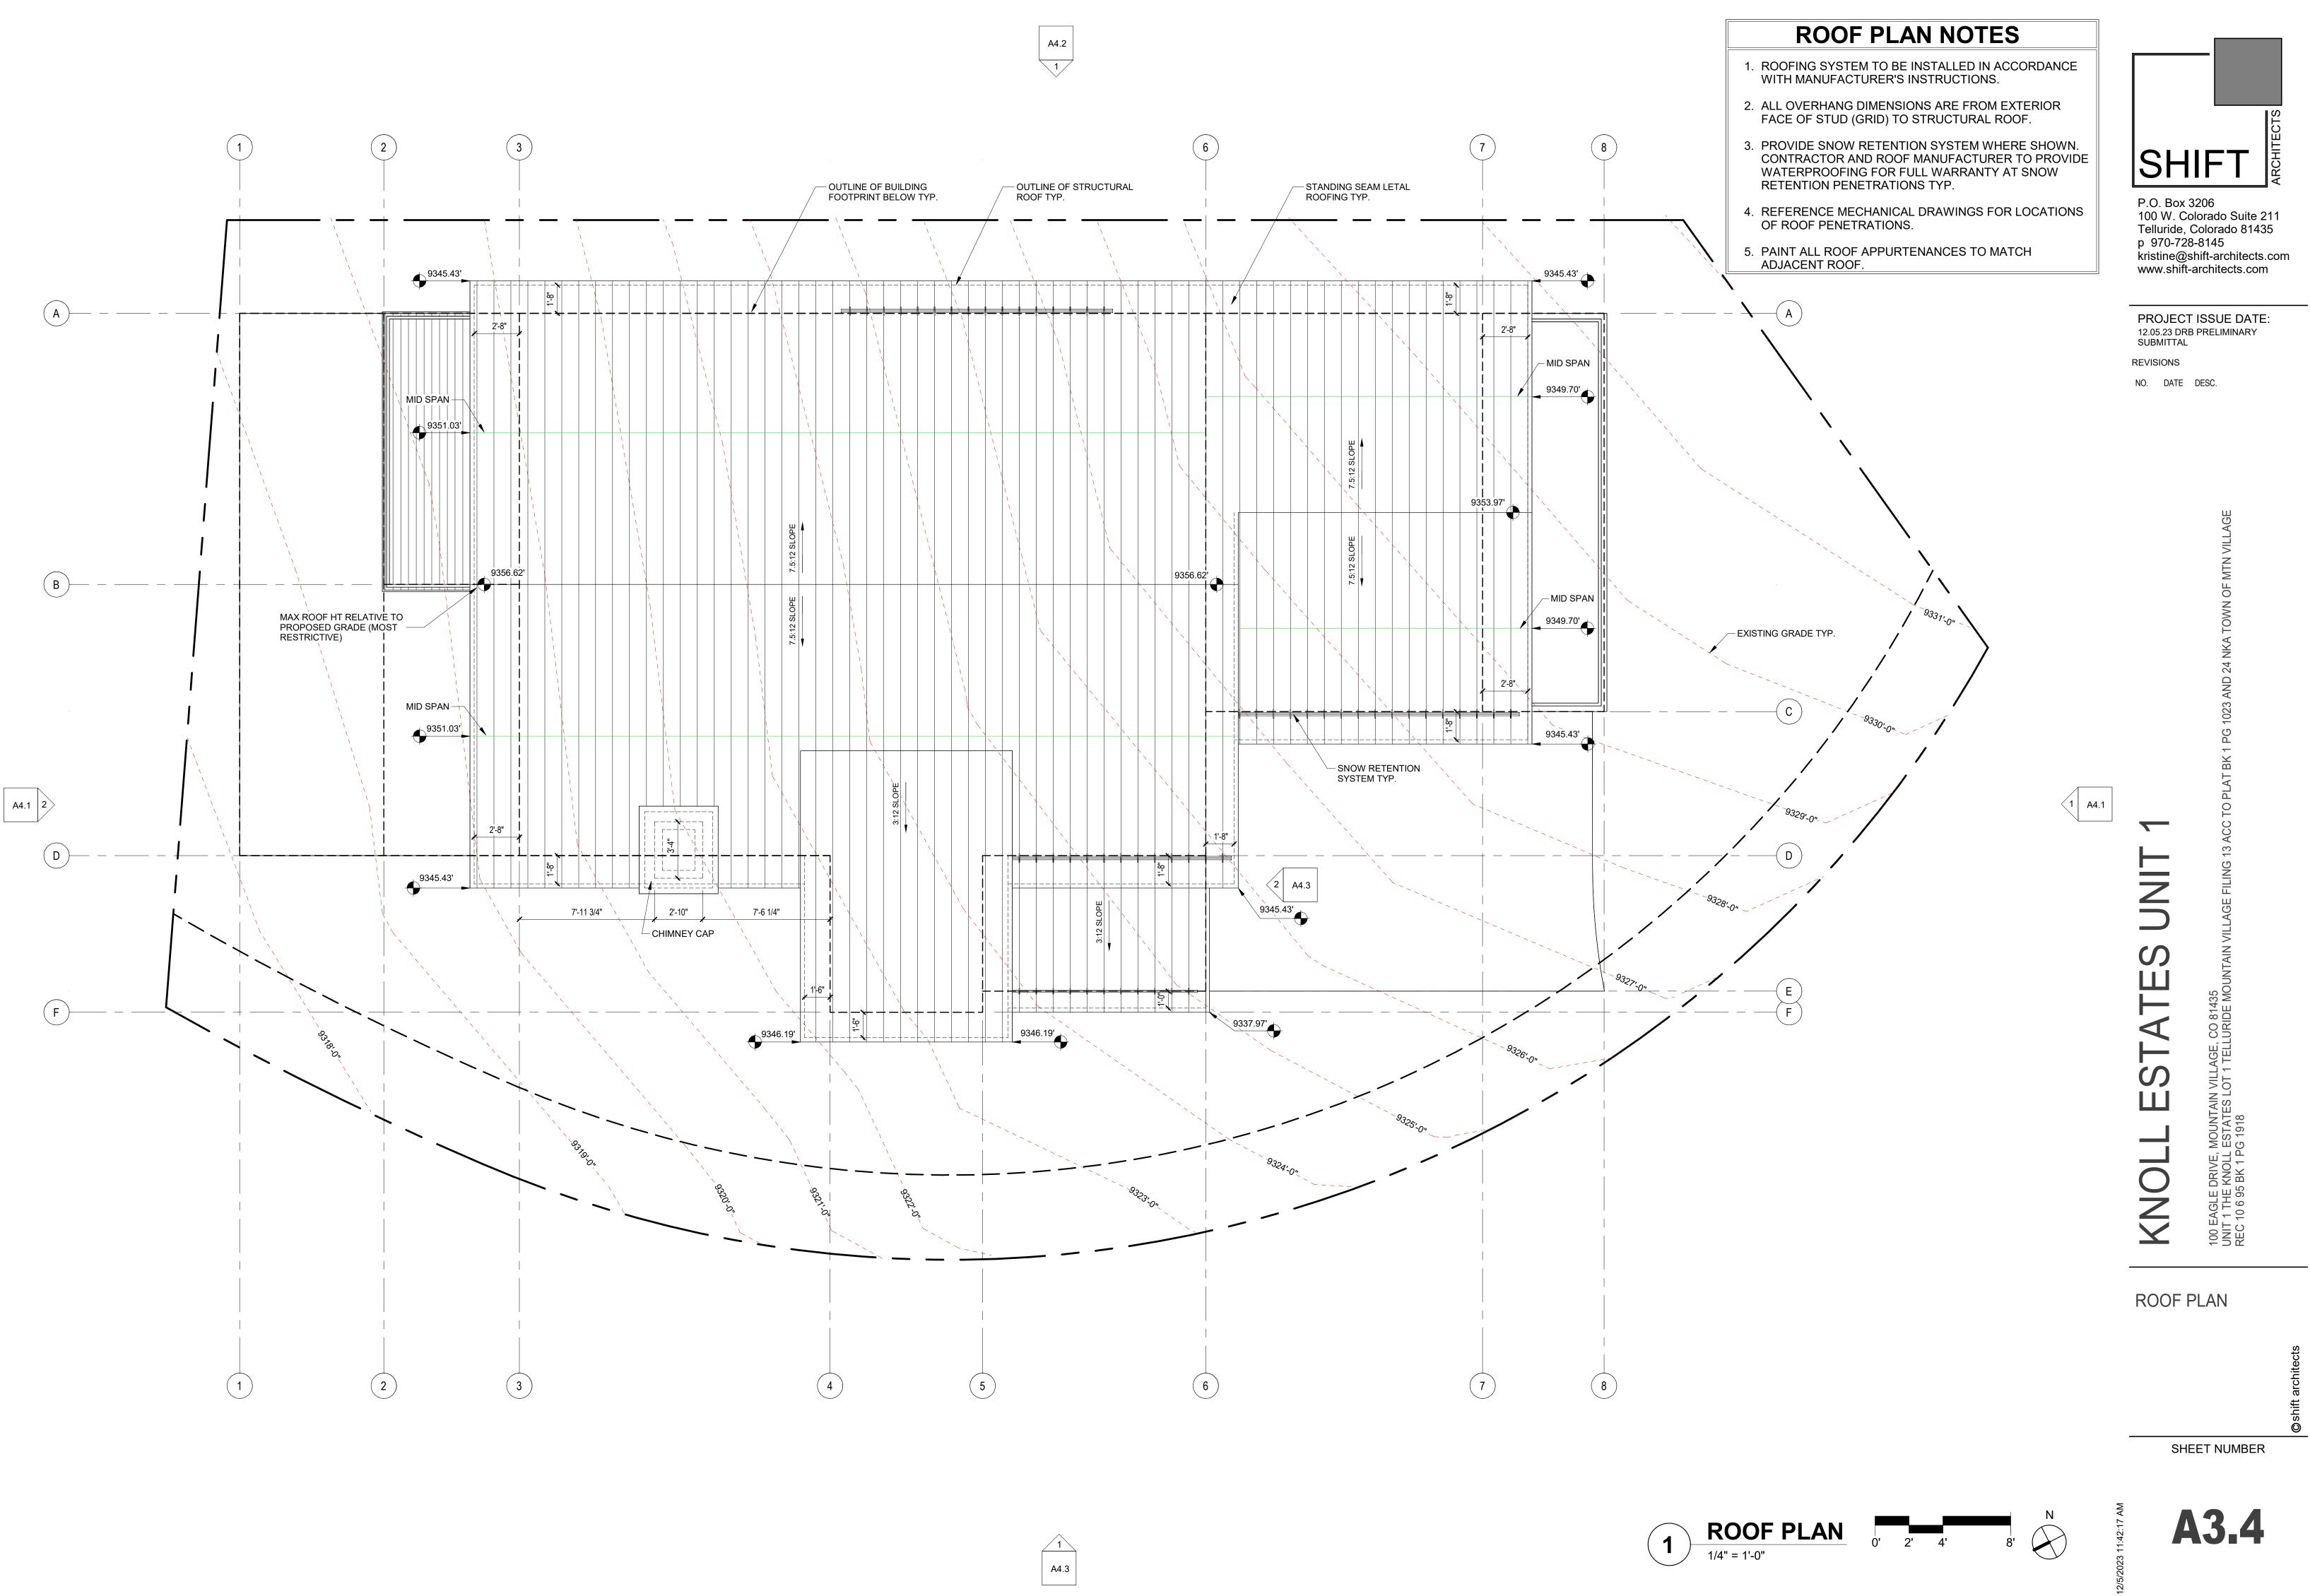

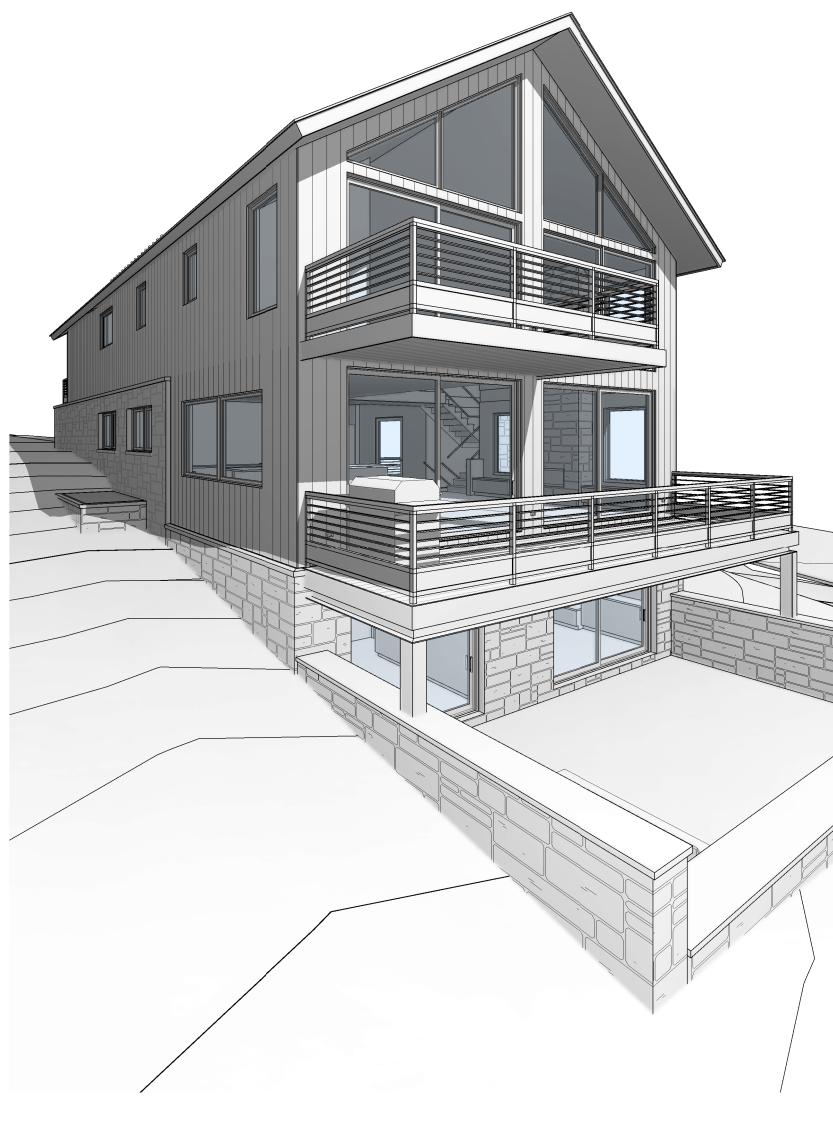

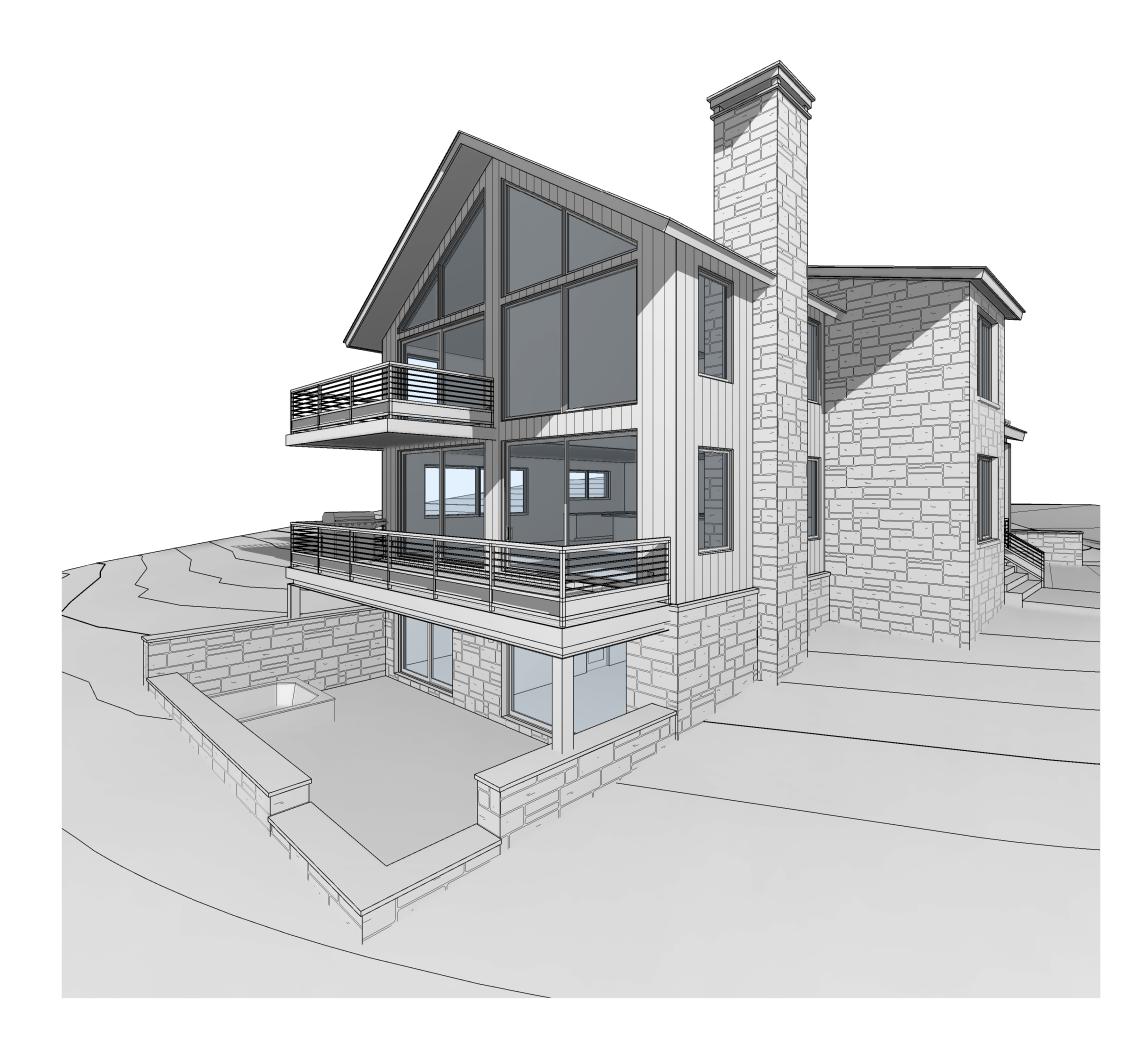

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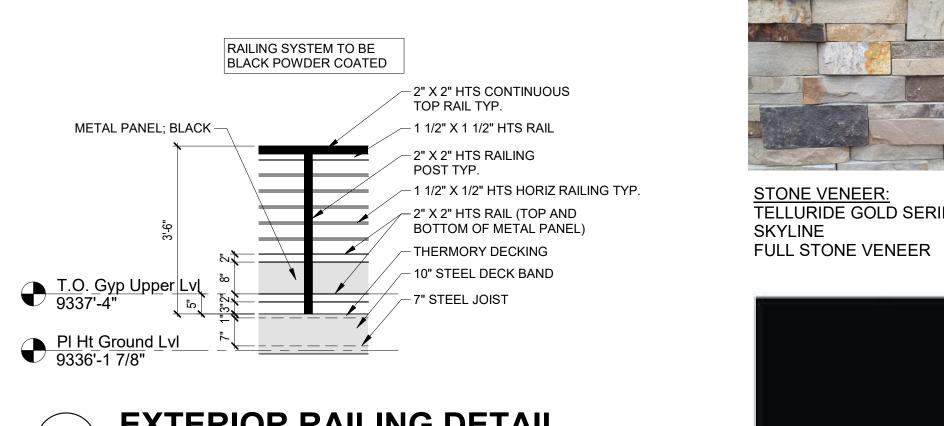


8143 IDF N


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WINDOWS / DOORS:












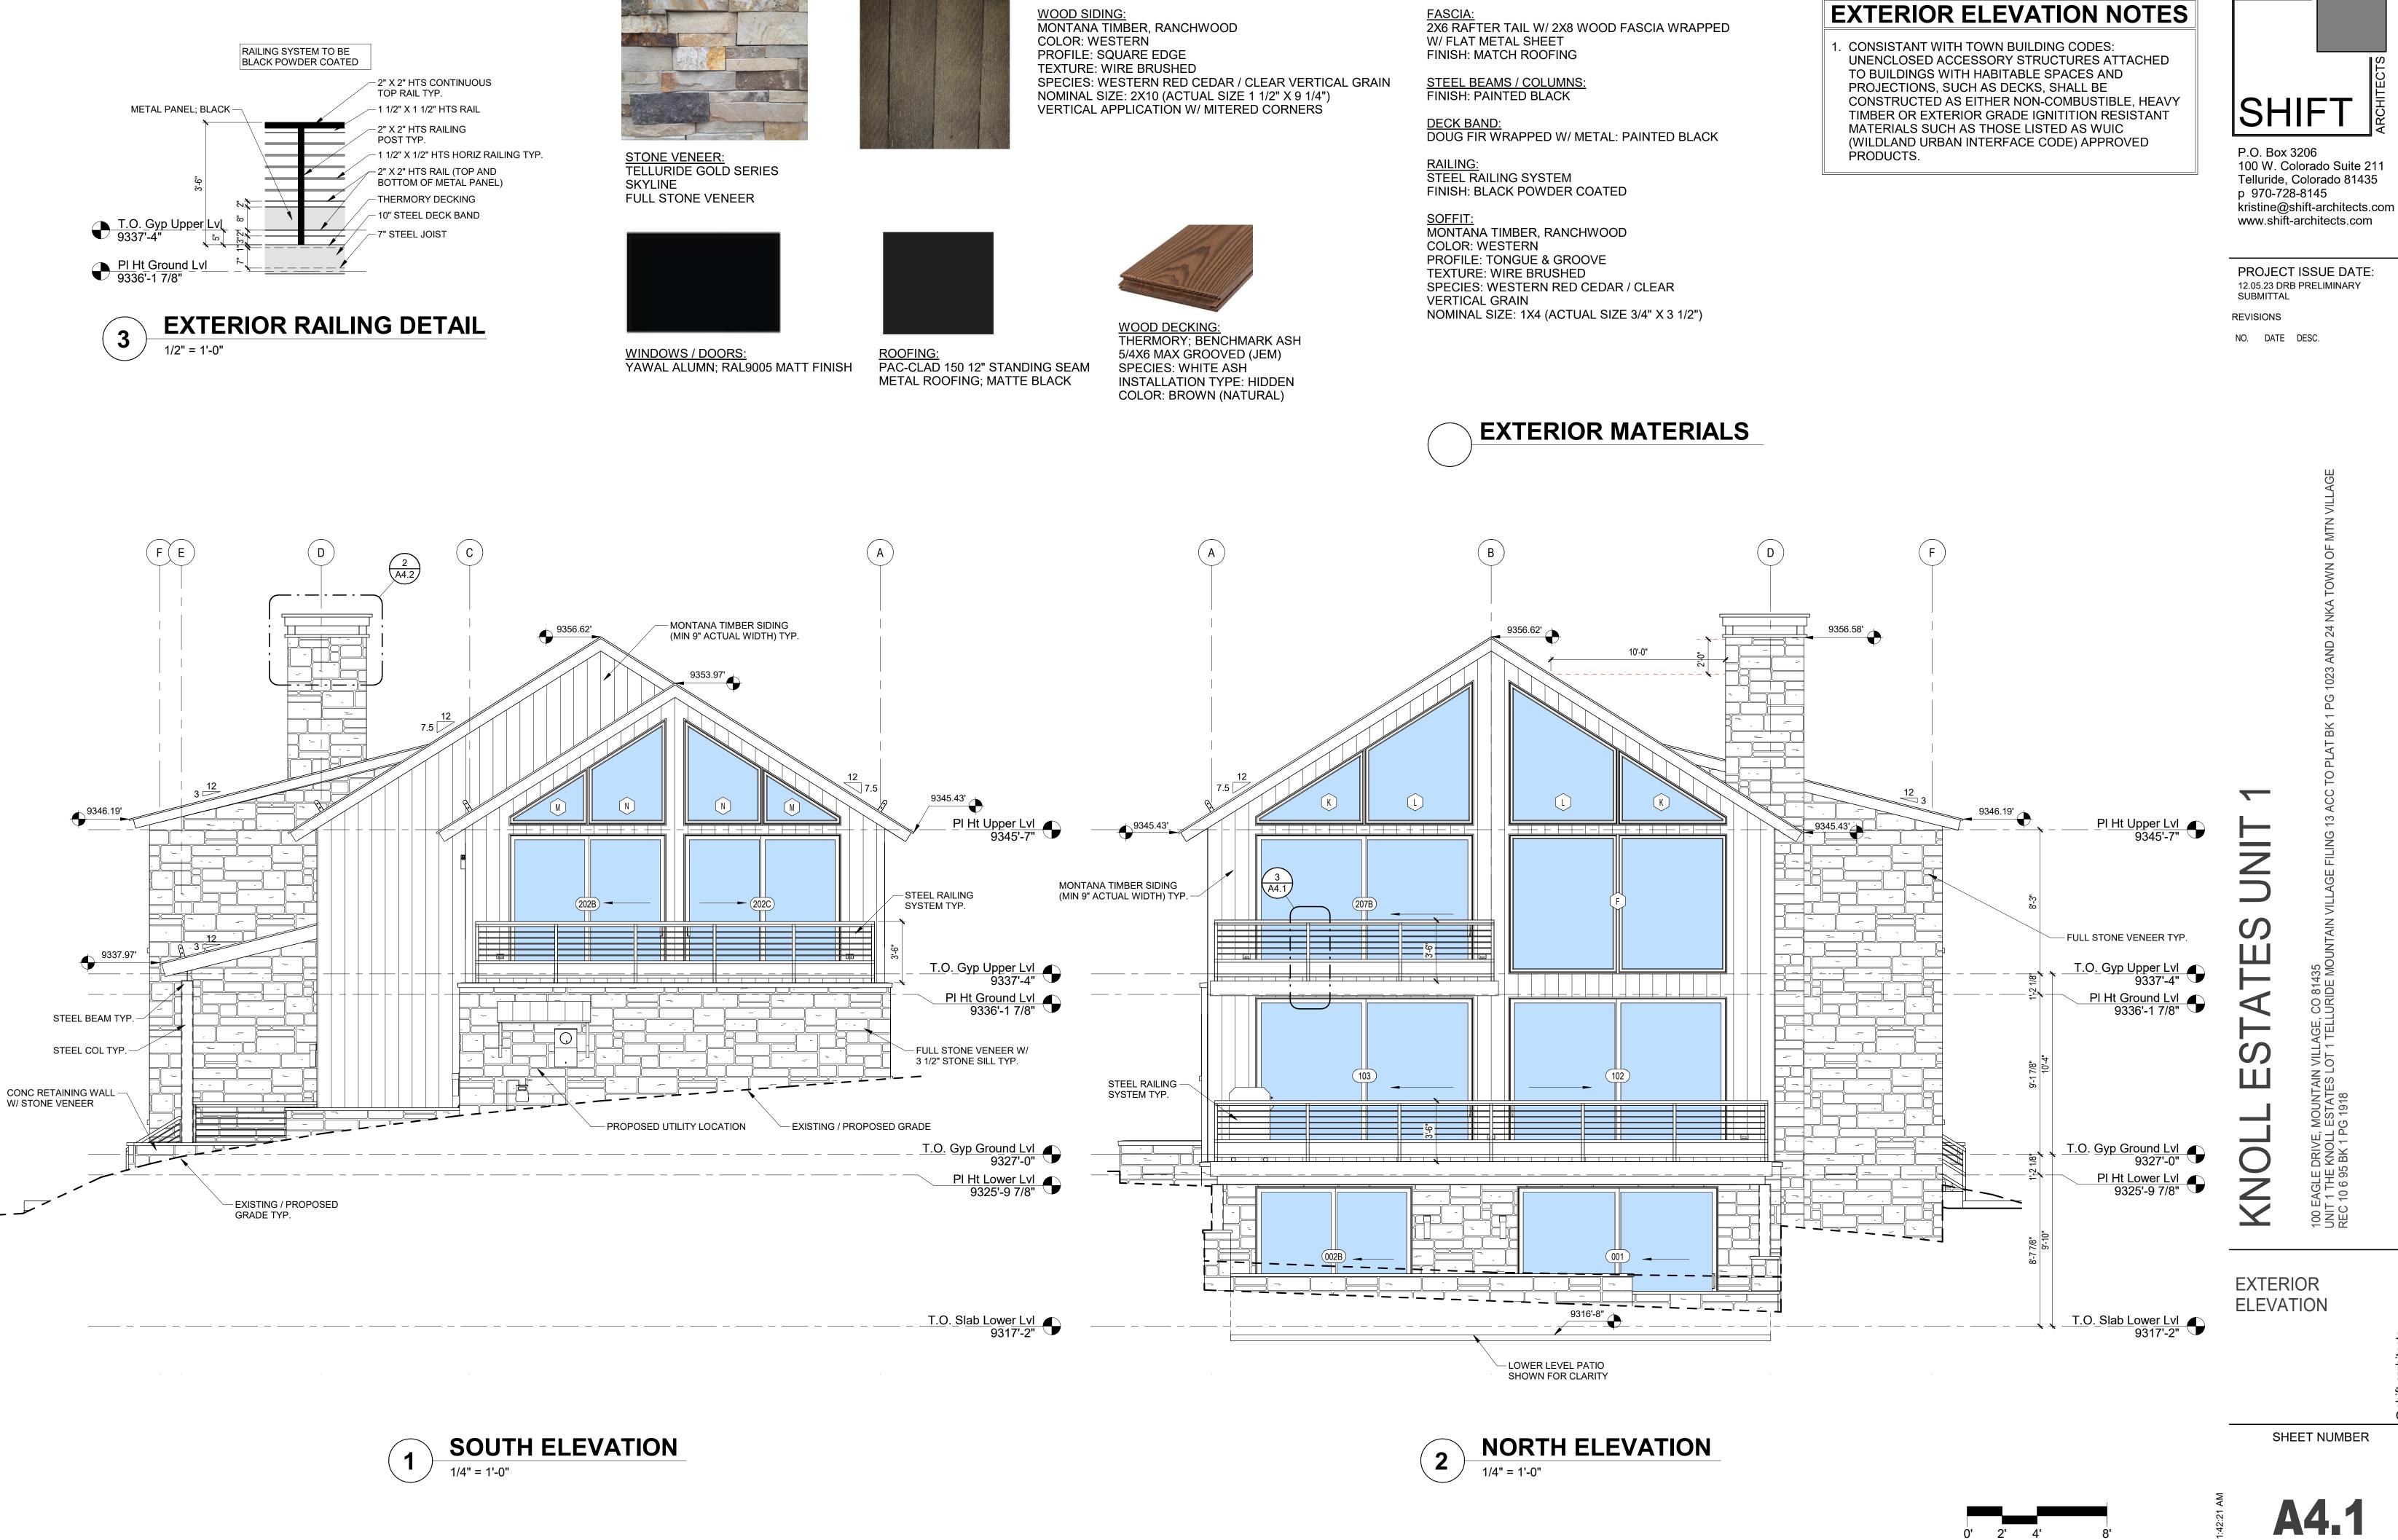


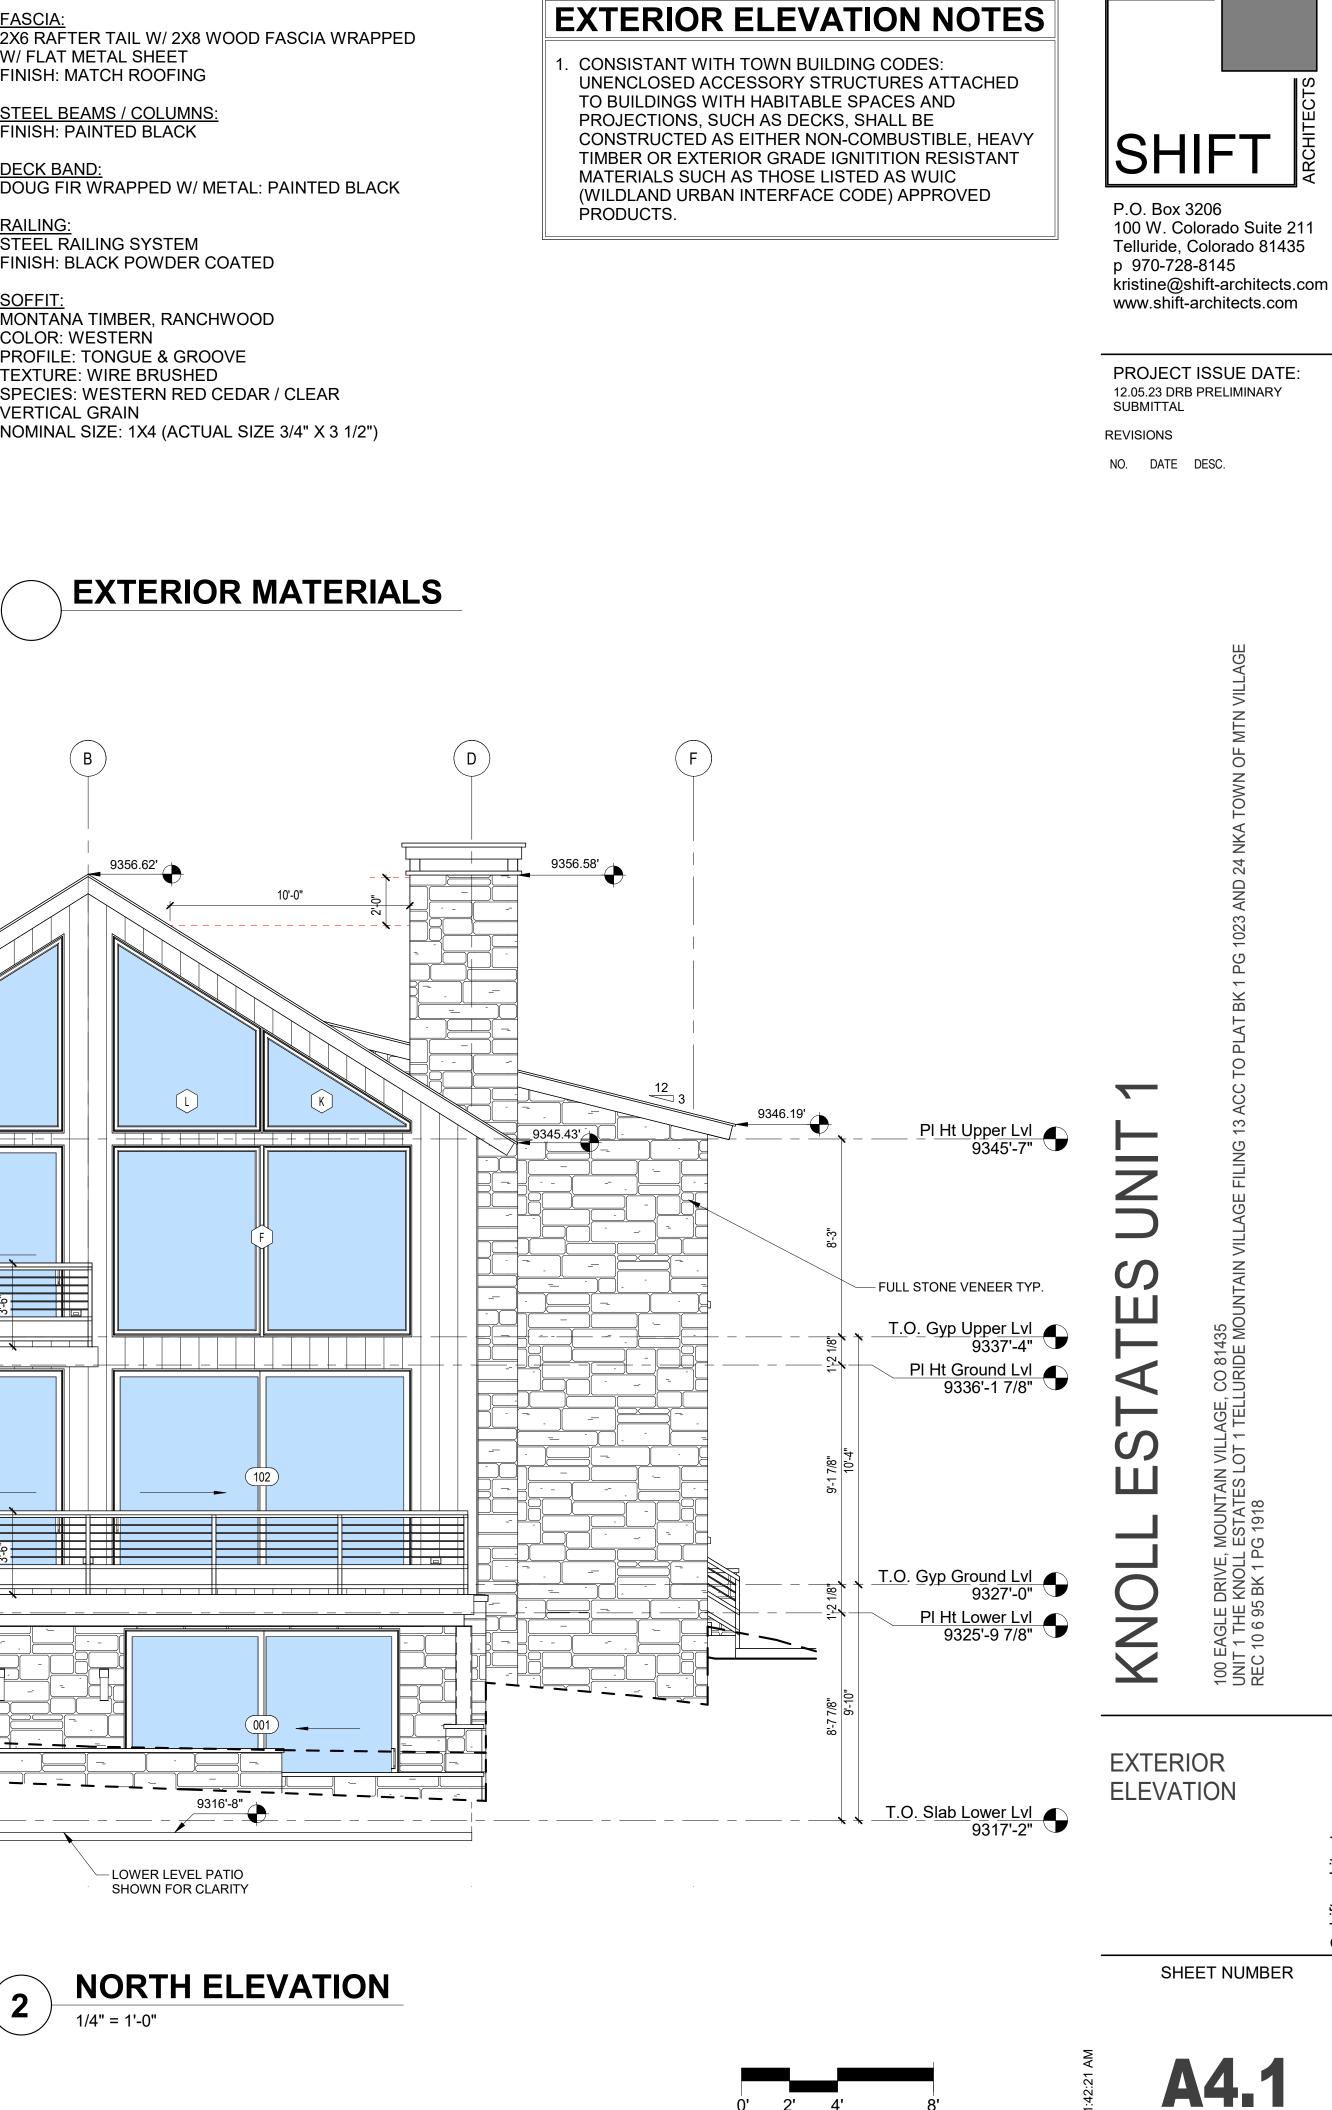

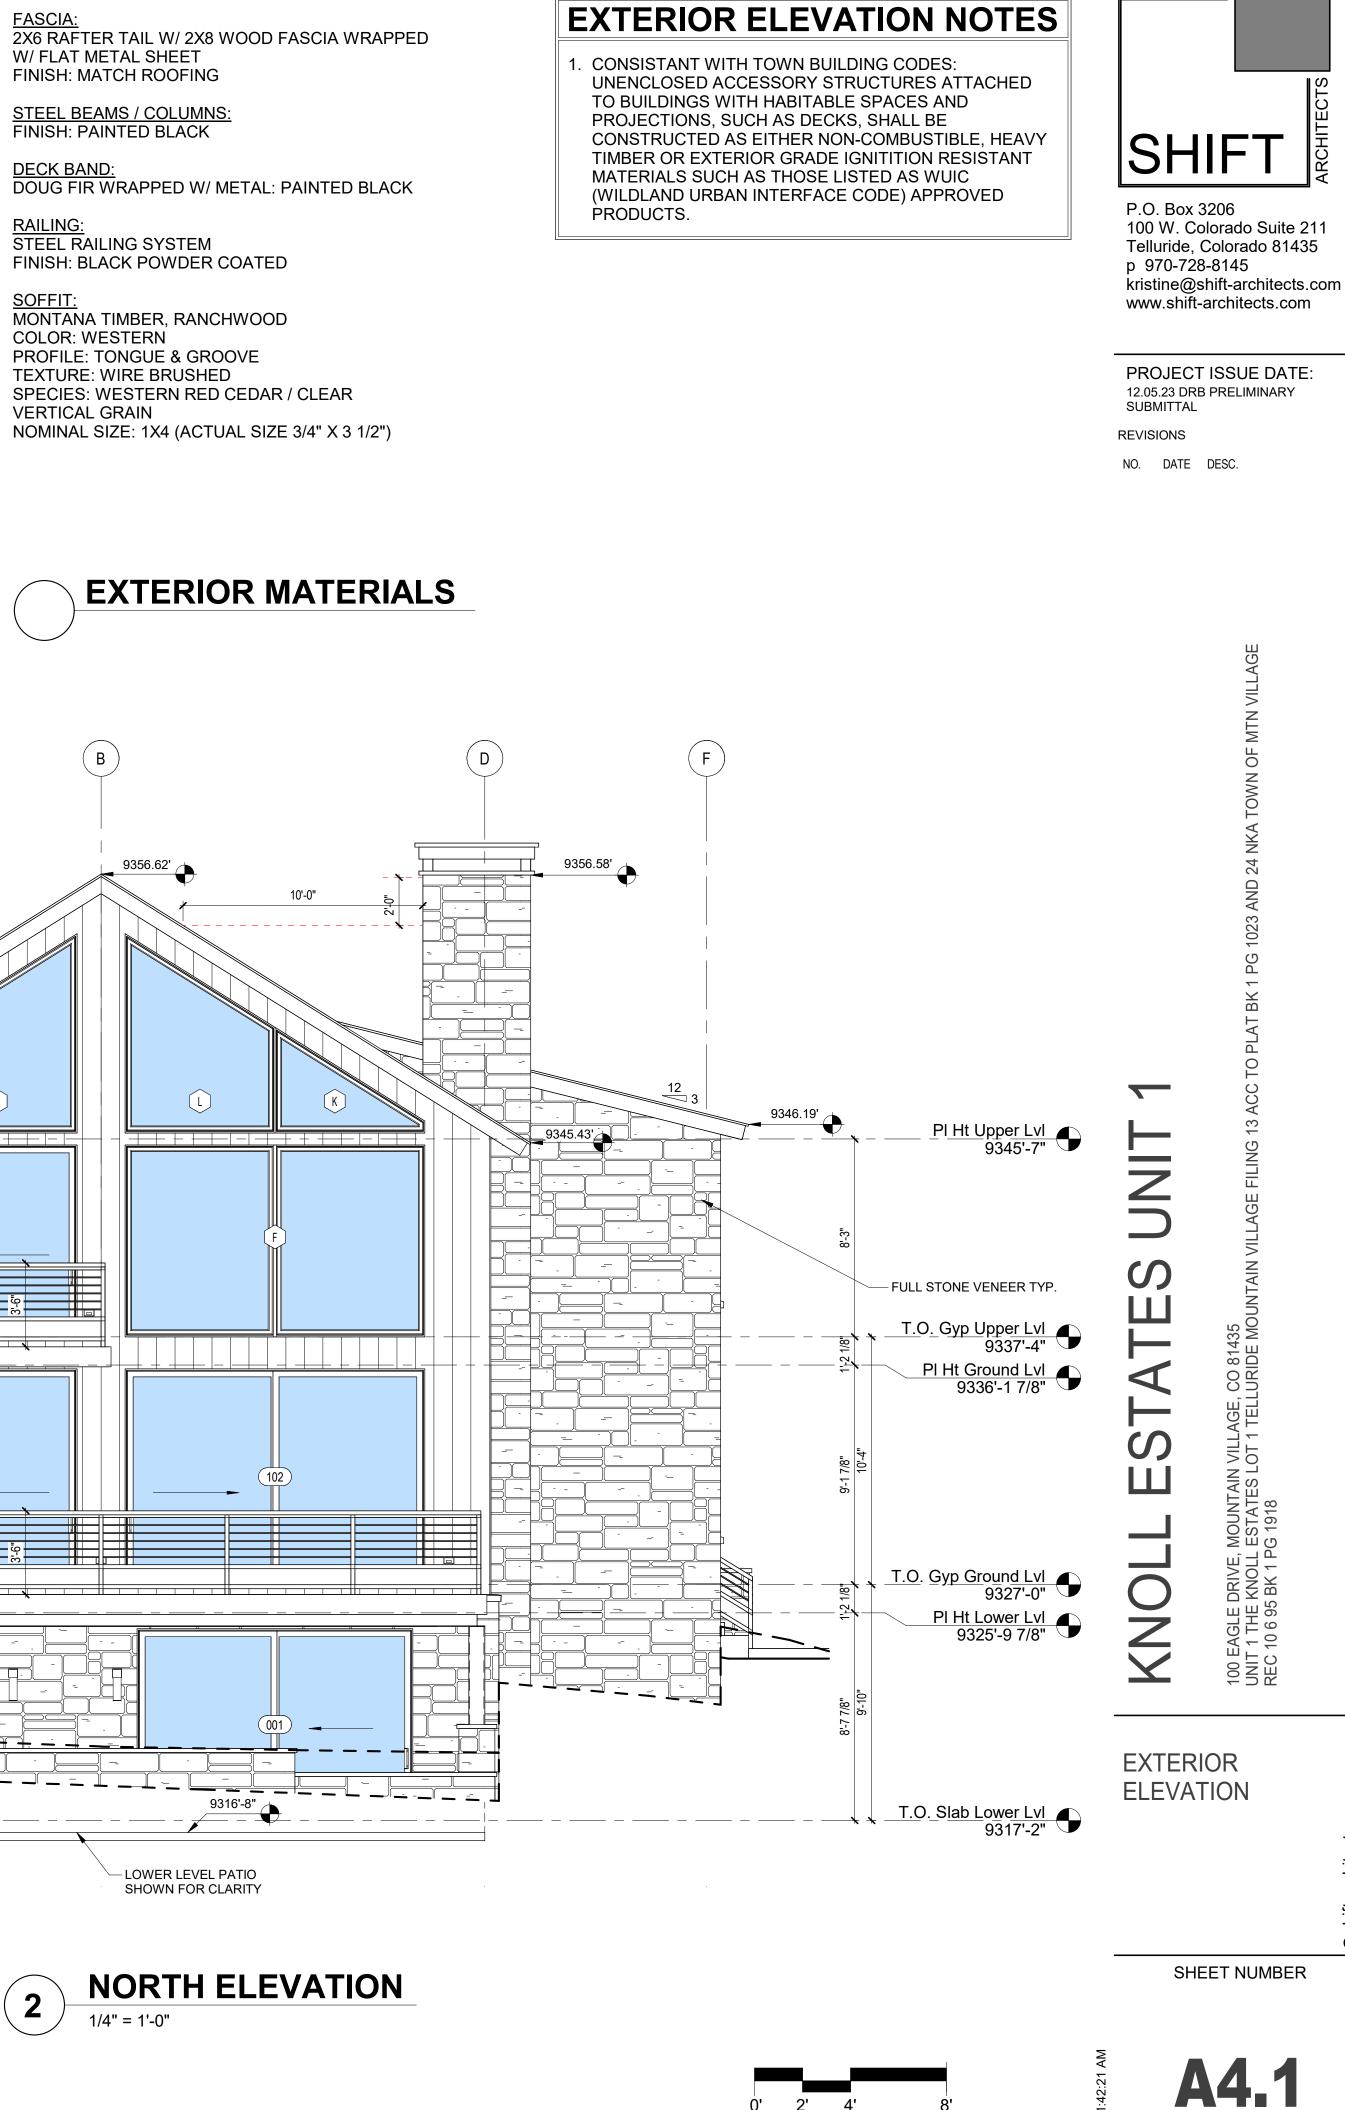


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S

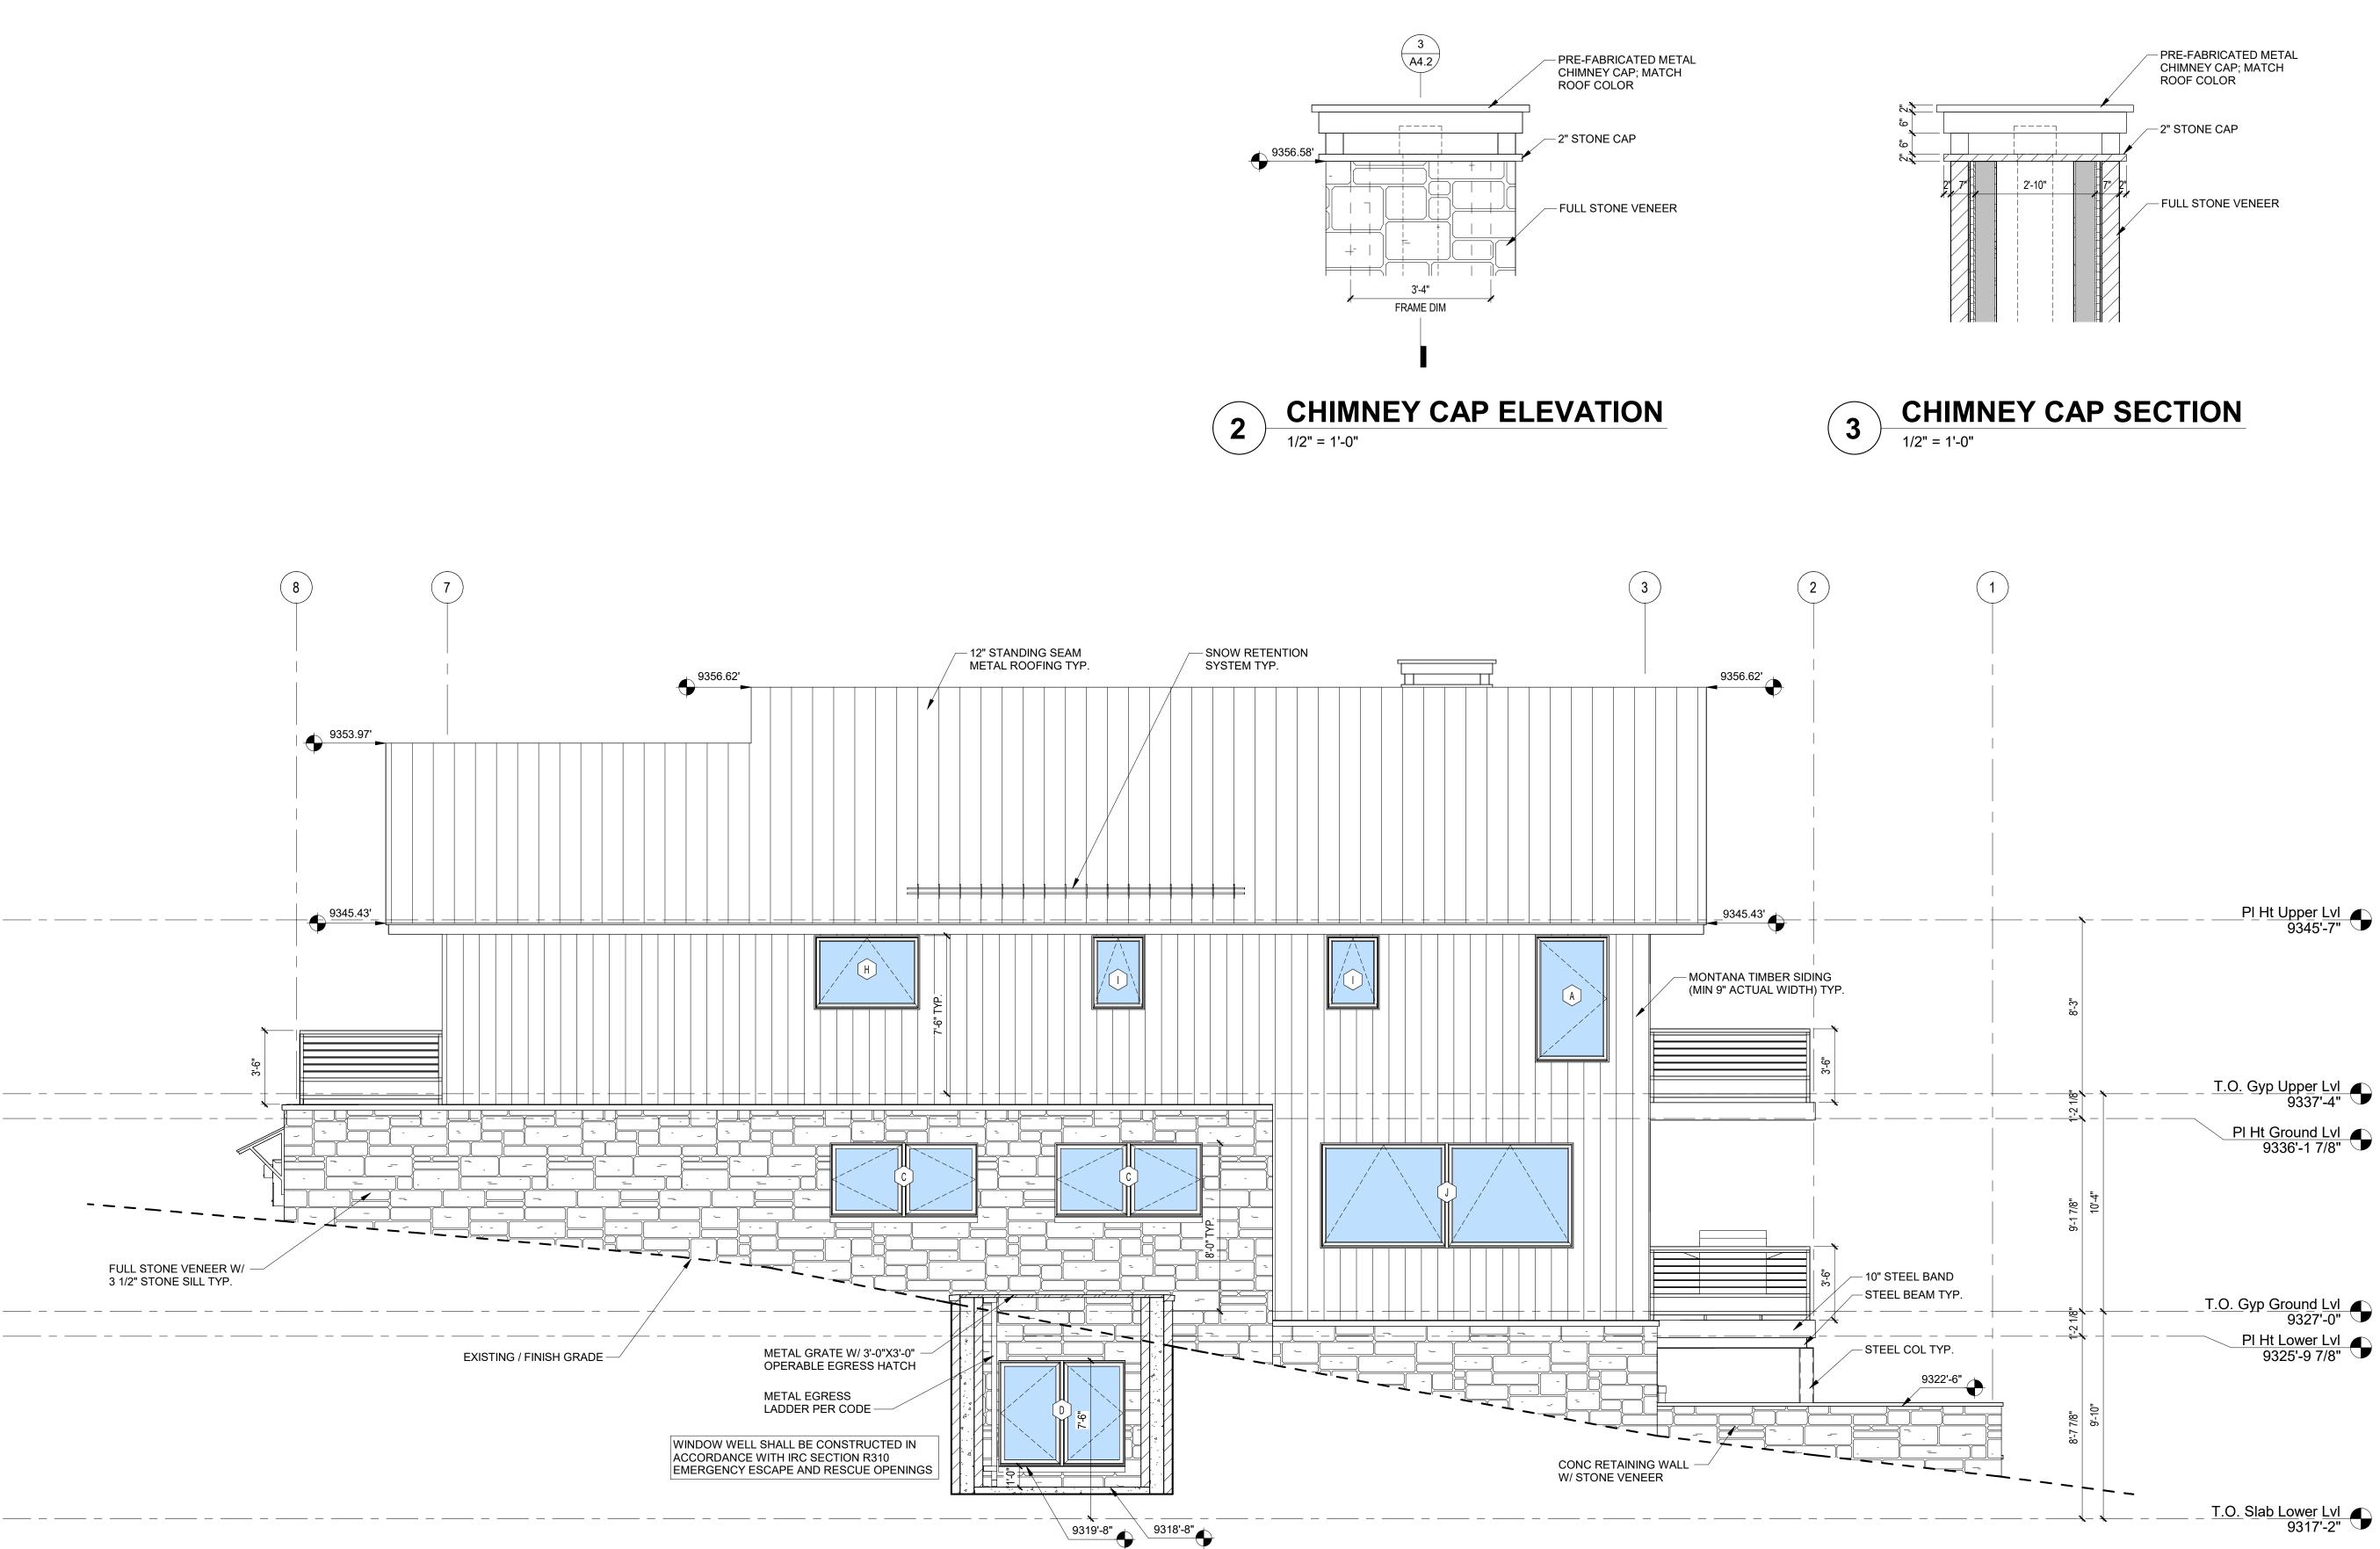ESTATE

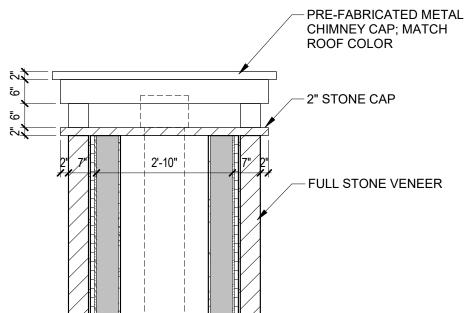KNOLL

EXTERIOR

ELEVATION

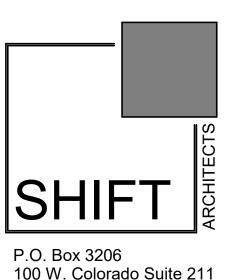
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100 EAGLE DRIVE, MOUNTAIN VILLAGE, CO UNIT 1 THE KNOLL ESTATES LOT 1 TELLURI REC 10 6 95 BK 1 PG 1918








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A4.3

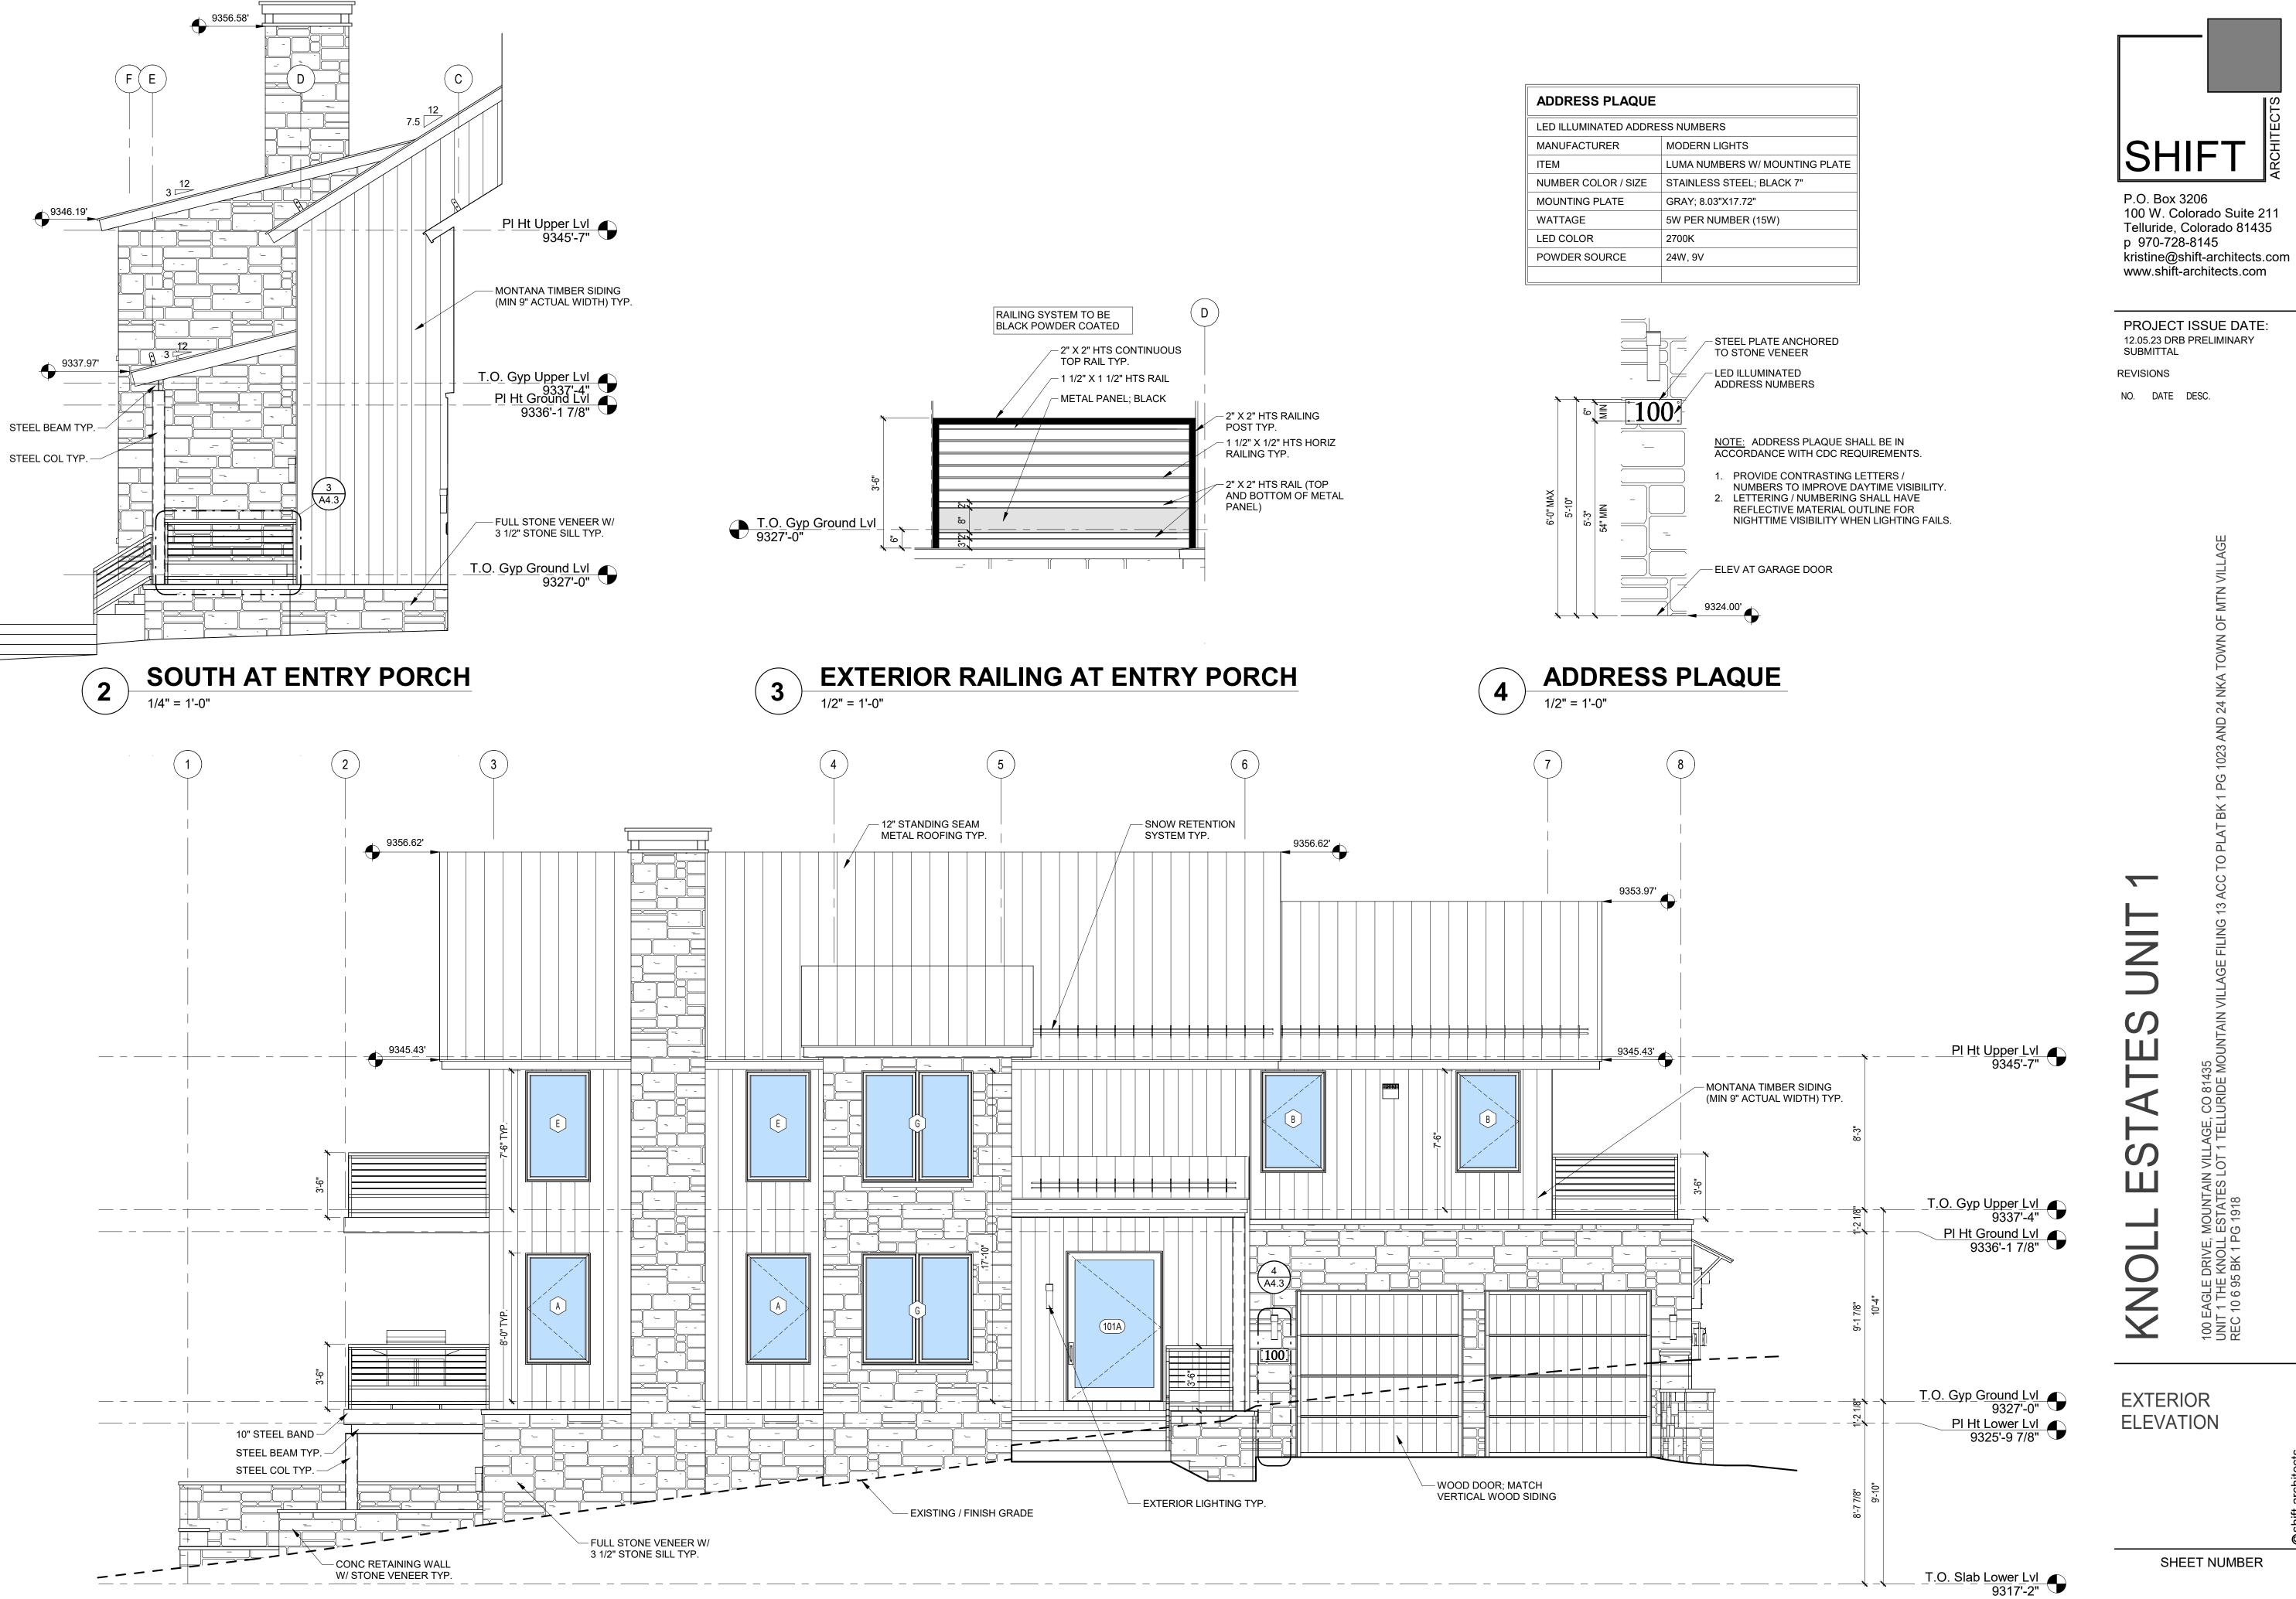**WEST ELEVATION** 1/4" = 1'-0"

0' 2' 4'



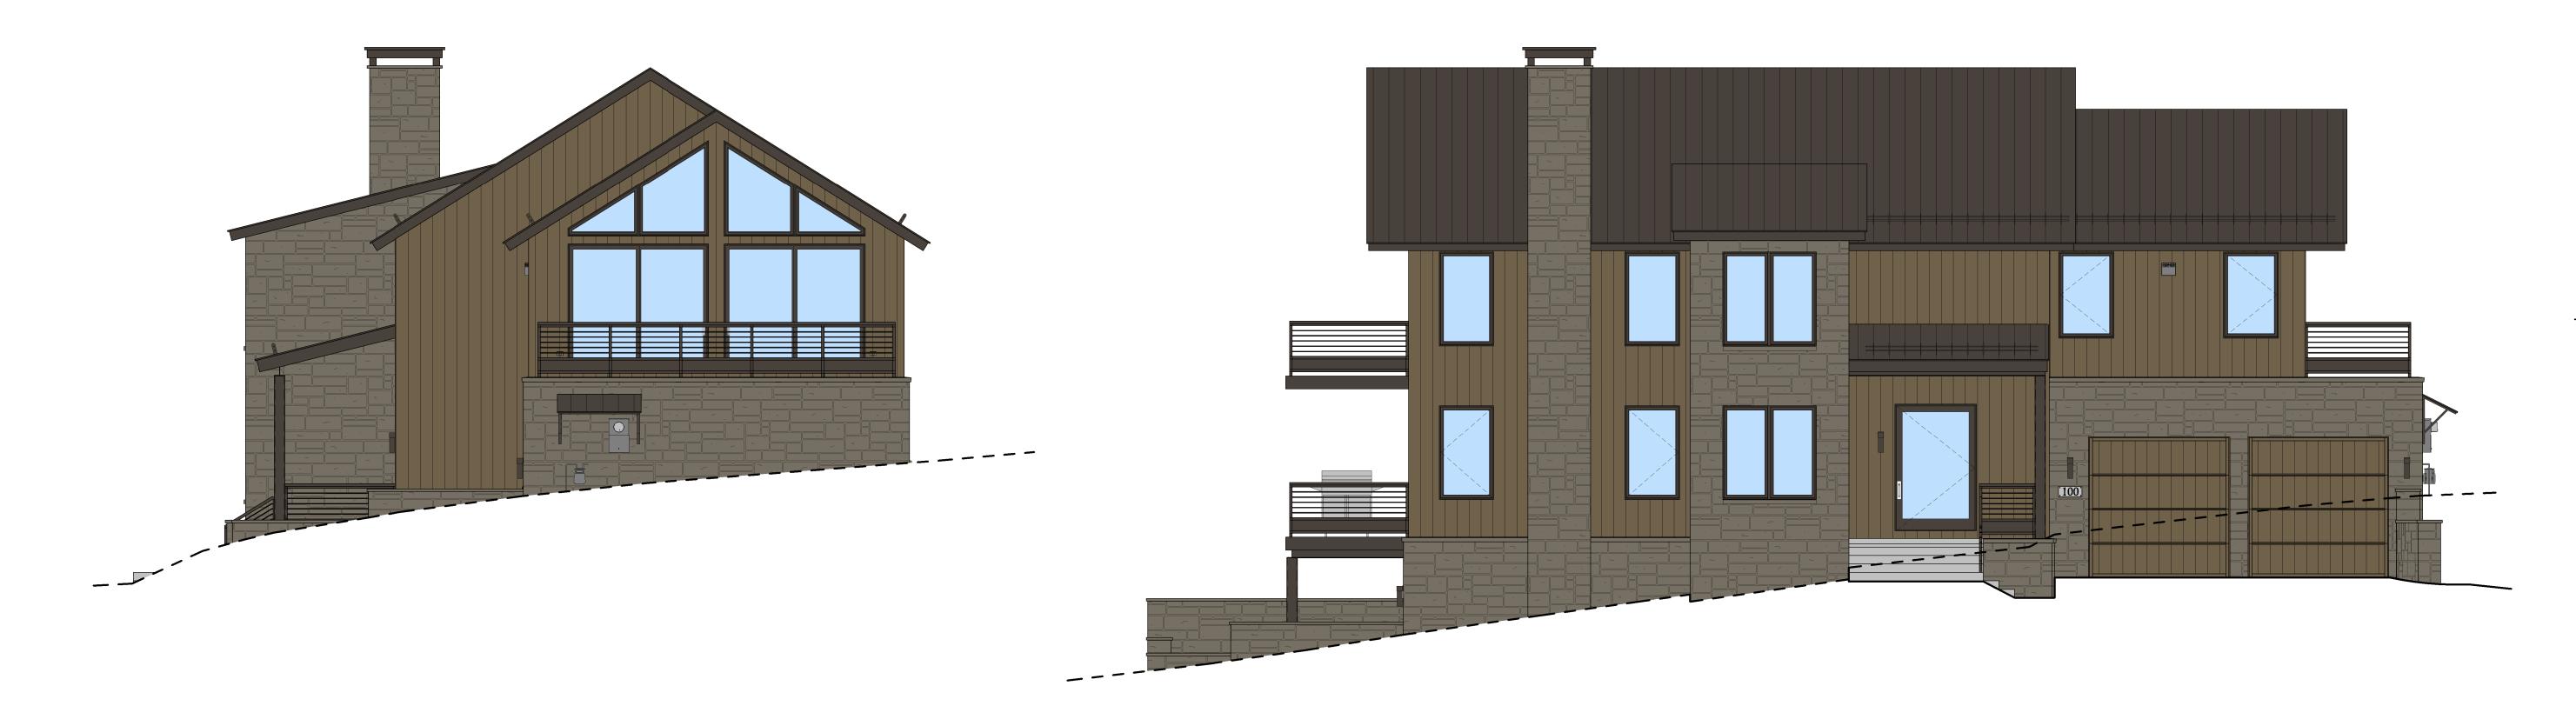






**NORTH ELEVATION** 3/16" = 1'-0"







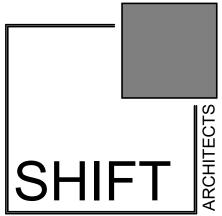

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# KNOLL ESTATES UNIT


# PRESENTATION ELEVATIONS

100 EAGLE DRIVE, MOUNTAIN VILLAGE, CO UNIT 1 THE KNOLL ESTATES LOT 1 TELLURI REC 10 6 95 BK 1 PG 1918

SHEET NUMBER



NOT FOR CONSTRUCTION

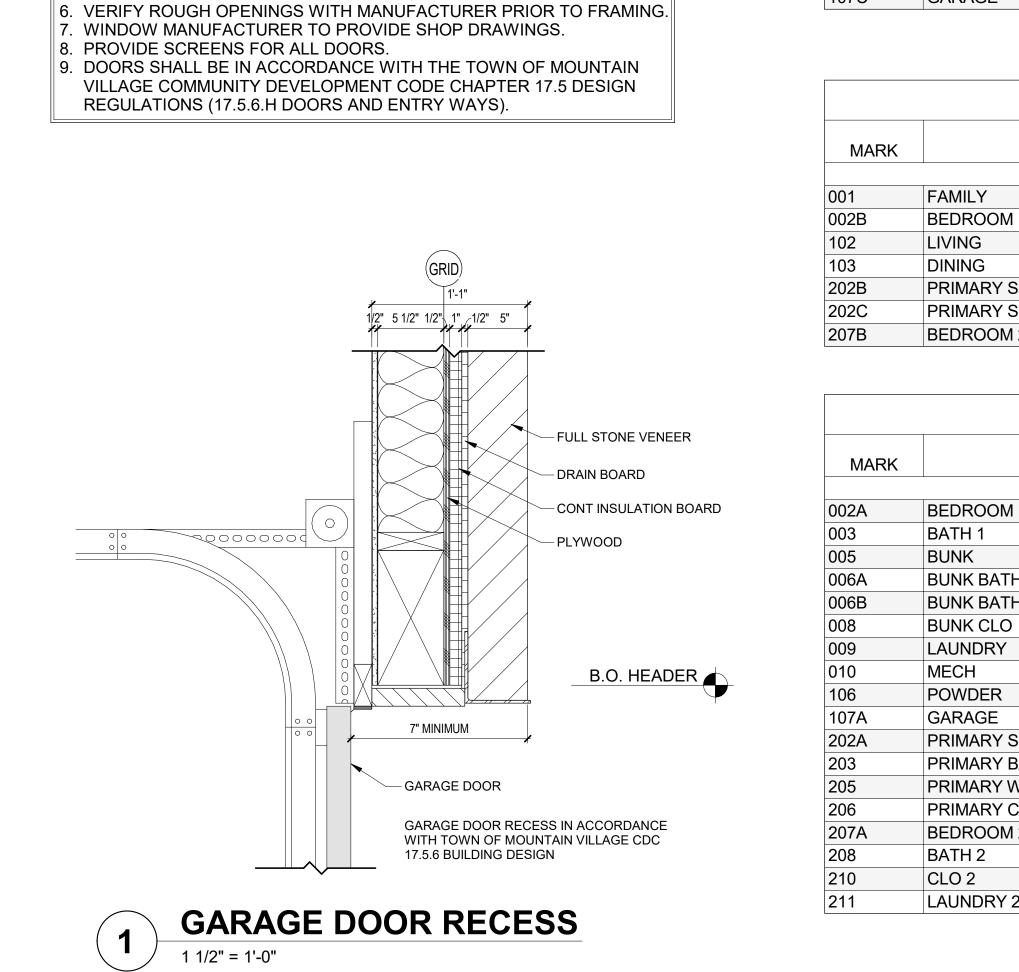

**DOOR NOTES:** 


. DOOR INSTALLATION: INSTALL DOORS IN ACCORDANCE WITH

5. DOOR MANUFACTURER: KAWAL ALUMN; RAL9005 MATT FINISH.

MANUFACTURER'S INSTALLATION INSTRUCTIONS. 2. PROVIDE TEMPERED GLASS AS REQUIRED BY CODE.

4. DOOR HARDWARE TO BE SELECTED BY DEVELOPER.

3. SEE ELEVATIONS FOR DOOR MUNTIN PATTERN.

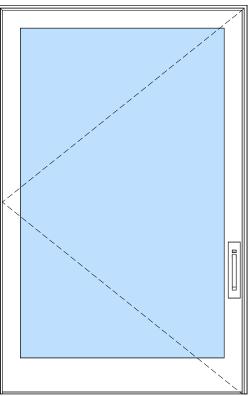

MARK

101A


107B


107C

ENTRY

GARAGE

GARAGE

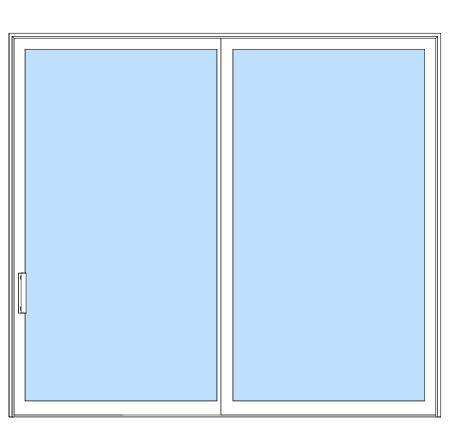

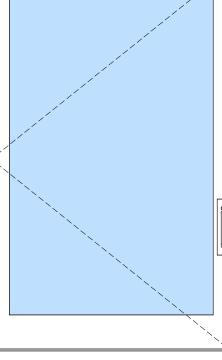

TYPE A CUSTOM PIVOT


DOOR SCHEDULE EXTERIOR PANEL									
PANELPANELPANELROOM NAMETYPE MARKWIDTHHEIGHTTYPEWIDTHHEIGHTTYPEMANUFACTURERCOMMENTS									
				1					
	A	5'-0"	8'-0"	CUSTOM PIVOT					
	С	9'-0"	9'-0"	OVERHEAD DOOR	VE	RTICAL WOOD; MATCH SIDING			
	С	9'-0"	9'-0"	OVERHEAD DOOR	VE	RTICAL WOOD; MATCH SIDING			

# **DOOR SCHEDULE EXTERIOR FRAME**

TYPE MARK	UNIT	UNIT			
	WIDTH	HEIGHT	TYPE	MANUFACTURER	COMMENTS
P	11' 6"	<u>8' 0"</u>	SUDING DATIO (2 DANEL)		
B	9'-0"		SLIDING PATIO (2 PANEL)	KAWAL ALUMN; RAL9005 MATT FINISH	
В	12'-6"	9'-0"	SLIDING PATIO (2 PANEL)	KAWAL ALUMN; RAL9005 MATT FINISH	
В	12'-6"	9'-0"	SLIDING PATIO (2 PANEL)	KAWAL ALUMN; RAL9005 MATT FINISH	
В	9'-0"	8'-0"	SLIDING PATIO (2 PANEL)	KAWAL ALUMN; RAL9005 MATT FINISH	
В	9'-0"	8'-0"	SLIDING PATIO (2 PANEL)	KAWAL ALUMN; RAL9005 MATT FINISH	
В	12'-6"	8'-0"	SLIDING PATIO (2 PANEL)	KAWAL ALUMN; RAL9005 MATT FINISH	
	B B B B B	B         9'-0"           B         12'-6"           B         12'-6"           B         9'-0"           B         9'-0"           B         9'-0"	B         9'-0"         8'-0"           B         12'-6"         9'-0"           B         12'-6"         9'-0"           B         9'-0"         8'-0"           B         9'-0"         8'-0"           B         9'-0"         8'-0"	B         9'-0"         8'-0"         SLIDING PATIO (2 PANEL)           B         12'-6"         9'-0"         SLIDING PATIO (2 PANEL)           B         12'-6"         9'-0"         SLIDING PATIO (2 PANEL)           B         9'-0"         SLIDING PATIO (2 PANEL)           B         9'-0"         SLIDING PATIO (2 PANEL)           B         9'-0"         8'-0"           B         9'-0"         8'-0"           SLIDING PATIO (2 PANEL)         8'-0"	B9'-0"8'-0"SLIDING PATIO (2 PANEL)KAWAL ALUMN; RAL9005 MATT FINISHB12'-6"9'-0"SLIDING PATIO (2 PANEL)KAWAL ALUMN; RAL9005 MATT FINISHB12'-6"9'-0"SLIDING PATIO (2 PANEL)KAWAL ALUMN; RAL9005 MATT FINISHB9'-0"8'-0"SLIDING PATIO (2 PANEL)KAWAL ALUMN; RAL9005 MATT FINISHB9'-0"8'-0"SLIDING PATIO (2 PANEL)KAWAL ALUMN; RAL9005 MATT FINISHB9'-0"8'-0"SLIDING PATIO (2 PANEL)KAWAL ALUMN; RAL9005 MATT FINISH


# DOOD COLLEDINE INTEDIOD DANEL


		PANEL	PANEL			
ROOM NAME	TYPE MARK	WIDTH	HEIGHT	TYPE	MANUFACTURER	COMMENTS
M 1	D	2'-8"	7'-6"	SWING		
	E	2'-4"	7'-6"	POCKET		
	D	2'-8"	7'-6"	SWING		
ТН	D	2'-6"	7'-6"	SWING		
ТН	D	2'-6"	7'-6"	SWING		
0	D	2'-4"	7'-6"	SWING		
Y	D	3'-0"	7'-6"	SWING		
	D	3'-0"	7'-6"	SWING		20 MIN FIRE RATED
2	E	2'-4"	7'-6"	POCKET		
	D	3'-0"	7'-6"	SWING		20 MIN FIRE RATED
ŚUITE	D	2'-8"	7'-6"	SWING		
′ BATH	D	2'-8"	7'-6"	SWING		
′ WC	E	2'-4"	7'-6"	POCKET		
′ CLO	E	2'-4"	7'-6"	POCKET		
M 2	D	2'-8"	7'-6"	SWING		
	E	2'-6"	7'-6"	POCKET		
	E	2'-4"	7'-6"	POCKET		
Y 2	F	3'-0"	7'-6"	SWING (LOUVERED)		

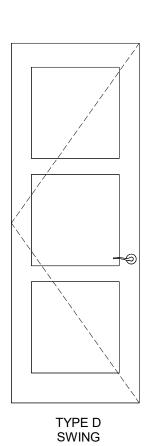


TYPE B SLIDING (2 PANEL)

TYPE C VERTICAL WOOD; MATCH SIDING

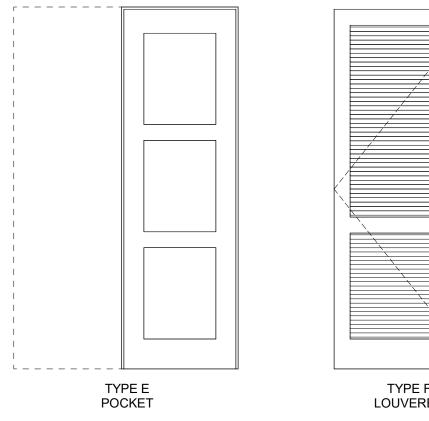

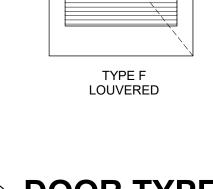



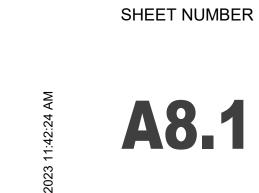



UNIT

ESTATES

KNOLL

SHIF

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Telluride, Colorado 81435

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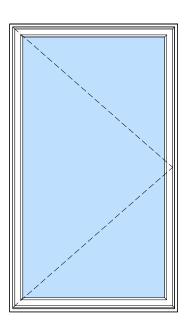
REVISIONS





WINDOW NOTES:							WINDOW SCH	EDULE
	ROOM NUMBER	ROOM NAME	MARK	UNIT WIDTH	UNIT HEIGHT	TYPE MARK	TYPE	MANUFACTURE
1. WINDOW INSTALLATION: INSTALL WINDOWS IN ACCORDANCE WITH MANUFACTURER'S INSTALLATION INSTRUCTIONS.								
2. PROVIDE TEMPERED GLASS AS REQUIRED BY CODE.	005	BUNK	D	6'-0"	5'-0"	2	CASEMENT (2 WIDE)	YAWAL ALUMN; RAL9005 MATT F
<ol> <li>SEE ELEVATIONS FOR WINDOW MUNTIN PATTERN.</li> <li>WINDOW MANUFACTURER: KAWAL ALUMN; RAL9005 MATT FINISH.</li> </ol>	400		•					
5. WINDOW HARDWARE TO BE SELECTED BY DEVELOPER.			A	3'-6"	6'-0"	1		YAWAL ALUMN; RAL9005 MATT F
6. VERIFY ROUGH OPENINGS WITH MANUFACTURER PRIOR TO FRAMING.			A	3'-6"	6'-0"	1		YAWAL ALUMN; RAL9005 MATT F
7. WINDOW MANUFACTURER TO VERIFY WINDOW SWINGS.		LIVING	E	3'-6"	6'-0"	3	PICTURE (1 WIDE)	YAWAL ALUMN; RAL9005 MATT F
8. WINDOW MANUFACTURER TO PROVIDE SHOP DRAWINGS.		LIVING	E	3'-6"	6'-0"	3	PICTURE (1 WIDE)	YAWAL ALUMN; RAL9005 MATT F
<ol> <li>PROVIDE SCREENS FOR ALL OPERABLE WINDOWS.</li> <li>WINDOWS SHALL BE IN ACCORDANCE WITH THE TOWN OF MOUNTAIN</li> </ol>		LIVING	F	12'-6"	8'-0"	4	PICTURE (2 WIDE)	YAWAL ALUMN; RAL9005 MATT F
VILLAGE COMMUNITY DEVELOPMENT CODE CHAPTER 17.5 DESIGN		LIVING	K	6'-3"	6"	7	PICTURE (RAKEHEAD)	YAWAL ALUMN; RAL9005 MATT F
REGULATIONS (17.5.6.G GLAZING).	102	LIVING	L	6'-3"	4'-4 7/8"	7	PICTURE (RAKEHEAD)	YAWAL ALUMN; RAL9005 MATT F
	103	DINING	J	12'-0"	5'-0"	6	AWNING (2 WIDE)	YAWAL ALUMN; RAL9005 MATT F
	104	KITCHEN	С	7'-0"	3'-6"	2	CASEMENT (2 WIDE)	YAWAL ALUMN; RAL9005 MATT F
GRID	105	MUDROOM	С	7'-0"	3'-6"	2	CASEMENT (2 WIDE)	YAWAL ALUMN; RAL9005 MATT F
5 1/2" <sup>1/2</sup> " 1" ( <sup>1/2"</sup> 5"	108	STAIRS	G	6'-0"	6'-0"	4	PICTURE (2 WIDE)	YAWAL ALUMN; RAL9005 MATT F
		STAIRS	G	6'-0"	6'-0"	4	PICTURE (2 WIDE)	YAWAL ALUMN; RAL9005 MATT F
	202	PRIMARY SUITE	В	3'-6"	5'-6"	1	CASEMENT (1 WIDE)	YAWAL ALUMN; RAL9005 MATT F
		PRIMARY SUITE	B	3'-6"	5'-6"	1	CASEMENT (1 WIDE)	YAWAL ALUMN; RAL9005 MATT F
		PRIMARY SUITE	M	4'-6"	6"	8	PICTURE (RAKEHEAD)	YAWAL ALUMN; RAL9005 MATT F
		PRIMARY SUITE	M	4'-6"	6"			
				4'-6"	-	8	PICTURE (RAKEHEAD)	YAWAL ALUMN; RAL9005 MATT F
		PRIMARY SUITE PRIMARY SUITE	N N	4'-6"	3'-3 3/4" 3'-3 3/4"	8	PICTURE (RAKEHEAD) PICTURE (RAKEHEAD)	YAWAL ALUMN; RAL9005 MATT F YAWAL ALUMN; RAL9005 MATT F
	203	PRIMARY BATH	H	5'-0"	3'-6"	5	AWNING (1 WIDE)	YAWAL ALUMN; RAL9005 MATT F
5" MIN REQUIRED	207	BEDROOM 2	A	3'-6"	6'-0"	1	CASEMENT (1 WIDE)	YAWAL ALUMN; RAL9005 MATT F
WOOD WINDOW	207	BEDROOM 2	K	6'-3"	6"	7	PICTURE (RAKEHEAD)	YAWAL ALUMN; RAL9005 MATT F
STONE SILL	207	BEDROOM 2	L	6'-3"	4'-4 7/8"	7	PICTURE (RAKEHEAD)	YAWAL ALUMN; RAL9005 MATT F
	208	BATH 2	Ι	2'-6"	3'-6"	5	AWNING (1 WIDE)	YAWAL ALUMN; RAL9005 MATT F
	209	SHW 2		2'-6"	3'-6"	5	AWNING (1 WIDE)	YAWAL ALUMN; RAL9005 MATT F





# WINDOW HEAD/SILL STONE VENEER 1 1/2" = 1'-0"




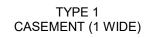

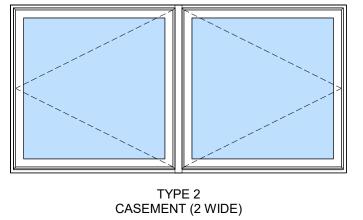


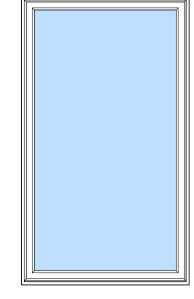

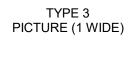


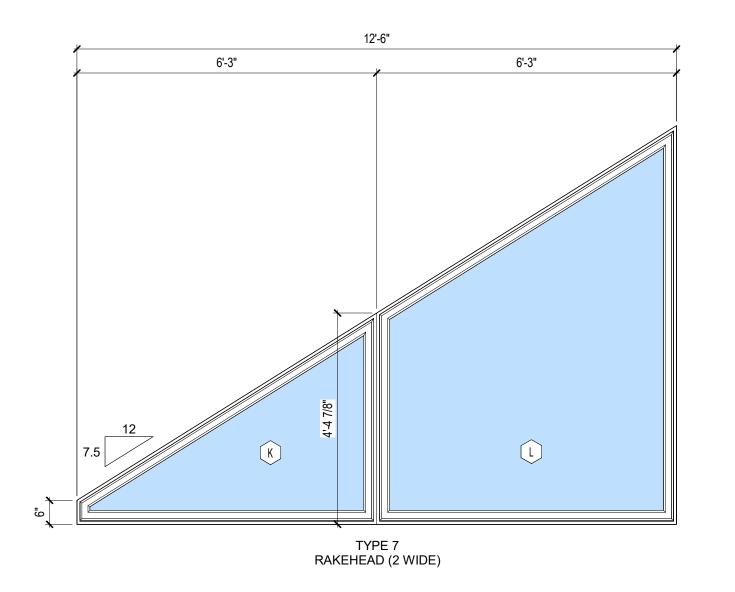



# 

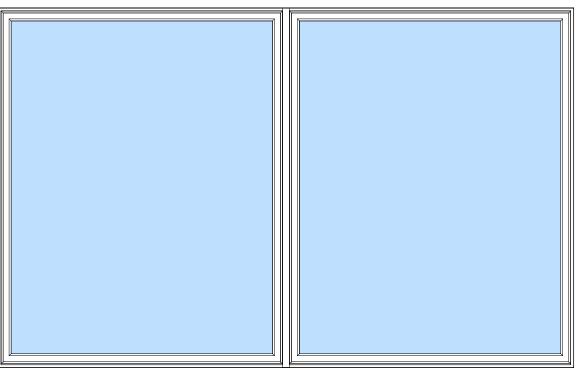


TYPE 4 PICTURE (2 WIDE)

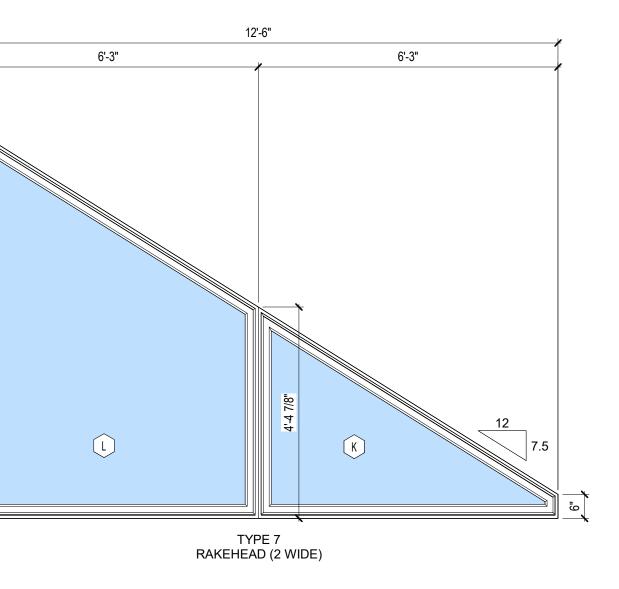

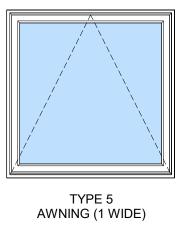


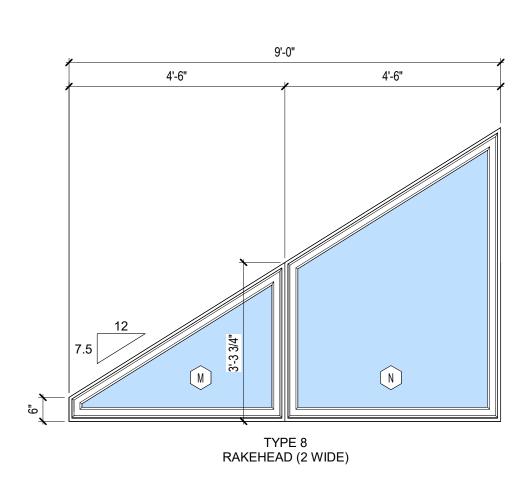

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TYPE 6 AWNING (2 WIDE)

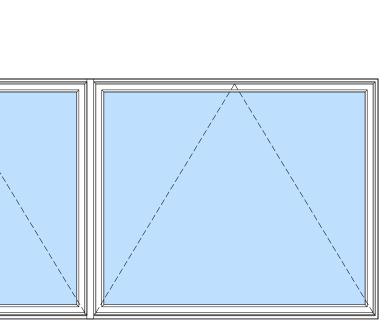



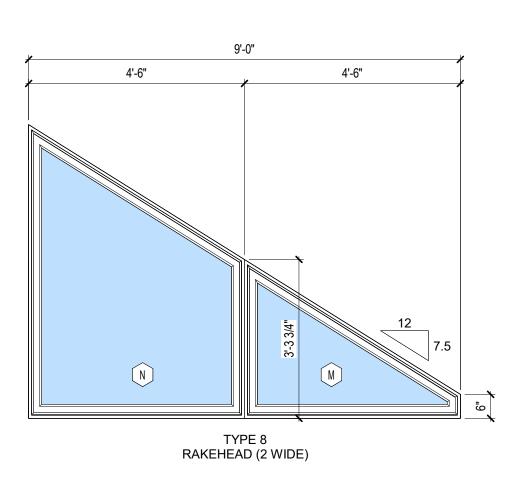

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REVISIONS

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SHEET NUMBER

**A8.2** 


# EXTERIOR FIXTURE X1:

EXTERIOR WALL SCONCE (5 TOTAL)



### MEDIUM WALL MOUNT LANTERN

COASTAL ELEMENTS COLLECT	ON
MANUFACTURER	HINKLEY
ITEM	TAPER 2144TK
FINISH	TEXTURED BLACK
MATERIAL	COMPOSITE
GLASS	ETCHED LENS
WIDTH	7"
HEIGHT	15"
WEIGHT	3.5 LB
BACK PLATE	7"W X 15"H
EXTENSION	3.5"
TOP OF OUTLET	7.5"
LIGHT SOURCE	INTEGRATED LED
LED NAME	L214X-6
VOLTAGE	120V
COLOR TEMP	3000
LUMENS	800
CRI	90
INCANDESCENT EQUIVALENCY	1X60W
DIMMABLE	YES - CL TYPE DIMMER (SSL7A)
WET LOCATION	SUITABLE AS DEFINED BY NEC AND CEC
DARY SKY	YES

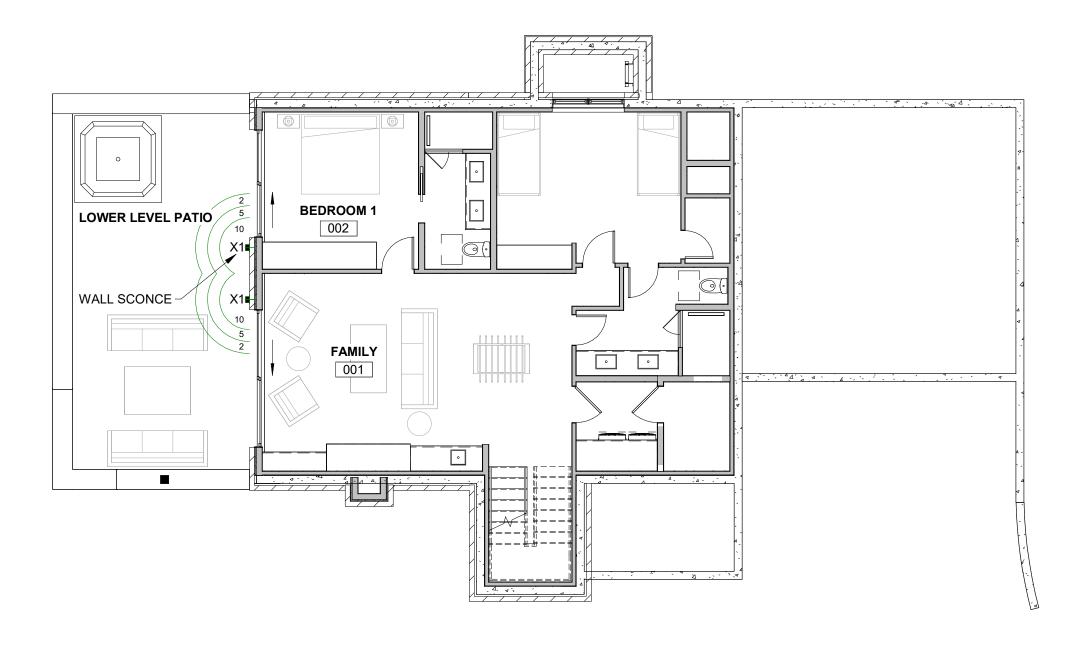



# EXTERIOR FIXTURE X2:

EXTERIOR WALL / STEP LIGHT (7 TOTAL)



# LANDSCAPE LIGHTING LED HORIZONTAL STEP LIGHT

BLACK ON ALUMINUM	1
MANUFACTURER	WAC LIGHTING
ITEM	4011-30-ВК
MATERIAL	CORROSION RESISTANT ALUMINUM ALLOY
GLASS	FROSTED GLASS DIFFUSER
WIDTH	5"
HEIGHT	3"
DEPTH	1 1/2"
LUMENS	68
BEAM SPREAD	50"
CRI	90
COLOR TEMP	3000K
PRIMARY BULB	1 X 2.0 WATTS 2.0 LED
RATED LIFE	60,000 HOURS
DIMMABLE	10% - 100% DIMMING
	WITH ELECTRONIC LOW VOLTAGE (ELV) DIMMER
VOLTAGE	12V
LIGHT SOURCE	2 WATT (68 LUMENS) 12 VOLT INTEGRATED LED
CERTIFICATION	UL1838, IP66 WET LOCATIONS

# **LIGHTING NOTES:**


- 1. FIELD VERIFY ALL LIGHTING LOCATIONS.
- 2. TYPICAL LIGHTING LOCATION AT STAIRS: (2 EA) PER RUN (1) EA PER LANDING
- 3. CONTRACTOR SHALL TAKE CARE IN PLANNING ROUGH FRAMING LAYOUT AS IT RELATES TO THE NEED TO CENTER FIXTURES IN HALLWAYS, RECESSES AND OTHER AREAS WHERE RELATIONSHIPS DON'T OFFER ANY LATITUDE OR FIELD ADJUSTMENTS.
- 4. ALL RECESSED FIXTURES AT INSULATED CEILINGS TO BE IC RATED AND CERTIFIED AIR TIGHT CONSTRUCTION. ALL EXTERIOR FIXTURES, SHOWER FIXTURES AND FIXTURES OVER TUBS TO BE MARKED "SUITABLE FOR DAMP LOCATIONS".
- 5. LIGHTING SHALL BE IN ACCORDANCE WITH TOWN OF MOUNTAIN VILLAGE COMMUNITY DEVELOPMENT CODE 17.5.12 LIGHTING REGULATIONS
- 6. PROVIDE FULL CUT OFF FIXTURES WITH LED 10W 2500K-2700K BULBS PER CDC REQUIREMENTS.
- 7. MOUNT FIXTURES AT 7'-0" AFF MAX PER CDC REQUIREMENTS.
- 8. EXTERIOR LIGHTING ON SECOND AND UPPER FLOORS SHALL REQUIRE EITHER A TIMER OR SENSOR TO REDUCE USAGE AND ENERGY LOSS DURING TIMES OF INACTIVITY.
- 9. PROVIDE SCREWLESS CAPS IN ALL SWITCHES AND OUTLETS.
- 10. PROVIDE OUTLET W/ USB AT EA BED (NIGHT STAND). VERIFY LOCATION IN FIELD.
- 11. LIGHTING LAYOUT GRID DIMENSIONS ARE TO FACE OF FRAME WALLS TYP.

# LIGHTING LEGEND <sup>⊘</sup>C1 REC

 $\oslash$ <sub>C2</sub> REC  $\oslash$  C3 REC  $^{\oslash}$ C4 REC ⊘<sub>F</sub> REC CEIL 2' LII ⊢\_\_\_\_ C EXH FN EXH 2'X2' **F**1

 $\langle \rangle$ 


F2 - $\oplus_{\mathsf{CH}}$ 

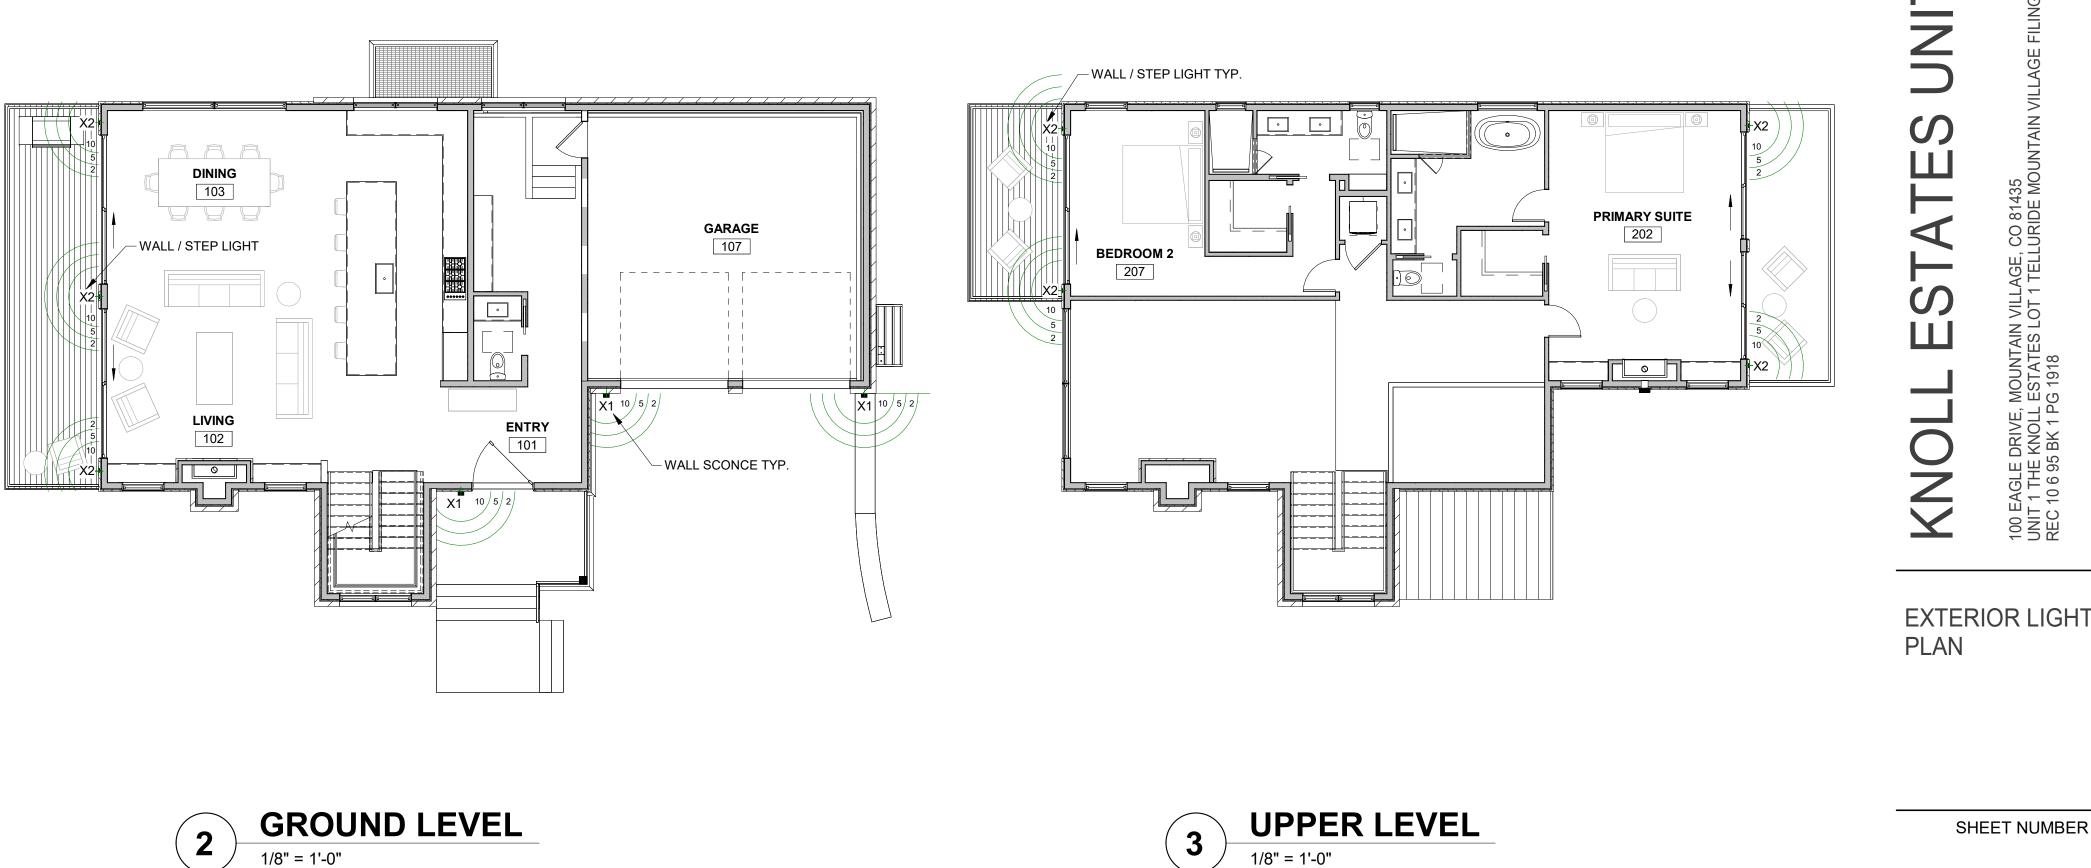



	RECESSED CAN	MS
	RECESSED CAN; DIRECTIONAL	° <sub>P</sub>
	RECESSED CAN; WET LOCATIONS —	uc
	RECESSED CAN; LOW PROFILE —	R
	RECESSED CAN; EXTERIOR	₽TL
	CEILING FAN	⊕ <sup>FL</sup> ⊕USB
	2' LINEAR CLOSET FIXTURE	$\Box^{S}$
	EXHAUST FAN	ST
	EXHAUST FAN WITH LIGHT	ς γ <b>2</b> γ <b>3</b>
	2'X2' FLUSH MOUNT LED LIGHT	TV
2	2'X4' FLUSH MOUNT LED LIGHT	—WG
	SURFACE MOUNT FIXTURE	<b>-</b> <sup>X2</sup>
	CHANDELIER	

MOTION SENSOR
PENDANT
UNDER CABINET LED STRIP
RECESSED LED LIGHT
TABLE LAMP RECEPTACLE
FLOOR LAMP RECEPTACLE
OUTLET WITH USB
WALL MOUNTED SCONCE
STEP LIGHT
TWO WAY SWITCH
THREE WAY SWITCH
TV OUTLET
WALL GRAZING
EXTERIOR SCONCE
EXTERIOR WALL / STEP
FIXTURE LAYOUT GRID

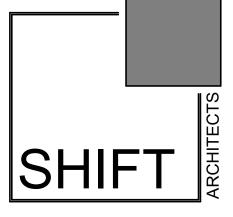


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PROJECT ISSUE DATE: 12.05.23 DRB PRELIMINARY SUBMITTAL REVISIONS NO. DATE DESC.

MONO POINT FIXTURE

DOUBLE HEADED MONO POINT

EXTERIOR LIGHTING

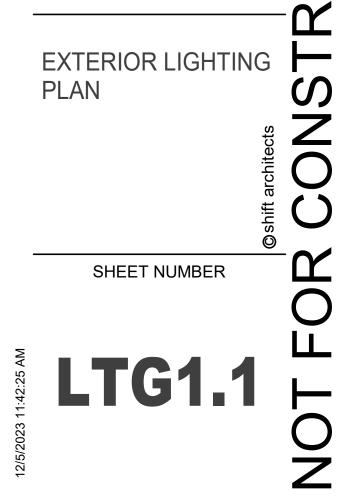

**JCTION** 

