

Date: January 22, 2024

To: Mountain Village Planning Staff **From:** Scott Beans, PE, NCARB **Re:** Design Review Application

Property: Lot 166AR2-1, Stonegate Drive

Dear Mountain Village Town Council and Design Review Board:

The owner of Lot 166AR2-1, Stonegate Drive intends to construct a single-family residence on the site, which is currently vacant. The accompanying drawings outline the proposed residence, including building height, site stabilization, construction impacts, exterior materials & lighting, and landscaping + revegetation. This narrative summarizes select information included in the drawings and addresses relevant criteria for this project as well as any requested variances per Title 17 of the Community Development Code.

Project Description:

The site is located in the Single-Family Zone District, near the end of Stonegate Drive, with the proposed driveway accessed at the outside of a large U-turn. The lower side of the road near the driveway entrance is supported by a retaining wall which should not be impacted by this project. Just past the driveway, Stonegate Drive has existing earth retention above the road, some of which may be impacted by this project. Per conversations with Finn Kjome, the project team will be allowed to impact and re-construct (as necessary) portions of the existing retention system. Prior to demolition or construction, engineered drawings will be submitted to Public Works for review.

The site slopes downhill from North to South, at a slope of 60%+. The site will be retained by two tiers of earth retention (likely soil nail walls), with the lower level constructed on one tier, and the garage + driveway level constructed on the upper tier. No portions of roof, wall, or foundation element will extend into the general easement or beyond any property lines. Additionally, the locations of retention walls and foundation walls are such that no impacts from construction, nor any soil nails, will extend beyond property lines. This project is proposing general disturbance, followed by revegetation, within portions of the general easement at the NE and NW lot lines.

The rooflines of the home step with the contours of the site, which keeps all portions of rooflines under the required 35' offset. No height variance is being requested.

CDC Provisions:

| CDC Provision | Requirement | Proposed |
|---------------------------------|--------------------|----------------------------|
| Maximum Building Height | 35'-0" | 35′-0″ |
| Maximum Average Building Height | 30'-0" | 27′-11″ |
| Maximum Lot Coverage | 4,423 sq ft (40%) | 4,204 sq ft (38%) |
| General Easement | no encroachment | construction impacts only, |
| General Easement | no encroachment | followed by revegetation |
| Primary Roof Pitch | | 3.5:12 |
| Secondary Roof Pitch | | Flat (0:12) |
| Exterior Materials – Stone | 35% minimum | 43.9% |
| Exterior Materials – Glazing | 40% maximum | 15.8% |
| Parking | 2 enclosed spaces; | 2 enclosed spaces; |
| raikilig | 2 surface spaces | 4+ surface spaces |

Criteria for Decisions & Variations:

17.3.11-12: Building Height

All rooflines and upper-level decks remain under the allowable 35' maximum building height. The stepping rooflines and decks of the home are designed to follow existing site contours. Final grade will match existing grade above soil nail walls and below the home, meaning the 35' parallel plane offset shown in drawings is relative to both natural + finished grade (in essence, the same grade).

Sheet A002 provides 5 section cuts, each at a critical height location on the project; it is difficult to portray the 3-D parallel plan offset with a single image, as no portion of the roofline extends *above* the 35' offset.

17.3.14: General Easement Setbacks

The lot contains a 16' general easement on the NE and NW lot lines, and no easement on the other 3 lot lines. Construction disturbance is proposed to occur in 5' of the 16' general easement, with planned revegetation in these areas (primarily native grasses, with some native shrubs/trees as makes sense). Construction disturbance will occur up to the SE lot line, and near, but not touching, the remaining 2 lot lines. Refer to sheet CM001 for additional information.

No portion of the home (foundation elements, walls, roofs) is proposed within the general easement. Portions of the driveway and accompanying retaining walls are within the NW general easement (there is currently a dirt parking area at this location). No portion of soil nails will extend beyond any property lines/into adjacent properties. Construction staging and parking will occur within the driveway, with additional offsite parking as noted on sheet CM001.

17.4.11: Design Review Process

Variance requests include construction impacts within the general easement, construction on steep slopes, and a review of select exterior materials. Per 17.4.11.D (Criteria for Decision), the project meets the design and zoning regulations, with proposed use as a single-family residence, building massing and style, and materiality. The project is in compliance with height standards, lot coverage, road and driveway standards, and, as a whole, follows regulations of the CDC.

17.5.6: Building Design

The building mass and style are appropriate for an alpine mountain environment. The home has a large amount of stone on the exterior, which visually help to ground it. The downhill sides of the home contain a large amount of glass to capture views, while many uphill portions of the home adjacent to large soil retention walls and are more enclosed. Additional exterior materials include metal panels (near the front entry, between windows, and along the downhill façade of the home), and metal panels which mimic wood along the upper level of the home and on the uphill side.

An approximately 4' space will remain between the home and soil retention walls. Within this space, which is hidden from view, will be a gravel base and board-formed concrete walls. Because these spaces are prone to filling with snow, concrete will extend up one level, with wood framing and exterior siding on the upper level. Board-formed concrete is proposed as in this area, as this is a balance of cost (no need to place a veneer over these portions of wall), while providing a visual element of higher quality than typical concrete foundation walls. Visible portions of retention walls (e.g. above the driveway) will be faced with a stone veneer to match the home.

17.5.9: Landscaping Regulations

This project site is small, and thus will contain very little landscaping. In areas just above and below the home/retention walls, native revegetation will occur in the form of native grasses, with some native shrubs and/or trees at select locations (plantings per Table 5-4 of the CDC). Other landscaped areas include a small region adjacent to the front entry of the home, and a small retaining wall containing plantings on the uphill side of the driveway, to help visually break the mass of the soil retention wall.

17.5.12: Lighting Regulations


Please refer to sheet A400 for exterior lighting plans. Three forms of exterior lighting are proposed on this project, all of which meet DarkSky regulations: at covered decks and the front entry canopy, LED can lights are located in soffits; adjacent to the front door, garage door, and upper level deck exterior doors are downcast wall sconces; and located along driveway retaining walls are small, downcast lights.

We appreciate your time and effort reviewing this project, and we look forward to working with Mountain Village. Feel free to call or email me with any questions or comments.

Sincerely,

Scott Beans, PE, NCARB

scott@sproutaec.com 970.759.3745

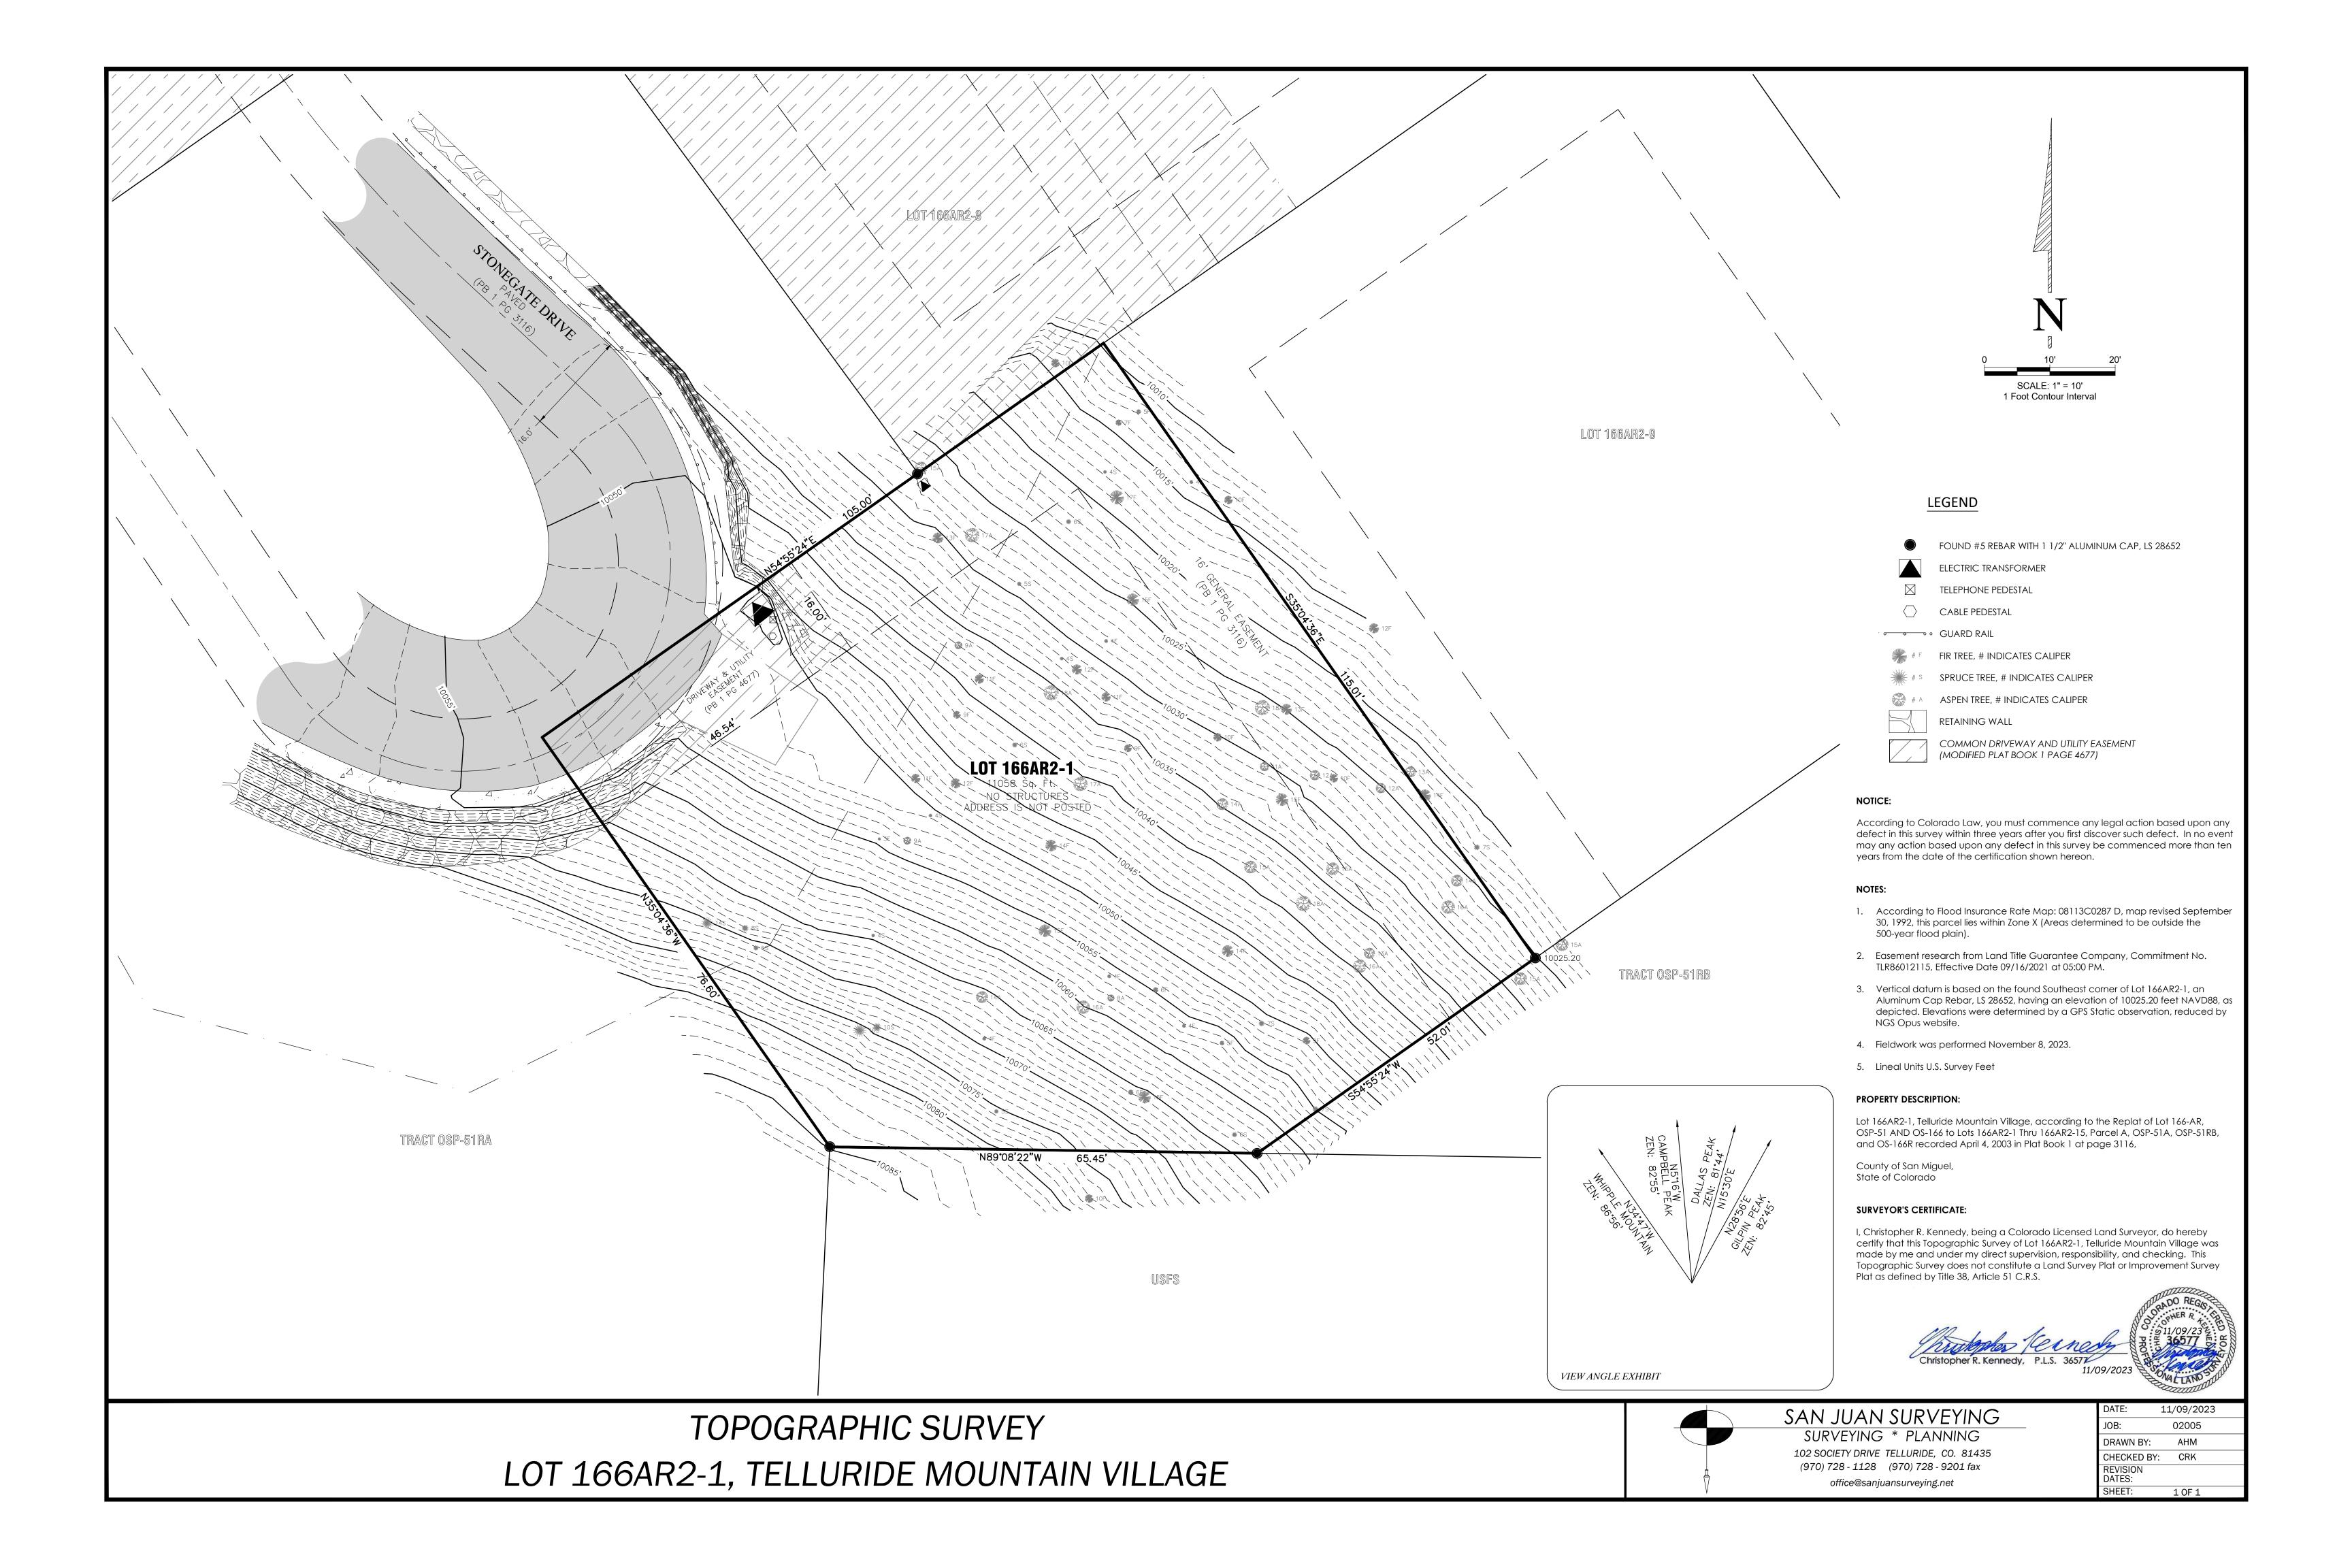

GENERAL CIVIL ENGINEERING NOTES:

1. THE EXISTING UTILITY LINES SHOWN ON THE PLANS ARE APPROXIMATE. AT LEAST TWO (2) FULL WORKING DAYS PRIOR TO TO COMMENCING CONSTRUCTION, THE CONTRACTOR SHALL CONTACT THE UTILITY NOTIFICATION CENTER OF COLORADO @ 1-800-922-1987 OR 811 TO GET ALL UTILITIES LOCATED. IF ANY OF THESE UNDERGROUND UTILITIES ARE IN CONFLICT WITH THE CONSTRUCTION PLANS, THE CONTRACTOR SHALL NOTIFY THE ENGINEER AND WORK WITH THE ENGINEER TO FIND A SOLUTION BEFORE THE START OF CONSTRUCTION.

INSTALLATION AND SEPARATION REQUIREMENTS SHALL BE COORDINATED WITH THE INDIVIDUAL UTILITY PROVIDERS.

THE UTILITY PROVIDERS ARE: SEWER, WATER, CABLE TV AND FIBEROPTIC: TOWN OF MOUNTAIN VILLAGE NATURAL GAS: BLACK HILLS ENERGY POWER: SAN MIGUEL POWER TELEPHONE: CENTURY LINK

2. PRIOR TO BEGINNING ANY CONSTRUCTION ACTIVITIES, ALL NECESSARY PERMITS SHALL BE OBTAINED BY THE OWNER OR CONTRACTOR.

3. IT IS THE CONTRACTOR'S RESPONSIBILITY TO INSURE THAT EXCAVATED SLOPES ARE SAFE AND COMPLY WITH OSHA REQUIRIEMENTS. REFER TO THE SITE—SPECIFIC REPORT FOR THIS PROJECT FOR ADDITIONAL INFORMATION...

4. ALL TRENCHES SHALL BE ADEQUATELY SUPPORTED OR LAID BACK PER OSHA REGULATIONS.

5. ALL MATERIALS AND CONSTRUCTION SHALL BE IN CONFORMANCE WITH THE TOWN OF MOUNTAIN VILLAGE DESIGN STANDARDS LATEST EDITION. ALL CONSTRUCTION WITHIN EXISTING STREET OR ALLEY RIGHT—OF—WAY SHALL BE SUBJECT TO TOWN OF MOUNTAIN VILLAGE INSPECTION.

6. THE CONTRACTOR SHALL HAVE ONE COPY OF THE STAMPED PLANS ON THE JOB SITE AT ALL TIMES.

7. THE CONTRACTOR SHALL NOTIFY THE TOWN 48 HOURS PRIOR TO THE START OF CONSTRUCTION.

8. THE CONTRACTOR IS RESPONSIBLE FOR IMPLEMENTING AND MAINTAINING EROSION AND SEDIMENT CONTROL MEASURES AT ALL TIMES DURING CONSTRUCTION. THE ADJOINING ROADWAYS SHALL BE FREE OF DEBRIS AT THE END OF CONSTRUCTION ACTIVITIES EACH DAY.

9. THE CONTRACTOR SHALL PROVIDE, ERECT AND MAINTAIN PROPER TRAFFIC CONTROL DEVICES UNTIL THE SITE IS OPEN TO TRAFFIC. ANY TRAFFIC CLOSURES MUST BE COORDINATED WITH THE TOWN OF MOUNTAIN VILLAGE.

10. ALL DAMAGE TO PUBLIC STREETS AND ROADS, INCLUDING HAUL ROUTES, TRAILS, OR STREET IMPROVEMENTS, OR TO PRIVATE PROPERTY, SHALL BE REPAIRED AT THE SOLE EXPENSE OF THE CONTRACTOR TO THE ORIGINAL CONDITIONS.

11. WHEN AN EXISTING ASPHALT STREET IS CUT, THE STREET MUST BE RESTORED TO A CONDITION EQUAL TO OR BETTER THAN ITS ORIGINAL CONDITION. THE FINISHED PATCH SHALL BLEND SMOOTHLY INTO THE EXISTING SURFACE. ALL LARGE PATCHES SHALL BE PAVED WITH AN ASPHALT LAY—DOWN MACHINE.

12. IF DEWATERING IS REQUIRED, THE CONTRACTOR SHALL NOTIFY THE ENGINEER. ANY DISCHARGE REQUIREMENTS SHALL BE COORDINATED WITH THE TOWN OF MOUNTAIN VILLAGE.

13. CONTRACTOR SHALL NOTIFY ALL RESIDENTS IN WRITING 24 HOURS PRIOR TO ANY SHUT—OFF IN SERVICE. THE NOTICES MUST HAVE CONTRACTOR'S PHONE NUMBER AND NAME OF CONTACT PERSON, AND EMERGENCY PHONE NUMBER FOR AFTER HOURS CALLS. ALL SHUT—OFF'S MUST BE APPROVED BY THE TOWN AND TOWN VALVES AND APPURTENANCES SHALL BE OPERATED BY TOWN PERSONNEL.

14. CONTRACTOR SHALL KEEP SITE CLEAN AND LITTER FREE (INCLUDING CIGARETTE BUTTS) BY PROVIDING A CONSTRUCTION DEBRIS TRASH CONTAINER AND A BEAR-PROOF POLY-CART TRASH CONTAINER, WHICH IS TO BE LOCKED AT ALL TIMES.

15. CONTRACTOR MUST BE AWARE OF ALL TREES TO REMAIN PER THE DESIGN AND APPROVAL PROCESS AND PROTECT THEM ACCORDINGLY.

16. THE CONTRACTOR SHALL PROVIDE UNDERGROUND UTILITY AS-BUILTS TO THE TOWN.

17. ALL STRUCTURAL FILL UNDER HARDSCAPE OR ROADS MUST BE COMPACTED TO 95% MODIFIED PROCTOR (MIN.) AT PLUS OR MINUS 2% OF THE OPTIMUM MOISTURE CONTENT. NON—STRUCTURAL FILL SHALL BE PLACED AT 90% (MIN.) MODIFIED PROCTOR.

18. UNSUITABLE MATERIAL SHALL BE REMOVED AS REQUIRED BY THE SOILS ENGINEER. ALL MATERIALS SUCH AS LUMBER, LOGS, BRUSH, TOPSOIL OR ORGANIC MATERIALS OR RUBBISH SHALL BE REMOVED FROM ALL AREAS TO RECEIVE COMPACTED FILL.

19. NO MATERIAL SHALL BE COMPACTED WHEN FROZEN.

20. NATIVE TOPSOIL SHALL BE STOCKPILED TO THE EXTENT FEASIBLE ON THE SITE FOR USE ON AREAS TO BE REVEGETATED.

21. THE CONTRACTOR SHALL BE RESPONSIBLE FOR DUST ABATEMENT AND EROSION CONTROL MEASURES DEEMED NECESSARY BY THE TOWN, IF CONDITIONS WARRANT THEM.


22. ALL DISTURBED GROUND SHALL BE RE-SEEDED WITH A TOWN-APPROVED SEED MIX. REFER TO THE LANDSCAPE PLAN.

23. THE CONTRACTOR IS REQUIRED TO PROTECT ALL EXISTING SURVEY MONUMENTS AND PROPERTY CORNERS DURING GRADING AND CONSTRUCTION.

24. ALL UNDERGROUND PIPE SHALL BE PROTECTED WITH BEDDING TO PROTECT THE PIPE FROM BEING DAMAGED.

25. HOT TUBS SHALL DRAIN TO THE SANITARY SEWER (OR PUMPED TO AA CLEAN-OUT).

26. THE UTILITY PLAN DEPICTS FINAL UTILITY LOCATIONS BUT HAS BEEN COMPLETED AT A PRELIMINARY STAGE. CONTRACTOR SHALL VERIFY ALIGNMENTS WITH THE ARCHITECT PRIOR TO CONSTRUCTION.

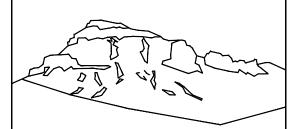

Uncompahgre Engineering, LLC

P.O. Box 3945 Telluride, CO 81435 970-729-0683

2024-01-20

SUBMISSIONS:

CHDMITTAL

TTAL


Lot 166AR2-1 Stonegate Mtn. Village, CO




CONTRACTOR TO REVIEW AND COMPARE ALL CHAPTERS AND INTERDISCIPLINARY DRAWINGS AND REPORT ANY DISCREPANCIES TO THE ARCHITECT PRIOR TO ANY FIELD WORK BEING DONE IN ACCORDANCE WITH AIA DOCUMENT A201

Notes

C1

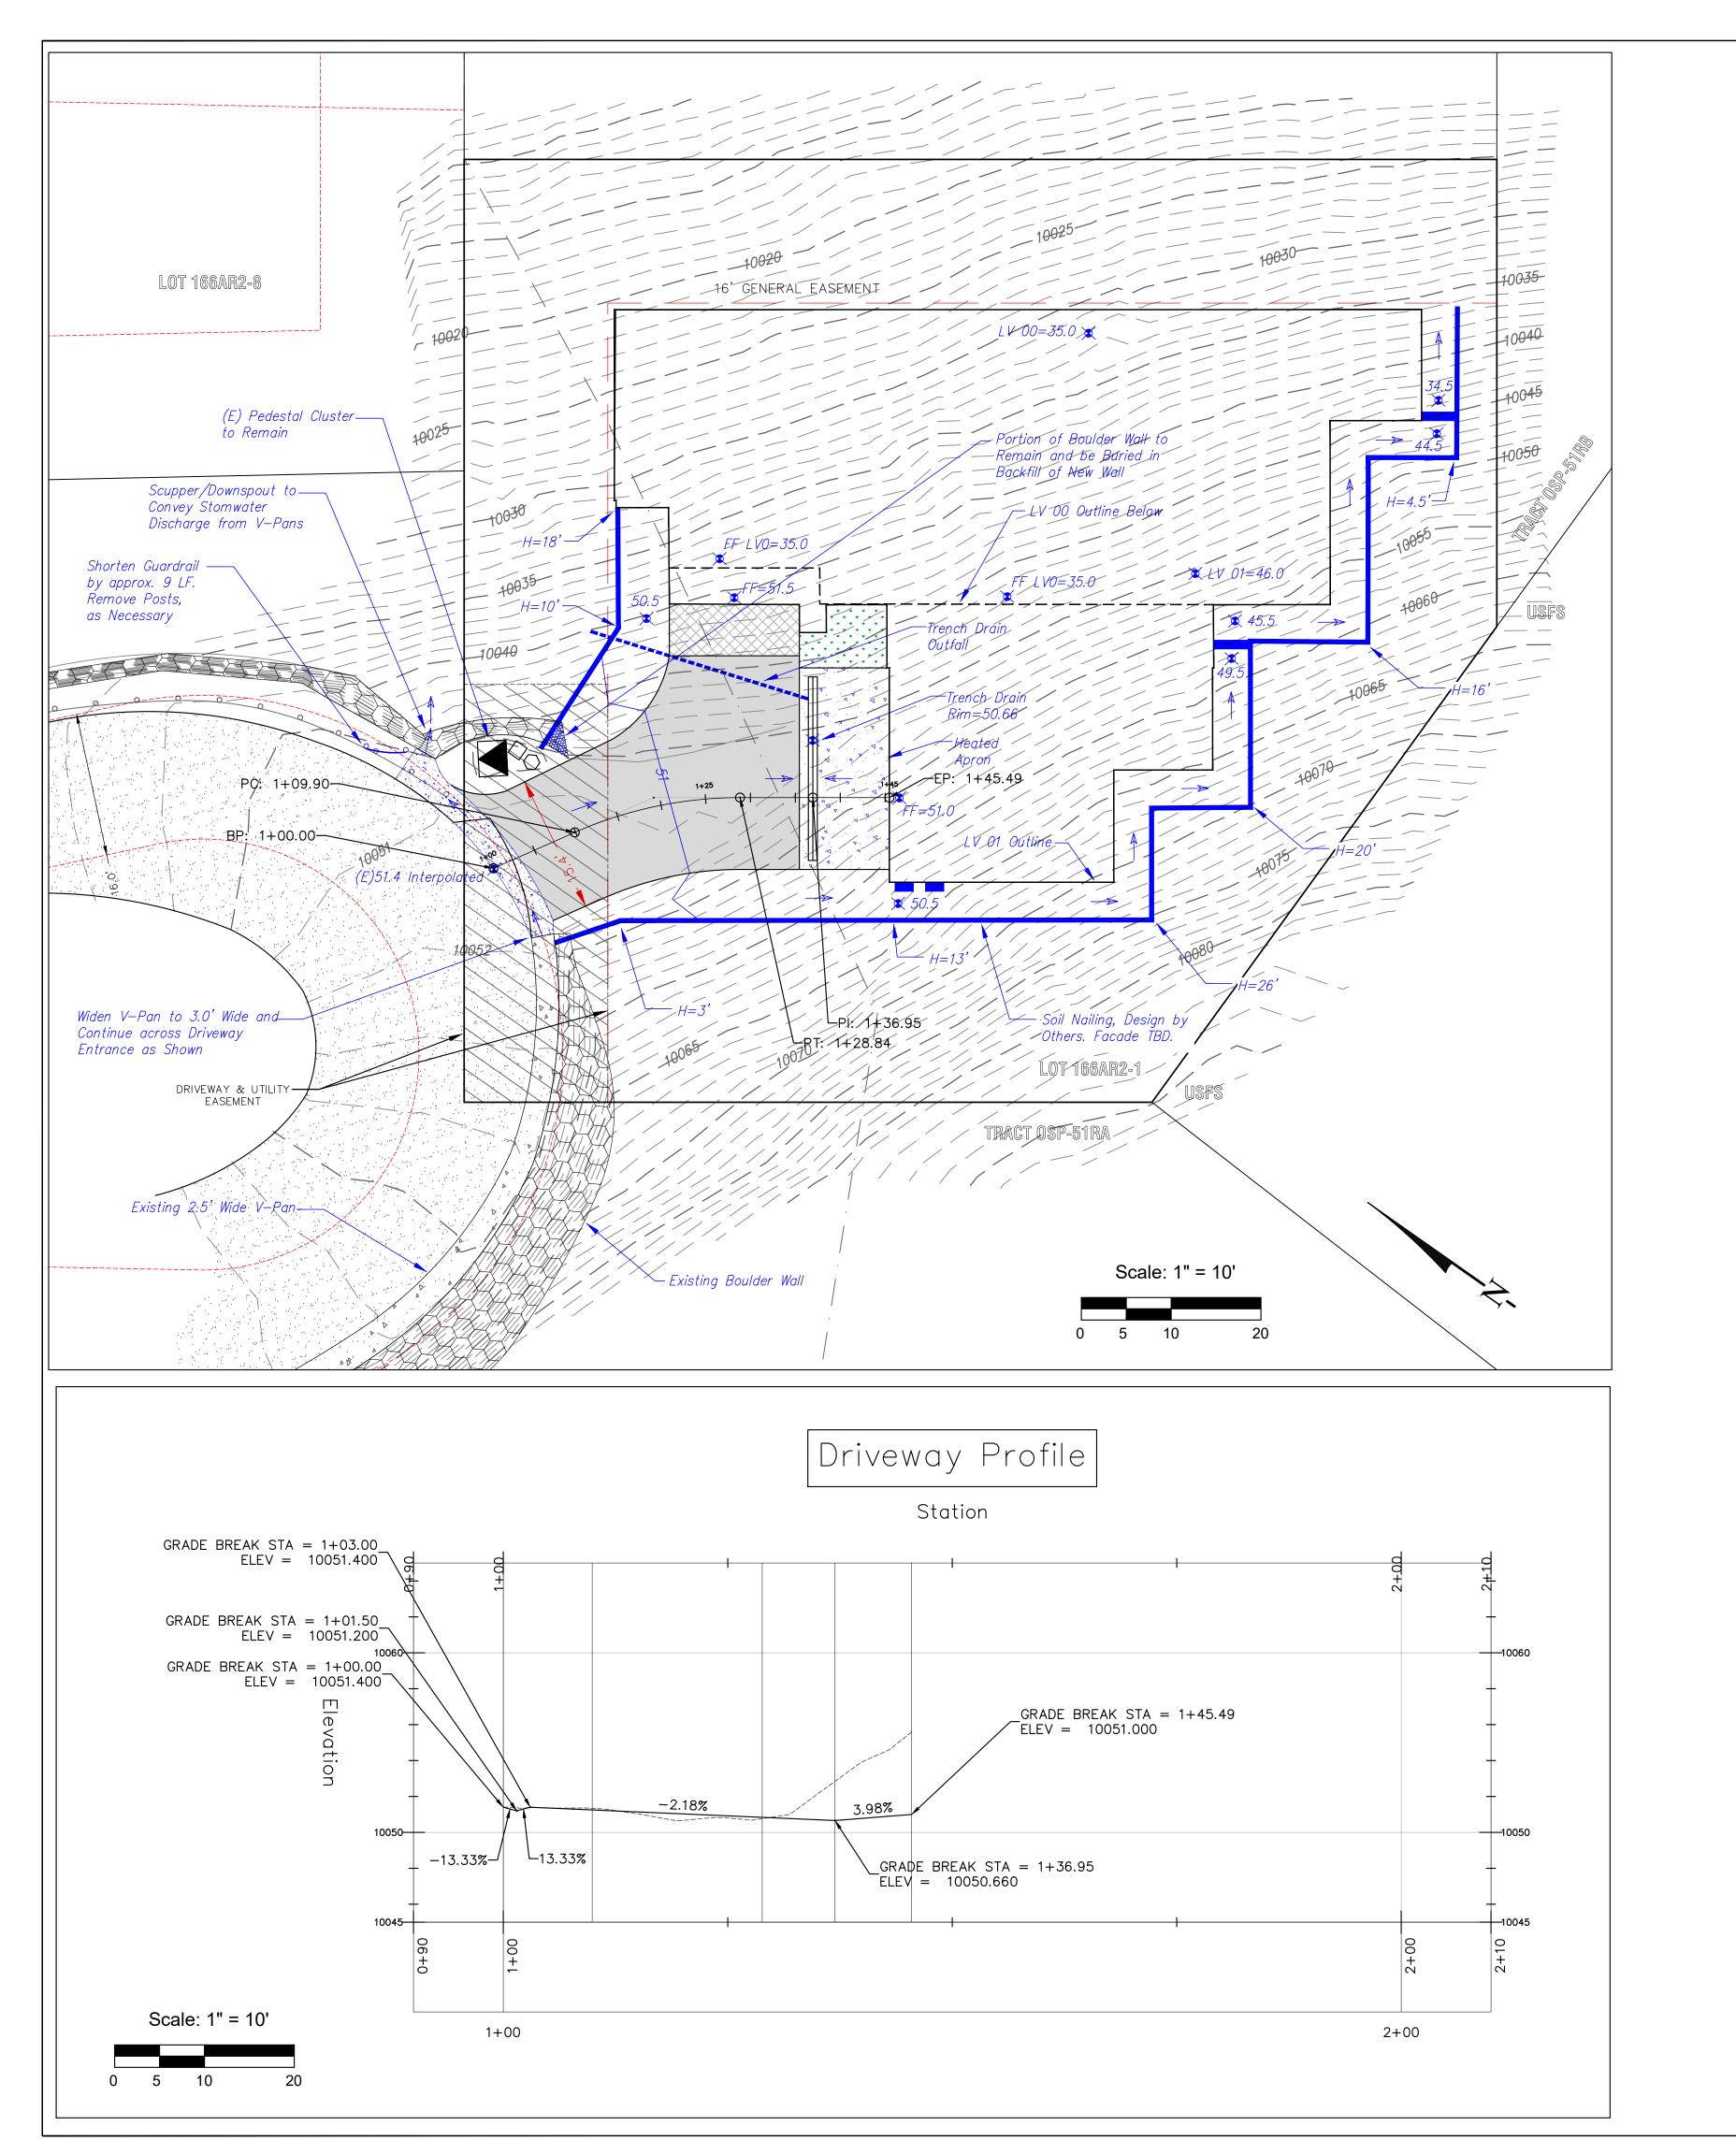

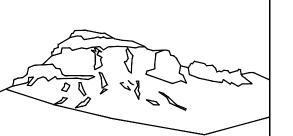

Uncompahgre Engineering, LLC

P.O. Box 3945 Telluride, CO 81435 970-729-0683

SUBMISSIONS:

SUBMITTAL

2024-01-20

Lot 166AR2-1 Stonegate Mtn. Village, CO





CONTRACTOR TO REVIEW AND COMPARE ALL CHAPTERS AND INTERDISCIPLINARY DRAWINGS AND REPORT ANY DISCREPANCIES TO THE ARCHITECT PRIOR TO ANY FIELD WORK BEING DONE IN ACCORDANCE WITH AIA DOCUMENT A201

Grading and Drainage

No Trees Displayed

C2.1

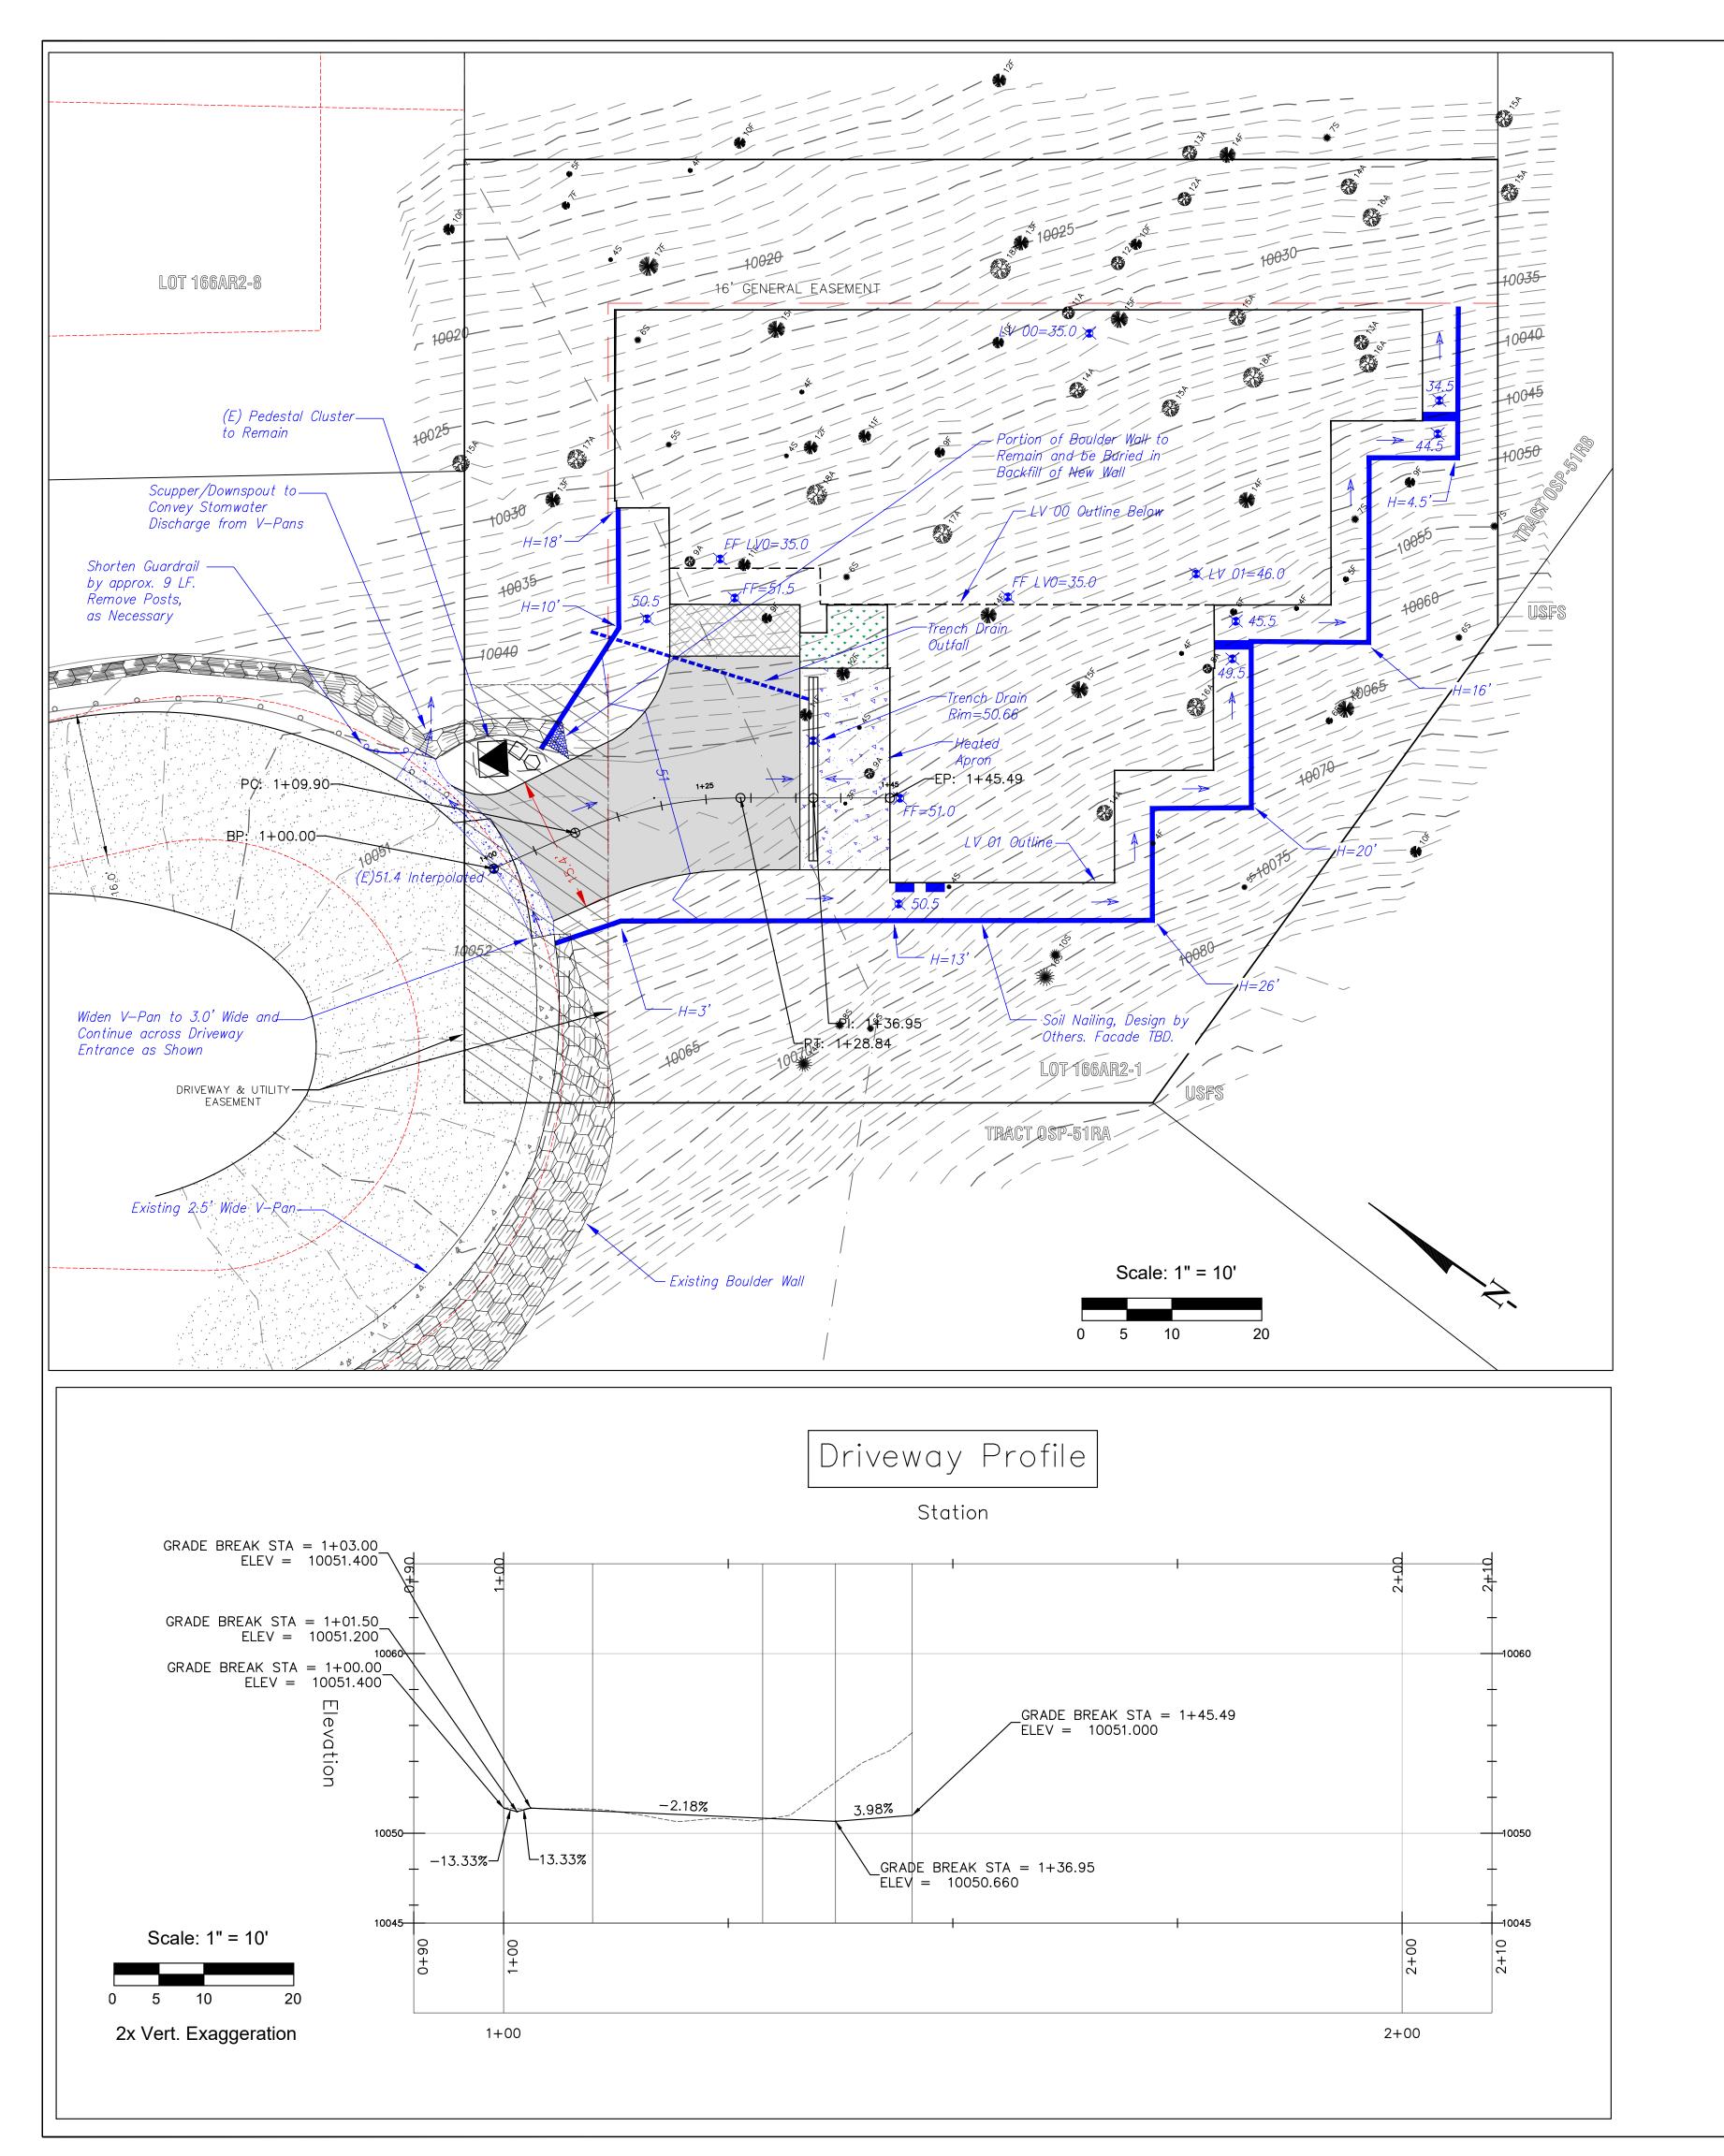

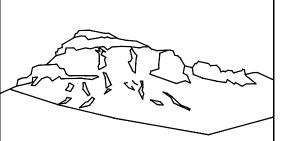

Uncompahgre Engineering, LLC

P.O. Box 3945 Telluride, CO 81435 970-729-0683

SUBMISSIONS:

SUBMITTAL

Lot 166AR2-1 Stonegate Mtn. Village, CO





CONTRACTOR TO REVIEW AND COMPARE ALL CHAPTERS AND INTERDISCIPLINARY DRAWINGS AND REPORT ANY DISCREPANCIES TO THE ARCHITECT PRIOR TO ANY FIELD WORK BEING DONE IN ACCORDANCE WITH AIA DOCUMENT A201


Grading and Drainage

With Trees Displayed

C2.2

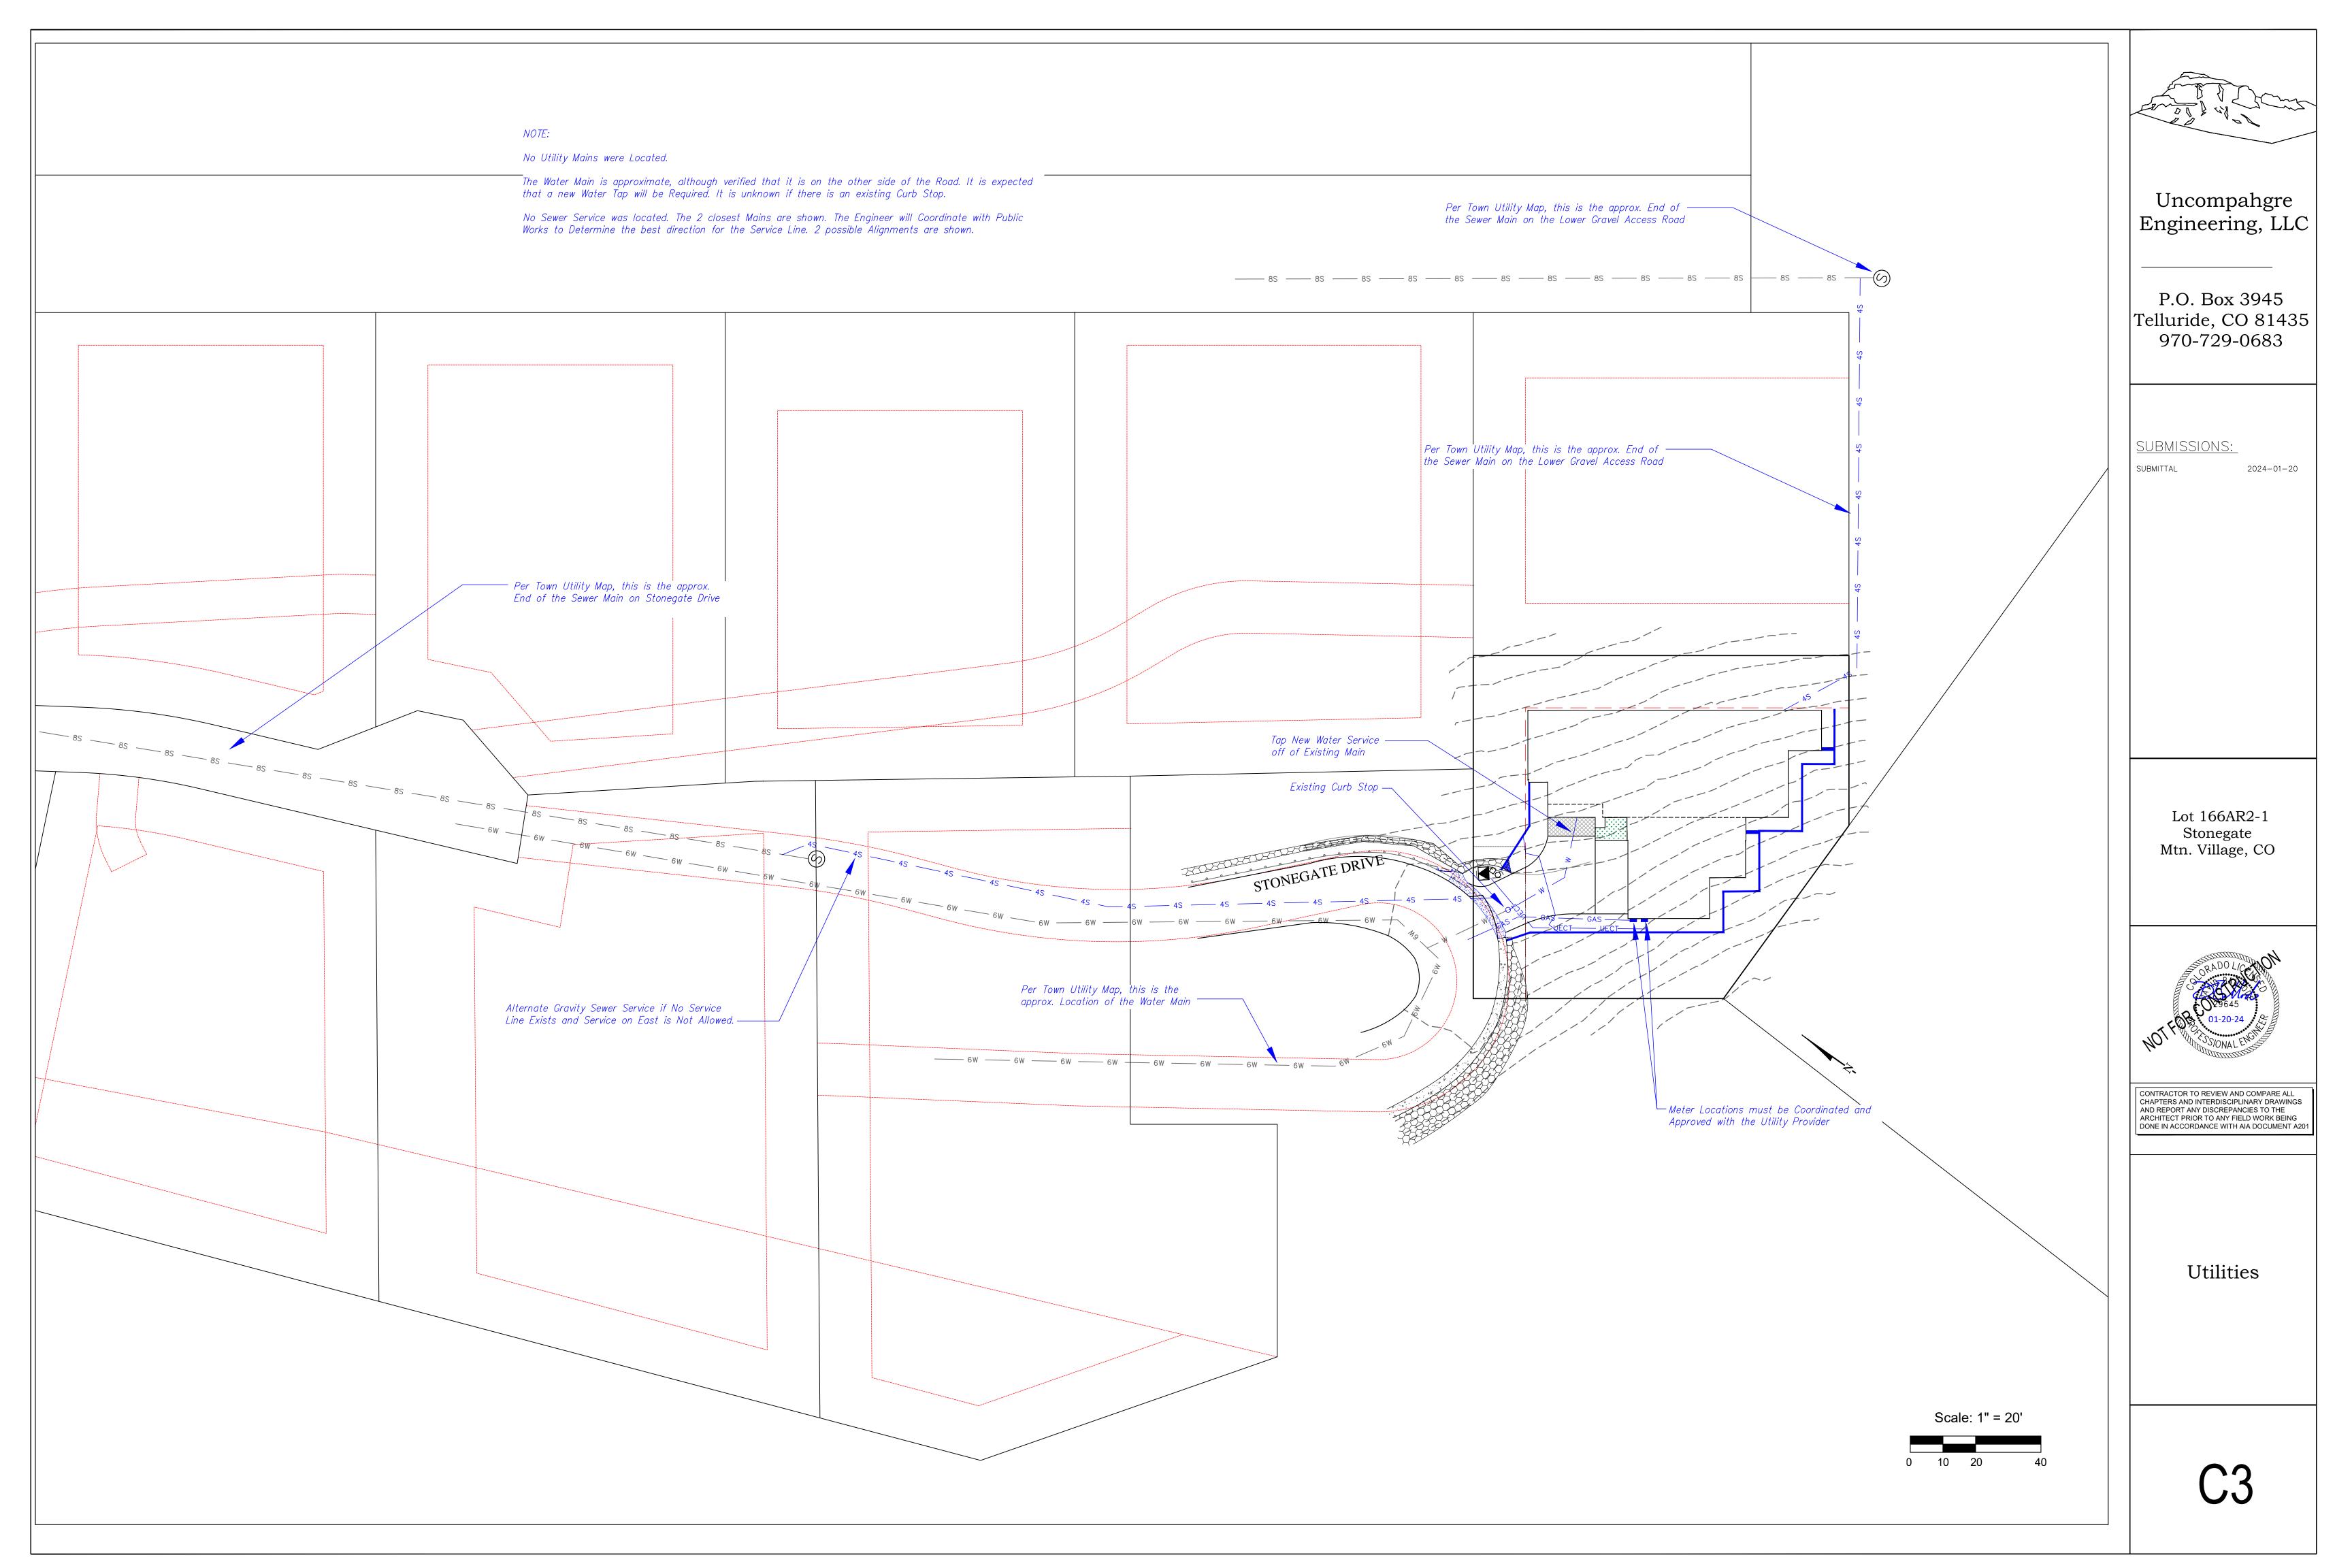

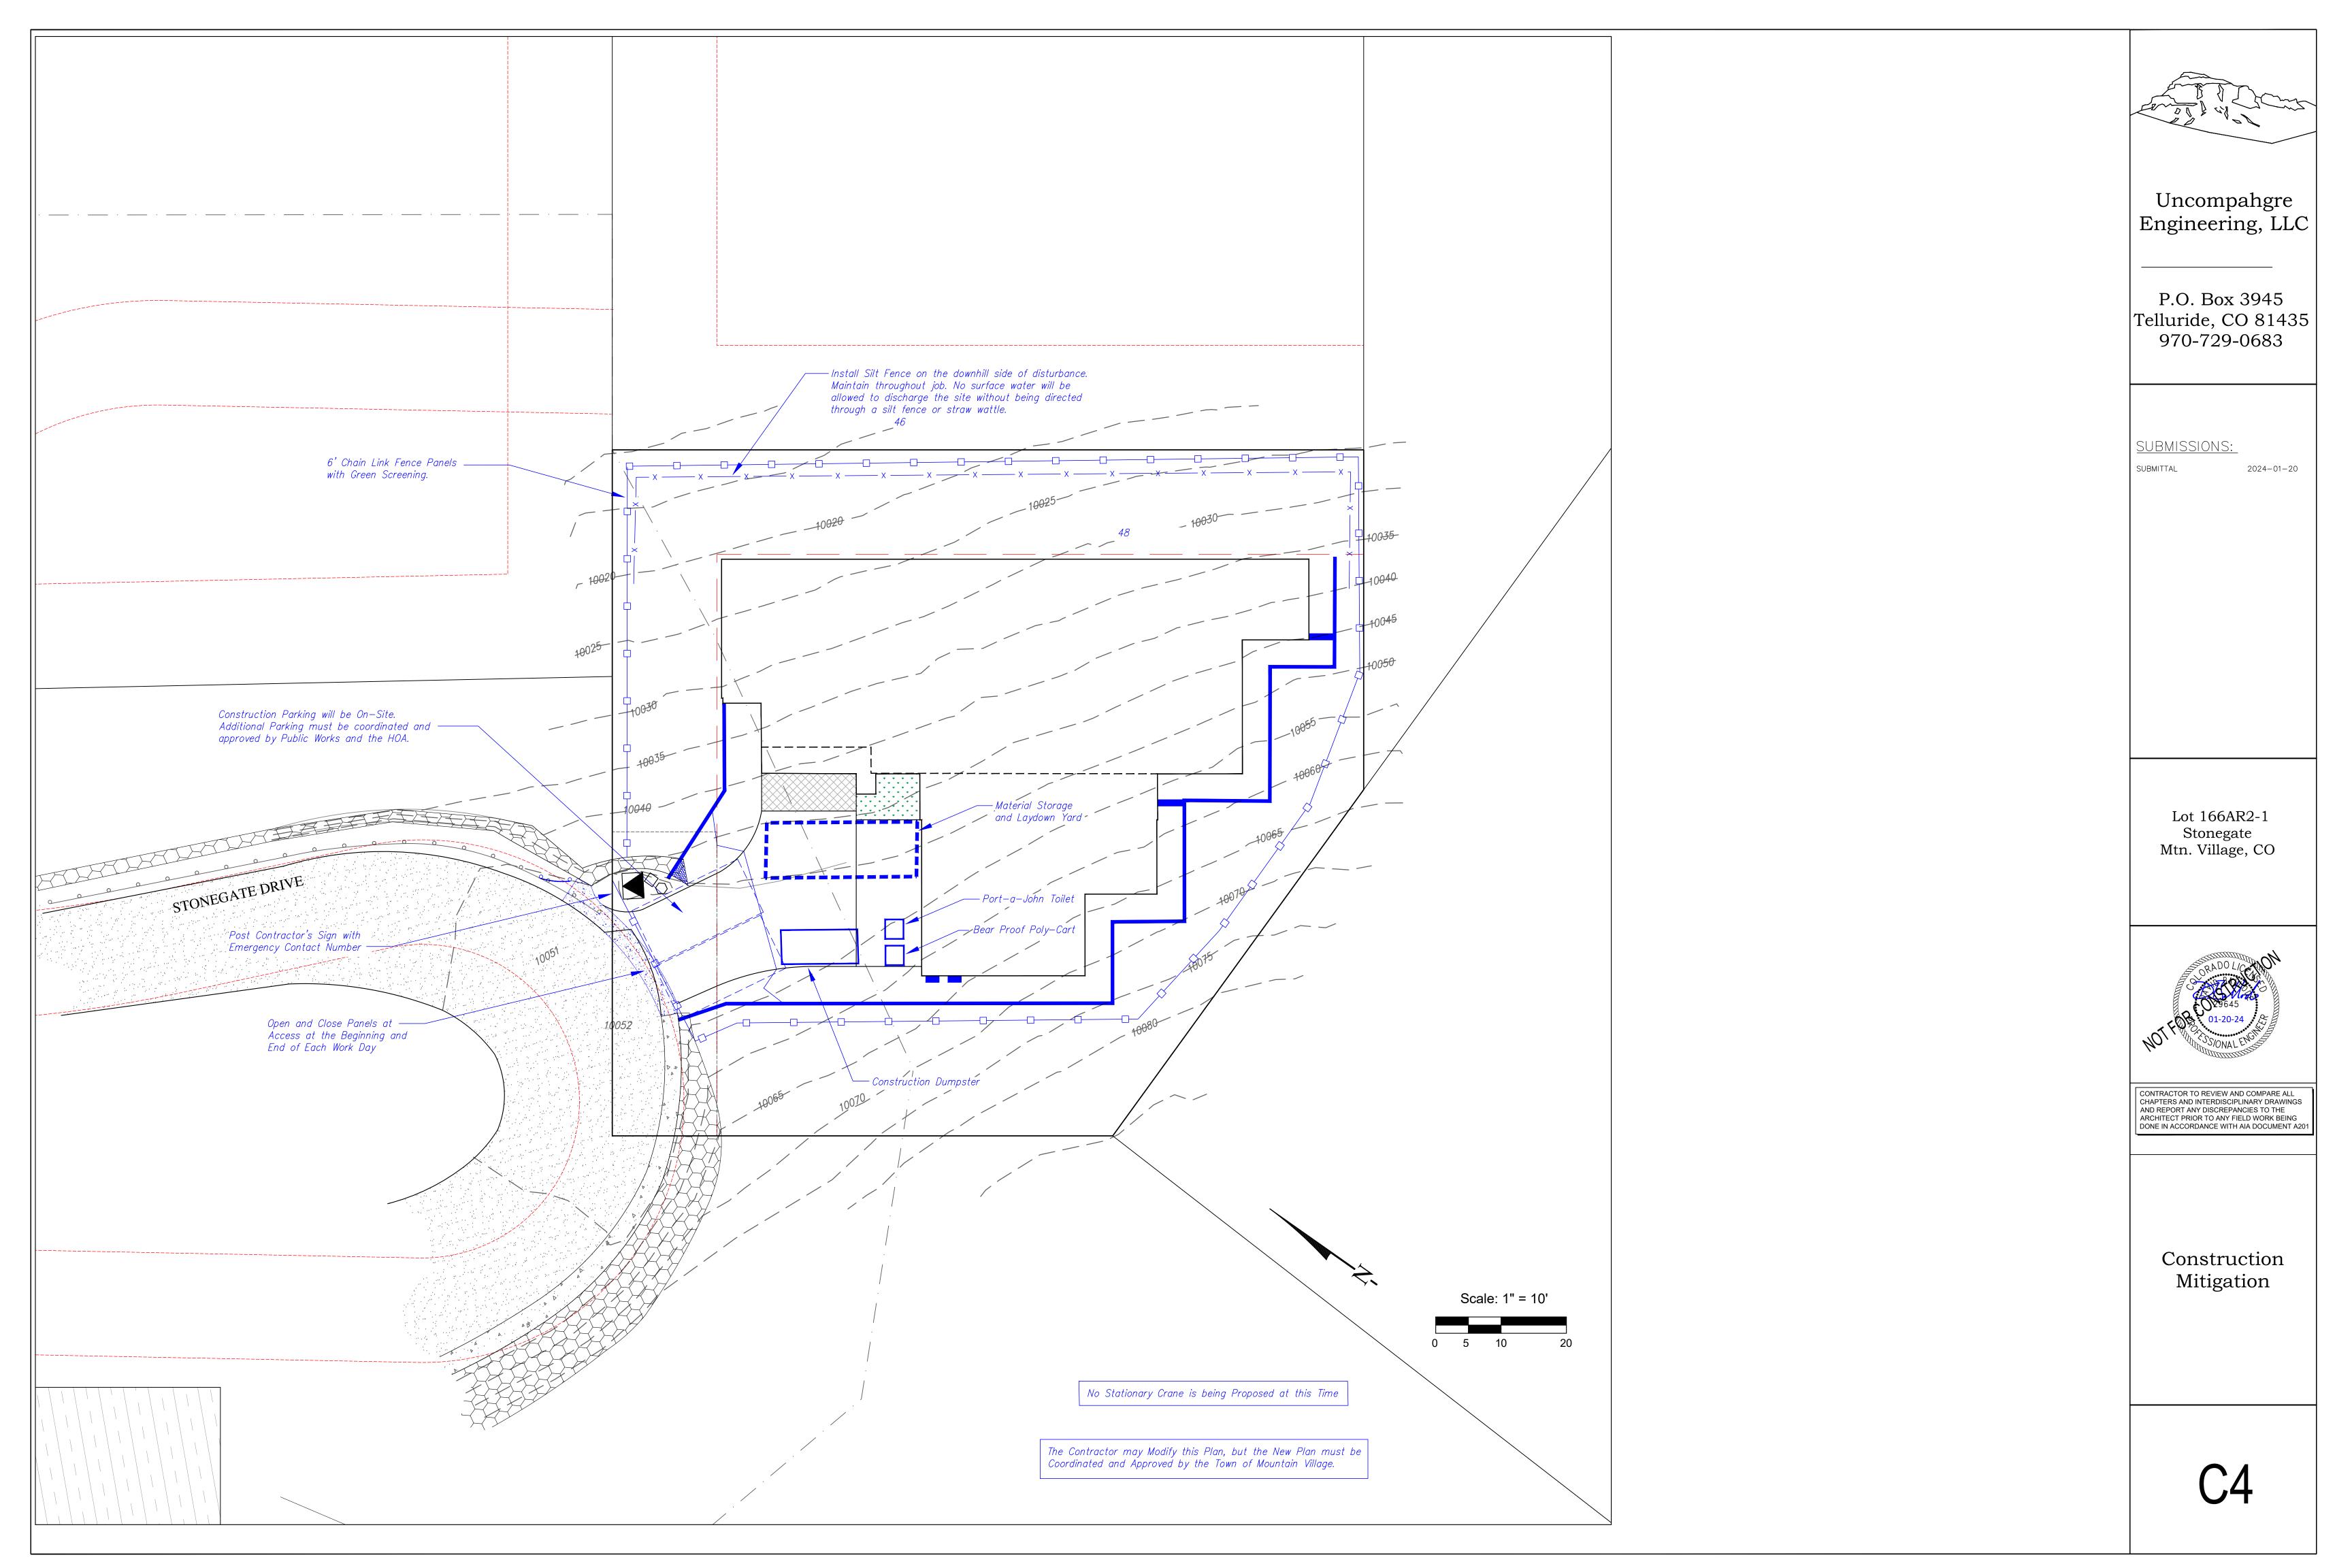

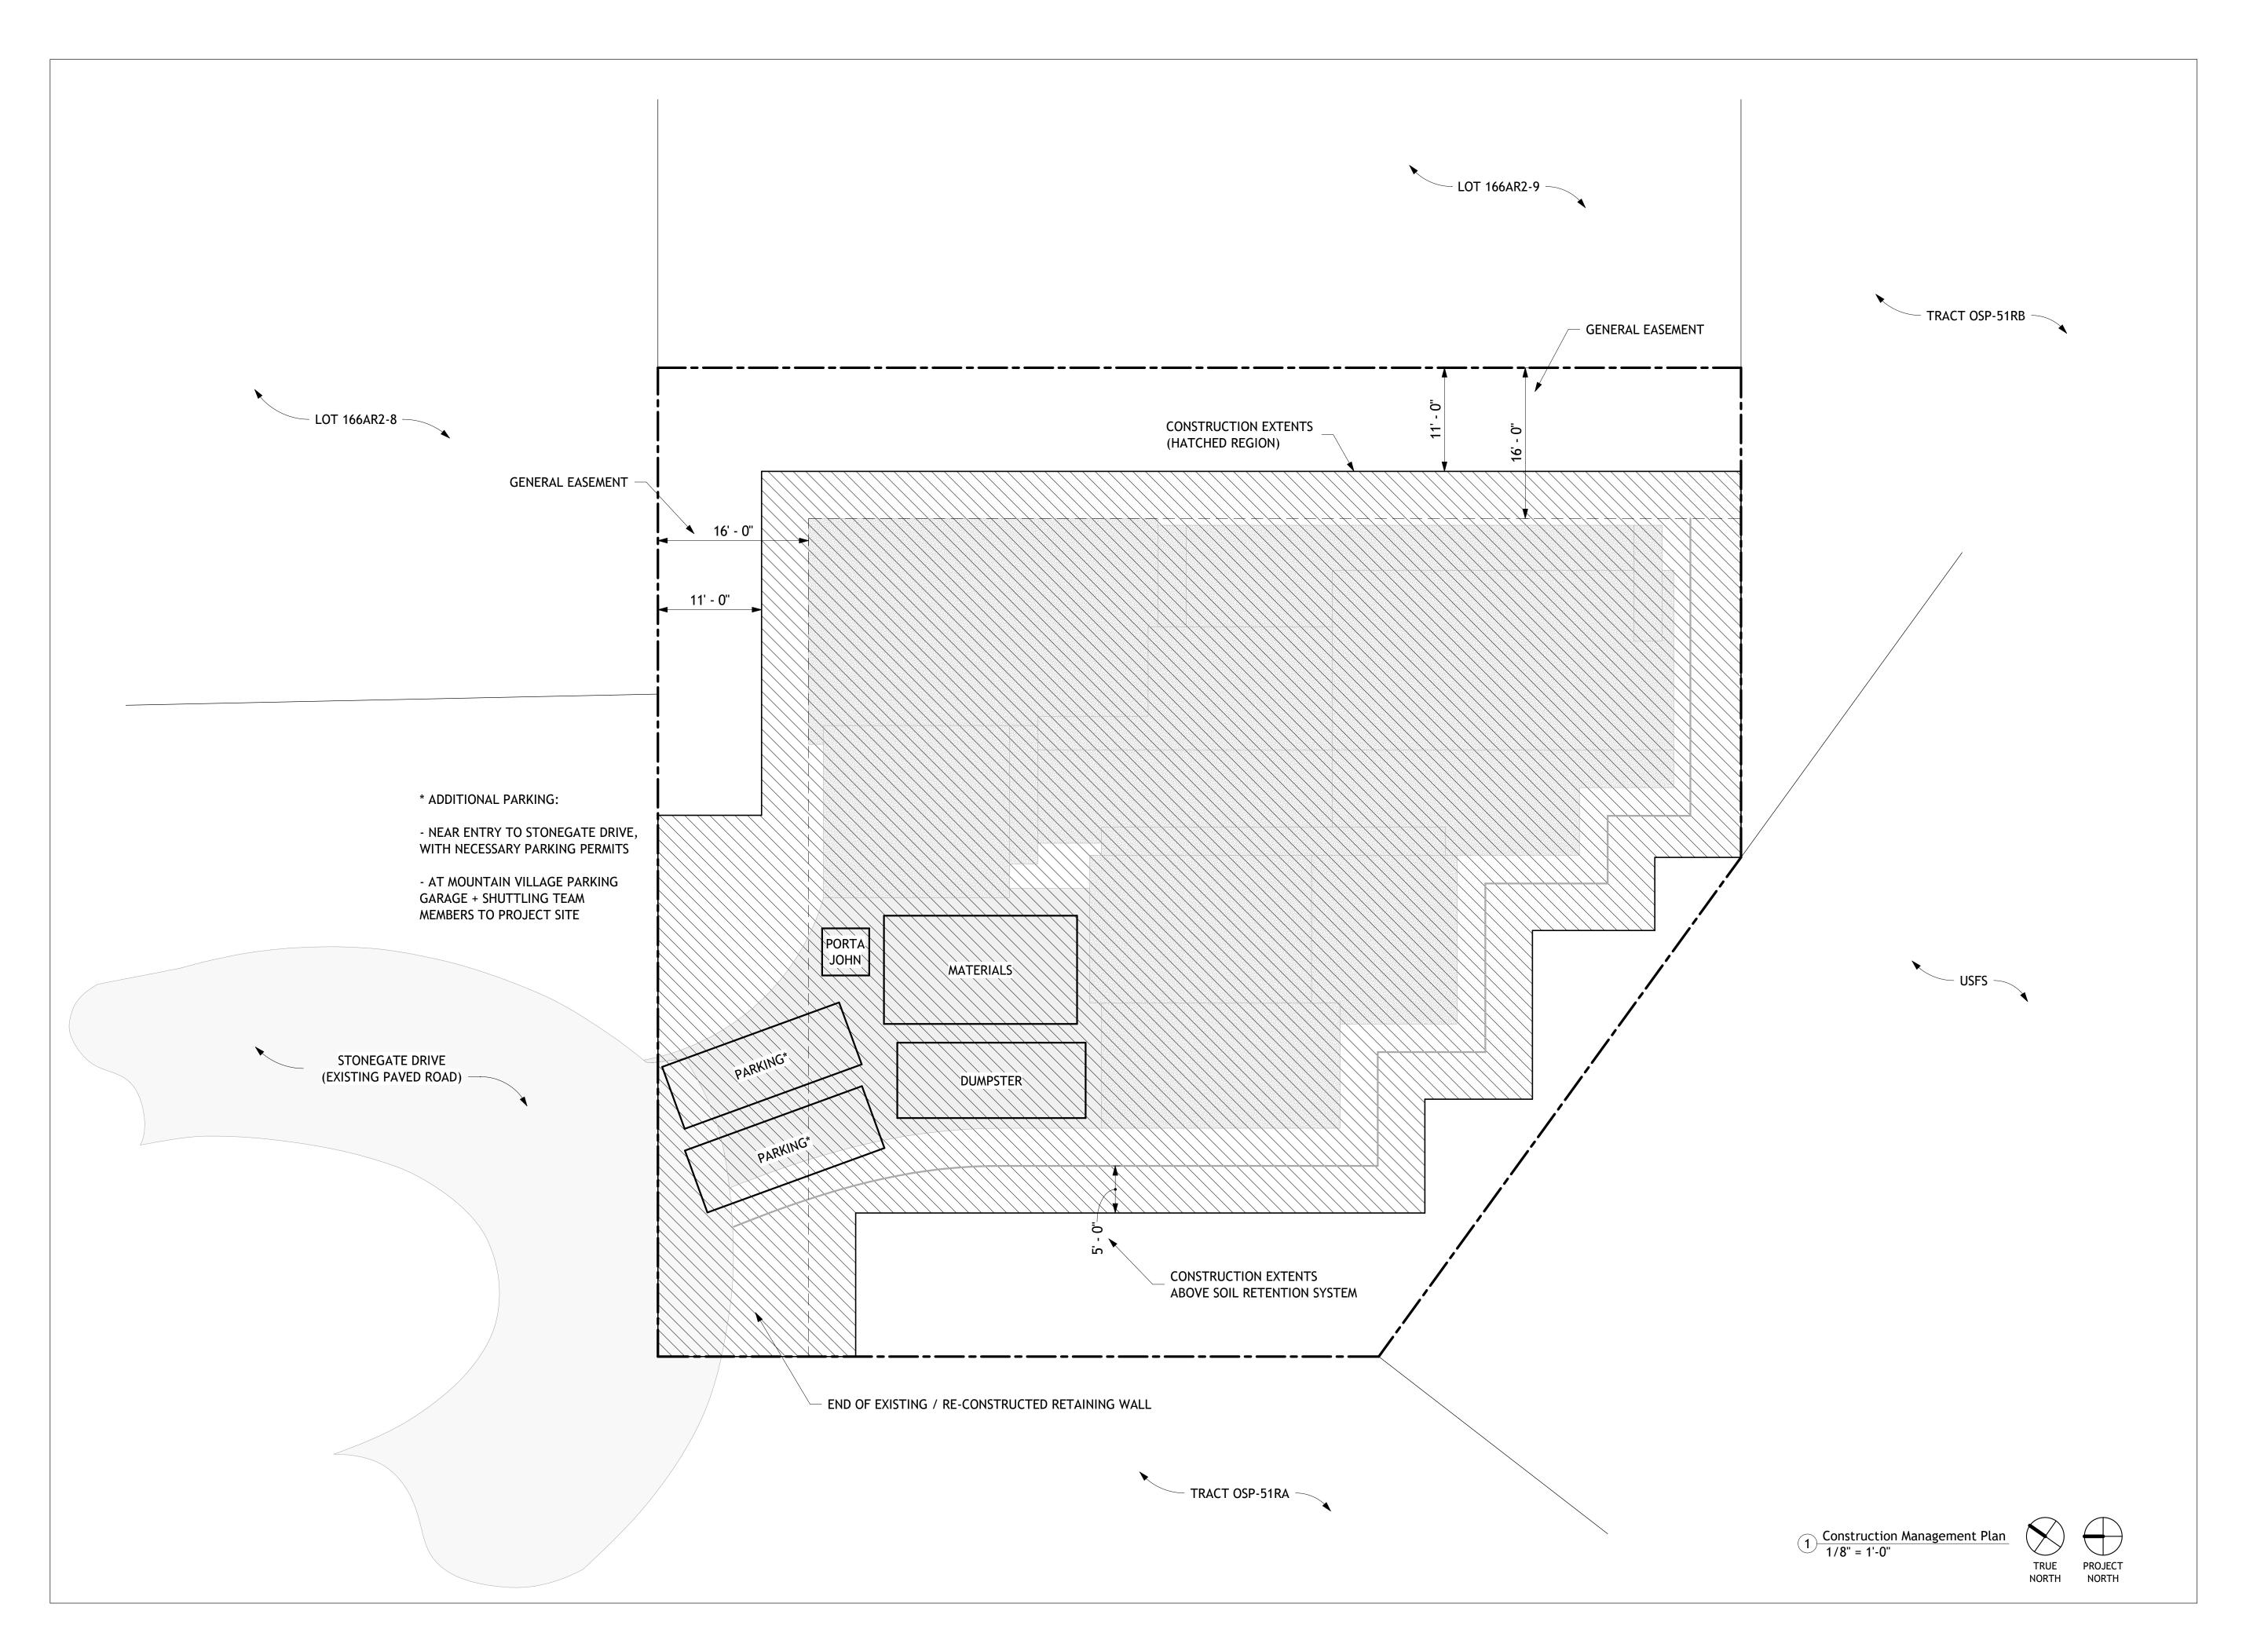



Architect Sprout aec, Ilc Scott Beans scott@sproutaec.com 970.759.3745

Civil Engineer Uncompahgre Engineering, LLC David Ballode dballode@msn.com 970.729.0683

Structural Engineer Sprout aec, Ilc Scott Beans scott@sproutaec.com 970.759.3745

Mechanical Engineer Hughes Consulting Engineering Dimitri Merrill dimitri@hce-pa.com 970.239.1949

HERS Consultant Lotus Energy Solutions Kim Wheels lotusenergysolutions@gmail.com 970.708.9674

Date Revision Description

Professional Seal:

Project Description: Mahfuz Residence Lot 166AR2-1, Stonegate Drive Mountain Village, CO 81435

Drawing Description:

Construction Management Plan

Project Number 1.22.2024 Drawn By Checked By

Drawing No.

© 2024 sprout aec, llc

STB

STB

PROJECT INFORMATION

SITE INFORMATION:

ADDRESS: LOT 166AR2-1, STONEGATE DRIVE MOUNTAIN VILLAGE, CO 81435

PARCEL #: 477910102001 LOT SIZE: 0.254 ACRES

OCCUPANCY CLASSIFICATION: R-3

APPLICABLE BUILDING CODES: 2018 IRC AND APPLICABLE CODES AS REQUIRED BY THE TOWN OF MOUNTAIN VILLAGE

BUILDING HEIGHT: 35'-0" MAX | 35'-0" PROPOSED AVERAGE BLDG HT: 30'-0" MAX | 27'-11" PROPOSED

REFER TO SHEETS A002, A003

SQ FOOTAGE: FINISHED INTERIOR 6,310 SQ FT


GARAGE 650 SQ FT EXTERIOR DECK 990 SQ FT

LOT COVERAGE: 40% MAX | 38% PROPOSED

PARKING: REQ'D - 2 ENCLOSED, 2 SURFACE

PROVIDED - 2 ENCLOSED, 4 SURFACE

LOCATION/VICINITY MAP

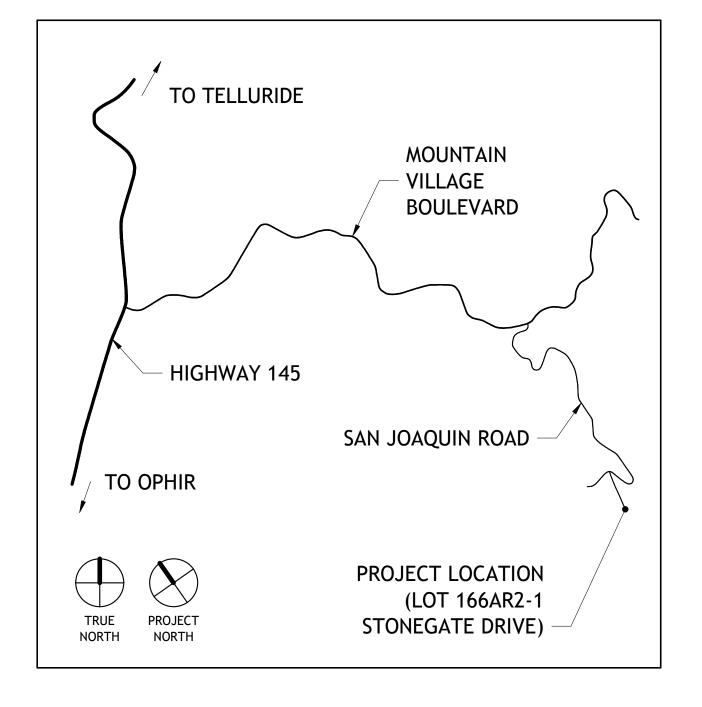

MAHFUZ RESIDENCE



GENERAL NOTES

- 1. THIS DRAWING SET IS INTENTED SOLELY FOR DESIGN REVIEW SUBMISSION TO THE TOWN OF MOUNTAIN VILLAGE, COLORADO.
- 2. THIS SET IS NOT FOR CONSTRUCTION, NOR SHALL IT BE ACCEPTED BY ANY BUILDING DEPARTMENT AS SUCH.
- 3. ANY COST ESTIMATES BASED ON THIS SET ARE AT THE DISCRETION OF THE OWNER AND//OR CONTRACTOR, AS THIS SET DOES NOT CONTAIN ADEQUATE INFORMATION FOR A DETALED & ACCURATE PRICING EXERCISE.

INSULATION REQ'TS

CLIMATE ZONE
ROOF/CEILING
R-49
WOOD FRAME WALL
BASEMENT WALL
FLOOR
SLAB-ON-GRADE
WINDOW
DOOR
R-30
U-0.30
U-0.30

- a. 2" CLOSED CELL SPRAY FOAM (R-14) + 3.5" FIBERGLASS BATT (R-15)
- b. FOUNDATION EXTERIOR FACE (CONTINUOUS) MINIMUM INSULATION: R-15; FOUNDATION INTERIOR FACE (CAVITY) MINIMUM INSULATION: R-19
- c. 2" RIDGID INSULATION; VERTICAL FACE OF INSULATION TO EXTEND MINIMUM 2 FEET BELOW GRADE AT FACE OF SLAB; (a+b = 4 FEET)
- d. PROVIDE CLASS II VAPOR RETARDER AT WARM SIDE OF EXTERIOR WALLS AS INDICATED IN WALL ASSEMBLIES
- e. ALL PIPING AND WATER DRAINS NEAR EXTERIOR WALLS SHALL BE WRAPPED WITH MIN. R-8 PRE-FORMED POLYETHYLENE FOAM INSULATION.
- f. INSULATE WITH MIN. R-8 BATT AROUND ALL DUCTING TO EXTERIOR, INCLUDING EXHAUST FAN.
- g. ALL MECHANICAL SYSTEM PIPING SHALL BE WRAPPED WITH MIN R-3 PRE-FORMED POLYETHYLENE FOAM INSULATION.
- h. ALL CIRCULATING HOT WATER SYSTEM PIPING SHALL BE WRAPPED WITH MIN. R-2 PRE-FORMED POLYETHYLENE FOAM NSULATION.

SHEET LIST

SUBMITTAL NARRATIVE (EXST) SURVEY + EXISTING CONDITIONS PLAN CIVIL GENERAL NOTES GRADING & DRAINAGE PLAN (WITH TREES) GRADING & DRAINAGE PLAN (WITHOUT TREES) UTILITIES **C4** CONSTRUCTION MITIGATION PLAN (CIVIL) CONSTRUCTION MITIGATION PLAN (ARCH) DRB SUBMITTAL COVER SHEET ARCHITECTURAL SITE PLAN PARALLEL PLANE HEIGHT ANALYSIS AVERAGE BUILDING HEIGHT CALCULATION A100 LOWER LEVEL FLOOR PLAN MAIN LEVEL FLOOR PLAN ENTRY & GARAGE LEVEL FLOOR PLAN A103 UPPER LEVEL FLOOR PLAN **ROOF PLAN** A104 **EXTERIOR 3-D VIEWS** A200 **EXTERIOR ELEVATIONS** EXTERIOR MATERIAL CALCULATIONS DOOR & WINDOW SCHEDULES EXTERIOR LIGHTING PLANS LANDSCAPE PLAN



628 Oak Street Steamboat Springs, CO 80487 scott@sproutaec.com

Architect Sprout aec, Ilc Scott Beans scott@sproutaec.com 970.759.3745


Civil Engineer Uncompahgre Engineering, LLC David Ballode dballode@msn.com

Structural Engineer Sprout aec, llc Scott Beans scott@sproutaec.com

Mechanical Engineer Hughes Consulting Engineering Dimitri Merrill dimitri@hce-pa.com

HERS Consultant
Lotus Energy Solutions
Kim Wheels
lotusenergysolutions@gmail.com

Revision Description Date

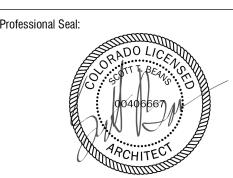

Project Description:

Mahfuz Residence

Lot 166AR2-1, Stonegate Drive

Mountain Village, CO 81435

Drawing Description:

DRB Submittal Cover Sheet


Project Number

Date 1.22.2024

Drawn By STB

Checked By STB

A000

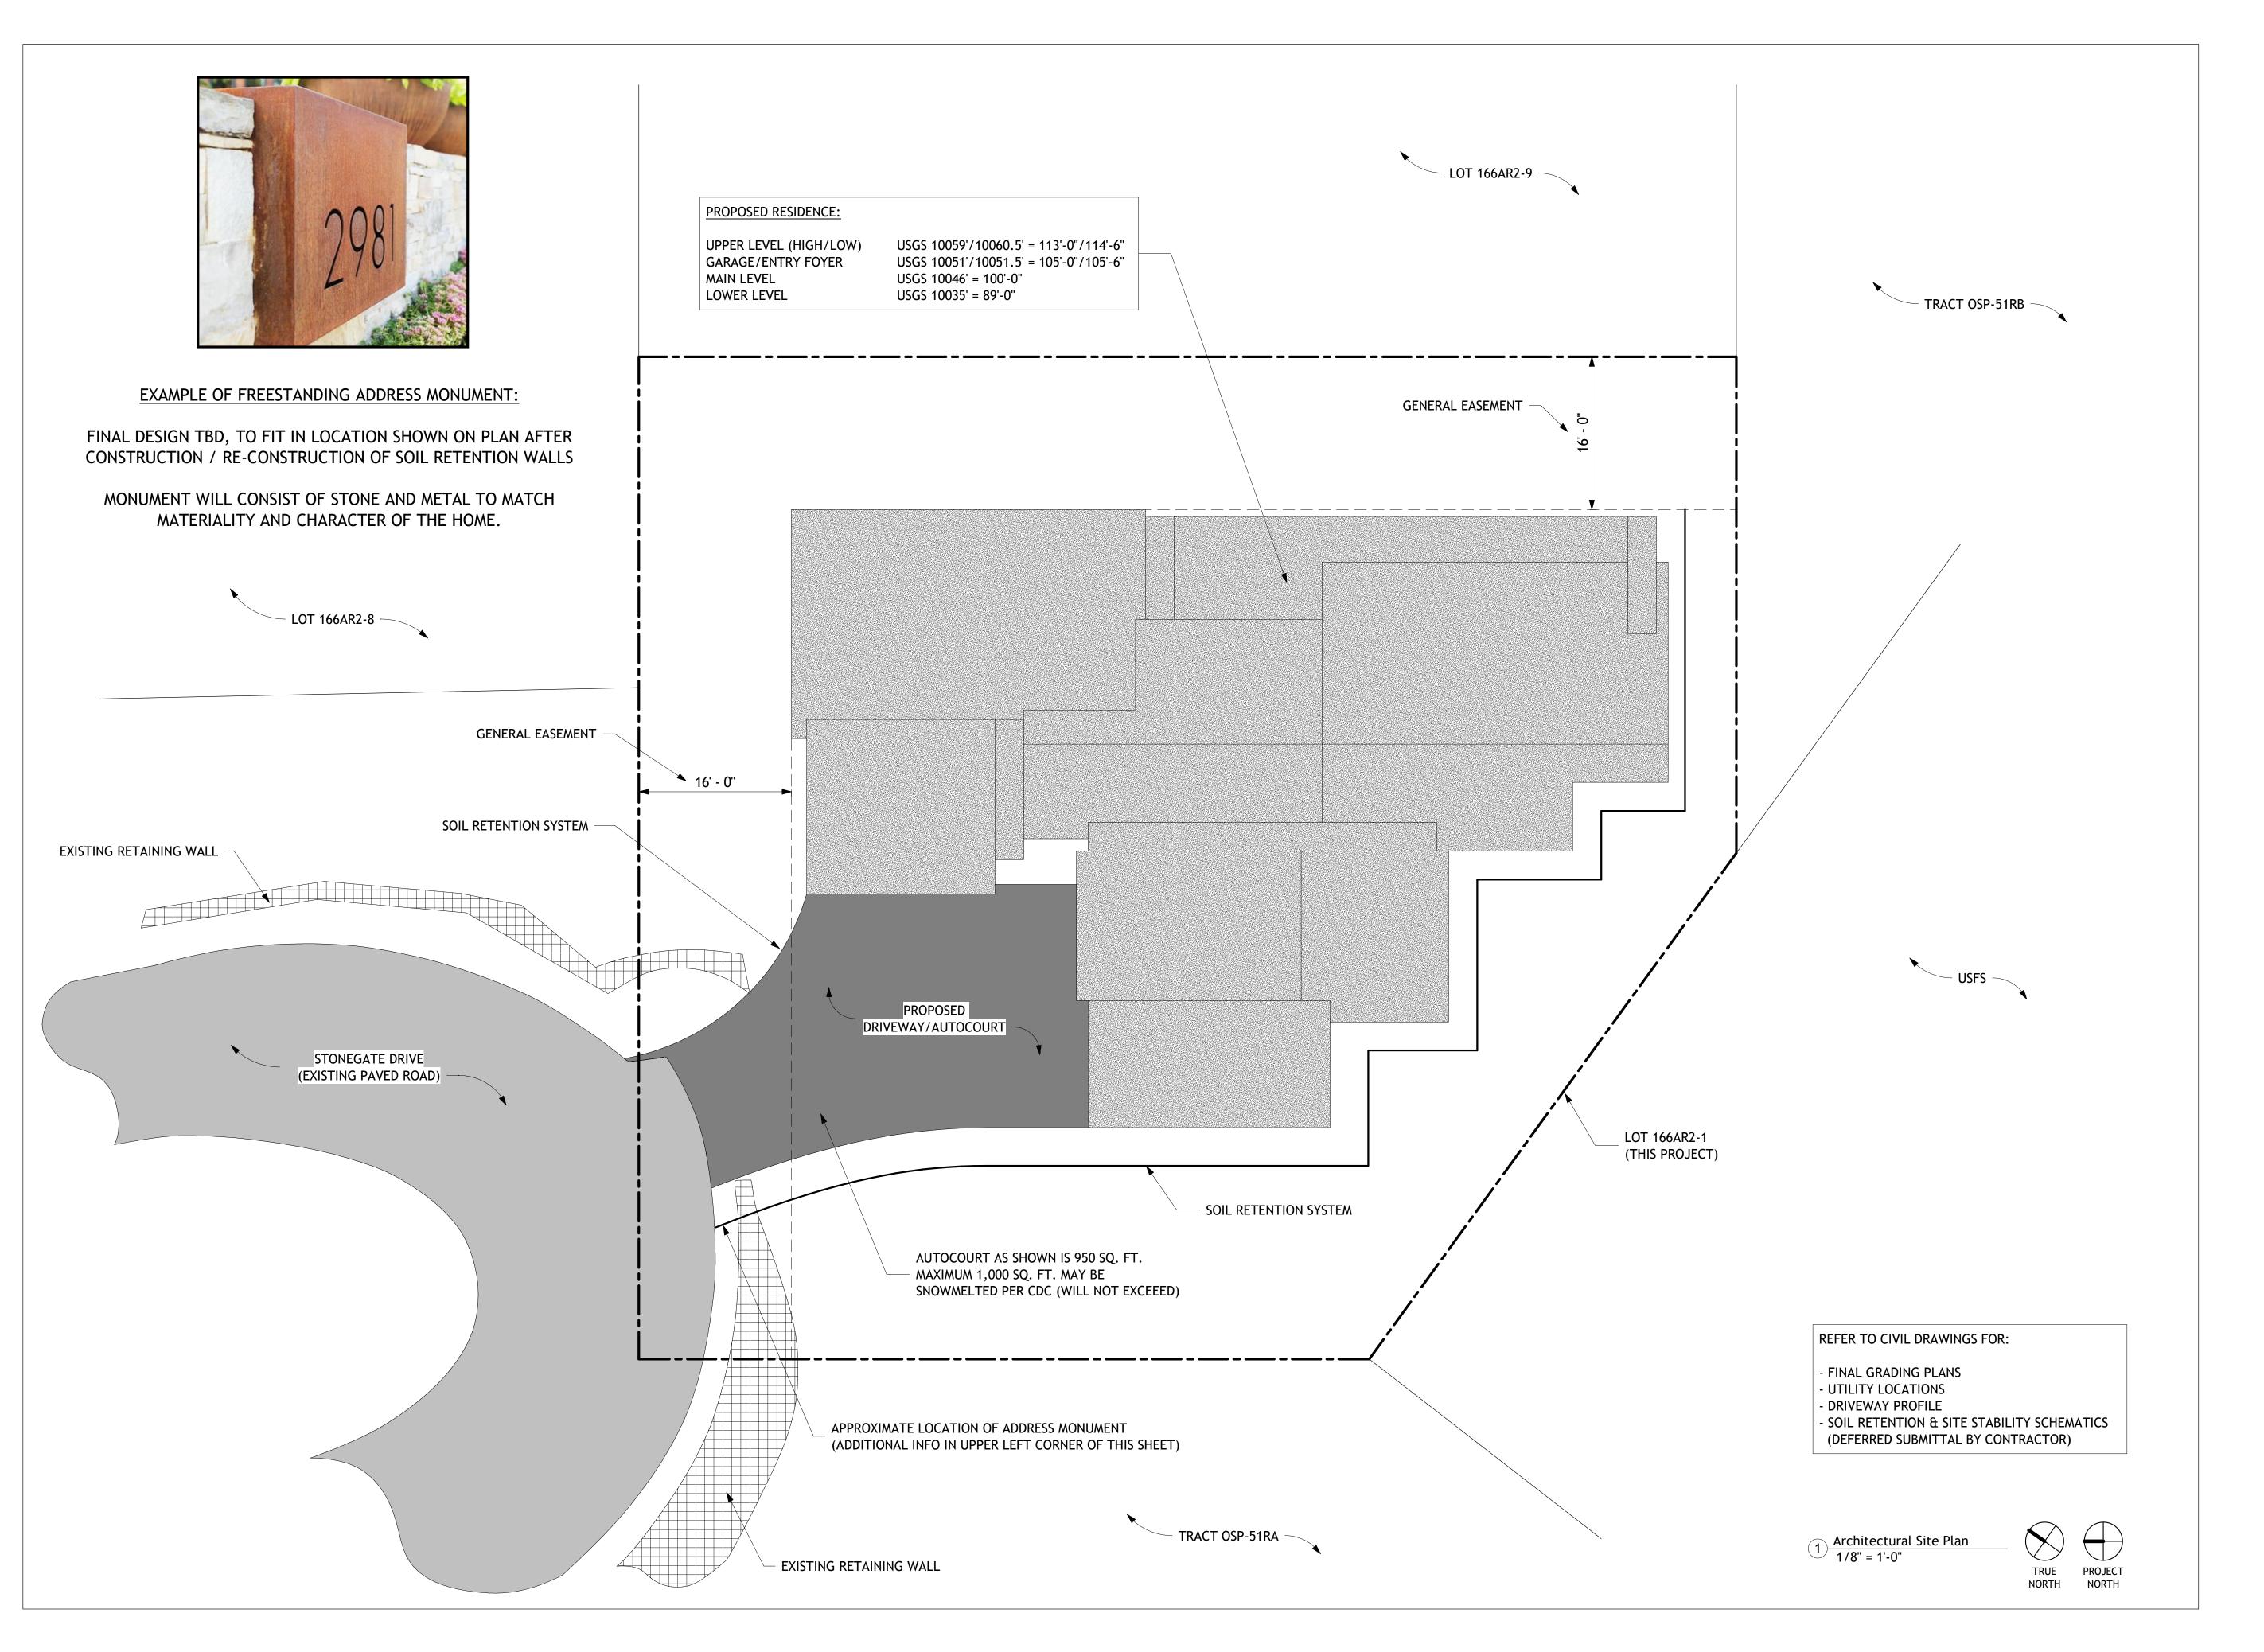



Architect Sprout aec, Ilc Scott Beans scott@sproutaec.com 970.759.3745

Civil Engineer Uncompahgre Engineering, LLC David Ballode dballode@msn.com 970.729.0683

Structural Engineer Sprout aec, Ilc Scott Beans scott@sproutaec.com 970.759.3745

Mechanical Engineer Hughes Consulting Engineering Dimitri Merrill dimitri@hce-pa.com 970.239.1949

HERS Consultant Lotus Energy Solutions Kim Wheels lotusenergysolutions@gmail.com 970.708.9674

| Revision | Description | Date |
|----------|-------------|------|
| | | |
| | | |
Professional Seal:

Project Description:

Mahfuz Residence

Lot 166AR2-1, Stonegate Drive

Mountain Village, CO 81435

Drawing Description:

Architectural Site Plan

Project Number


Date 1.22.2024


Drawn By STB

Checked By STB

Drawing No.

A001

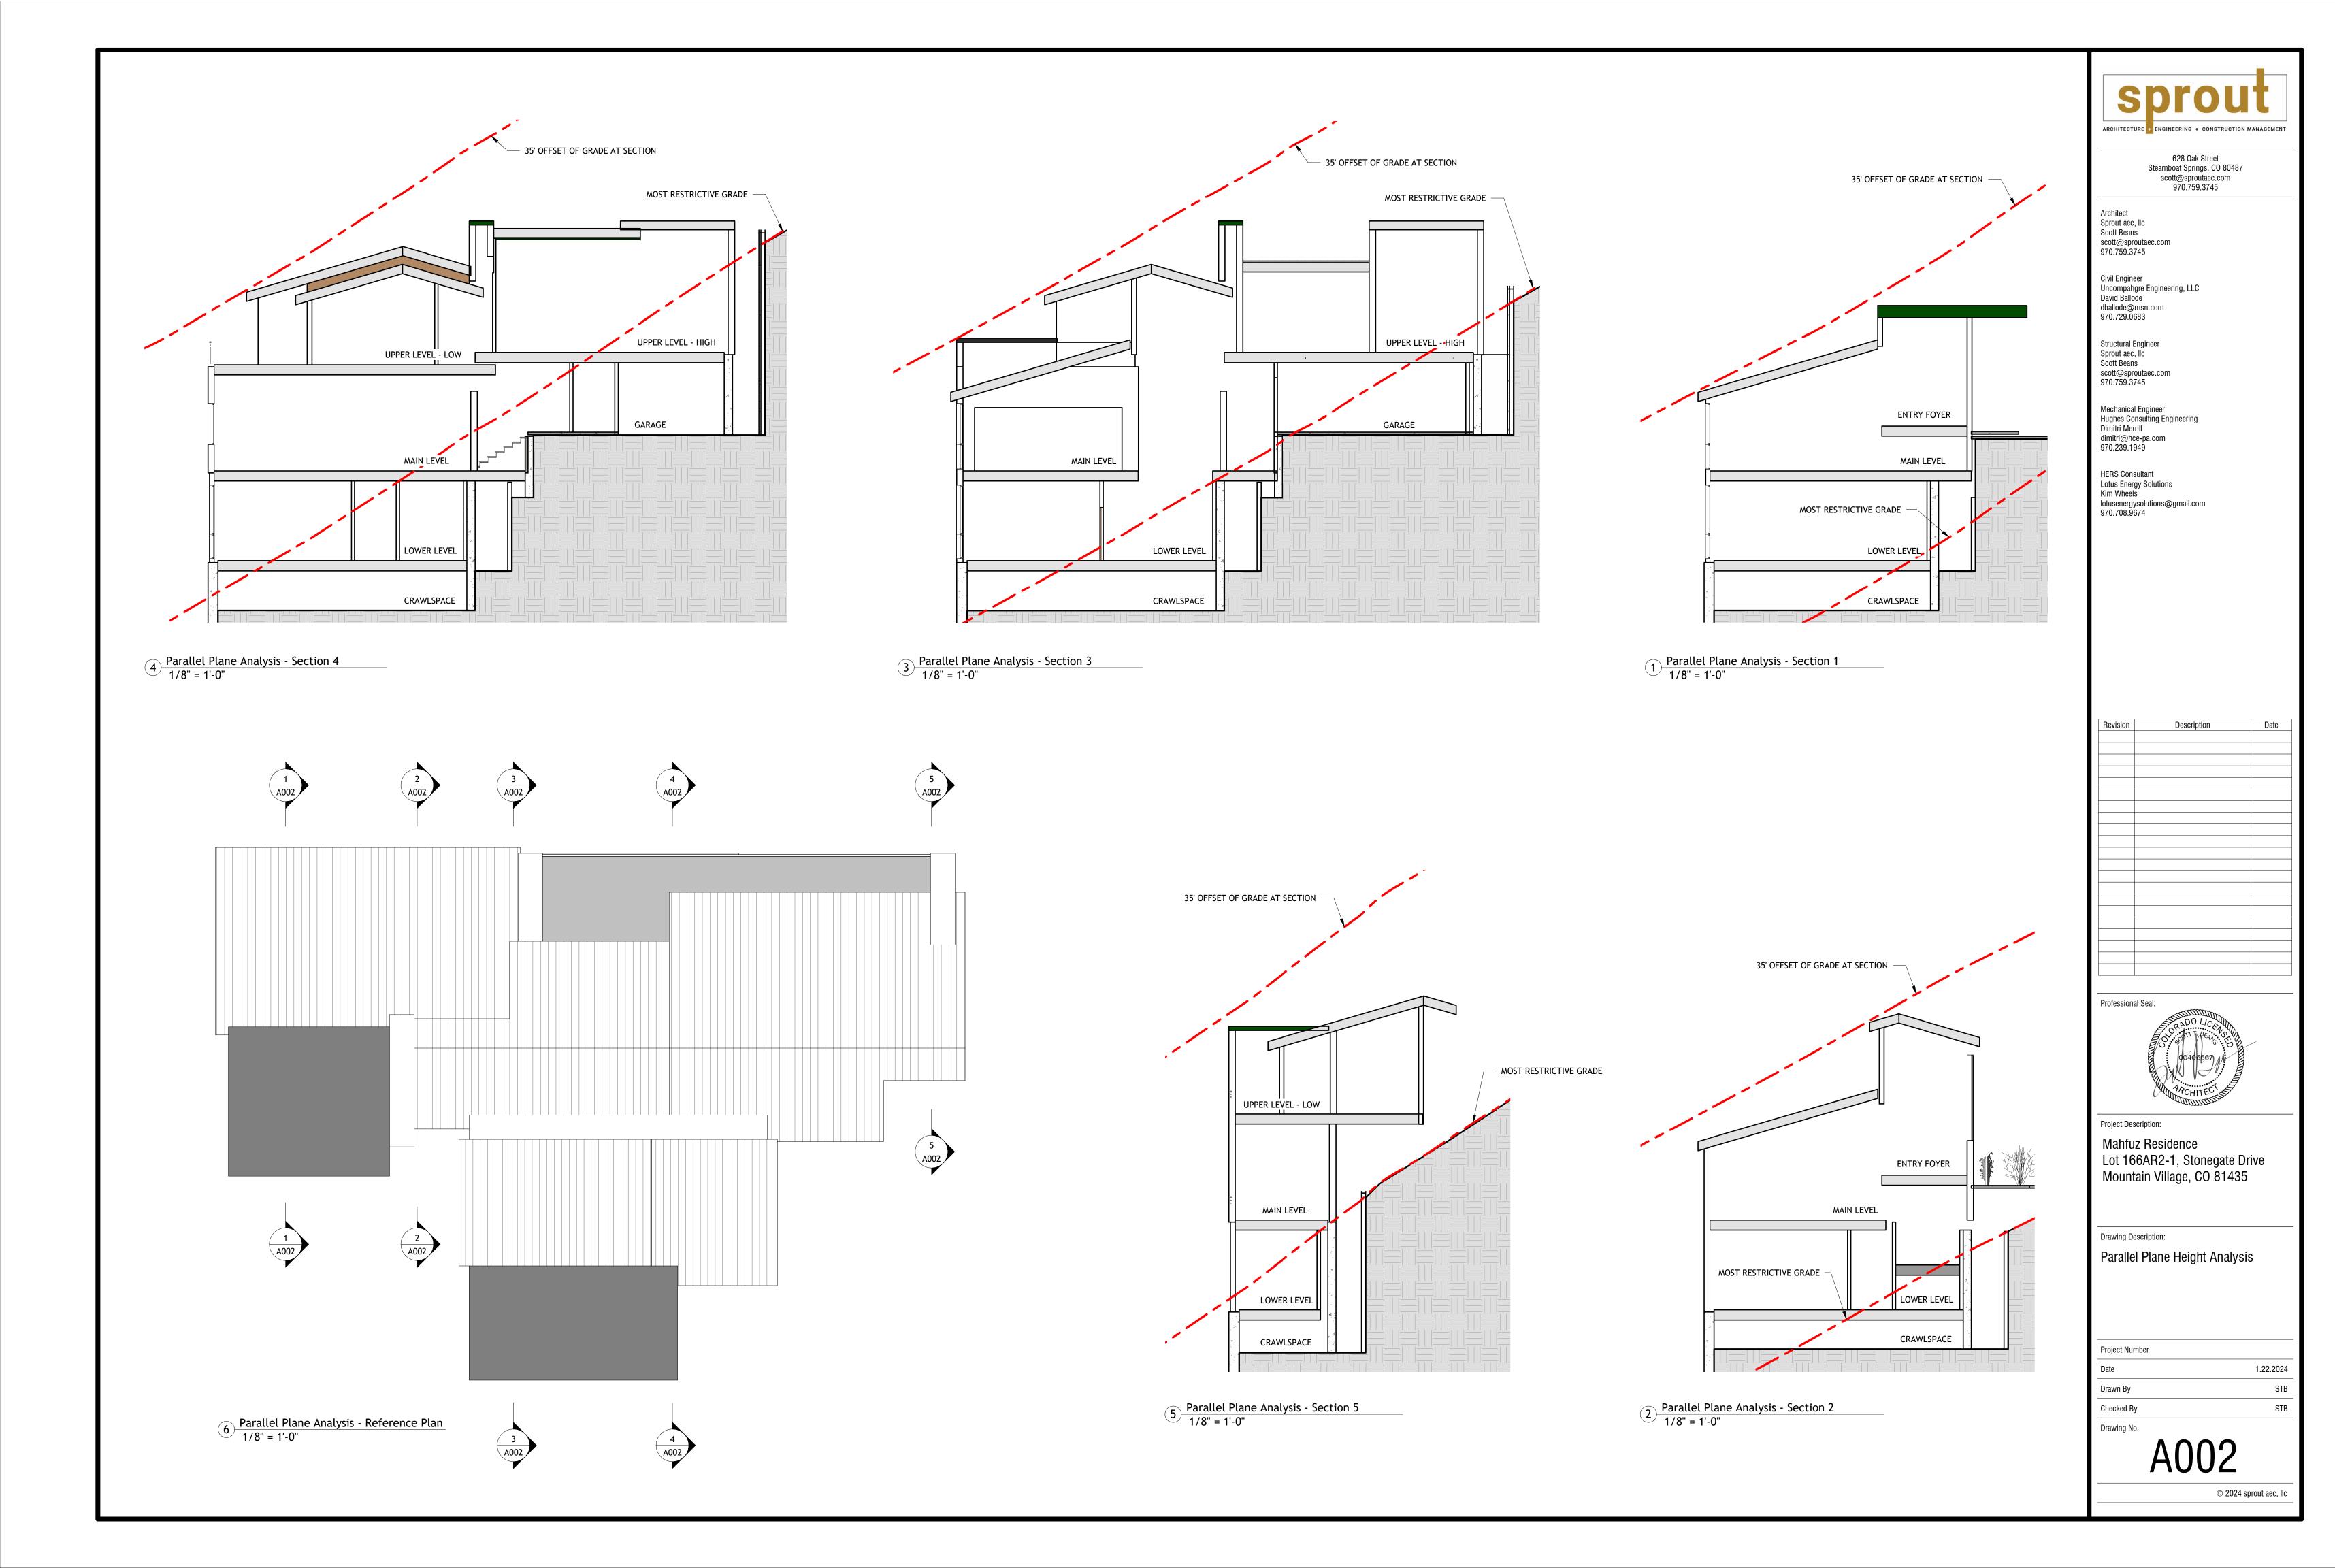

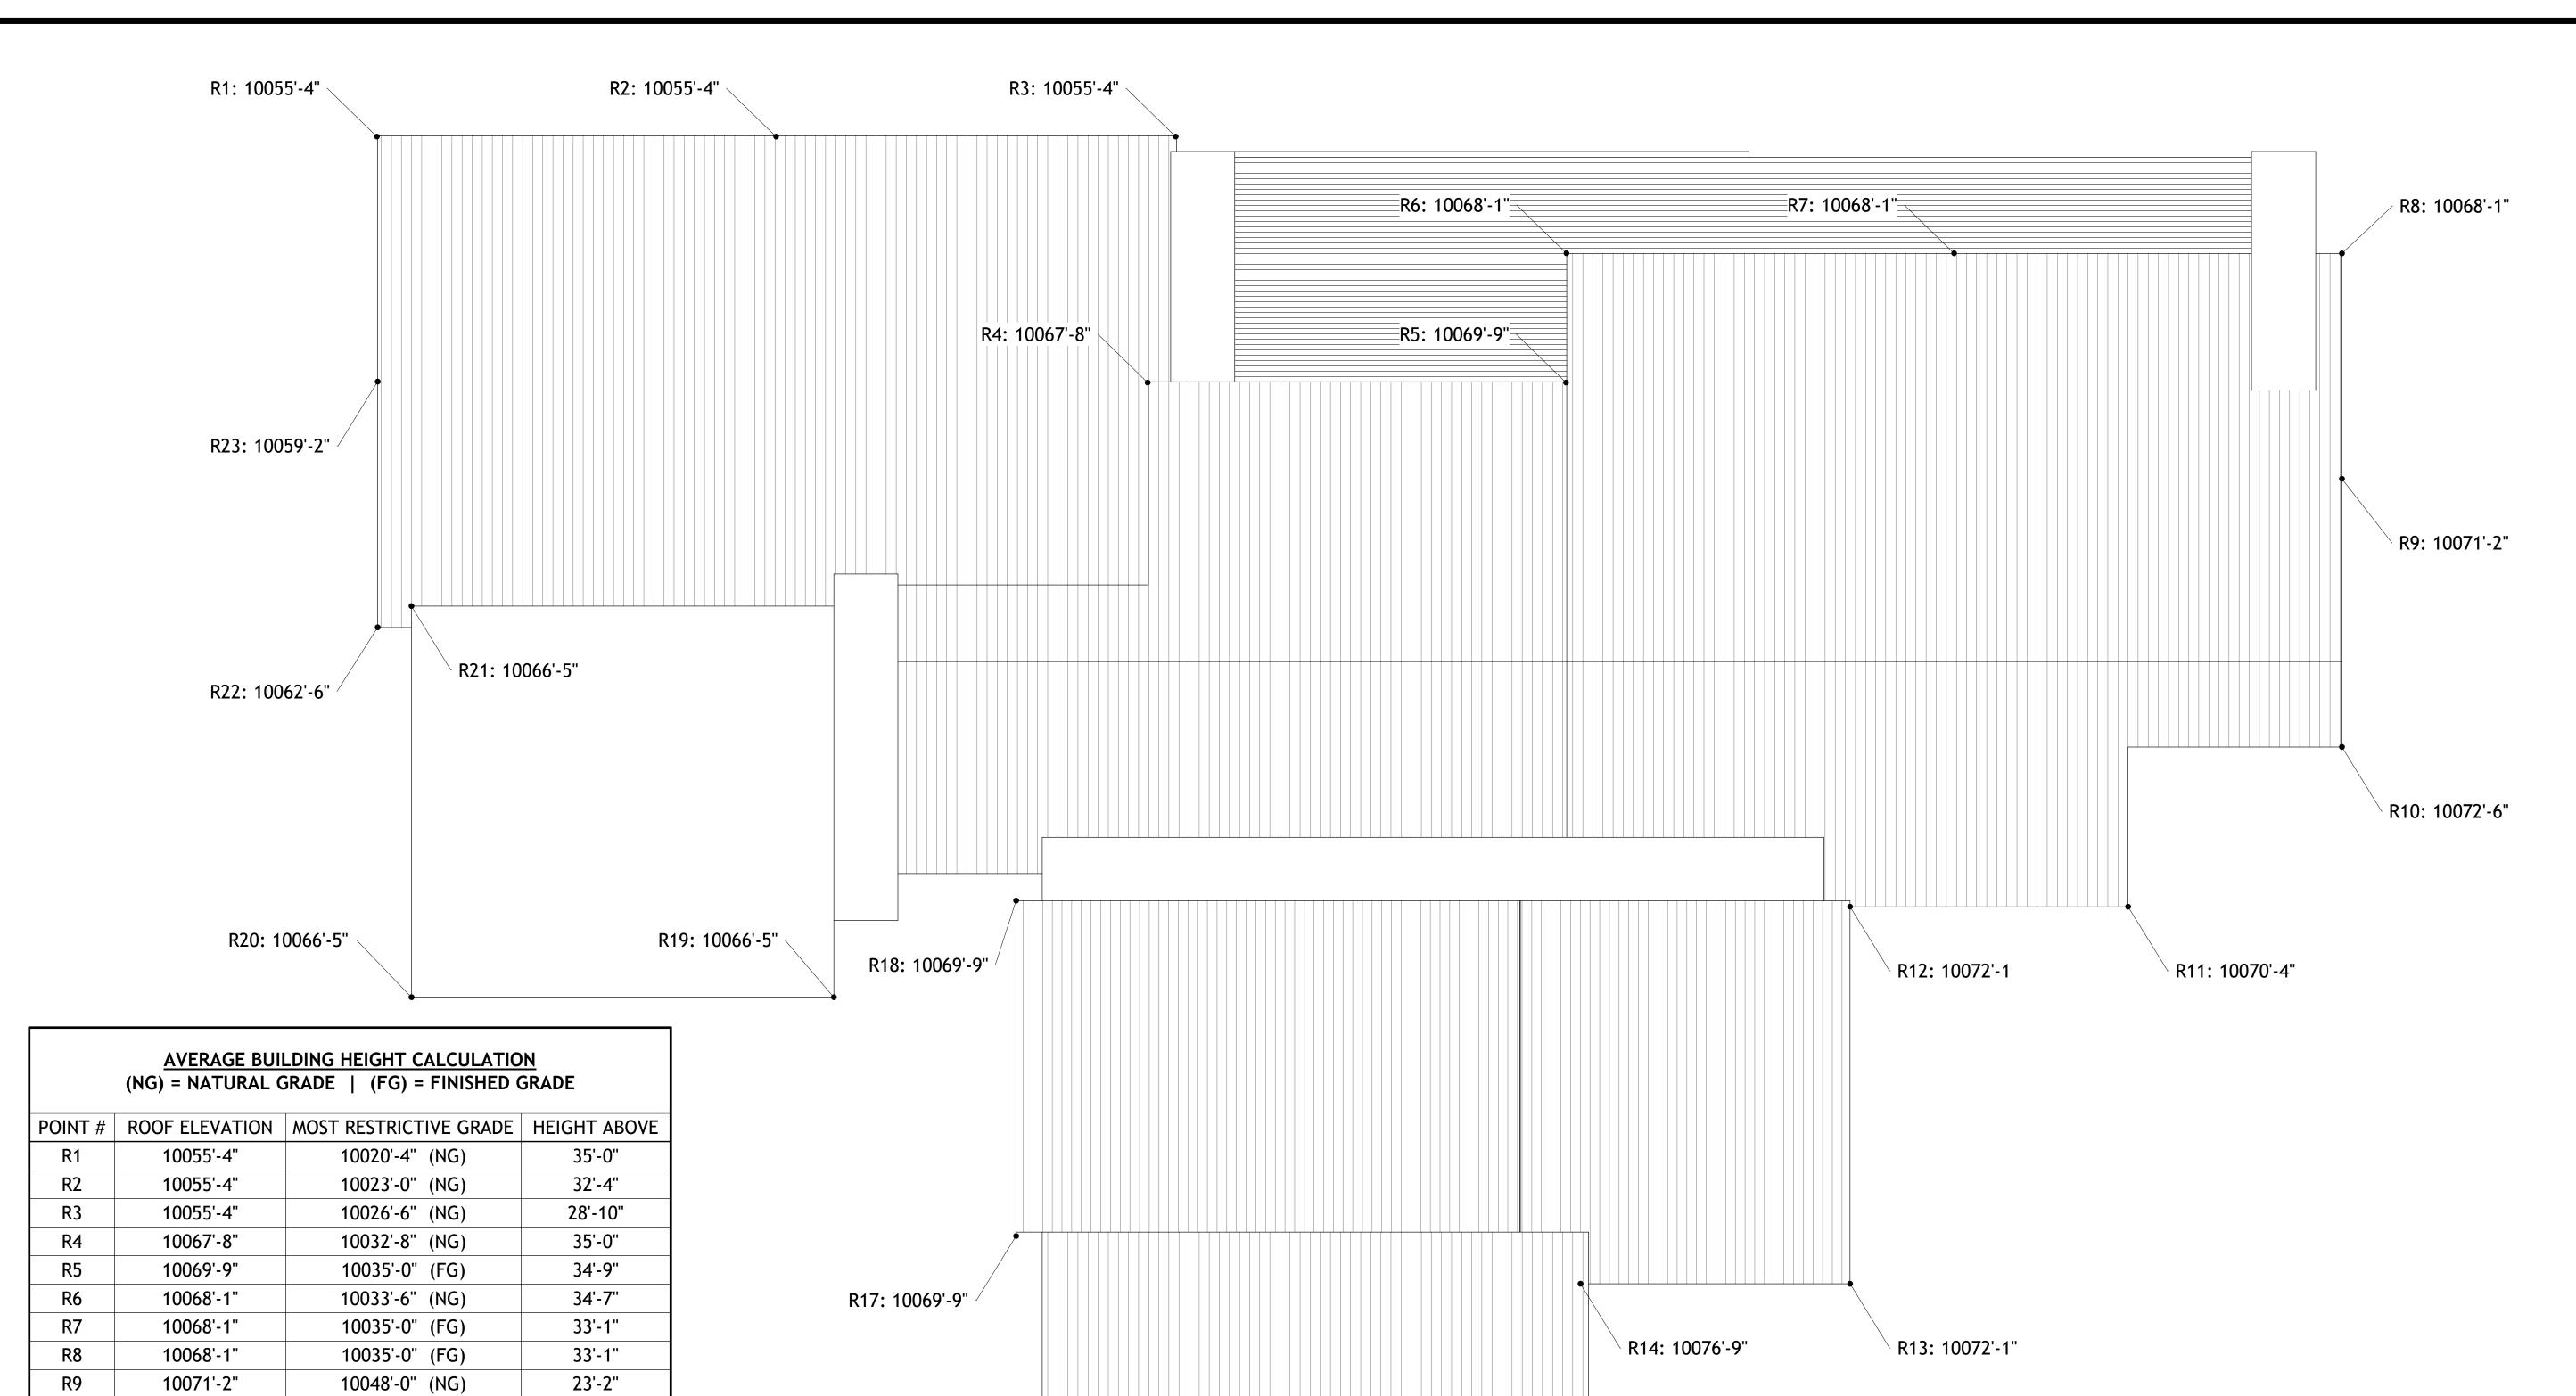

R17: 10069'-9"

R14: 10076'-9"

R15: 10076'-9"

R10

R11

R12

R13

R14

R15

R16

R17

R18

R19

10072'-6"

10070'-4"

10072'-1

10072'-1"

10076'-9"

10076'-9"

10076'-9"

10069'-9"

10069'-9"

10066'-5"

10066'-5"

10066'-5"

10062'-6"

10059'-2"

MAX AVERAGE ALLOWABLE HEIGHT

AVERAGE HEIGHT

COMPLIANT BY

10057'-2" (NG)

10035'-0" (FG)

10046'-0" (FG)

10051'-0" (FG)

10051'-0" (FG)

10051'-0" (FG)

10051'-0" (FG)

10051'-0" (FG)

10044'-8" (NG)

10045'-4" (NG)

10043'-6" (NG)

10031'-5" (NG)

10032'-0" (NG)

10025'-10" (NG)

15'-4"

34'-8"

26'-1"

21'-1"

25'-9"

25'-9"

25'-9"

18'-9"

25'-1"

21'-1"

22'-11"

35'-0"


30'-6"

23'-4"

27'-11"

30'-0"

2'-1"

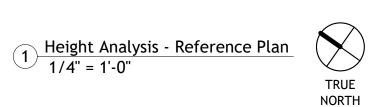

PROJECT NORTH SOFOUT

ARCHITECTURE ENGINEERING + CONSTRUCTION MANAGEMENT

628 Oak Street
Steamboat Springs, CO 80487
scott@sproutaec.com
970.759.3745

Architect Sprout aec, Ilc Scott Beans scott@sproutaec.com 970.759.3745

Civil Engineer Uncompahgre Engineering, LLC David Ballode dballode@msn.com 970.729.0683

Structural Engineer Sprout aec, Ilc Scott Beans scott@sproutaec.com 970.759.3745

Mechanical Engineer Hughes Consulting Engineering Dimitri Merrill dimitri@hce-pa.com 970.239.1949

HERS Consultant Lotus Energy Solutions Kim Wheels lotusenergysolutions@gmail.com 970.708.9674

Revision Description Date

Professional Seal:

RADO LICES

00406667

Project Description:

Mahfuz Residence
Lot 166AR2-1, Stonegate Drive
Mountain Village, CO 81435

Drawing Description:

Average Building Height Calulation

Project Number


Date 1.22.2024

Drawn By STB

Checked By STB


Drawing No.


A003

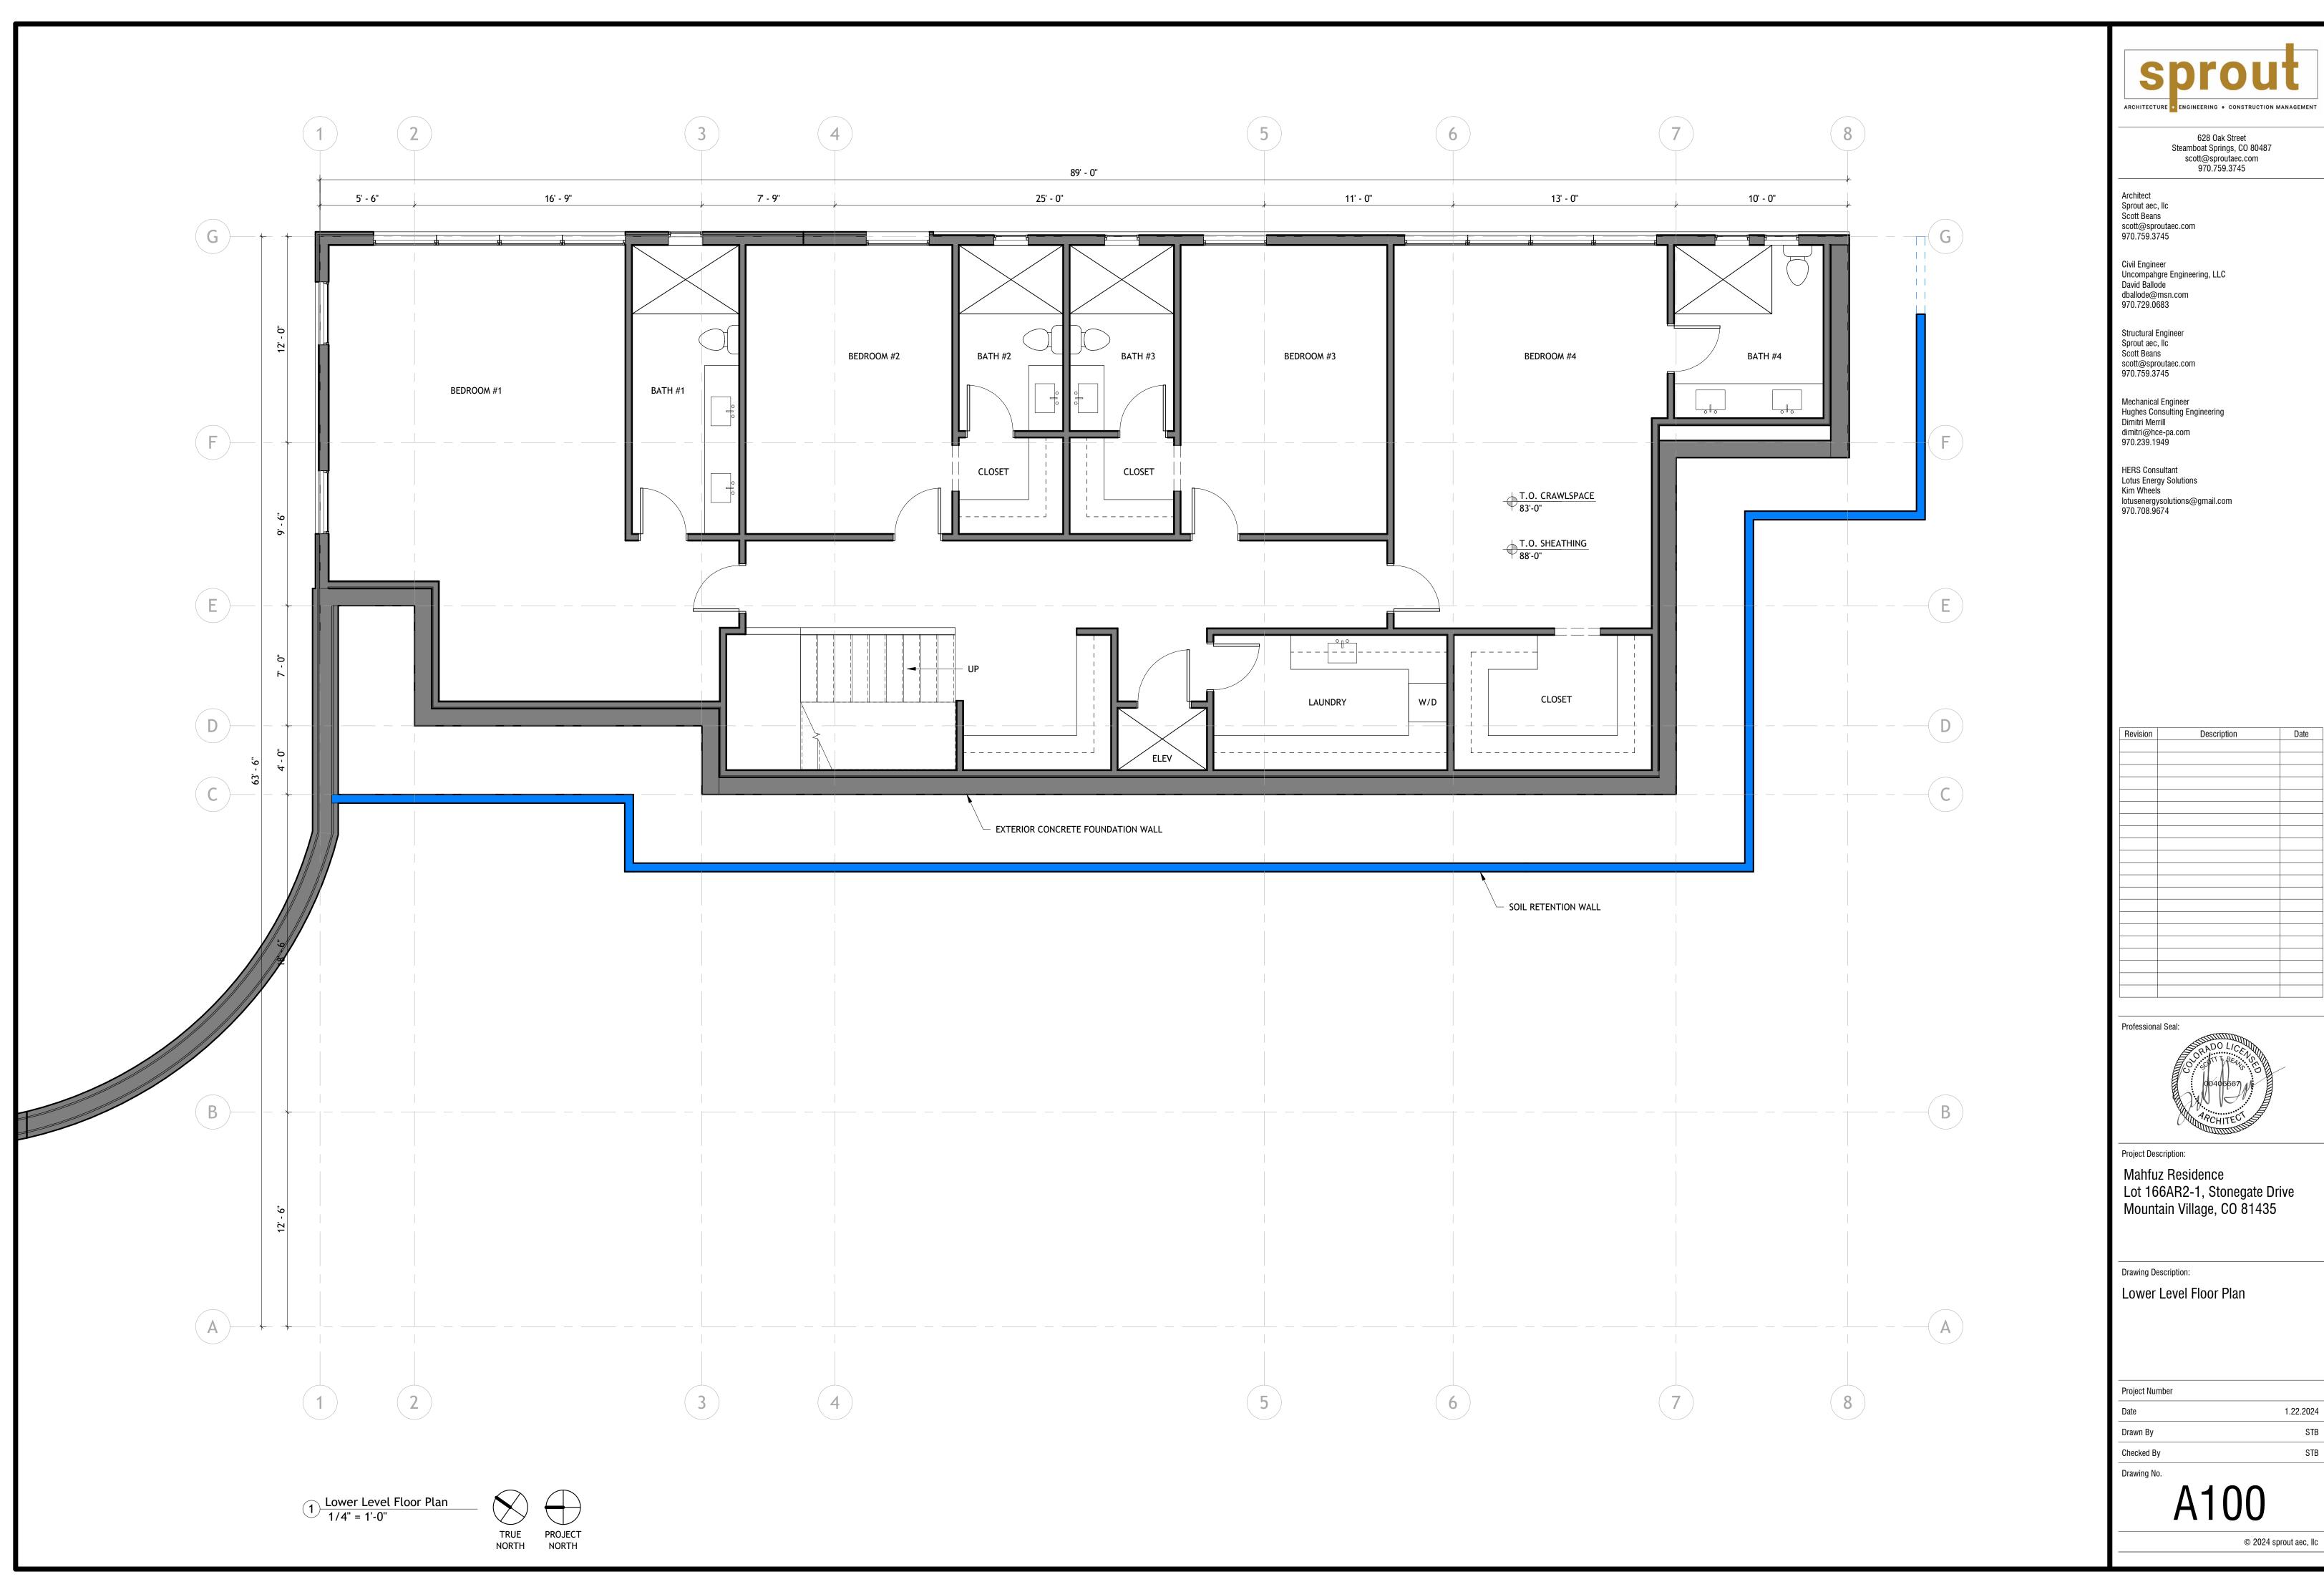





| 1 Tojout Namboi | |
|-----------------|-----------|
| Date | 1.22.2024 |
| Drawn By | STB |
| Checked By | STB |
| Drawing No. | |
| | |

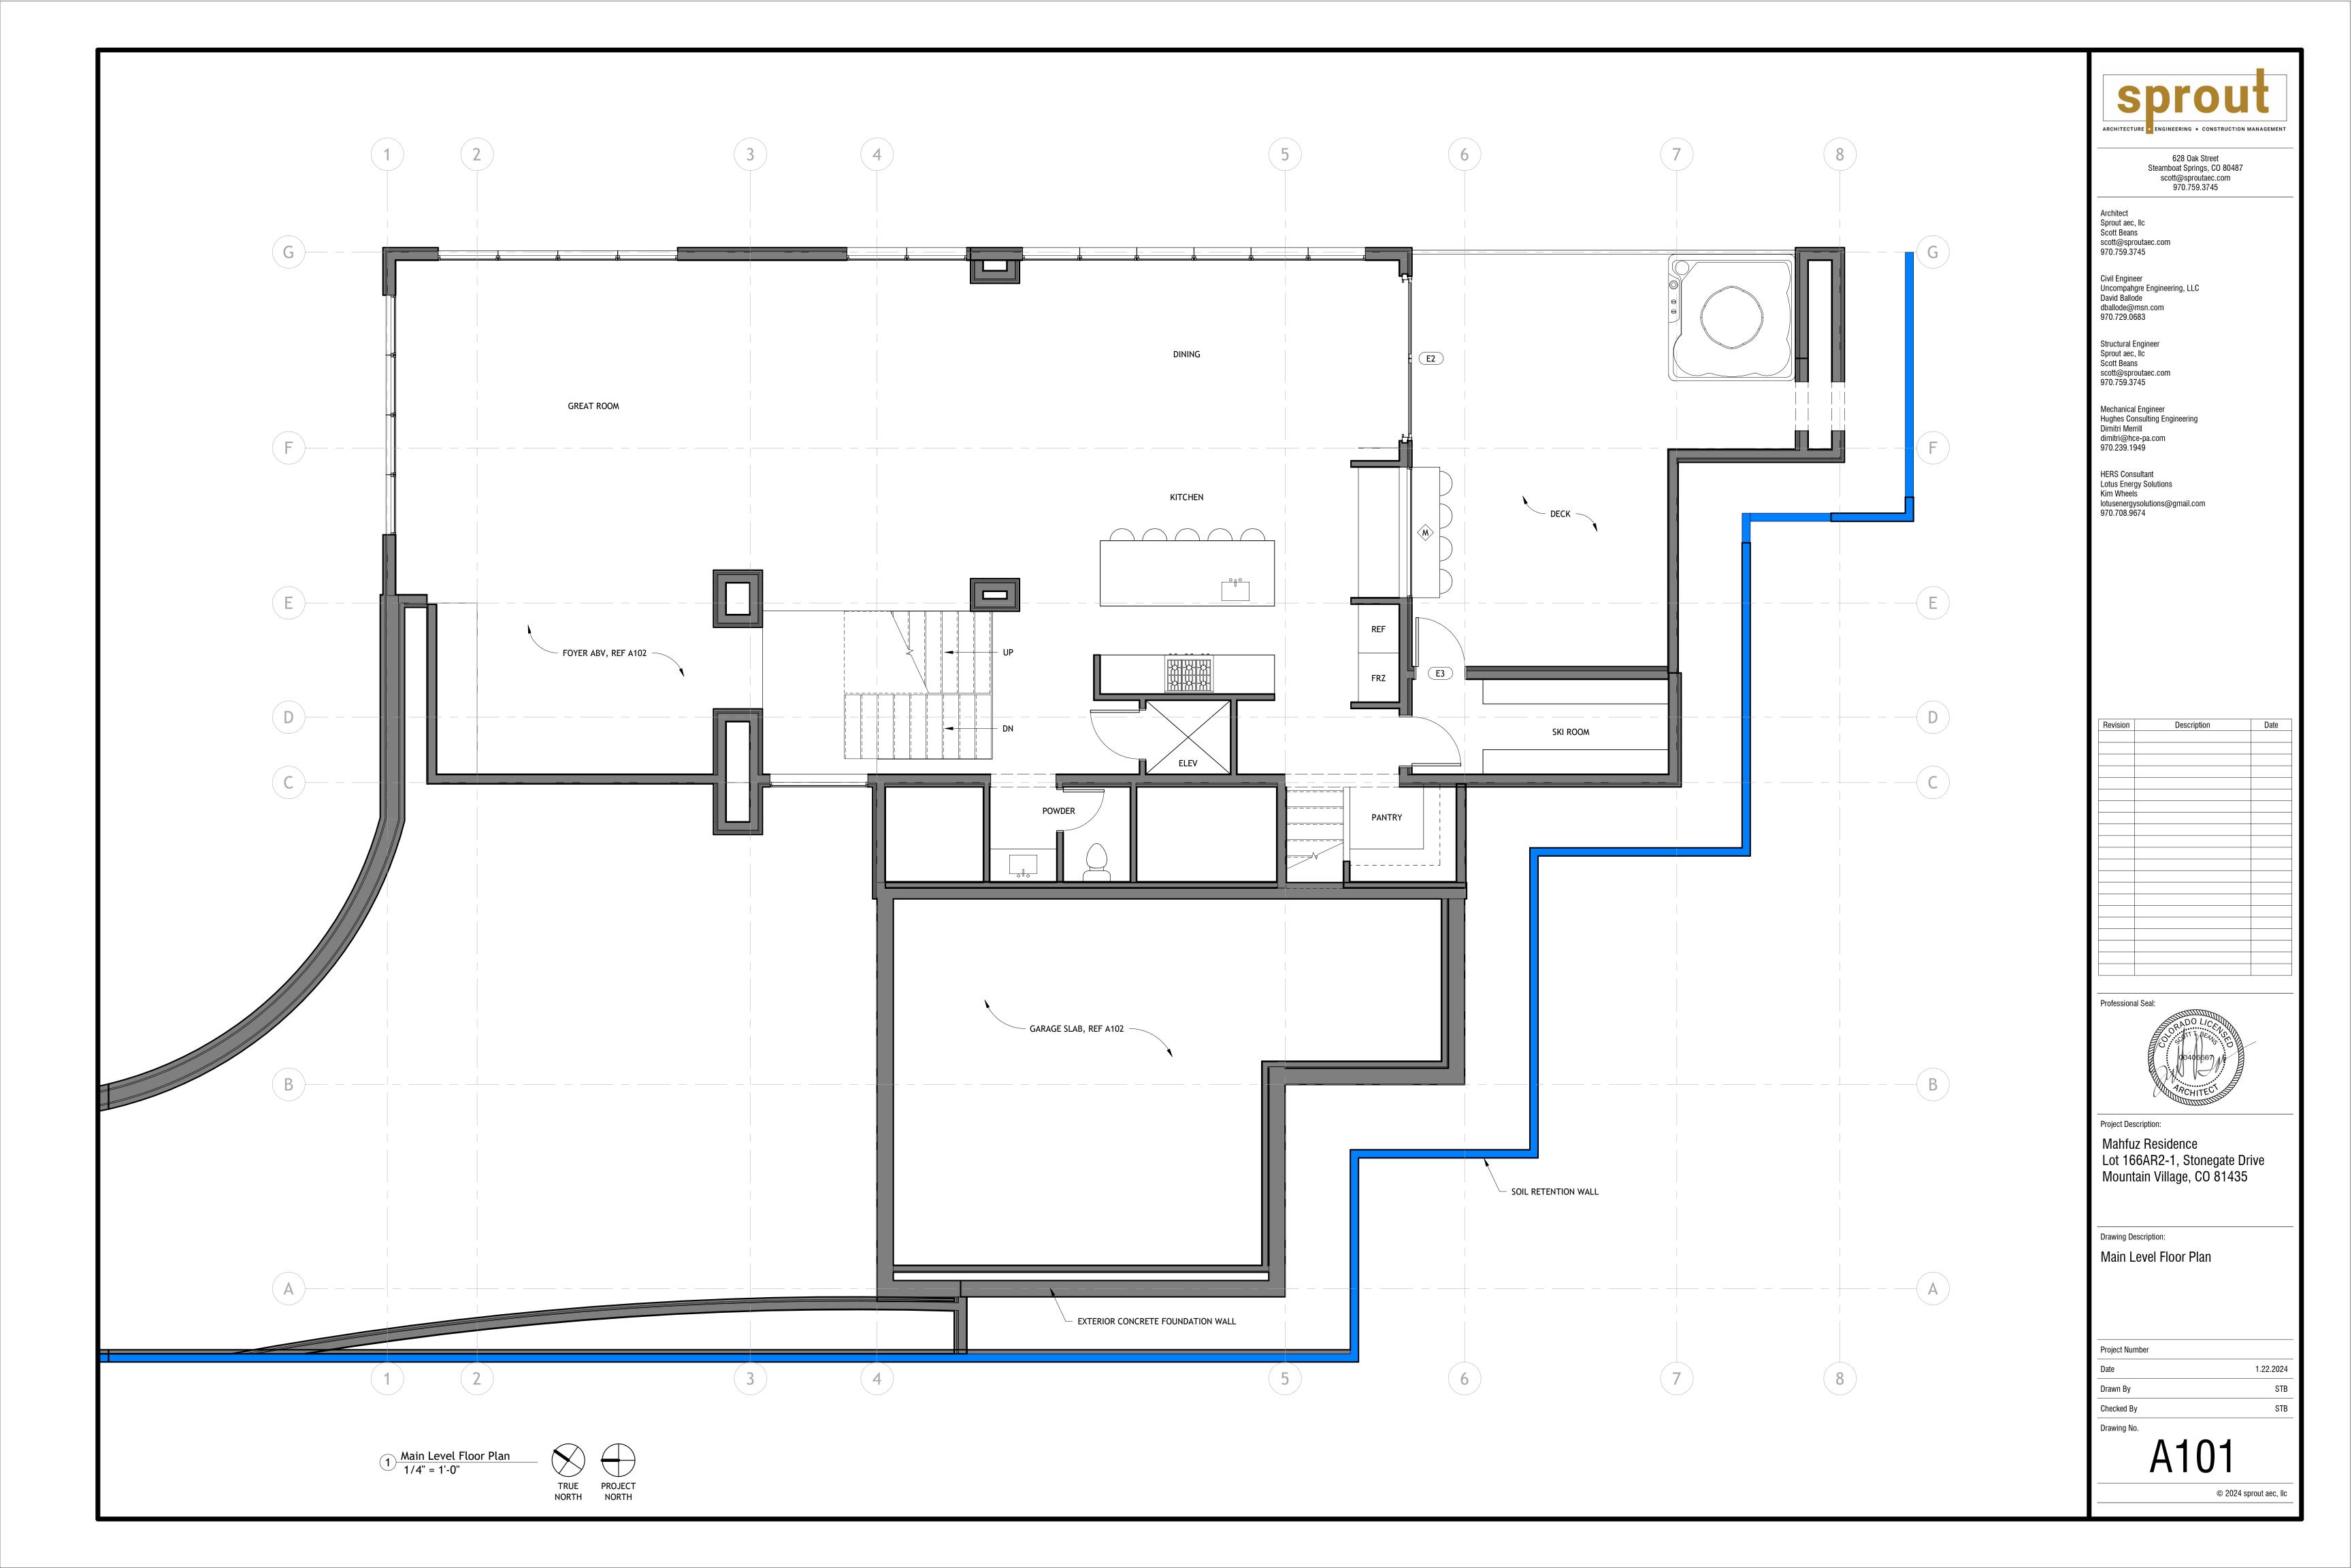

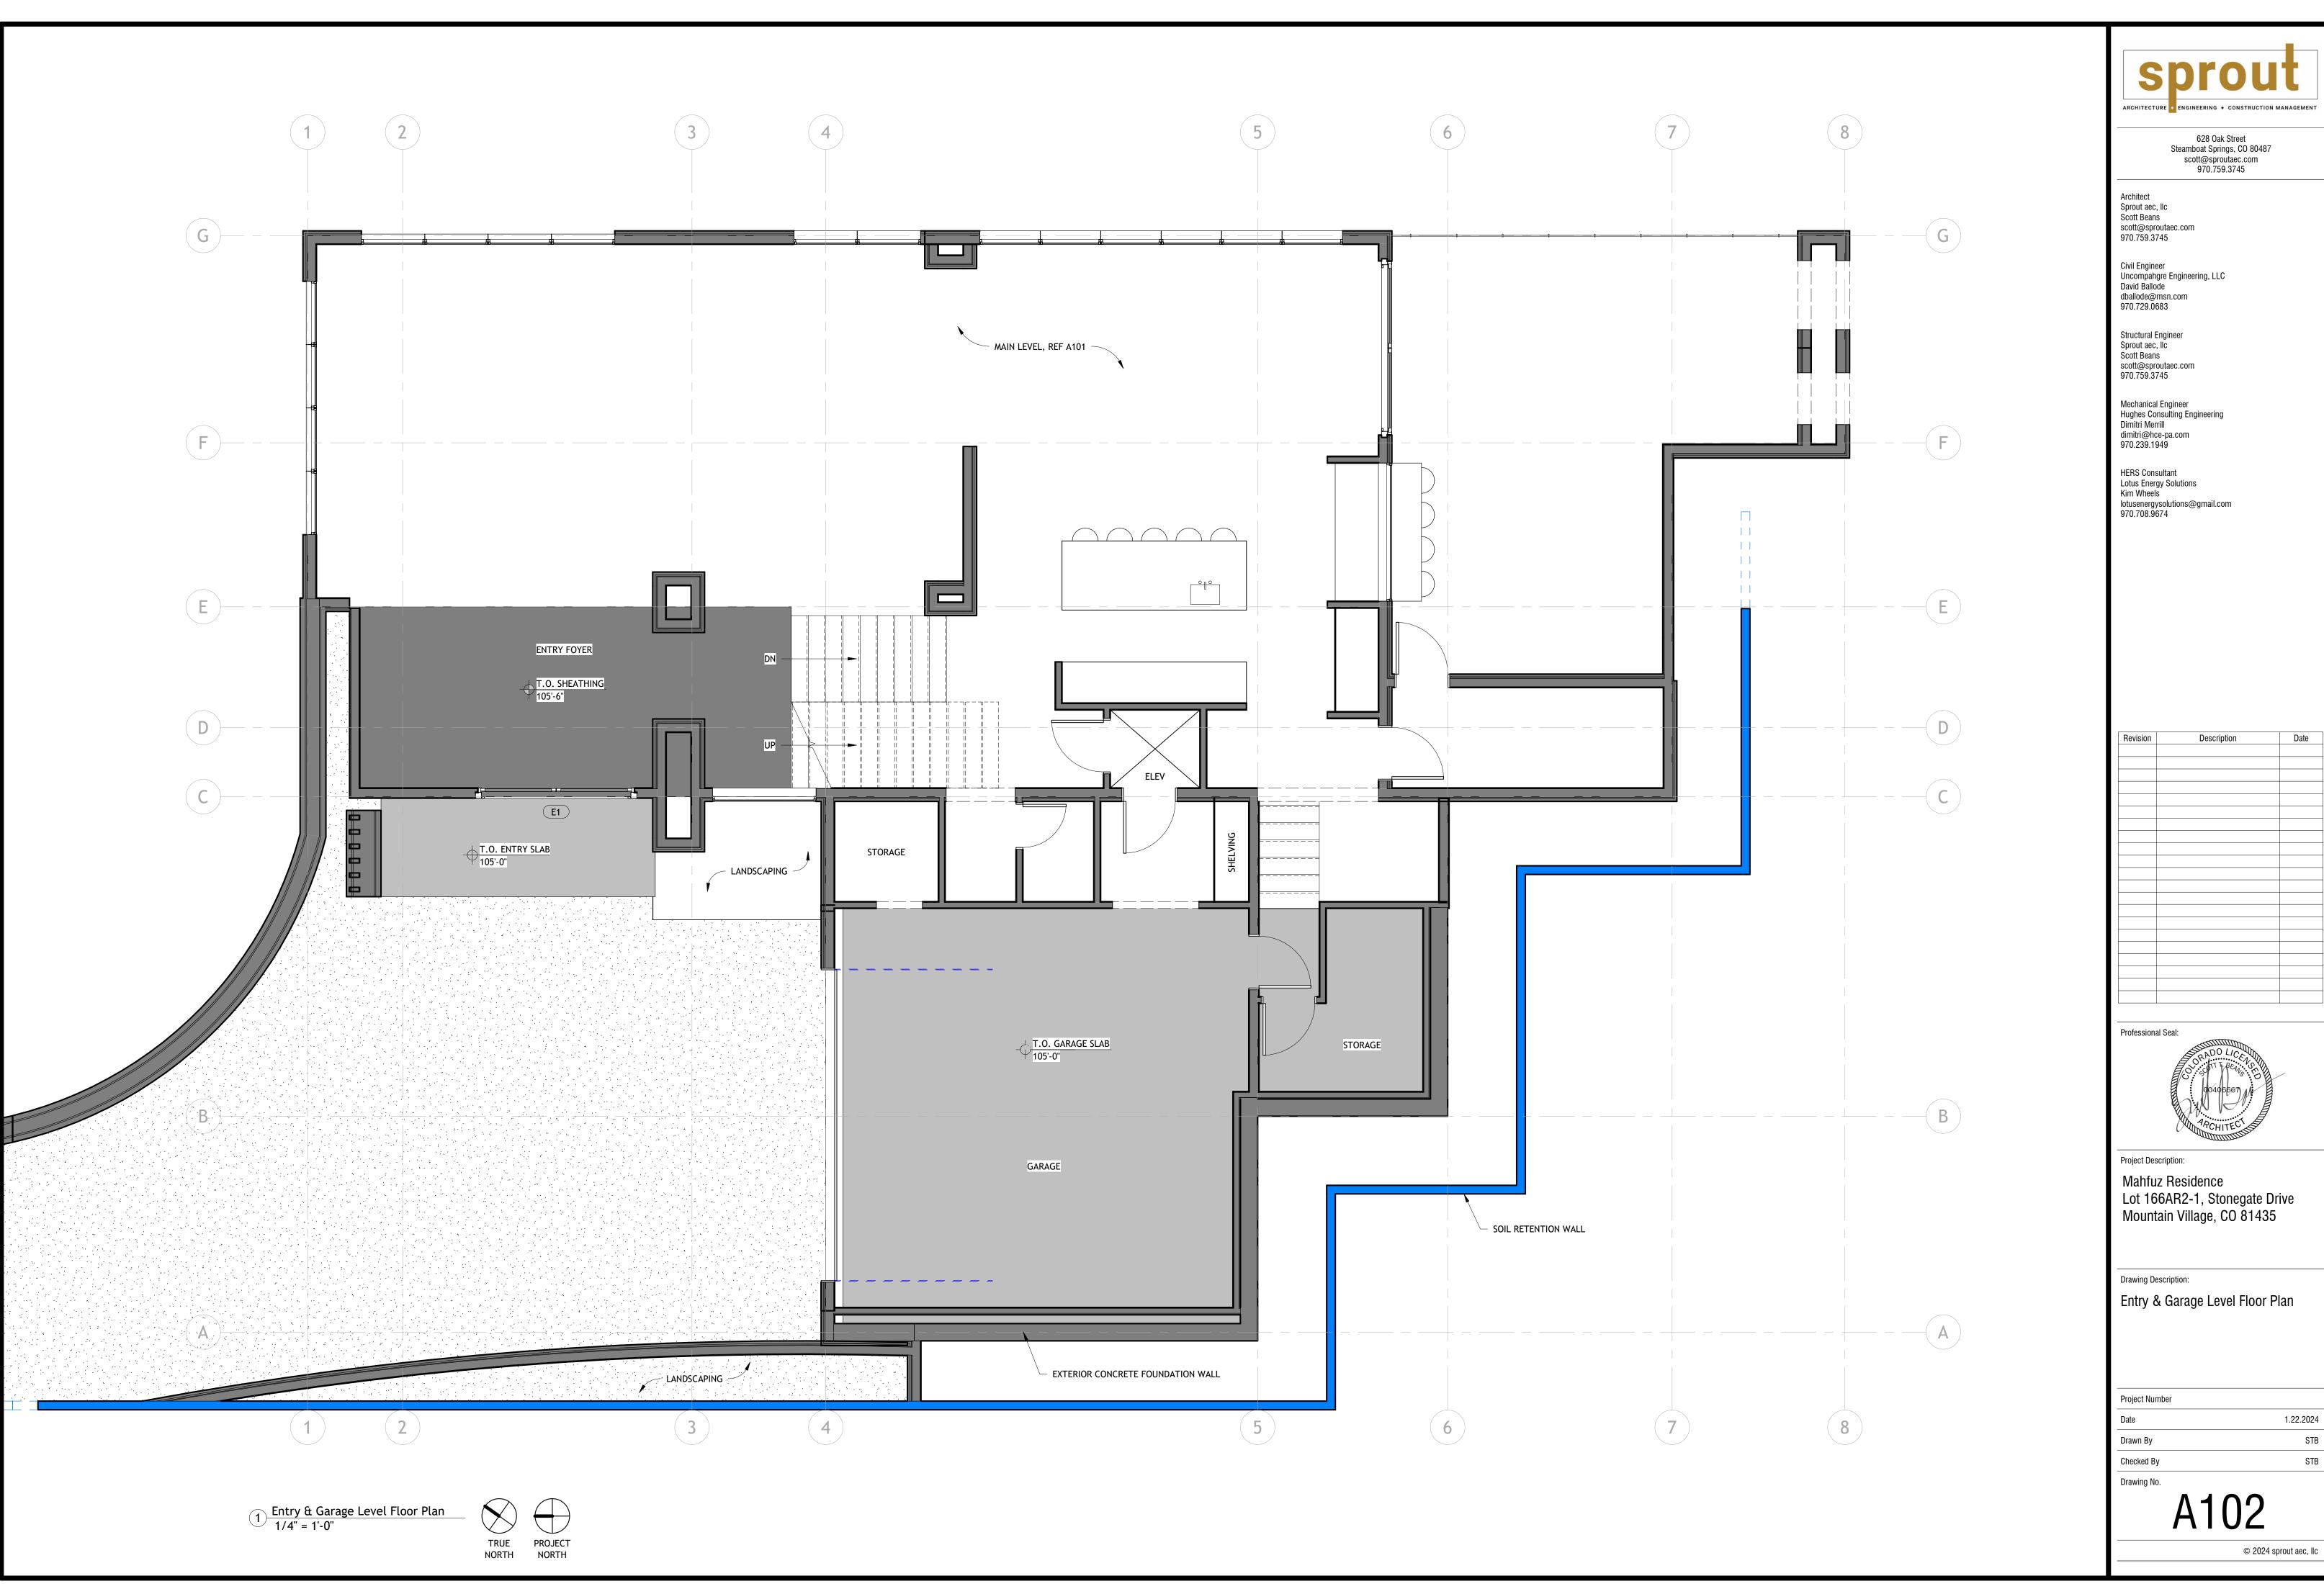

1.22.2024 STB STB

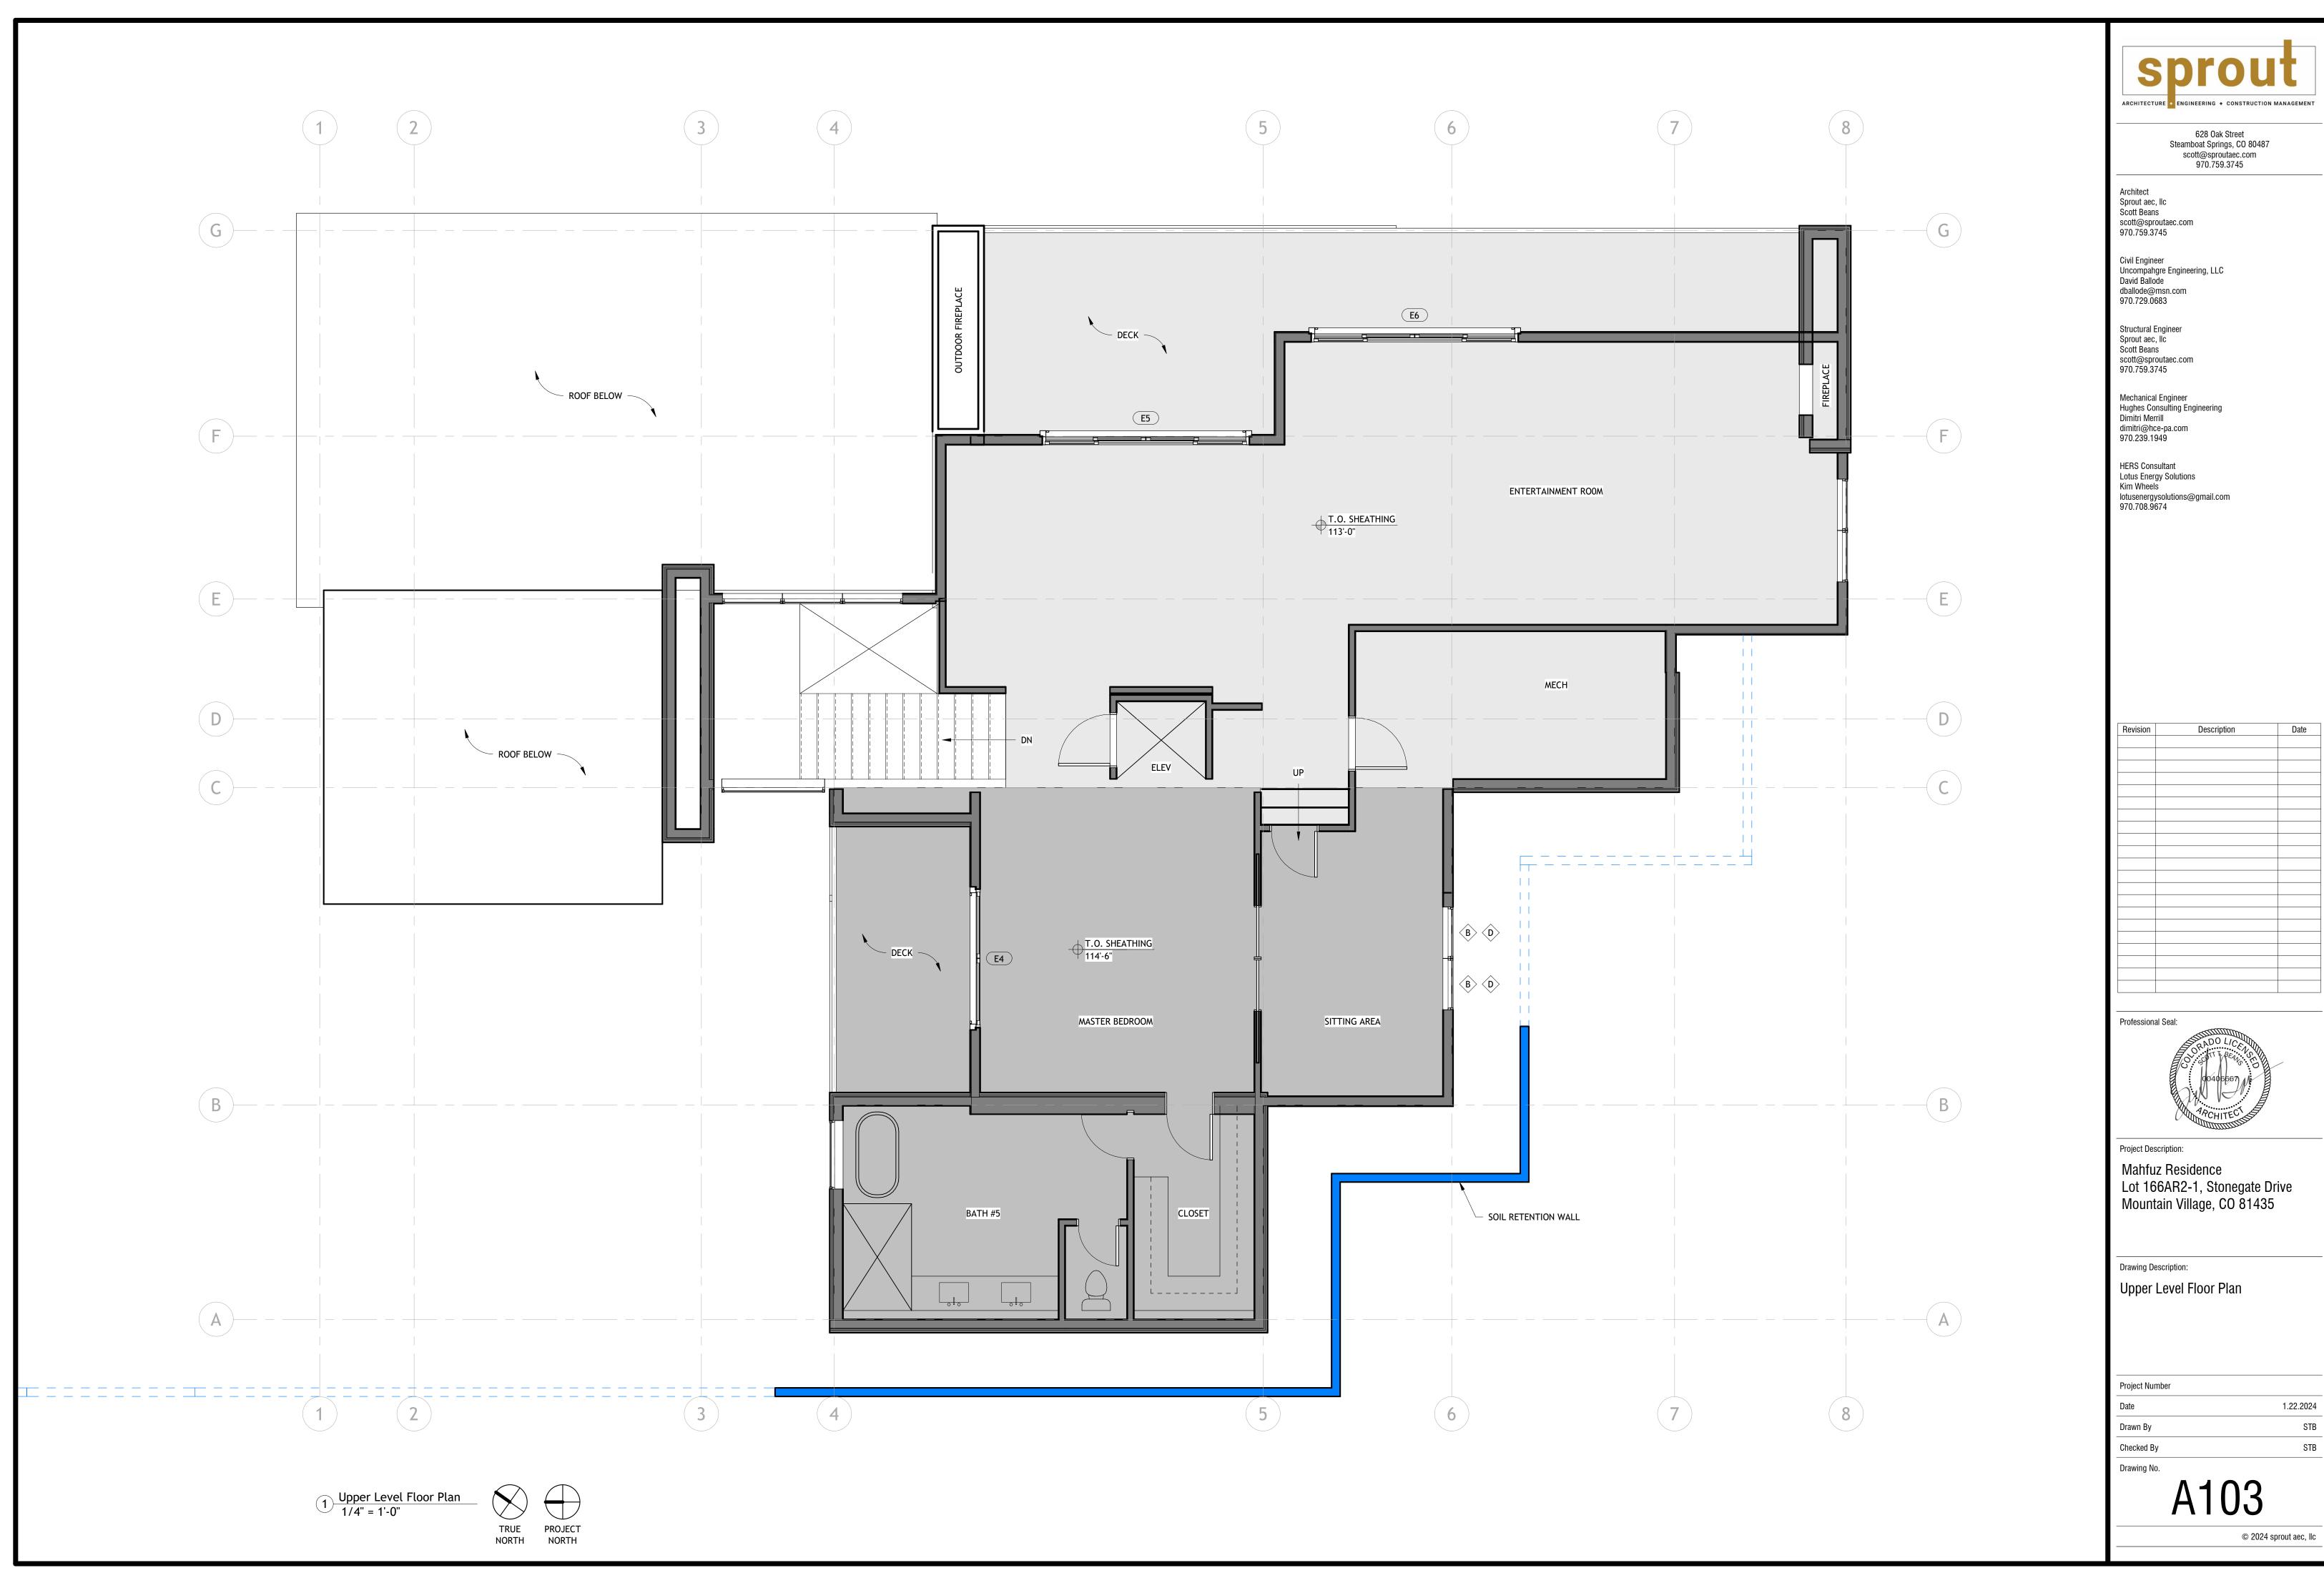

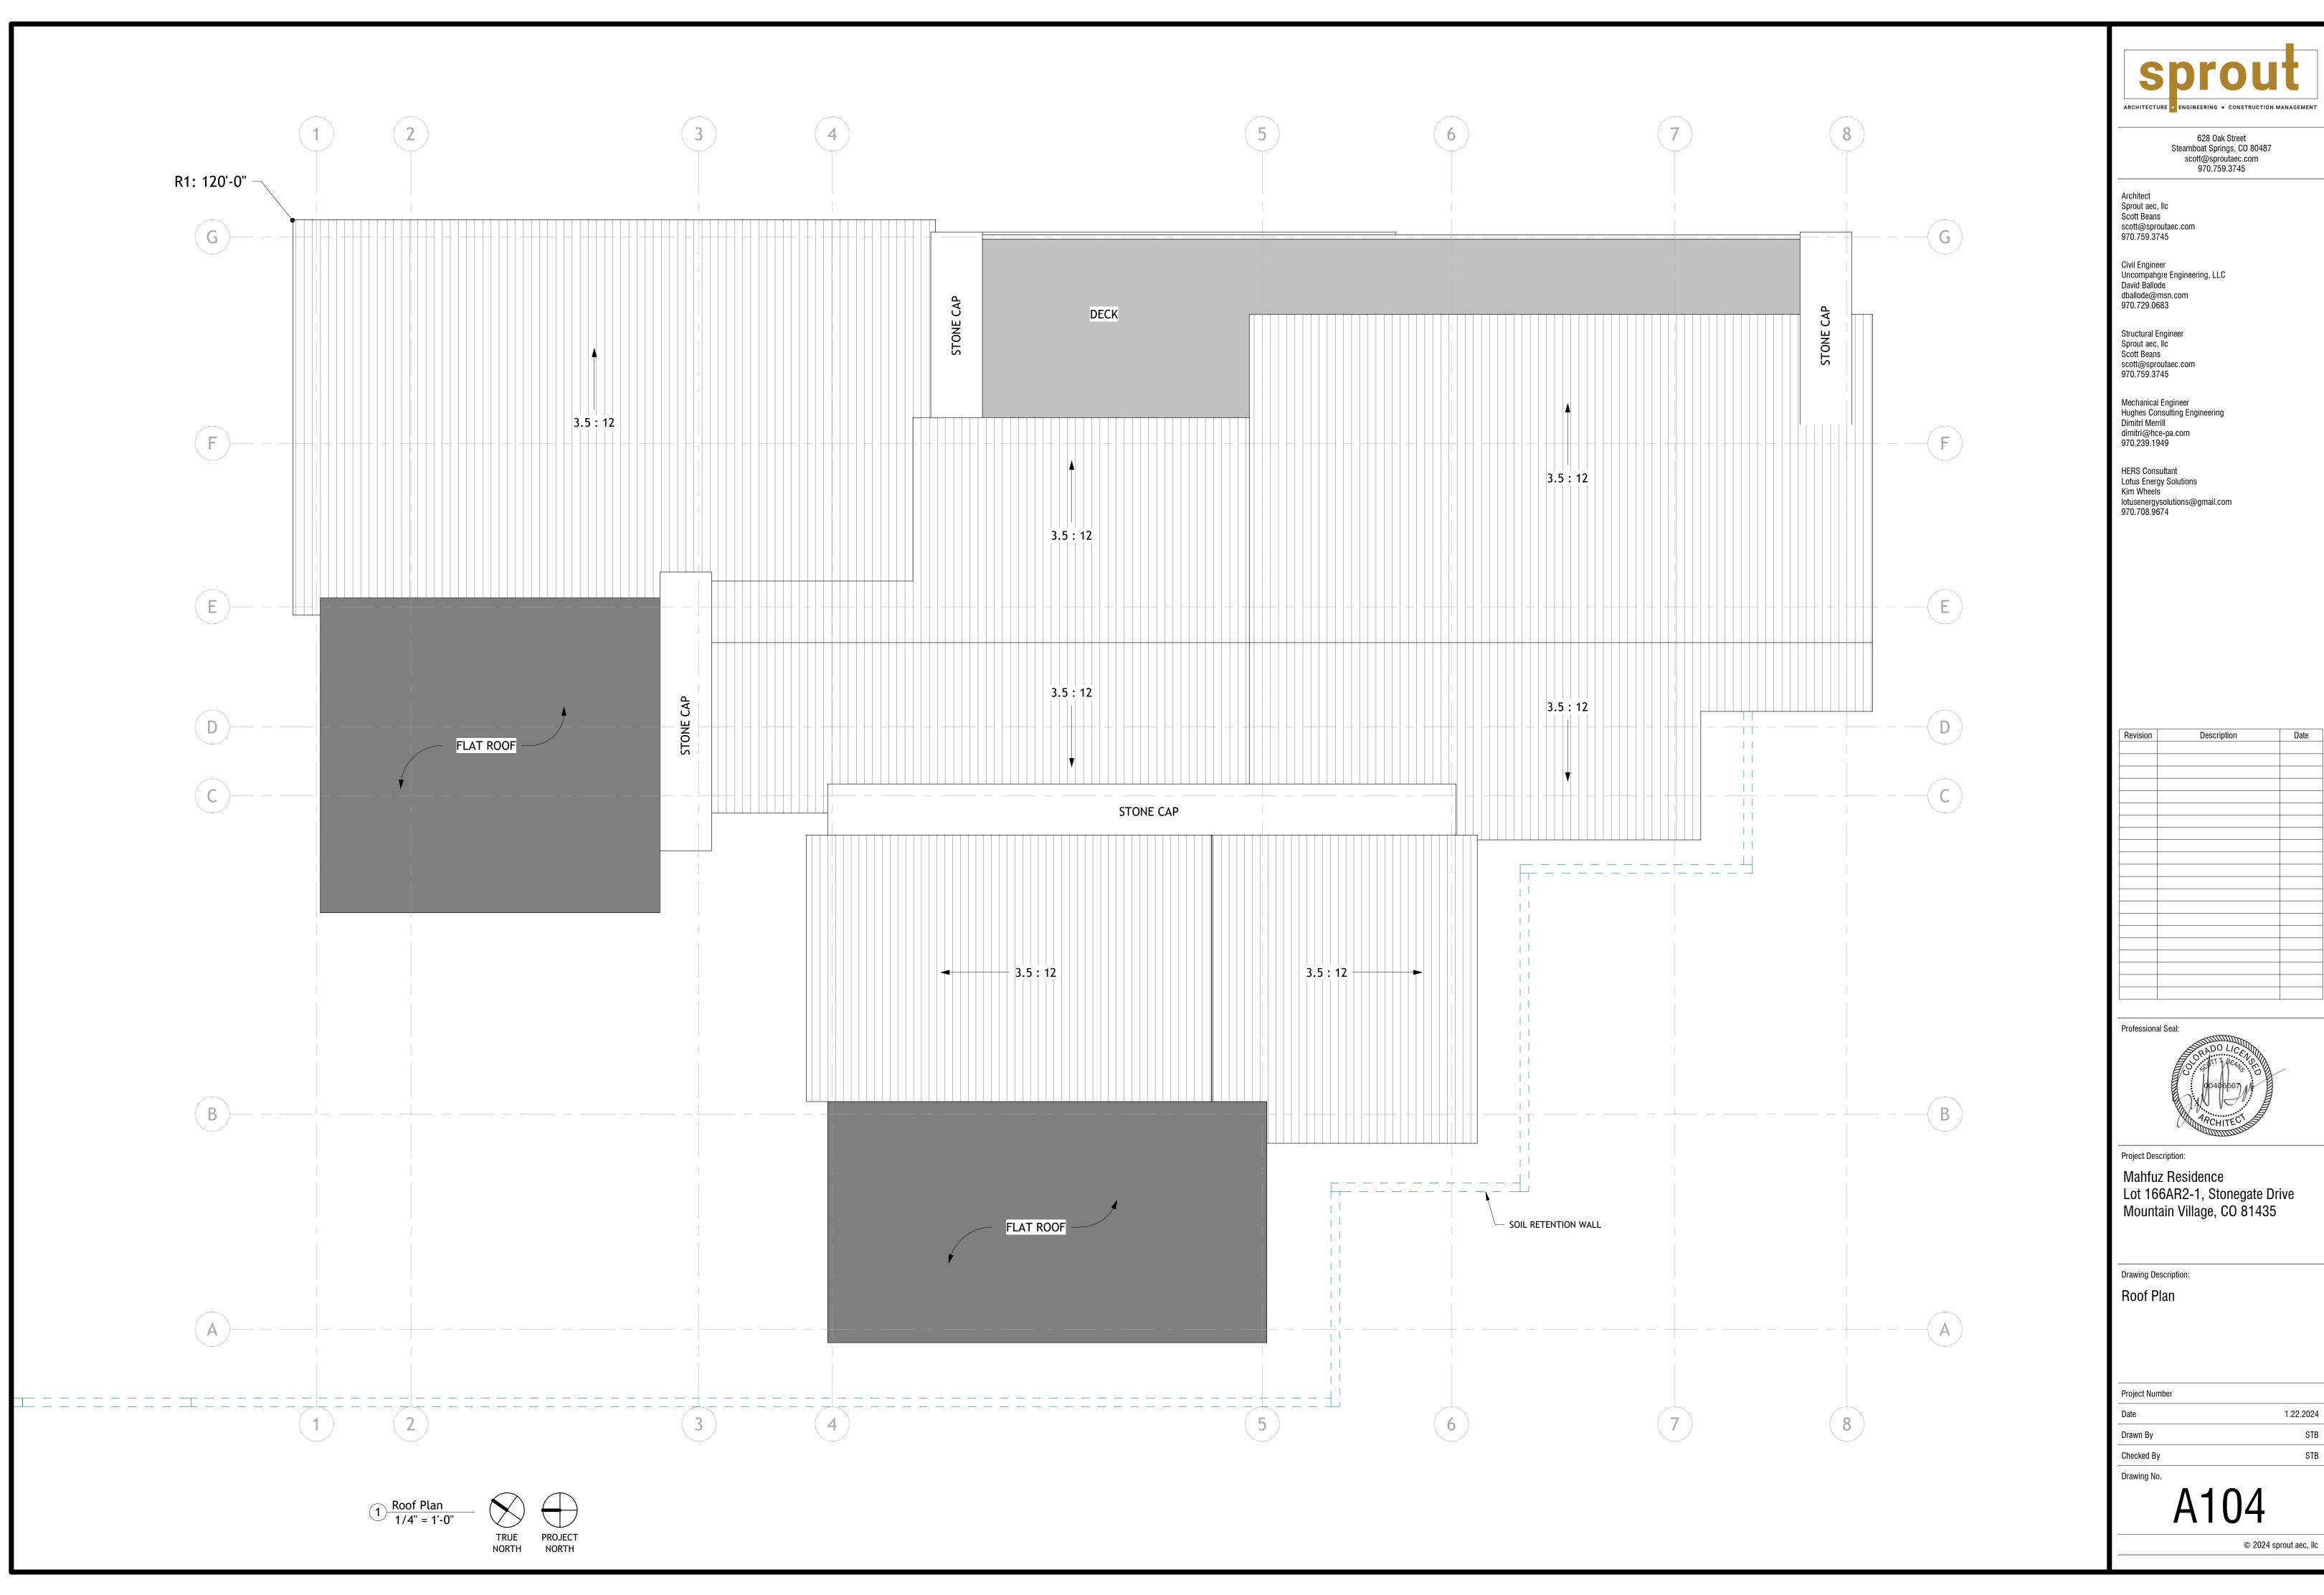




1.22.2024





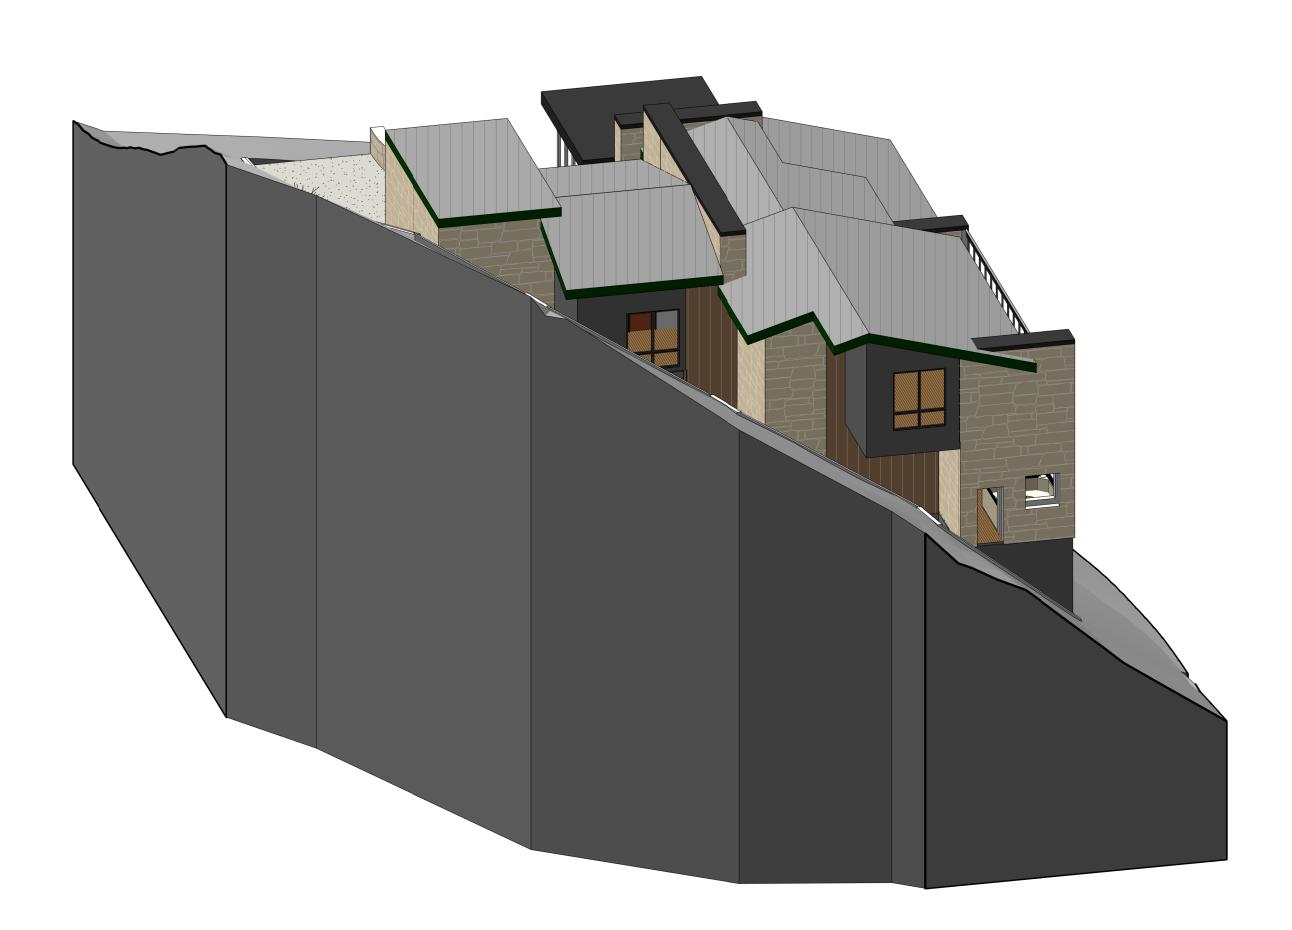

3-D View #4



2 3-D View #2



628 Oak Street Steamboat Springs, CO 80487 scott@sproutaec.com 970.759.3745

Architect Sprout aec, IIc Scott Beans scott@sproutaec.com 970.759.3745

Civil Engineer Uncompahgre Engineering, LLC David Ballode dballode@msn.com 970.729.0683

Structural Engineer Sprout aec, Ilc Scott Beans scott@sproutaec.com 970.759.3745

Mechanical Engineer Hughes Consulting Engineering Dimitri Merrill dimitri@hce-pa.com 970.239.1949

HERS Consultant Lotus Energy Solutions Kim Wheels lotusenergysolutions@gmail.com 970.708.9674

| Revision | Description | Date |
|----------|-------------|------|
| | | |
| | | |
Professional Seal:

Project Description:

Mahfuz Residence

Lot 166AR2-1, Stonegate Drive


Mountain Village, CO 81435


Drawing Description:

Exterior 3-D Views

| Project Number | |
|----------------|----------|
| Date | 1.22.202 |
| Drawn By | ST |
| Checked By | ST |
| Drawing No. | |
| | |

A200

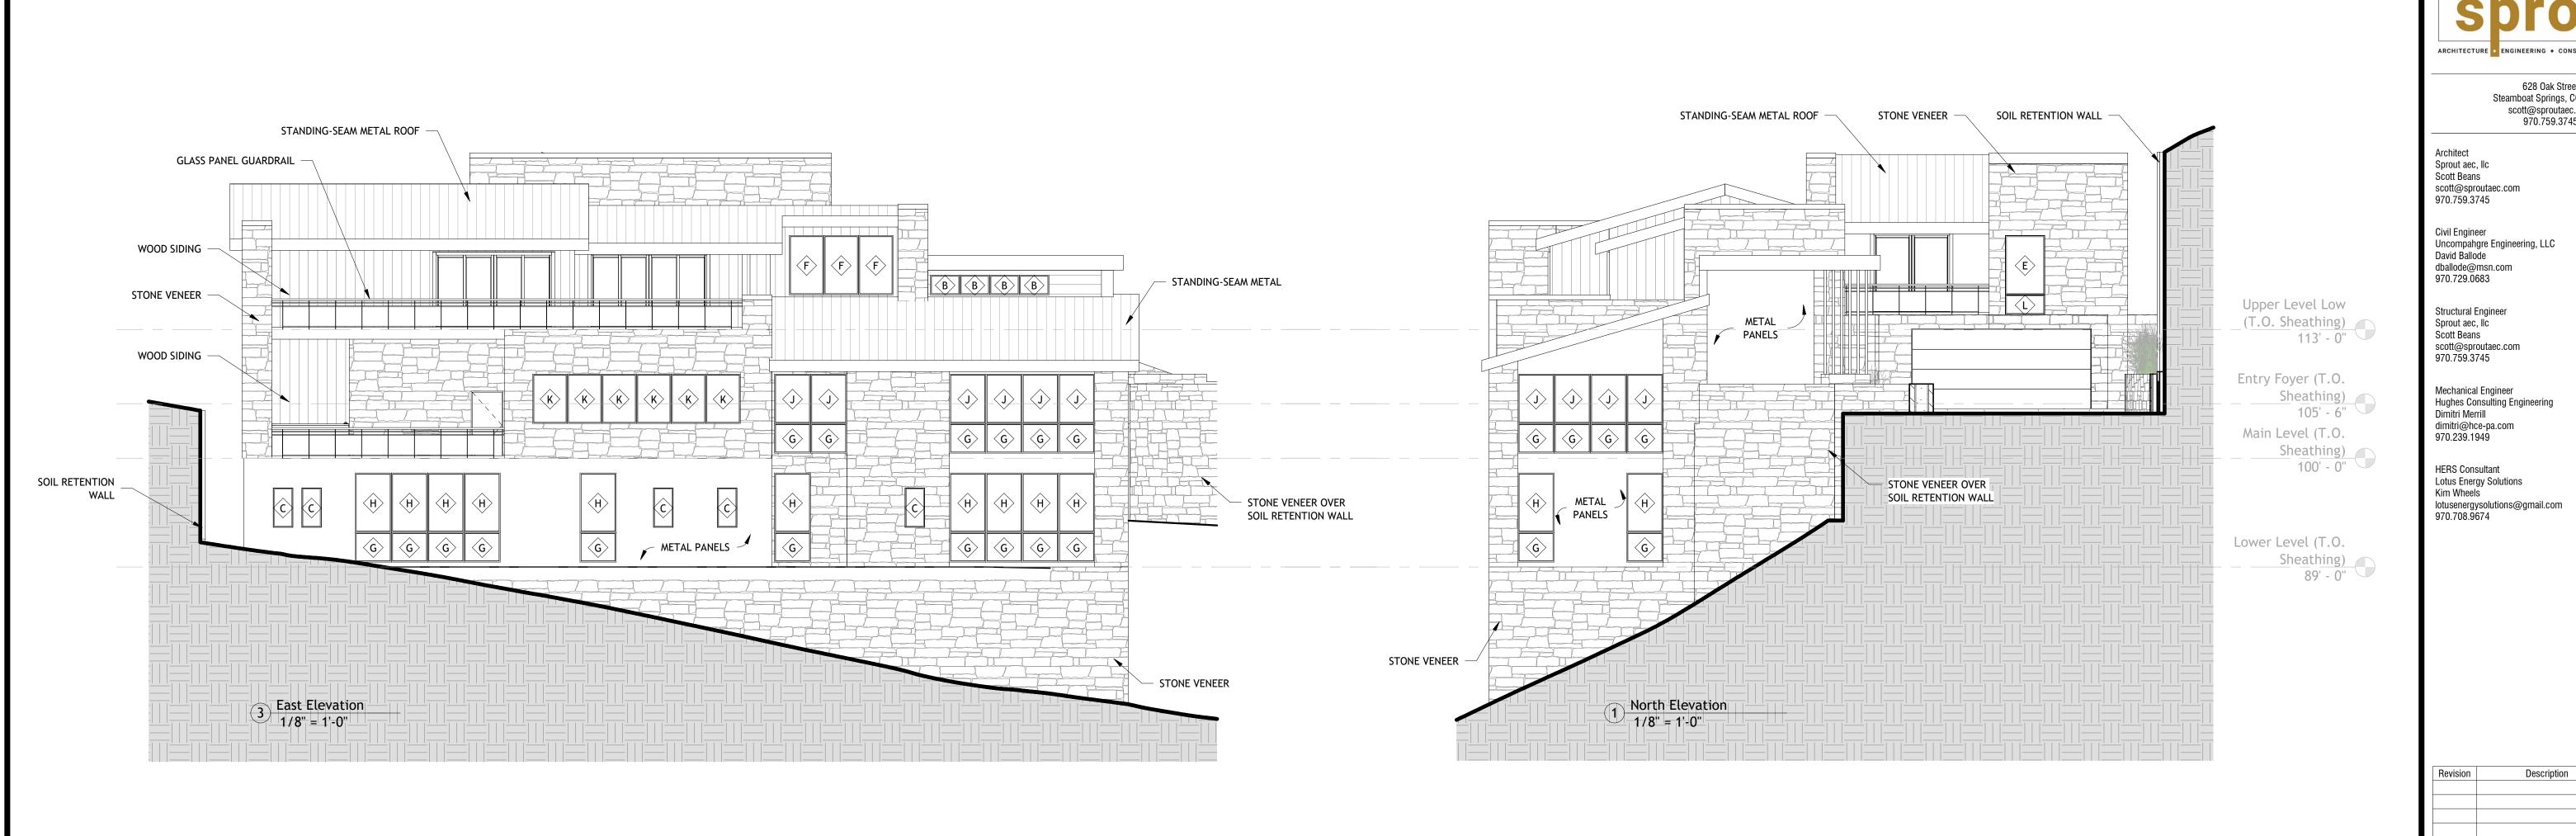

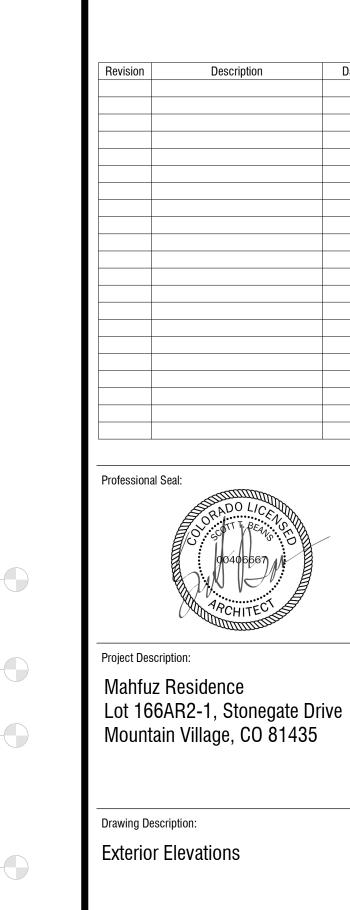

Project Number

Drawn By

Checked By

Drawing No.

Date


1.22.2024

© 2024 sprout aec, llc

STB


STB

628 Oak Street Steamboat Springs, CO 80487 scott@sproutaec.com 970.759.3745

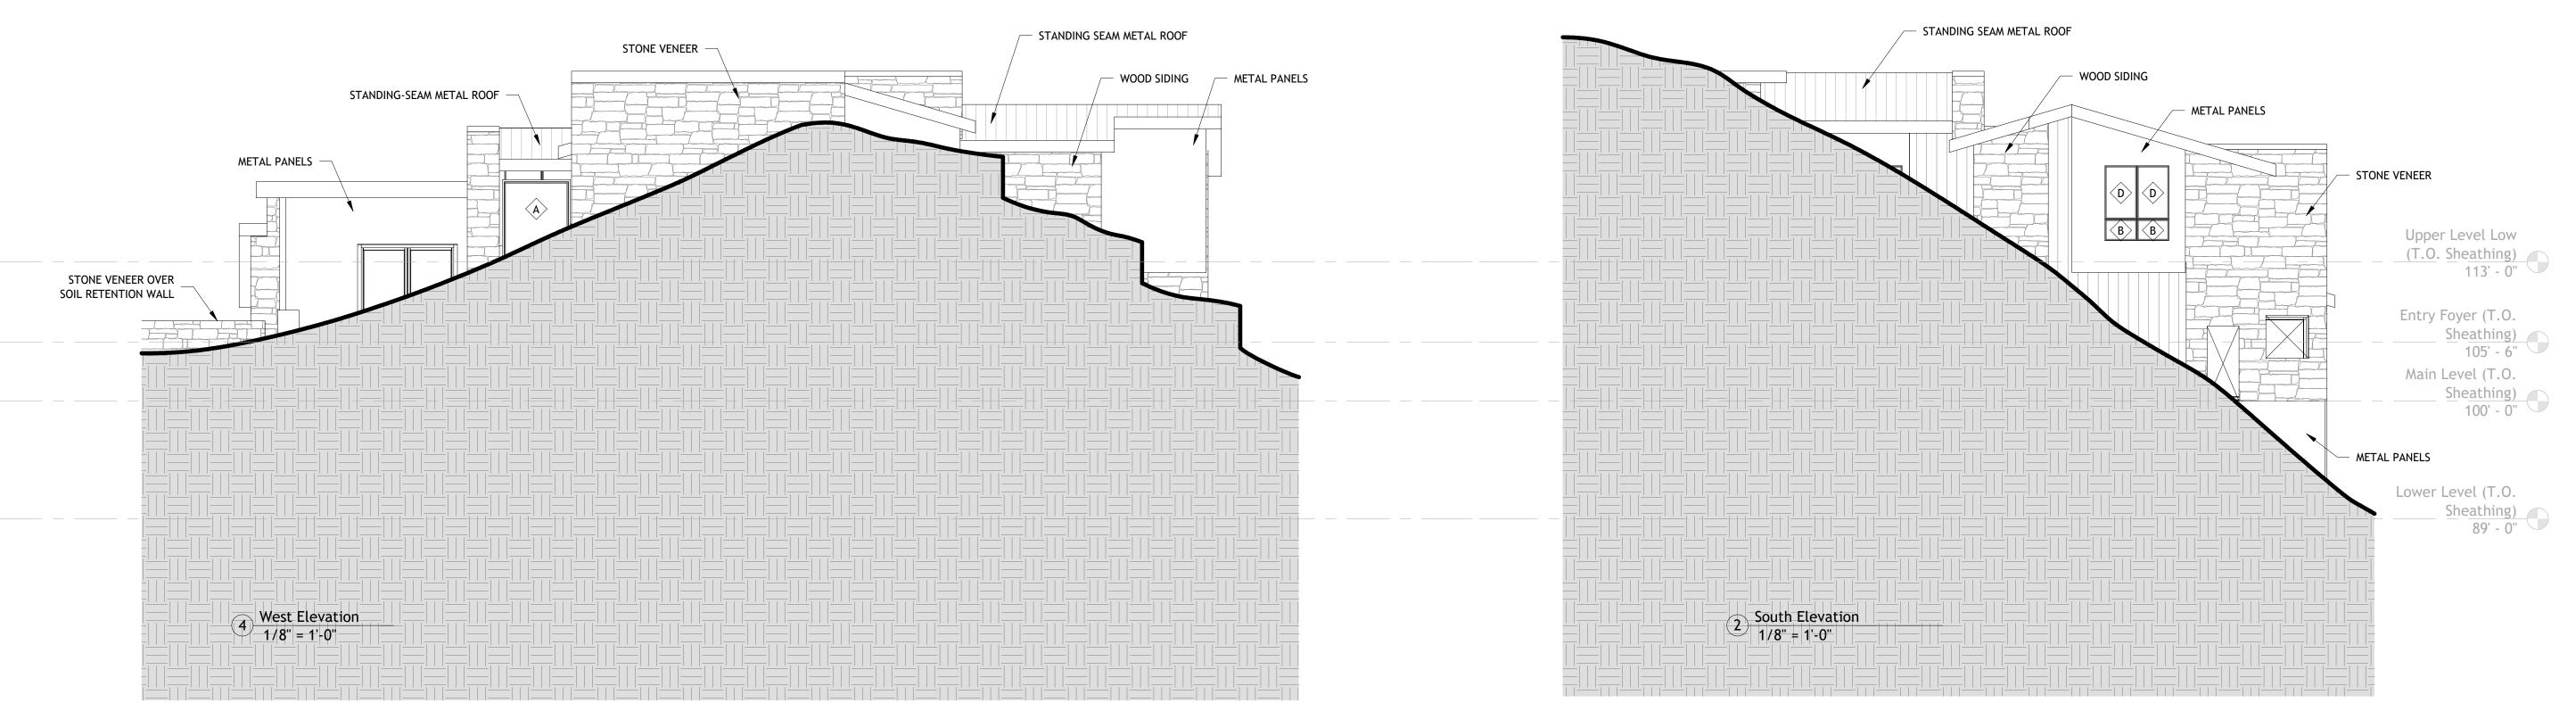



EXPOSED CONCRETE:
BOARD-FORMED

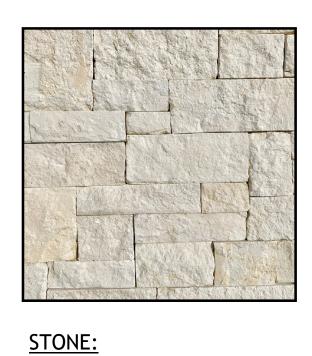

FULL-DEPTH LIMESTONE



METAL SIDING:

DARK METAL PANELS



VERTICAL 'WOOD':
TEXTURED METAL PANEL



SLOPED ROOF:
STANDING SEAM METAL

| EXTERIOR A | MATERIALS | <u>.</u> |
|---------------|-----------|----------|
| STONE | 4,072 SF | 43.9% |
| GLASS | 1,462 SF | 15.8% |
| METAL PANEL | 1,404 SF | 15.1% |
| WOOD | 1,272 SF | 13.7% |
| EXPOSED CONC. | 911 SF | 9.8% |
| GARAGE DOOR | 158 SF | 1.7% |

| 3 EAST ELEVATION - MATE | RIAL CALCULATIONS | | |
|-------------------------|-------------------|--|--|





WEST ELEVATION - MATERIAL CALCULATIONS

1/8" = 1'-0"



2 SOUTH ELEVATION - MATERIAL CALCULATIONS 1/8" = 1'-0" Upper Level Low (T.O. Sheathing) 113' - 0"

Entry Foyer (T.O.

Sheathing)

105' - 6"

Main Level (T.O.

Sheathing)

100' - 0"

Lower Level (T.O.
Sheathing)
89' - 0"

Prawing No. A202



628 Oak Street Steamboat Springs, CO 80487 scott@sproutaec.com 970.759.3745


Architect Sprout aec, Ilc Scott Beans scott@sproutaec.com 970.759.3745


Civil Engineer Uncompahgre Engineering, LLC David Ballode dballode@msn.com 970.729.0683

Structural Engineer Sprout aec, Ilc Scott Beans scott@sproutaec.com 970.759.3745

Mechanical Engineer Hughes Consulting Engineering Dimitri Merrill dimitri@hce-pa.com 970.239.1949

HERS Consultant Lotus Energy Solutions Kim Wheels lotusenergysolutions@gmail.com 970.708.9674

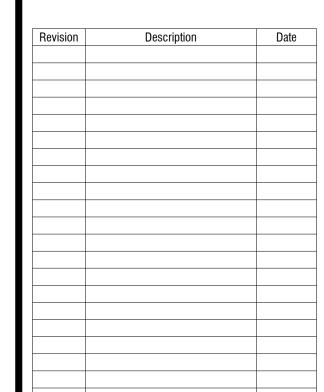

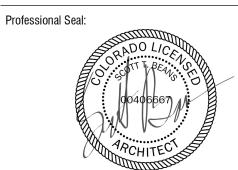

Project Description:

Mahfuz Residence

Lot 166AR2-1, Stonegate Drive

Mountain Village, CO 81435

Drawing Description:

Exterior Material Calculations

Project Number

Date 1.22.2024

Drawn By STB

Checked By STB

| | | | | | Door Schedule |
|------|----------|---------|----------|--------|---------------|
| | | Door | | | |
| | 5 | Size | | | |
| Mark | Width | Height | Material | Finish | Comments |
| | • | | | | |
| E1 | 9' - 0" | 9' - 0" | | | |
| E2 | 10' - 0" | 8' - 0" | | | |
| E3 | 3' - 0" | 6' - 8" | | | |
| E4 | 8' - 0" | 8' - 0" | | | |
| E5 | 12' - 0" | 7' - 6" | | | |
| E6 | 12' - 0" | 7' - 6" | | | |

| | | | | | Windo | w Schedi | ule |
|-----------|--------------------|--------------------|------|----------|--------|---------------------|----------|
| Type Mark | Width | Size Height | Туре | Material | Finish | Head Height | Comments |
| | 6' - 0" | 15' - 0" | | | | 15' - 0" | |
| B B | 3' - 0" | 2' - 0" 2' - 0" | | | | 13' - 0" 4' - 0" | |
| | 3' - 0" | 2' - 0" | | | | 4' - 0" | |
| В | 3' - 0" | 2' - 0" | | | | 4' - 0" | |
| В | 3' - 0" | 2' - 0" | | | | 4' - 0" | |
| | 3' - 0" 3' - 0" | 2' - 0" 2' - 0" | | | | 4' - 0" 2' - 6" | |
| В | 3' - 0" | 2' - 0" | | | | 2' - 6" | |
| | 2' - 0" | 4' - 0" | | | | 8' - 0" | |
| C | 2' - 0" | 4' - 0" 4' - 0" | | | | 8' - 0" 8' - 0" | |
| C | 2' - 0" | 4' - 0" | | | | 8' - 0" | |
| | 2' - 0" | 4' - 0" | | | | 8' - 0" | |
| D | 3' - 0" | 5' - 0" | | | | 9' - 0" | |
| | 3' - 0" 3' - 0" | 5' - 0" 5' - 0" | | | | 9' - 0" 7' - 6" | |
| | 3' - 0" | 5' - 0" | | | | 7' - 6" | |
| | 4' - 0" | 6' - 0" | | | | 8' - 0" | |
| F F | 3' - 6" 3' - 6" | 6' - 0" 6' - 0" | | | | 8' - 0" 8' - 0" | |
| =' | 3' - 6" | 6' - 0" | | | | 8' - 0" | |
| G | 3' - 8" | 3' - 0" | | | | 3' - 6" | |
| G | 3' - 8" | 3' - 0" | | | | 3' - 6" | |
| | 3' - 8" 3' - 8" | 3' - 0" 3' - 0" | | | | 3' - 6" 3' - 6" | |
| | 3' - 8" | 3' - 0" | | | | 3' - 6" | |
| | 3' - 8" | 3' - 0" | | | | 3' - 6" | |
| | 3' - 8" | 3' - 0" 3' - 0" | | | | 3' - 6" 3' - 6" | |
| G G | 3' - 8" | 3' - 0" | | | | 3' - 6" | |
| G | 3' - 8" | 3' - 0" | | | | 3' - 6" | |
| | 3' - 8" | 3' - 0" | | | | 3' - 6" | |
| G G | 3' - 8" | 3' - 0" 3' - 0" | | | | 3' - 6" 3' - 6" | |
| G | 3' - 8" | 3' - 0" | | | | 3' - 6" | |
| | 3' - 8" | 3' - 0" | | | | 3' - 6" | |
| G G | 3' - 8" | 3' - 0" 3' - 0" | | | | 3' - 6" 3' - 6" | |
| G | 3' - 8" | 3' - 0" | | | | 3' - 6" | |
| | 3' - 8" | 3' - 0" | | | | 3' - 6" | |
| G | 3' - 8" | 3' - 0" | | | | 3' - 6" | |
| G G | 3' - 8" | 3' - 0" 3' - 0" | | | | 3' - 6" 3' - 6" | |
| Н | 3' - 8" | 6' - 0" | | | | 9' - 6" | |
| Н | 3' - 8" | 6' - 0" | | | | 9' - 6" | |
| | 3' - 8" | 6' - 0" 6' - 0" | | | | 9' - 6" | |
| H | 3' - 8" | 6' - 0" | | | | 9' - 6" | |
| Н | 3' - 8" | 6' - 0" | | | | 9' - 6" | |
| | 3' - 8" | 6' - 0" | | | | 9' - 6" | |
| | 3' - 8" 3' - 8" | 6' - 0" 6' - 0" | | | | 9' - 6" | |
| H | 3' - 8" | 6' - 0" | | | | 9' - 6" | |
| Н | 3' - 8" | 6' - 0" | | | | 9' - 6" | |
| H | 3' - 8" 3' - 8" | 6' - 0" 5' - 0" | | | | 9' - 6" 8' - 6" | |
| J | 3' - 8" | 5' - 0" | | | | 8' - 6" | |
| | 3' - 8" | 5' - 0" | | | _ | 8' - 6" | |
| J | 3' - 8" | 5' - 0" | | | | 8' - 6" | |
| J | 3' - 8" | 5' - 0" 5' - 0" | | | | 8' - 6" 8' - 6" | |
| J | 3' - 8" | 5' - 0" | | | | 8' - 6" | |
| J | 3' - 8" | 5' - 0" | | | | 8' - 6" | |
| | 3' - 8" | 5' - 0" 5' - 0" | | | | 8' - 6" 8' - 6" | |
| | 3' - 6" | 5' - 0" | | | | 8' - 6" | |
| K | 3' - 6" | 5' - 0" | | | | 8' - 6" | |
| K | 3' - 6" | 5' - 0" | | | | 8' - 6" | |
| K K | 3' - 6" 3' - 6" | 5' - 0" 5' - 0" | | | | 8' - 6" 8' - 6" | |
| | 3' - 6" | 5' - 0" | | | | 8' - 6" | |
| | 4' - 0" | 2' - 0" | | | | 2' - 0" | |
| M | 8' - 0" | 4' - 0" | | | | 7' - 0" | |




Architect Sprout aec, Ilc Scott Beans scott@sproutaec.com 970.759.3745


Civil Engineer Uncompahgre Engineering, LLC David Ballode dballode@msn.com 970.729.0683

Structural Engineer Sprout aec, Ilc Scott Beans scott@sproutaec.com 970.759.3745

Mechanical Engineer Hughes Consulting Engineering Dimitri Merrill dimitri@hce-pa.com 970.239.1949

HERS Consultant Lotus Energy Solutions Kim Wheels lotusenergysolutions@gmail.com 970.708.9674

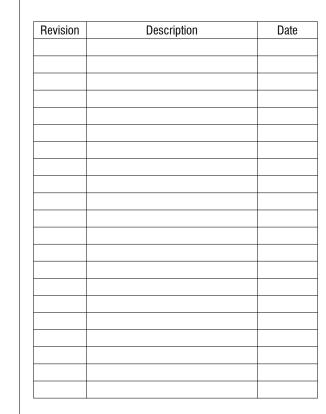

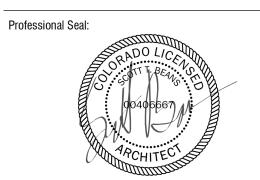

Project Description:

Mahfuz Residence

Lot 166AR2-1, Stonegate Drive


Mountain Village, CO 81435


Drawing Description:

Door & Window Schedules

| Project Number | |
|----------------|----------|
| Date | 1.22.202 |
| Drawn By | STI |
| Checked By | STE |

A300

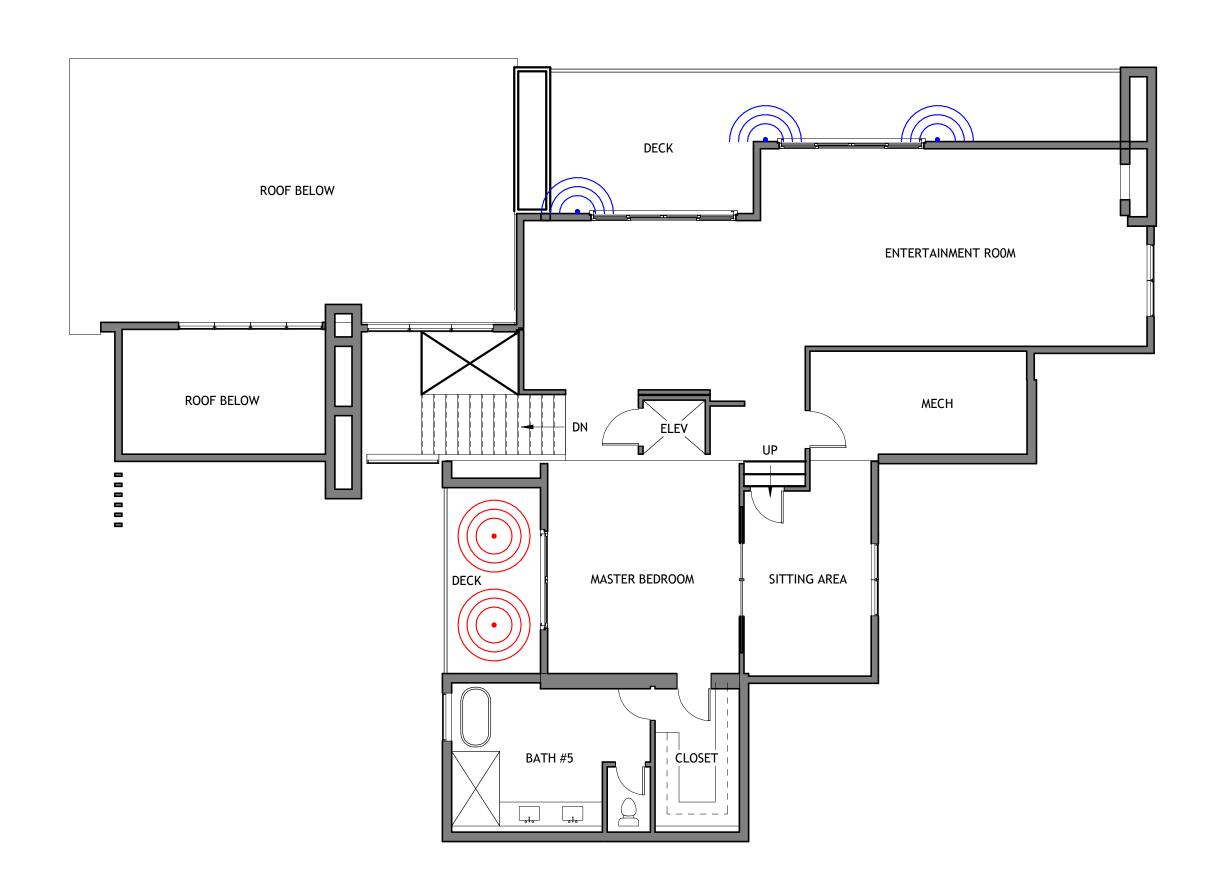

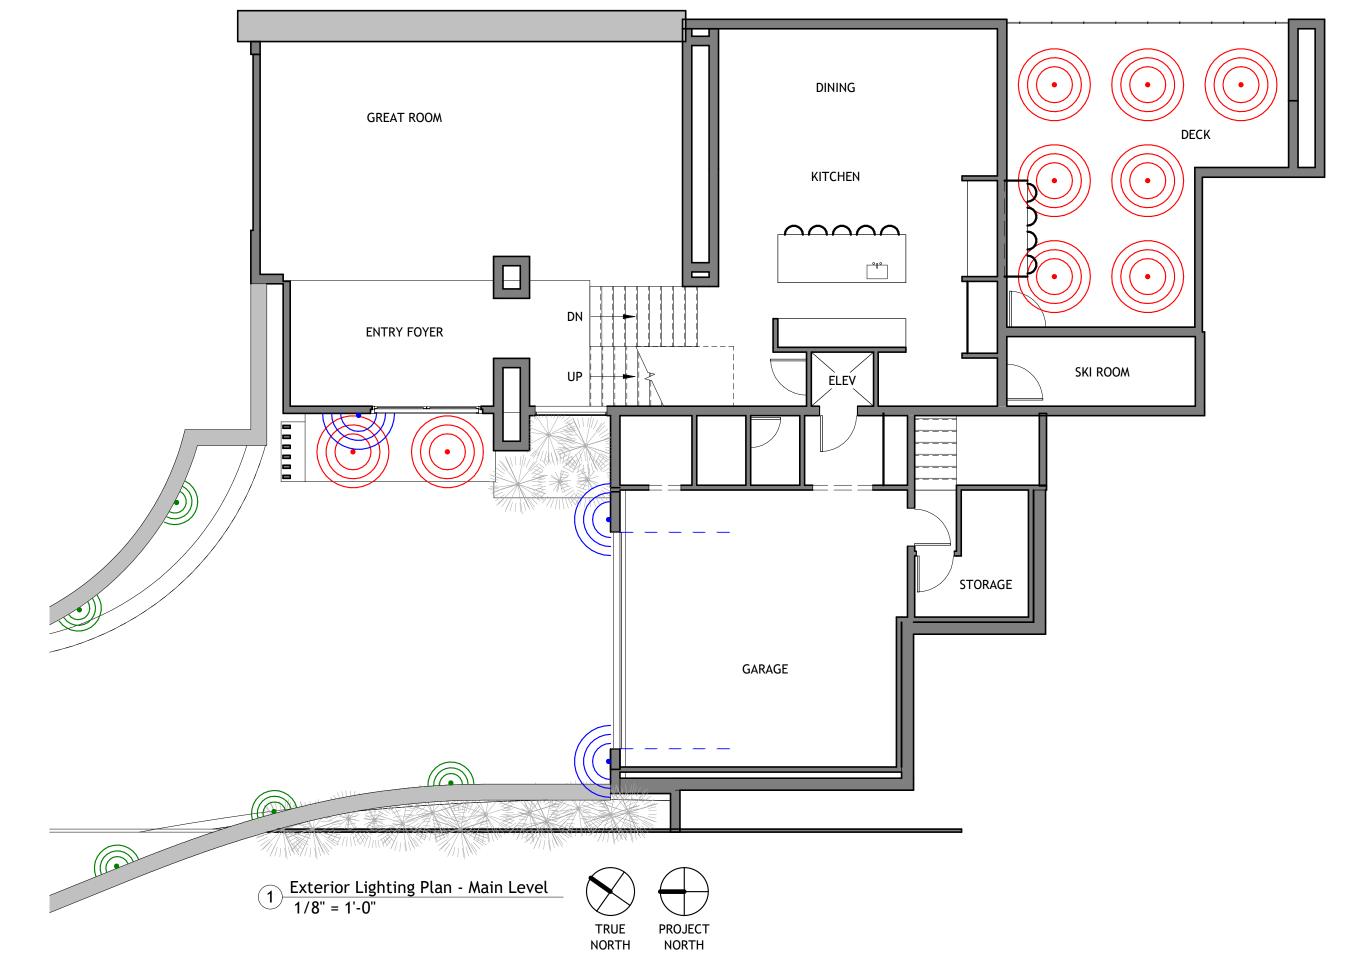

Lithonia Wafter LED Recessed Downlight | WF4 LED 27K30K35K



3 Exterior Lighting Plan - Upper Level 1/8" = 1'-0"

CAN LIGHT


WALL SCONCE


| | Color Temperature | 3000K |
|----|--------------------|------------------------------------|
| | Lumens | 800 |
| | CRI | 90 |
| Λ. | Rated wattage | 10.1 |
| | Lu/Watts | 79.2 |
| | Min. starting temp | -40°C (-40°F) |
| | EMI/RFI | FCC Title 47 CFR, Part 15, Class B |
| К | Sound rating | Class A Standards |
| | Input voltage | 120V |
| | Min. power factor | 0.97 |
| | Input frequency | 50/60 Hz |
| | Input power | 120V |
| | Input current | 0.09A |

Hinkley Taper Medium Wall Mount Lantern | 2144TK



| | | DETAILS | |
|-----------|--|------------------------------|--------------------------------|
| DASTAL | | FINISH: | Textured Black |
| ENACNITO" | 7" \\/ | MATERIAL: | Composite |
| ection | — 7" W —— | GLASS: | Etched |
| 1 | | DIMENSIONS | \neg |
| | | WIDTH: | 7" |
| | | HEIGHT: | 15" |
| | | WEIGHT: | 3.5 lbs. |
| | | BACK PLATE: | 7"W X 15"H |
| | | EXTENSION: | 3.5" |
| | | TOP TO OUTLET: | 7.5" |
| | | | |
| 15" H | | LIGHT SOURCE | |
| | | LIGHT SOURCE: | Integrated LED |
| | | LED NAME: | L214X-6 |
| | | WATTAGE: | 8w LED *Included |
| | | VOLTAGE: | 120v |
| | | COLOR TEMP: | 3000 |
| | | LUMENS: | 600 |
| | The same of the sa | CRI: | 90 |
| | - | INCANDESCENT EQUIVALENCY: | 1 x 60w |
| | | DIMMABLE: | Yes - CL Type Dimme (SSL7A) |

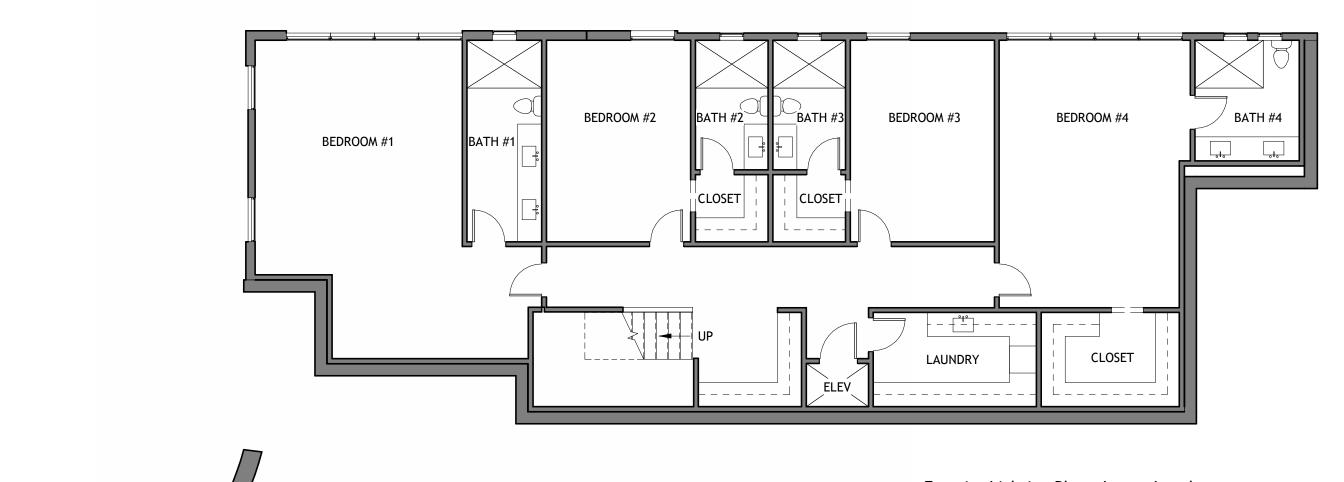

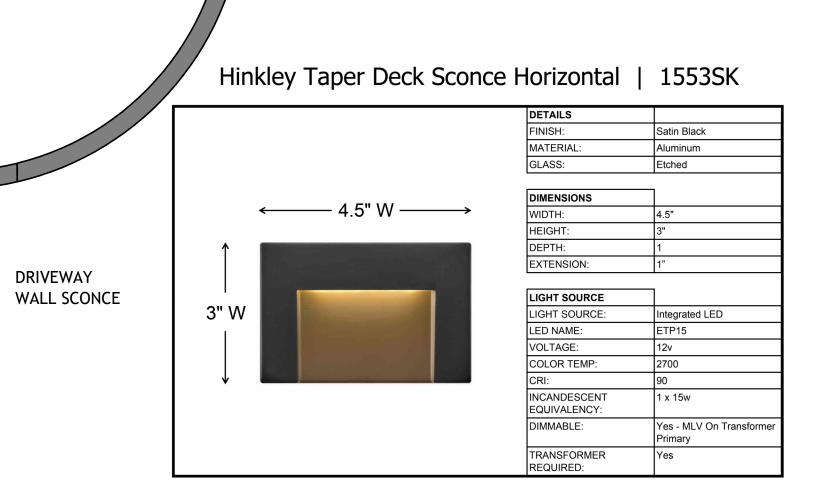

2 Exterior Lighting Plan - Lower Level 1/8" = 1'-0"

628 Oak Street Steamboat Springs, CO 80487 scott@sproutaec.com 970.759.3745

Architect Sprout aec, Ilc Scott Beans scott@sproutaec.com 970.759.3745


Civil Engineer Uncompahgre Engineering, LLC David Ballode dballode@msn.com 970.729.0683

Structural Engineer Sprout aec, Ilc Scott Beans scott@sproutaec.com 970.759.3745

Mechanical Engineer Hughes Consulting Engineering Dimitri Merrill dimitri@hce-pa.com 970.239.1949

HERS Consultant Lotus Energy Solutions Kim Wheels lotusenergysolutions@gmail.com 970.708.9674

| Revision | Description | Date |
|----------|-------------|------|
| | | |
| | | |
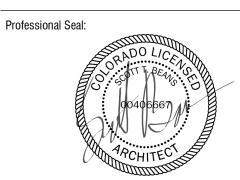


Project Description: Mahfuz Residence Lot 166AR2-1, Stonegate Drive Mountain Village, CO 81435

Drawing Description: Exterior Lighting Plans

| Project Number | |
|----------------|-----------|
| Date | 1.22.2024 |
| Drawn By | STB |
| Checked By | STB |
| Drawing No. | |
| 1100 | |

A400

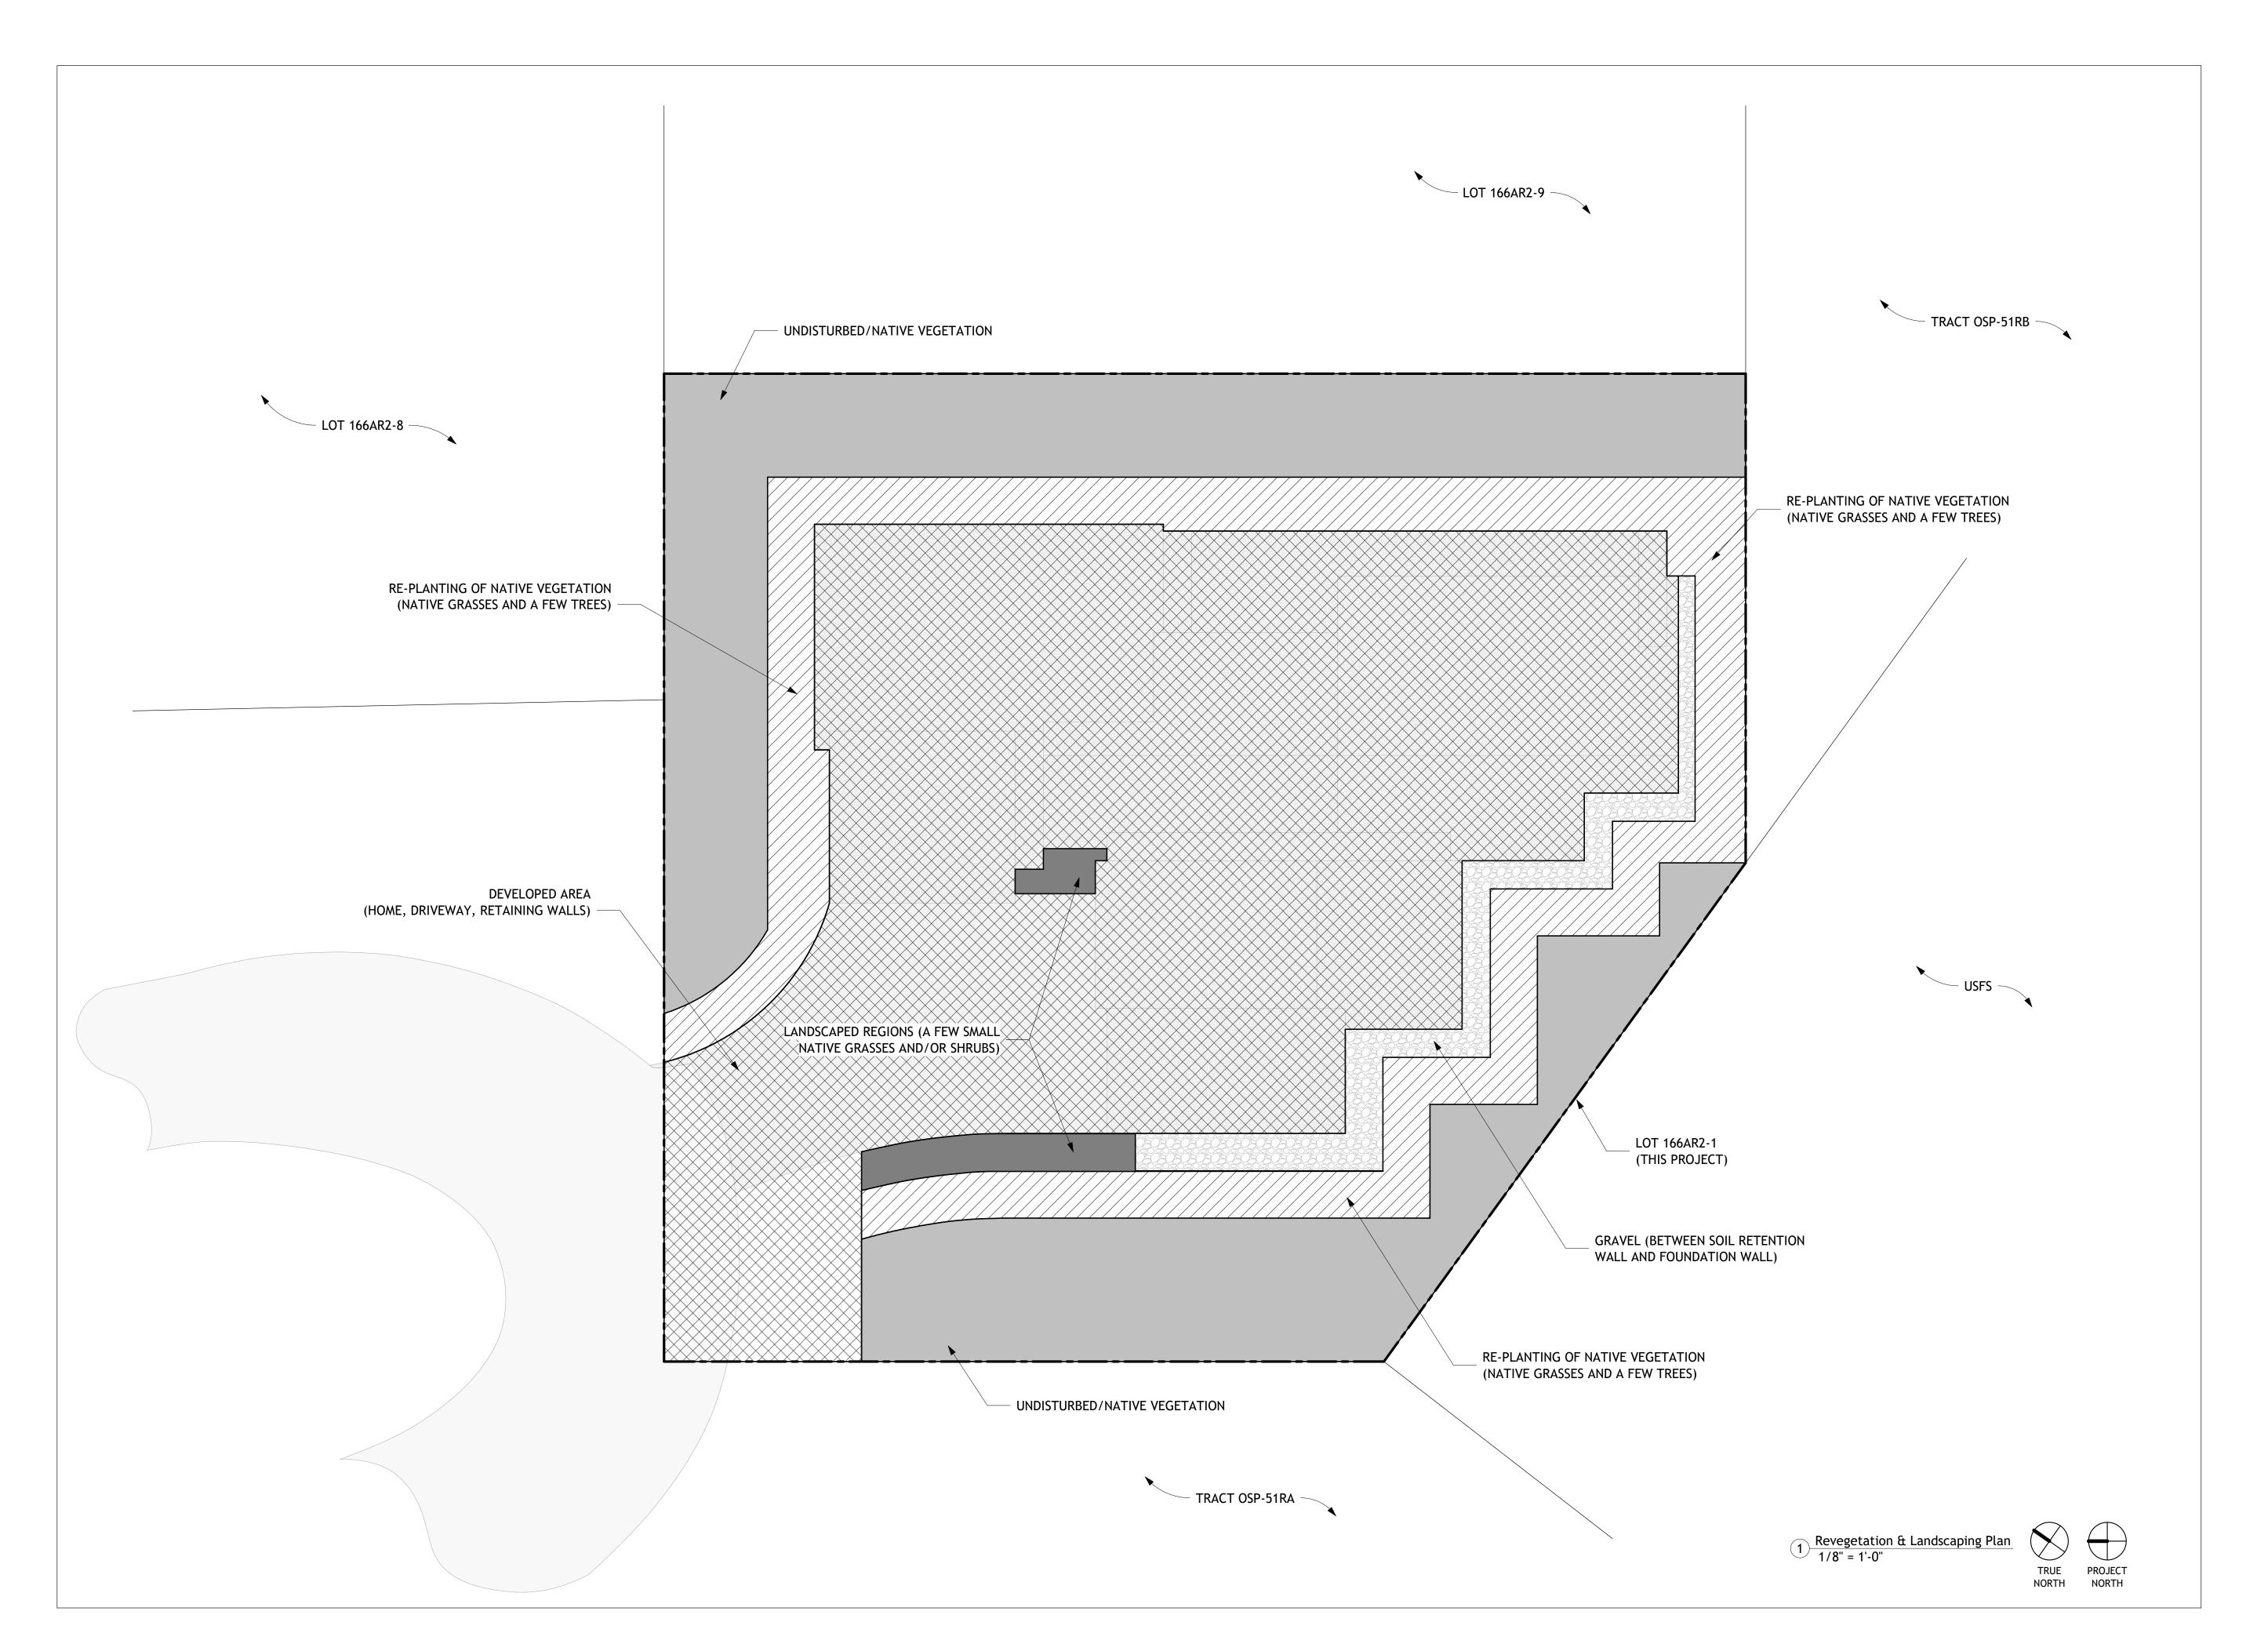



Architect Sprout aec, Ilc Scott Beans scott@sproutaec.com 970.759.3745


Civil Engineer Uncompahgre Engineering, LLC David Ballode dballode@msn.com 970.729.0683

Structural Engineer Sprout aec, Ilc Scott Beans scott@sproutaec.com 970.759.3745

Mechanical Engineer Hughes Consulting Engineering Dimitri Merrill dimitri@hce-pa.com 970.239.1949

HERS Consultant Lotus Energy Solutions Kim Wheels lotusenergysolutions@gmail.com 970.708.9674

| Revision | Description | Date |
|----------|-------------|------|
| | | · |
| | | |
| | | |
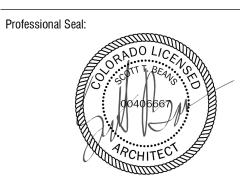

Project Description:

Mahfuz Residence

Lot 166AR2-1, Stonegate Drive

Mountain Village, CO 81435

Drawing Description:

Revegetation & Landscaping Plan

| oject Number | | |
|--------------|------------------------|-----------|
| ite | | 1.22.2024 |
| awn By | | STB |
| ecked By | | STB |
| awing No. | | |
| | $\Delta \Delta \Delta$ | |

L001