Date: April 2, 2024 By: Kristine Perpar, Architect

Property address:

Lot 11; Boulders Mountain Village, CO 81435

Sent to: MV DRB

Re: Development of a Single Family Residence

Dear Mountain Village Design Review Board,

The proposed home for Unit 11; Lot 649R was designed for sensitivity of the restricted site, neighbors and the existing topography.

Unit 11 is currently vacant of structures and trees. The building site is essentially flat with a slight slope at the west end.

Exterior elevations, plans and roof are simple in form. Roofs are all Shed roofs at a 5:12 pitch. Exterior materials; stone, metal and wood accents were selected for their sensitivity to the environment, neighboring properties and for durability.

The proposed landscape plan is simple. Aspen trees to be planted on the north and either side of the structure.

Sincerely,

K

Kristine Perpar



GENERAL NOTES:

CONTRACT DOCUMENTS:

CONTRACT DOCUMENTS CONSIST OF THE AGREEMENT, GENERAL CONDITIONS, SPECIFICATIONS, DETAIL BOOK AND DRAWINGS, WHICH ARE COOPERATIVE AND CONTINUOUS. WORK INDICATED OR REASONABLY IMPLIED IN ANY ONE OF THE DOCUMENTS SHALL BE SUPPLIED AS THOUGH FULLY COVERED IN ALL. ANY DISCREPANCIES BETWEEN THE PARTS SHALL BE REPORTED TO THE ARCHITECT PRIOR TO THE COMMENCEMENT OF WORK. THESE DRAWINGS ARE PART OF THE CONTRACT DOCUMENTS FOR THIS PROJECT. THESE DRAWINGS ARE THE GRAPHIC ILLUSTRATION OF THE WORK TO BE ACCOMPLISHED. ALL DIMENSIONS NOTED TAKE PRECEDENCE OVER SCALED DIMENSIONS. DIMENSIONS NOTES WITH "N.T.S." DENOTES NOT TO SCALE.

ORGANIZATION:

THE DRAWINGS FOLLOW A LOGICAL, INTERDISCIPLINARY FORMAT: ARCHITECTURAL DRAWINGS (A SHEETS), CIVIL DRAWINGS (C SHEETS), STRUCTURAL (S SHEETS), MECHANICAL AND PLUMBING (M SHEETS), ELECTRICAL (E SHEETS) AND LIGHTING (LTG SHEETS).

CODE COMPLIANCE:

ALL WORK, MATERIALS AND ASSEMBLIES SHALL COMPLY WITH APPLICABLE STATE AND LOCAL CODES, ORDINANCES AND REGULATIONS. THE CONTRACTOR, SUBCONTRACTORS AND JOURNEYMEN OF THE APPROPRIATE TRADES SHALL PERFORM WORK TO THE HIGHEST STANDARDS OF CRAFTSMANSHIP AND IN ACCORDANCE WITH AIA DOCUMENT A201-SECTION 3. THE BUILDING INSPECTOR SHALL BE NOTIFIED BY THE CONTRACTOR WHEN THERE IS NEED OF INSPECTION AS REQUIRED BY THE INTERNATIONAL BUILDING CODE OR ANY LOCAL CODE OR ORDINANCE.

INTENT:

THESE DOCUMENTS ARE INTENDED TO INCLUDE ALL LABOR, MATERIALS, EQUIPMENT AND SERVICES REQUIRED TO COMPLETE THE WORK DESCRIBED HEREIN.

COORDINATION:

THE CONTRACTOR SHALL CAREFULLY STUDY AND COMPARE THE DOCUMENTS, VERIFY ACTUAL CONDITIONS AND REPORT ANY DISCREPANCIES, ERRORS OR OMISSIONS TO THE ARCHITECT IN A TIMELY MANNER. THE ARCHITECT SHALL CLARIFY OR PROVIDE REASONABLE ADDITIONAL INFORMATION REQUIRED FOR SUCCESSFUL EXECUTION. THE CONTRACTOR SHALL VERIFY AND COORDINATE ALL OPENINGS THROUGH FLOORS, CEILINGS AND WALLS WITH ALL ARCHITECTURAL, INTERIOR, STRUCTURAL, MECHANICAL AND PLUMBING, ELECTRICAL AND LIGHTING DRAWINGS. CONTRACTOR WILL ASSUME RESPONSIBILITY OF ITEMS REQUIRING COORDINATION AND RESOLUTION DURING THE BIDDING PROCESS.

SUBSTITUTIONS:

ANY MATERIALS PROPOSED FOR SUBSTITUTION OF THOSE SPECIFIED OR THE CALLED-OUT-BY-TRADE-NAME IN THESE DOCUMENTS SHALL BE PRESENTED TO THE ARCHITECT FOR REVIEW. THE CONTRACTOR SHALL SUBMIT SAMPLES WHEN REQUIRED BY THE ARCHITECT AND SUCH SAMPLES SHALL BE REVIEWED BY THE ARCHITECT BEFORE THE WORK IS PERFORMED. WORK MUST CONFORM TO THE REVIEWED SAMPLES. ANY WORK WHICH DOES NOT CONFORM SHALL BE REMOVED AND REPLACED WITH WORK WHICH CONFORMS AT THE CONTRACTOR'S EXPENSE. SUBCONTRACTORS SHALL SUBMIT REQUESTS FOR REVIEW THROUGH THE GENERAL CONTRACTOR WHEN WORK IS LET THROUGH HIM OR HER. REQUIRED VERIFICATION AND SUBMITTALS TO BE MADE IN ADEQUATE TIME AS NOT TO DELAY WORK IN PROGRESS.

SHOP DRAWINGS

SHOP DRAWINGS SHALL BE SUBMITTED TO THE ARCHITECT FOR HIS OR HER REVIEW WHERE CALLED FOR ANYWHERE IN THESE DOCUMENTS. REVIEW SHALL BE MADE BY THE ARCHITECT BEFORE WORK IS BEGUN, AND WORK SHALL CONFORM TO THE REVIEWED SHOP DRAWINGS, SUBJECT TO REPLACEMENT AS REQUIRED IN PARAGRAPH "SUBSTITUTIONS" ABOVE.

SAFETY & PROTECTION OF WORK

THE CONTRACTOR SHALL BE RESPONSIBLE FOR THE SAFETY AND CARE OF ADJACENT PROPERTIES DURING CONSTRUCTION FOR COMPLIANCE WITH FEDERAL AND STATE O.S.H.A. REGULATIONS, AND FOR THE PROTECTION OF ALL WORK UNTIL IT IS DELIVERED COMPLETED TO THE OWNER.

PROJECT CODE INFORMATION

ZONING:	MULTI-FAMILY
SUBDIVISION:	BOULDERS
BUILDING CODE:	IRC 2018 AND ALL APPLICABLE CODES AS REQUIRED BY THE TOWN OF MOUNTAIN VILLAGE
DESIGN REQUIREMENTS:	BOULDER TOWN OF MOUNTAIN VILLAGE
	MULTI-STORY DWELLING
DESCRIPTION:	R-3
OCCUPANCY CLASSIFICATION:	REQUIRED
AUTOMATIC FIRE SPRINKLER:	GARAGE - 1 HR MECHANICAL - 1 HR
FIRE RESISTIVE RATING:	

TYPE OF UNIT:

GROSS FLOOR AREA:


LEVEL 1 LEVEL 2 LEVEL 3 TOTAL:

GARAGE BASEMENT

LOT AREA:

TOTAL:

BUILDING FOOTPRINT: ALLOWABLE PROPOSED

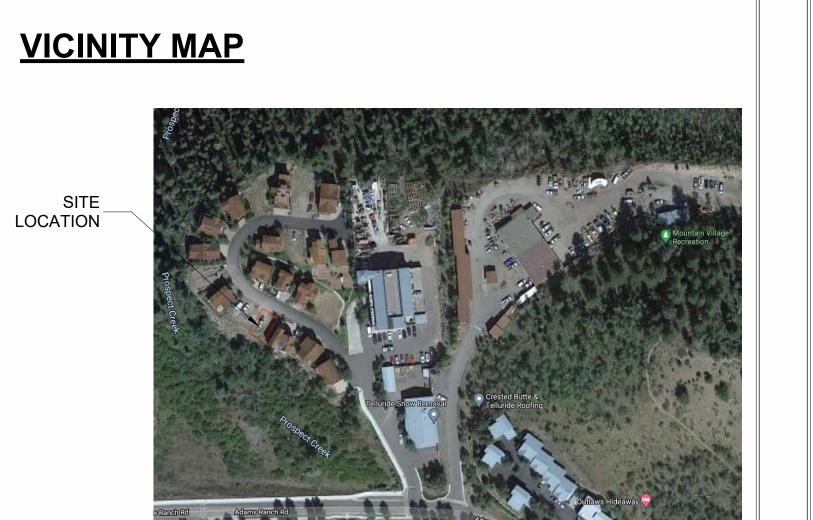



OWNER:

NOVAEZ ERIC AND NOVA 1411 W 46TH ST AUSTIN TX 787563005 Eric Novaez ericnovaez@g 1.210.286.5585

ARCHITECT:

SHIFT ARCHITECTS **KRISTINE PERPAR - ARC** 100 WEST COLORADO ST TELLURIDE, CO 81435 P. 970.275.0263 kristine@shift-architects.cor

GENERAL CONTRACTOR:

TBD.

PROJECT INFORMATION

SINGLE FAMILY HOME	MAX BUILDING HEIGHT: ALLOWABLE PROPOSED	35'-0" 35.00'
645.61 SF 1053.49 SF 814.00 SF <u>2,513.10 SF</u>	MAX AVERAGE HEIGHT: ALLOWABLE PROPOSED	30'-0" 26.76'
374.90 SF 1,020.50 SF	PARKING REQUIRED:	1 SPACE PROVIDED (ENCLOSED IN GARAGE)
<u>3,908.50 SF</u>		
0.062 ACRES (2,709.92 SF)		
2,400 SF 1,381.31 SF	SEE SHEET A2.1 FOR MA	XIMUM BUILDING HEIGHT /
	BUILDING FOOTPRINT CA	

	SURVEYOR:	MECHANICAL:
/AEZ MONIQUE AS JT)gmail.com	FOLEY ASSOCIATES, INC. 125 W. PACIFIC, SUITE B-1 P.O. BOX 1385 TELLURIDE, CO 81435 P. 970.728.6153 F. 970.728.6050	HUGHES CONSULTING ENGINEERING, PA DIMITRI MERRILL, P.E. TELLURIDE, CO 81435 P. 970.239.1949 F. 785.842.2492 dimitri@hce-pa.com
	<u>CIVIL</u> :	LANDSCAPING:
CHITECT STE. 211 com	UNCOMPAHGRE ENGINEERING LLC DAVID BALLODE P.E. PO BOX 3945 TELLURIDE, CO 81435 P. 970.729.0683 dballode@msn.com	C SHIFT ARCHITECTS KRISTINE PERPAR - ARCHITECT 100 WEST COLORADO STE. 211 TELLURIDE, CO 81435 P. 970.275.0263 kristine@shift-architects.com
	STRUCTURAL:	
	ALPINE EDGE ENGINEERING LLC MATTHEW D. HEPP, P.E. 605 RIVER PARK DR. RIDGEWAY, CO 81432 P. 970.318.1469	

matthewheppeng@gmail.com




SHEET INDEX

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C2	SITE DRAINAGE AND U
C3	CONSTRUCTION MITIC
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A1.2	
A2.1	FLOOR PLANS
	FLOOR & ROOF PLAN
A3.1	MATERIAL CALCULATI
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A6.1	PERSPECTIVES
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A8.2	DOOR SCHEDULE
LIGHTING	
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E1.2	LIGHTING PLANS

UTILITY PLAN GATION PLAN

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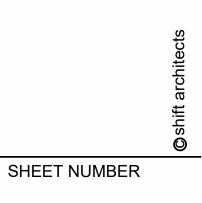
P.O. Box 3206 100 W. Colorado Suite 211 Telluride, Colorado 81435 p 970-728-8145 kristine@shift-architects.com www.shift-architects.com

PROJECT ISSUE DATE: 02.20.24 REVISED DRB SUBMITTAL

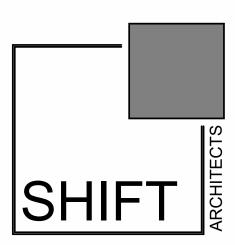
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COVER SHEET



G1.0



SCALE: 1"=4'
0 1 2 3 4 8
LEGEND
TELEPHONE PEDESTAL
CABLE-TV PEDESTAL
● FOUND 1-1/2" ALUMINUM CAP ON 5/8" REBAR, L.S. 24954
• FOUND 1-1/2" ALUMINUM CAP ON 5/8" REBAR, L.S. 24954
● SET 1−1/2" ALUMINUM CAP ON 18" × 5/8" REBAR, L.S. 37970
SET 3/4" BRASS TAG, L.S. 37970

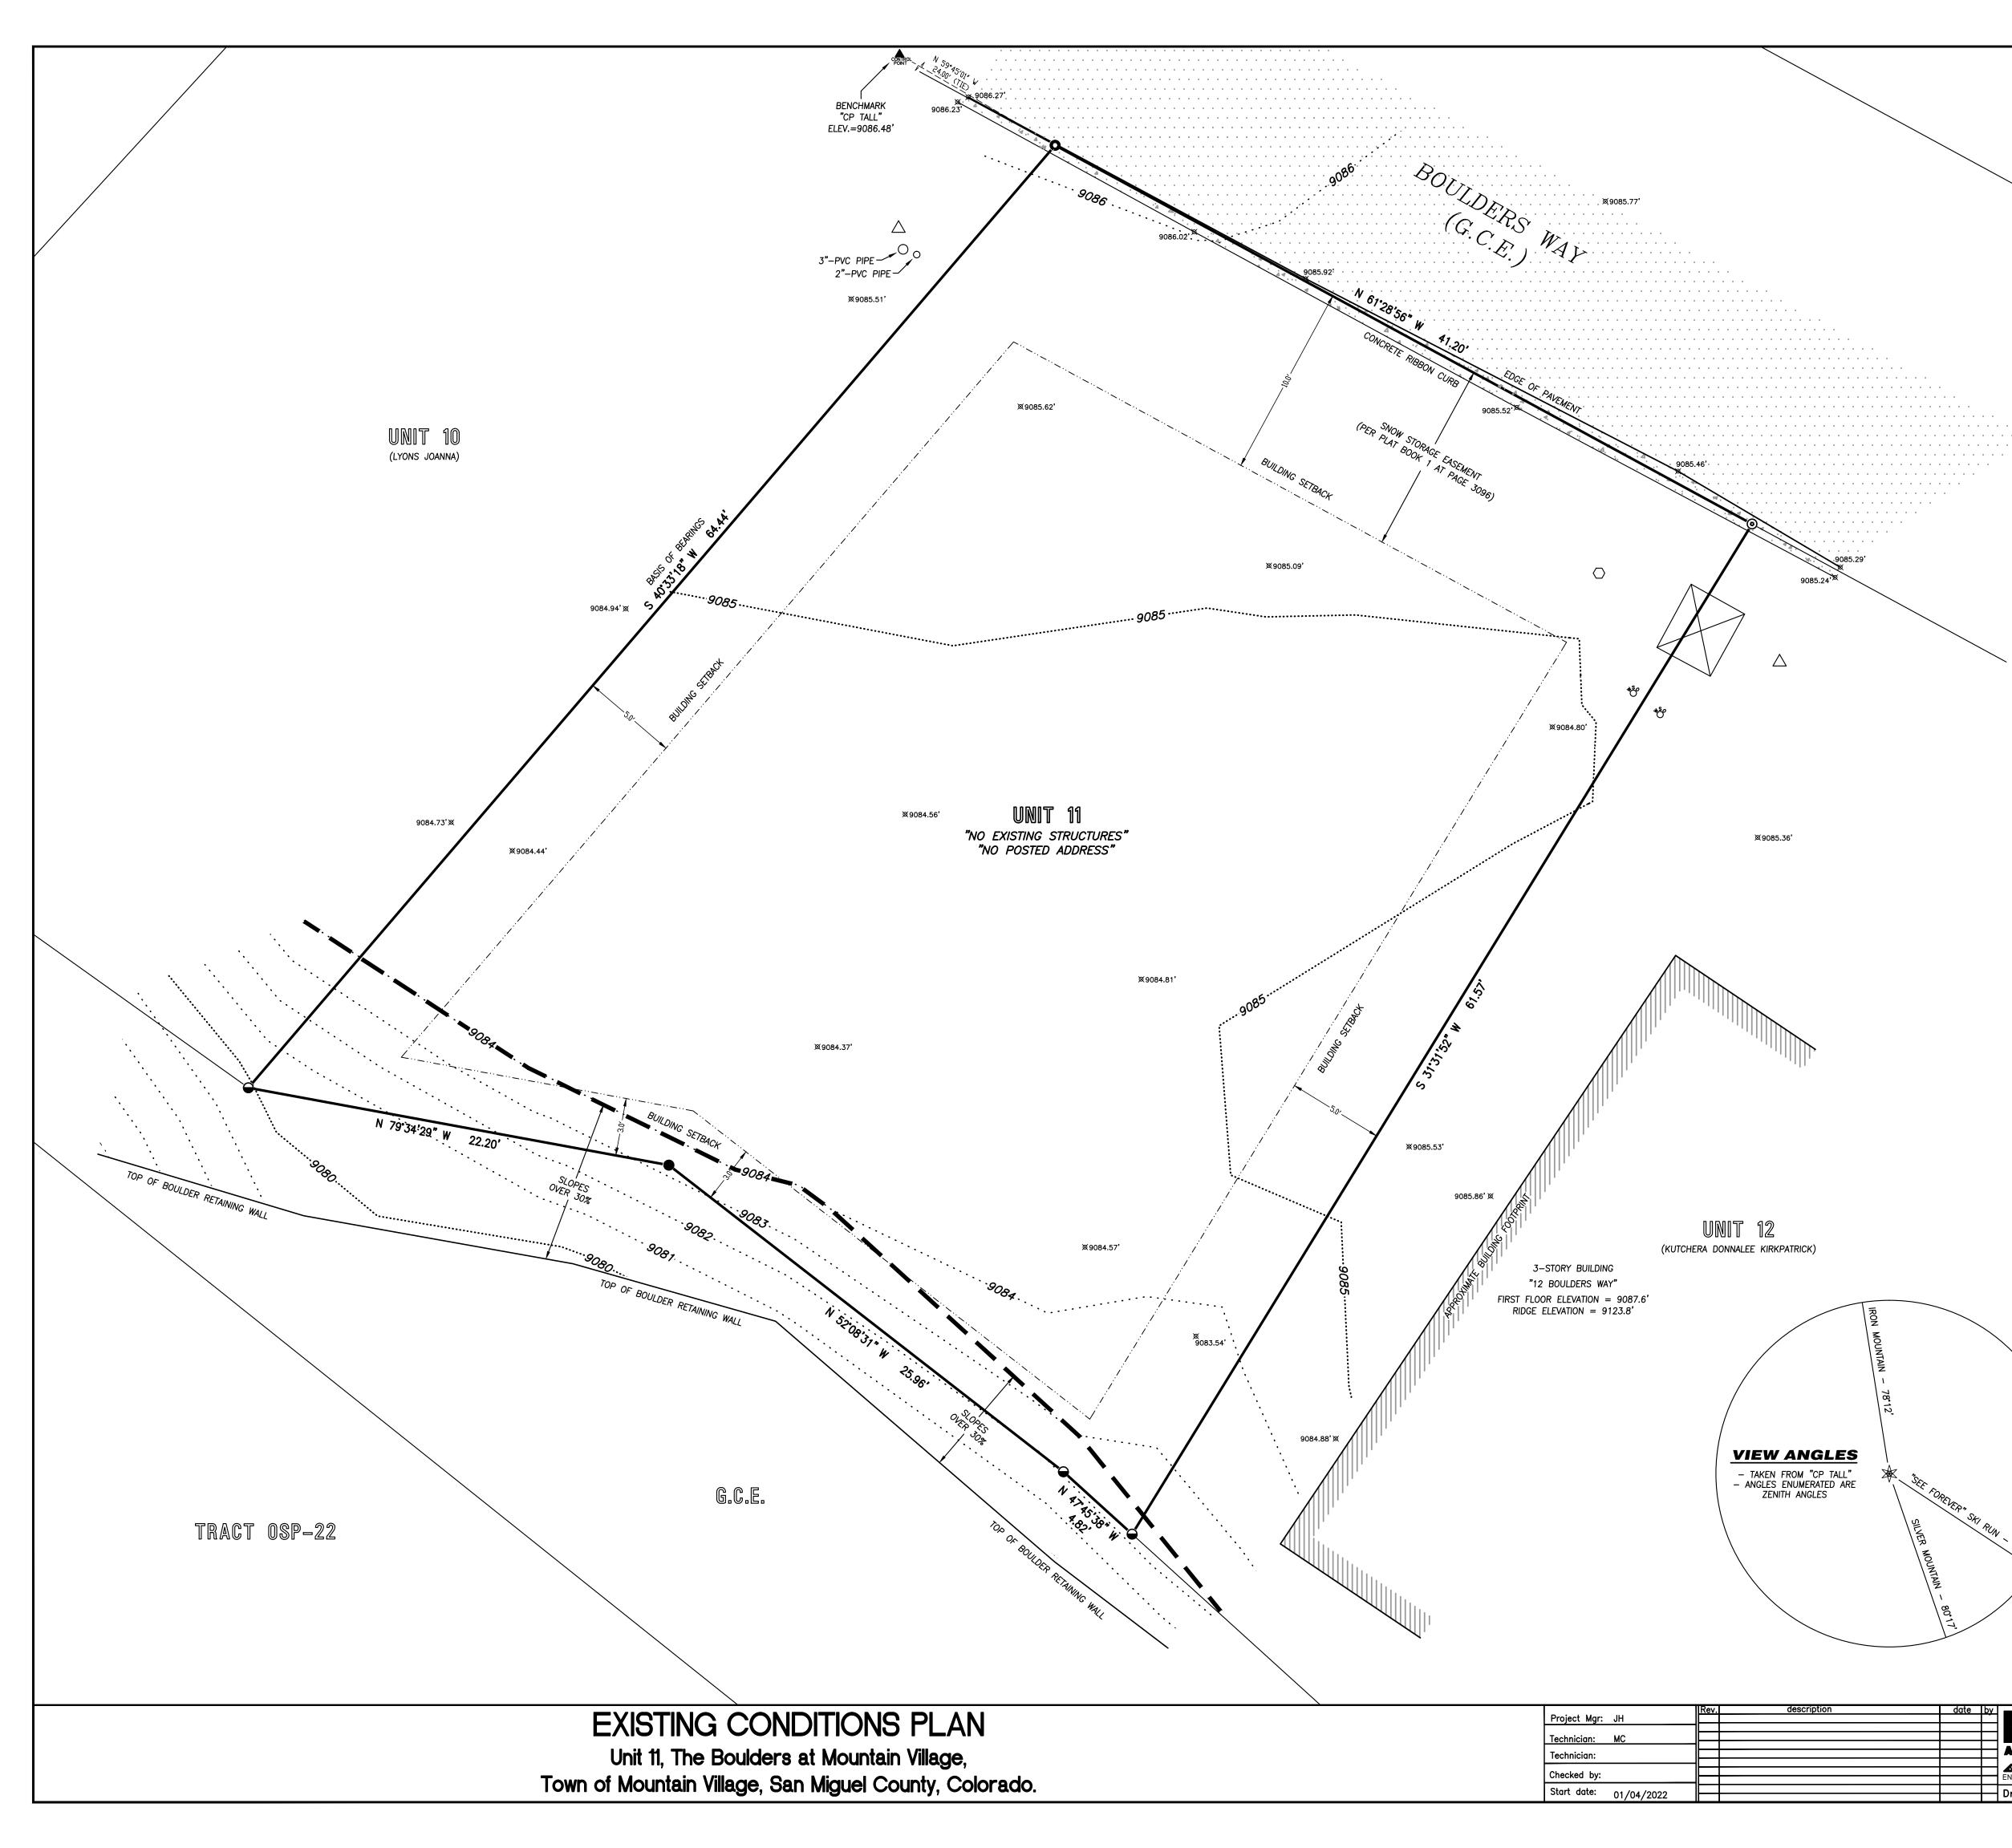This Existing Conditions Plan of Unit 11, The Boulders at Mountain Village, was prepared on January 04, 2022 under the direct responsibility, supervision and checking of Jeffrey C. Haskell of Foley Associates, Inc., being a Colorado Licensed Surveyor, " does not constitute a Land Survey Plat or Improvement Survey P as defined by section 38–51–102 C.R.S.

P.L.S. NO. 37970

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• 🛛 9085.46'

LEGAL DESCRIPTION:

UNIT 11, THE BOULDERS AT MOUNTAIN VILLAGE, ACCORDING TO THE PLAT RECORDED JANUARY 24, 2003 IN PLAT BOOK 1 AT PAGE 3096, AND AS DEFINED AND DESCRIBED IN THE DECLARATION FOR THE BOULDERS AT MOUNTAIN VILLAGE RECORDED JANUARY 24, 2003 UNDER RECEPTION NO. 354564,

COUNTY OF SAN MIGUEL, STATE OF COLORADO.

NOTES:

1. Easement research and legal description from Land Title Guarantee Company, Order No. TLR86012303, dated November 05, 2021 at 5:00 P.M.

2. According to FEMA Flood Insurance Rate Map 080168, Panel Number 0291 D, dated September 30, 1992, this parcel is within Zone X; Areas determined to be outside 500—year flood plain.

3. BASIS OF BEARINGS: Found monuments along the western boundary of Unit 11, as shown hereon, assumed to have the record bearing of S 40°33'18" W according to Plat Book 1 at page 3096.

4. Benchmark: Control Point "CP TALL", as shown hereon, with an elevation of 9086.48'.

5. Contour interval is one foot.

6. There exists a Drainage Easement according to Note 10 of the plat recorded in Plat Book 1 at page 3096.

7. There are no trees located within this lot.

8. Slopes 30% or greater are shown hereon.

9. Foley Associates, Inc. is not aware of any underground utilities located on this lot, but utility locates were not performed as part of this survey. Utility locates should be performed by respective providers before any construction.

10. Foley Associates, Inc. is not aware of any wetland areas located on this lot, but a wetland delineation was not performed as part of this survey.

11. Due to winter conditions, only visible improvements are shown on this survey. Any improvements buried under snow cover will not be shown.

12. NOTICE: According to Colorado law, you must commence any legal action based upon any defect in this survey within three years after you first discover such defect. In no event may any action based upon any defect in this survey be commenced more than ten years from the date of the certification shown hereon.

date by	FOLEY	.53 970-72 O. BOX 1385	
	ASSOCIATES, INC.	PACIFIC, SU DE, COLORAI	
	Drawing path: dwg\12020 EC Plan 01-22.dwg	Sheet1 of 1	Project #: 12020

GENERAL CIVIL ENGINEERING NOTES:

1. THE EXISTING UTILITY LINES SHOWN ON THE PLANS ARE APPROXIMATE. AT LEAST TWO (2) FULL WORKING DAYS PRIOR TO TO COMMENCING CONSTRUCTION, THE CONTRACTOR SHALL CONTACT THE UTILITY NOTIFICATION CENTER OF COLORADO @ 1-800-922-1987 OR 811 TO GET ALL UTILITIES LOCATED. IF ANY OF THESE UNDERGROUND UTILITIES ARE IN CONFLICT WITH THE CONSTRUCTION PLANS, THE CONTRACTOR SHALL NOTIFY THE ENGINEER AND WORK WITH THE ENGINEER TO FIND A SOLUTION BEFORE THE START OF CONSTRUCTION.

INSTALLATION AND SEPARATION REQUIREMENTS SHALL BE COORDINATED WITH THE INDIVIDUAL UTILITY PROVIDERS.

THE UTILITY PROVIDERS ARE: SEWER AND WATER: TOWN OF MOUNTAIN VILLAGE NATURAL GAS: BLACK HILLS ENERGY POWER: SAN MIGUEL POWER BROADBAND: CLEARNETWORX TELEPHONE: CENTURY LINK

2. PRIOR TO BEGINNING ANY CONSTRUCTION ACTIVITIES, ALL NECESSARY PERMITS SHALL BE OBTAINED BY THE OWNER OR CONTRACTOR.

3. IT IS THE CONTRACTOR'S RESPONSIBILITY TO INSURE THAT EXCAVATED SLOPES ARE SAFE AND COMPLY WITH OSHA REQUIRIEMENTS. REFER TO THE SITE—SPECIFIC REPORT FOR THIS PROJECT FOR ADDITIONAL INFORMATION..

4. ALL TRENCHES SHALL BE ADEQUATELY SUPPORTED OR LAID BACK PER OSHA REGULATIONS.

5. ALL MATERIALS AND CONSTRUCTION SHALL BE IN CONFORMANCE WITH THE TOWN OF MOUNTAIN VILLAGE DESIGN STANDARDS LATEST EDITION. ALL CONSTRUCTION WITHIN EXISTING STREET OR ALLEY RIGHT—OF—WAY SHALL BE SUBJECT TO TOWN OF MOUNTAIN VILLAGE INSPECTION.

6. THE CONTRACTOR SHALL HAVE ONE COPY OF THE STAMPED PLANS ON THE JOB SITE AT ALL TIMES.

7. THE CONTRACTOR SHALL NOTIFY THE TOWN 48 HOURS PRIOR TO THE START OF CONSTRUCTION.

8. THE CONTRACTOR IS RESPONSIBLE FOR IMPLEMENTING AND MAINTAINING EROSION AND SEDIMENT CONTROL MEASURES AT ALL TIMES DURING CONSTRUCTION. THE ADJOINING ROADWAYS SHALL BE FREE OF DEBRIS AT THE END OF CONSTRUCTION ACTIVITIES EACH DAY.

9. THE CONTRACTOR SHALL PROVIDE, ERECT AND MAINTAIN PROPER TRAFFIC CONTROL DEVICES UNTIL THE SITE IS OPEN TO TRAFFIC. ANY TRAFFIC CLOSURES MUST BE COORDINATED WITH THE TOWN OF MOUNTAIN VILLAGE.

10. ALL DAMAGE TO PUBLIC STREETS AND ROADS, INCLUDING HAUL ROUTES, TRAILS, OR STREET IMPROVEMENTS, OR TO PRIVATE PROPERTY, SHALL BE REPAIRED AT THE SOLE EXPENSE OF THE CONTRACTOR TO THE ORIGINAL CONDITIONS.

11. WHEN AN EXISTING ASPHALT STREET IS CUT, THE STREET MUST BE RESTORED TO A CONDITION EQUAL TO OR BETTER THAN ITS ORIGINAL CONDITION. THE FINISHED PATCH SHALL BLEND SMOOTHLY INTO THE EXISTING SURFACE. ALL LARGE PATCHES SHALL BE PAVED WITH AN ASPHALT LAY—DOWN MACHINE.

12. IF DEWATERING IS REQUIRED, THE CONTRACTOR SHALL NOTIFY THE ENGINEER. ANY DISCHARGE REQUIREMENTS SHALL BE COORDINATED WITH THE TOWN OF MOUNTAIN VILLAGE.

13. CONTRACTOR SHALL NOTIFY ALL RESIDENTS IN WRITING 24 HOURS PRIOR TO ANY SHUT-OFF IN SERVICE. THE NOTICES MUST HAVE CONTRACTOR'S PHONE NUMBER AND NAME OF CONTACT PERSON, AND EMERGENCY PHONE NUMBER FOR AFTER HOURS CALLS. ALL SHUT-OFF'S MUST BE APPROVED BY THE TOWN AND TOWN VALVES AND APPURTENANCES SHALL BE OPERATED BY TOWN PERSONNEL.

14. CONTRACTOR SHALL KEEP SITE CLEAN AND LITTER FREE (INCLUDING CIGARETTE BUTTS) BY PROVIDING A CONSTRUCTION DEBRIS TRASH CONTAINER AND A BEAR—PROOF POLY—CART TRASH CONTAINER, WHICH IS TO BE LOCKED AT ALL TIMES.

15. CONTRACTOR MUST BE AWARE OF ALL TREES TO REMAIN PER THE DESIGN AND APPROVAL PROCESS AND PROTECT THEM ACCORDINGLY.

16. THE CONTRACTOR SHALL PROVIDE UNDERGROUND UTILITY AS-BUILTS TO THE TOWN.

17. ALL STRUCTURAL FILL UNDER HARDSCAPE OR ROADS MUST BE COMPACTED TO 95% MODIFIED PROCTOR (MIN.) AT PLUS OR MINUS 2% OF THE OPTIMUM MOISTURE CONTENT. NON—STRUCTURAL FILL SHALL BE PLACED AT 90% (MIN.) MODIFIED PROCTOR.

18. UNSUITABLE MATERIAL SHALL BE REMOVED AS REQUIRED BY THE SOILS ENGINEER. ALL MATERIALS SUCH AS LUMBER, LOGS, BRUSH, TOPSOIL OR ORGANIC MATERIALS OR RUBBISH SHALL BE REMOVED FROM ALL AREAS TO RECEIVE COMPACTED FILL.

19. NO MATERIAL SHALL BE COMPACTED WHEN FROZEN.

20. NATIVE TOPSOIL SHALL BE STOCKPILED TO THE EXTENT FEASIBLE ON THE SITE FOR USE ON AREAS TO BE REVEGETATED.

21. THE CONTRACTOR SHALL BE RESPONSIBLE FOR DUST ABATEMENT AND EROSION CONTROL MEASURES DEEMED NECESSARY BY THE TOWN, IF CONDITIONS WARRANT THEM.


22. ALL DISTURBED GROUND SHALL BE RE-SEEDED WITH A TOWN-APPROVED SEED MIX. REFER TO THE LANDSCAPE PLAN.

23. THE CONTRACTOR IS REQUIRED TO PROTECT ALL EXISTING SURVEY MONUMENTS AND PROPERTY CORNERS DURING GRADING AND CONSTRUCTION.


24. ALL UNDERGROUND PIPE SHALL BE PROTECTED WITH BEDDING TO PROTECT THE PIPE FROM BEING DAMAGED.


25. HOT TUBS SHALL DRAIN TO THE SANITARY SEWER (OR PUMPED TO AA CLEAN-OUT).


26. THE UTILITY PLAN DEPICTS FINAL UTILITY LOCATIONS BUT HAS BEEN COMPLETED AT A PRELIMINARY STAGE. CONTRACTOR SHALL VERIFY ALIGNMENTS WITH THE ARCHITECT PRIOR TO CONSTRUCTION.

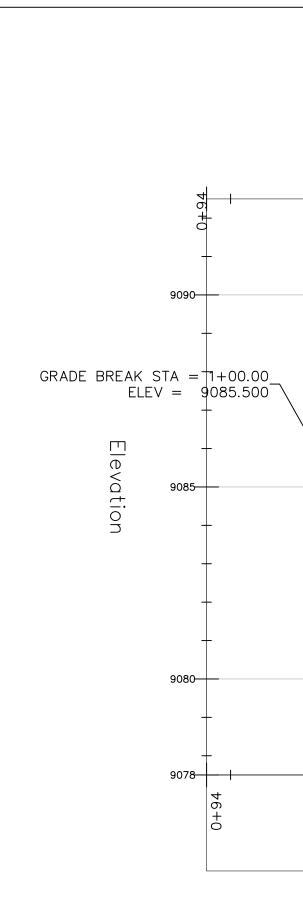


	Uncompahgre Engineering, LLC
	P.O. Box 3945 Telluride, CO 81435 970-729-0683
	SUBMISSIONS: DRB 2024-04-30
	Menhard Residence Lot 11 The Boulders Mtn. Village, CO
Driveway Profile Station	NOTHER OF SOUTH AND LASS THOM
	CONTRACTOR TO REVIEW AND COMPARE ALL CHAPTERS AND INTERDISCIPLINARY DRAWINGS AND REPORT ANY DISCREPANCIES TO THE ARCHITECT PRIOR TO ANY FIELD WORK BEING DONE IN ACCORDANCE WITH AIA DOCUMENT A201
CRADE BREAK STA = 1+18.85 ELEV = 9086.000 9085	Notes
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1+00 1+25	

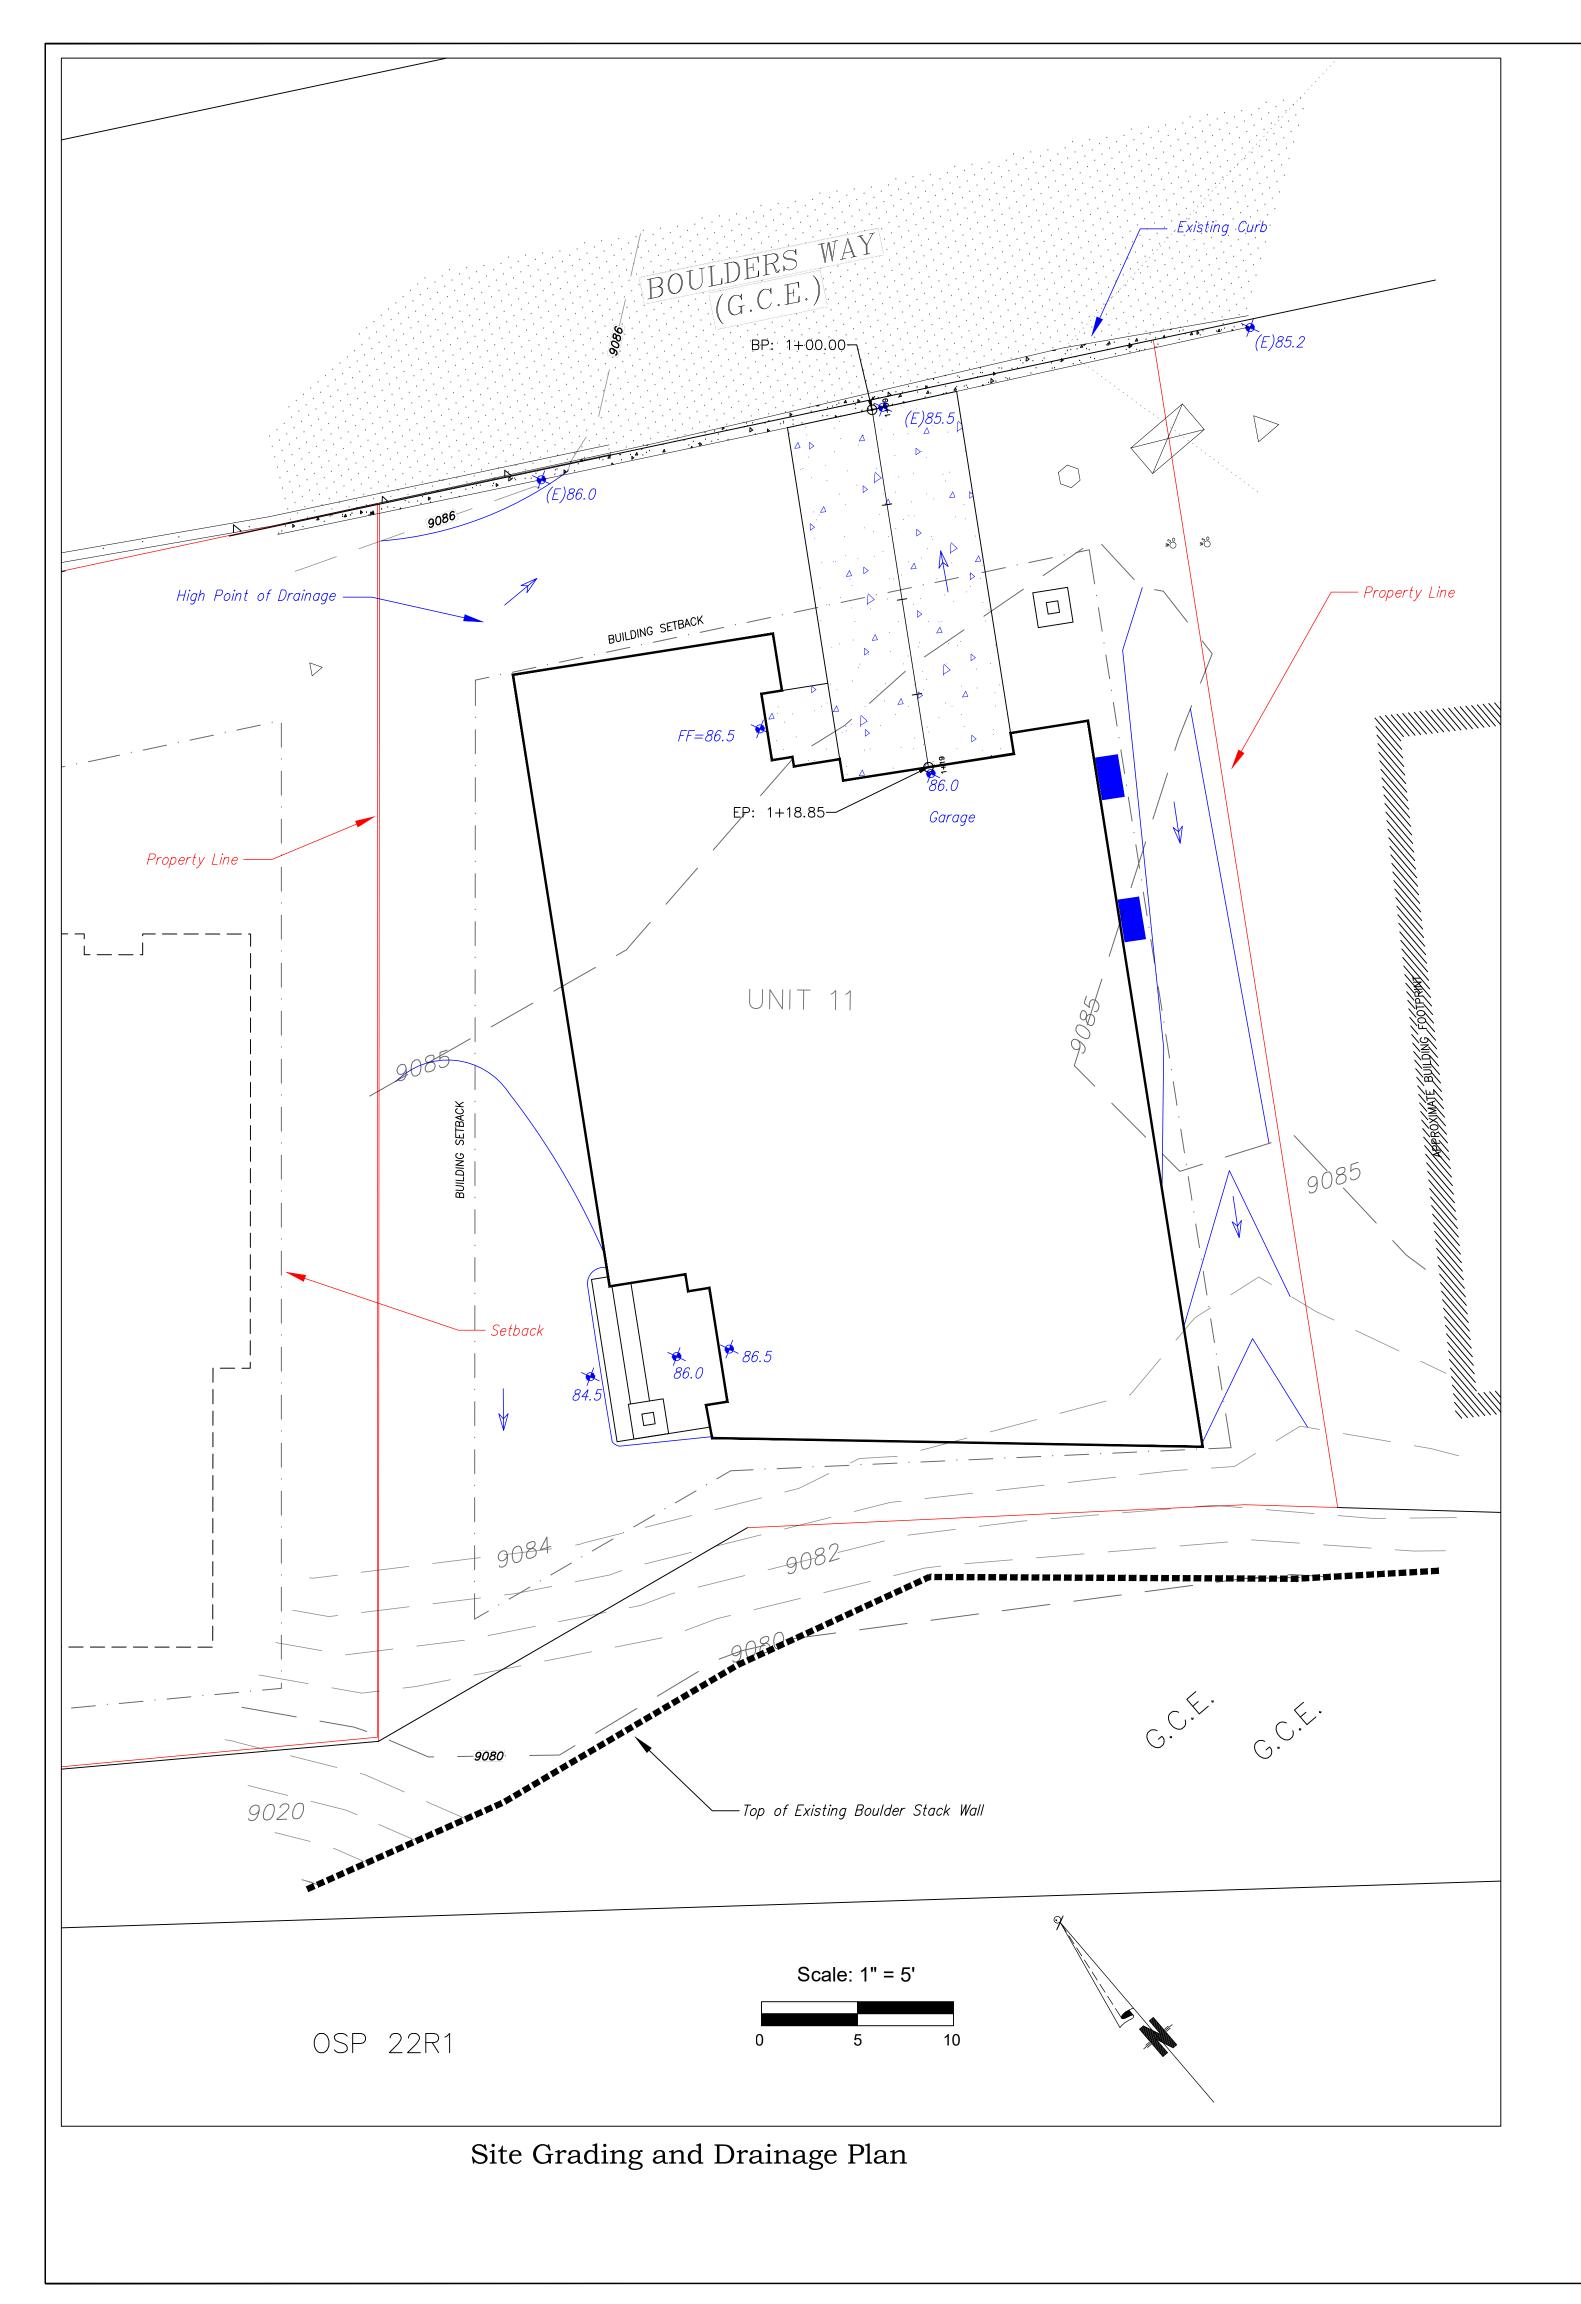

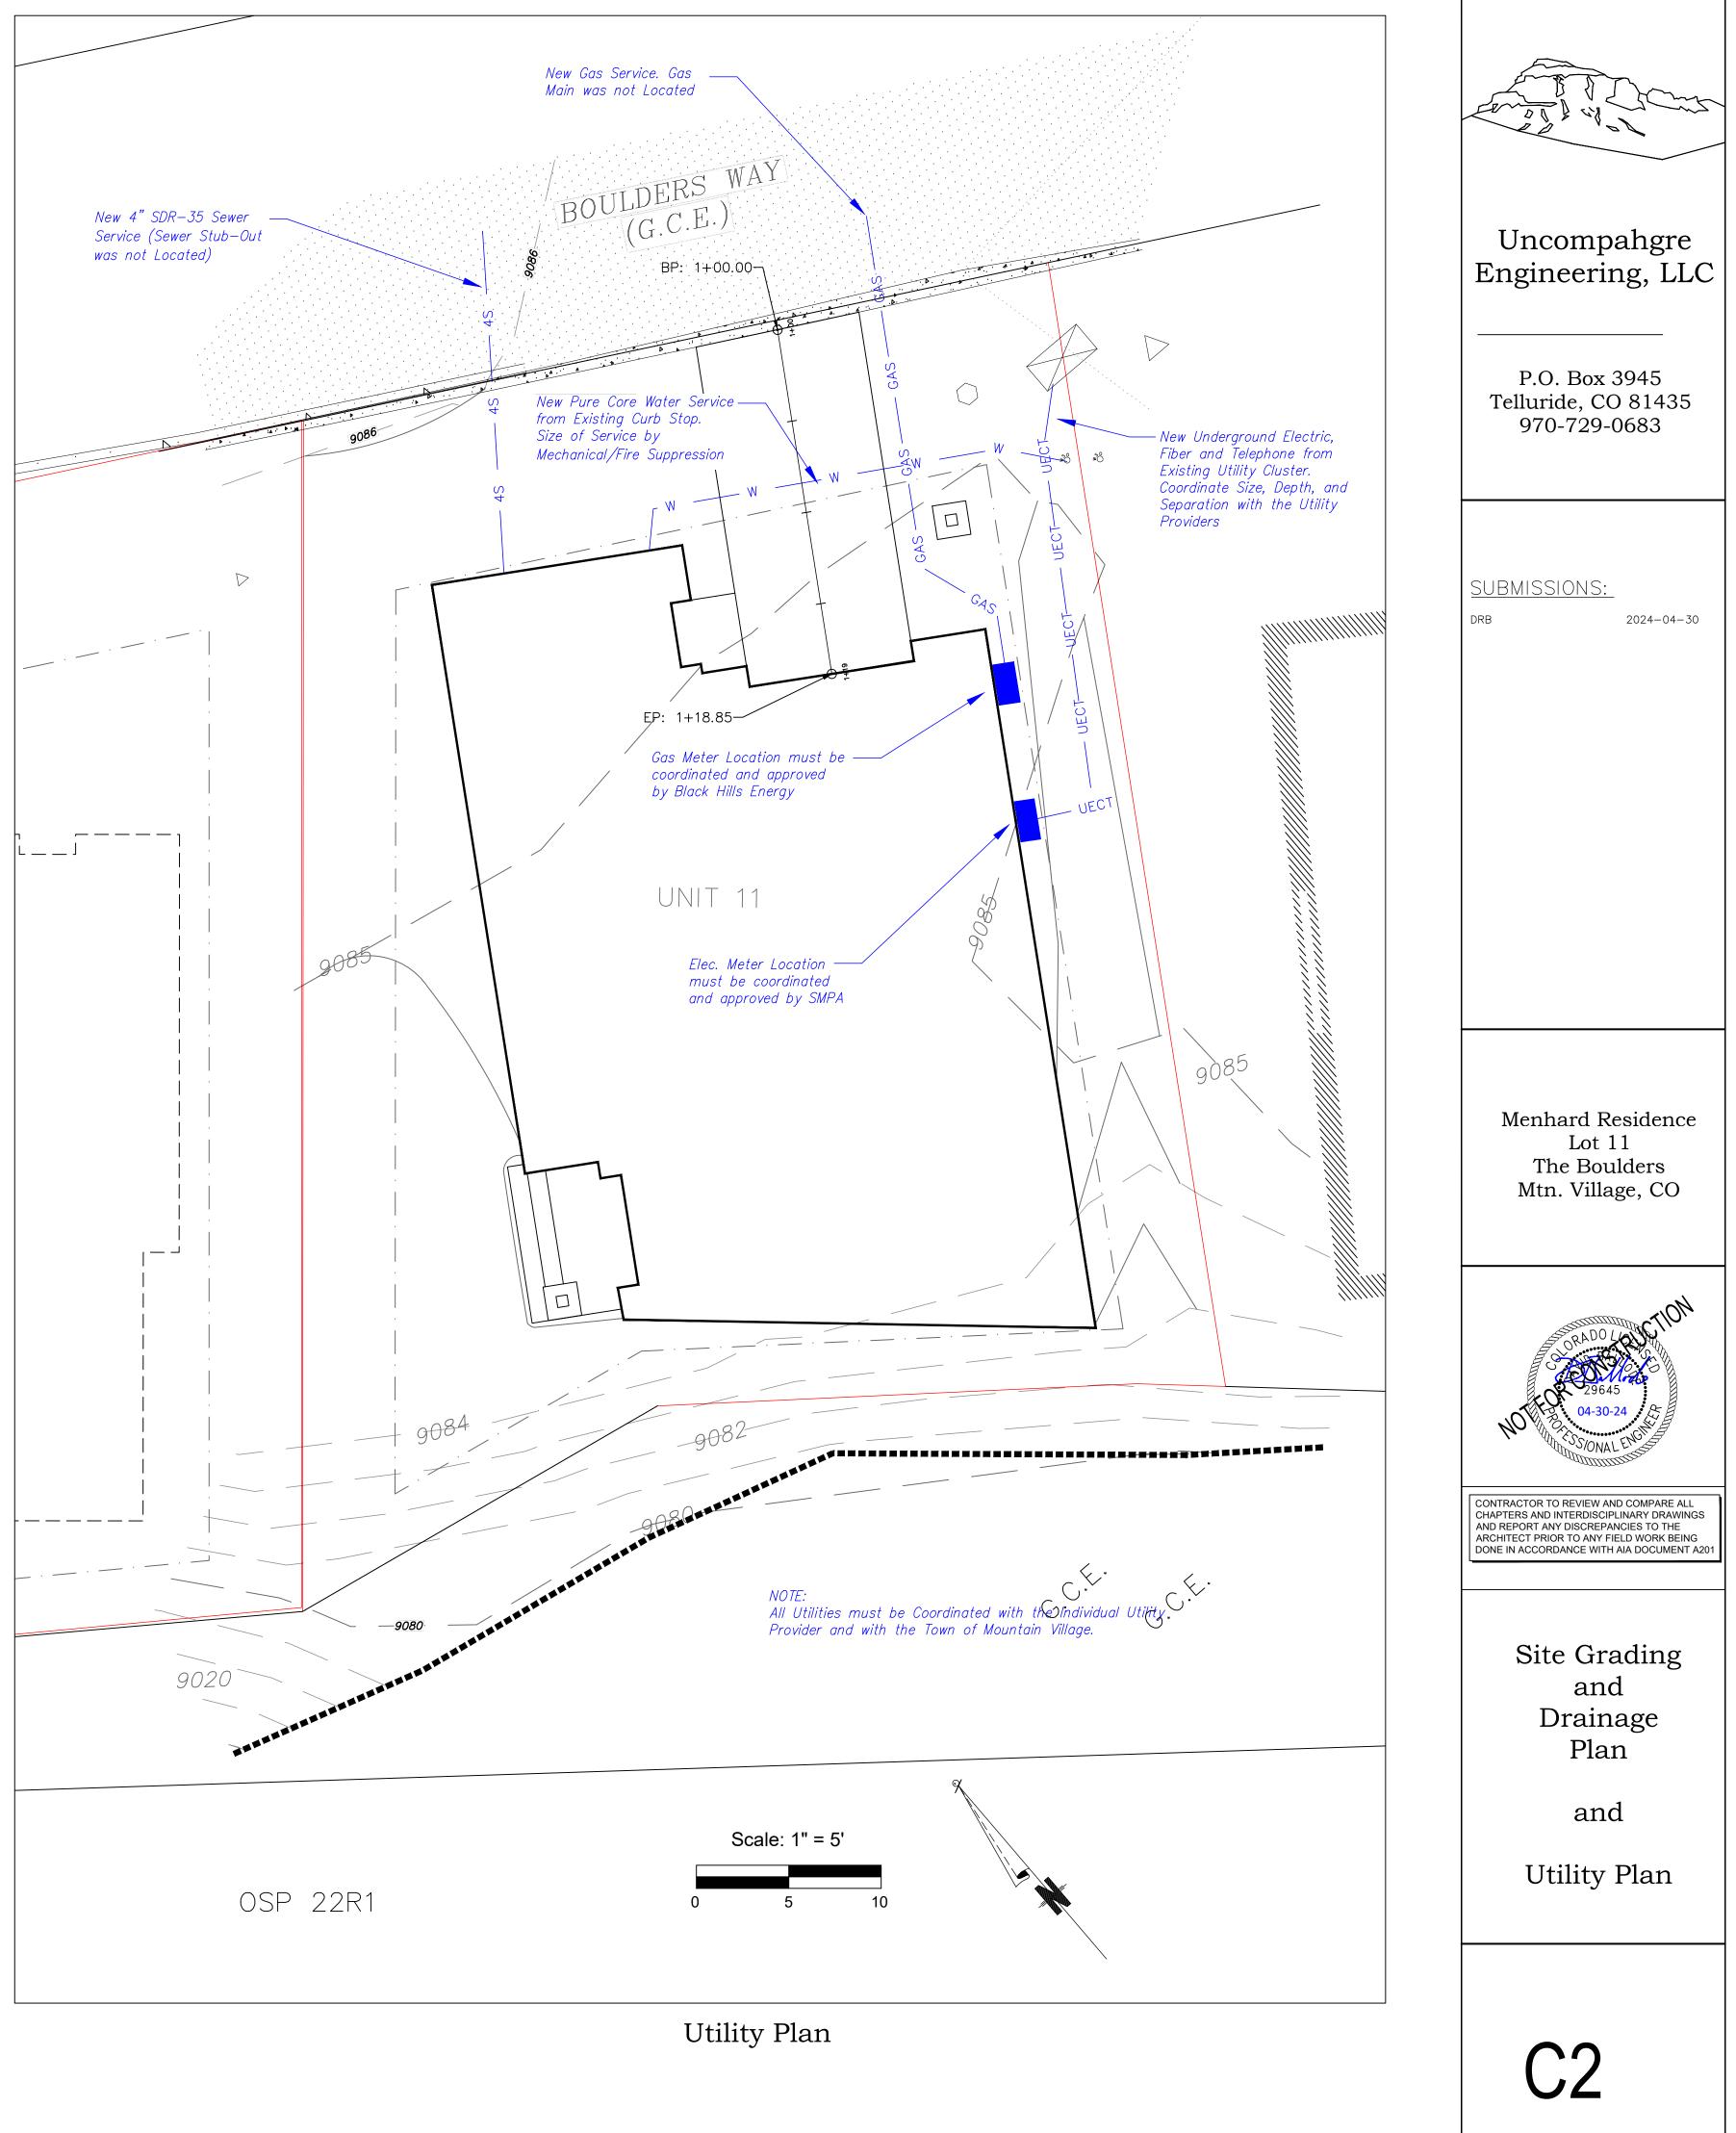

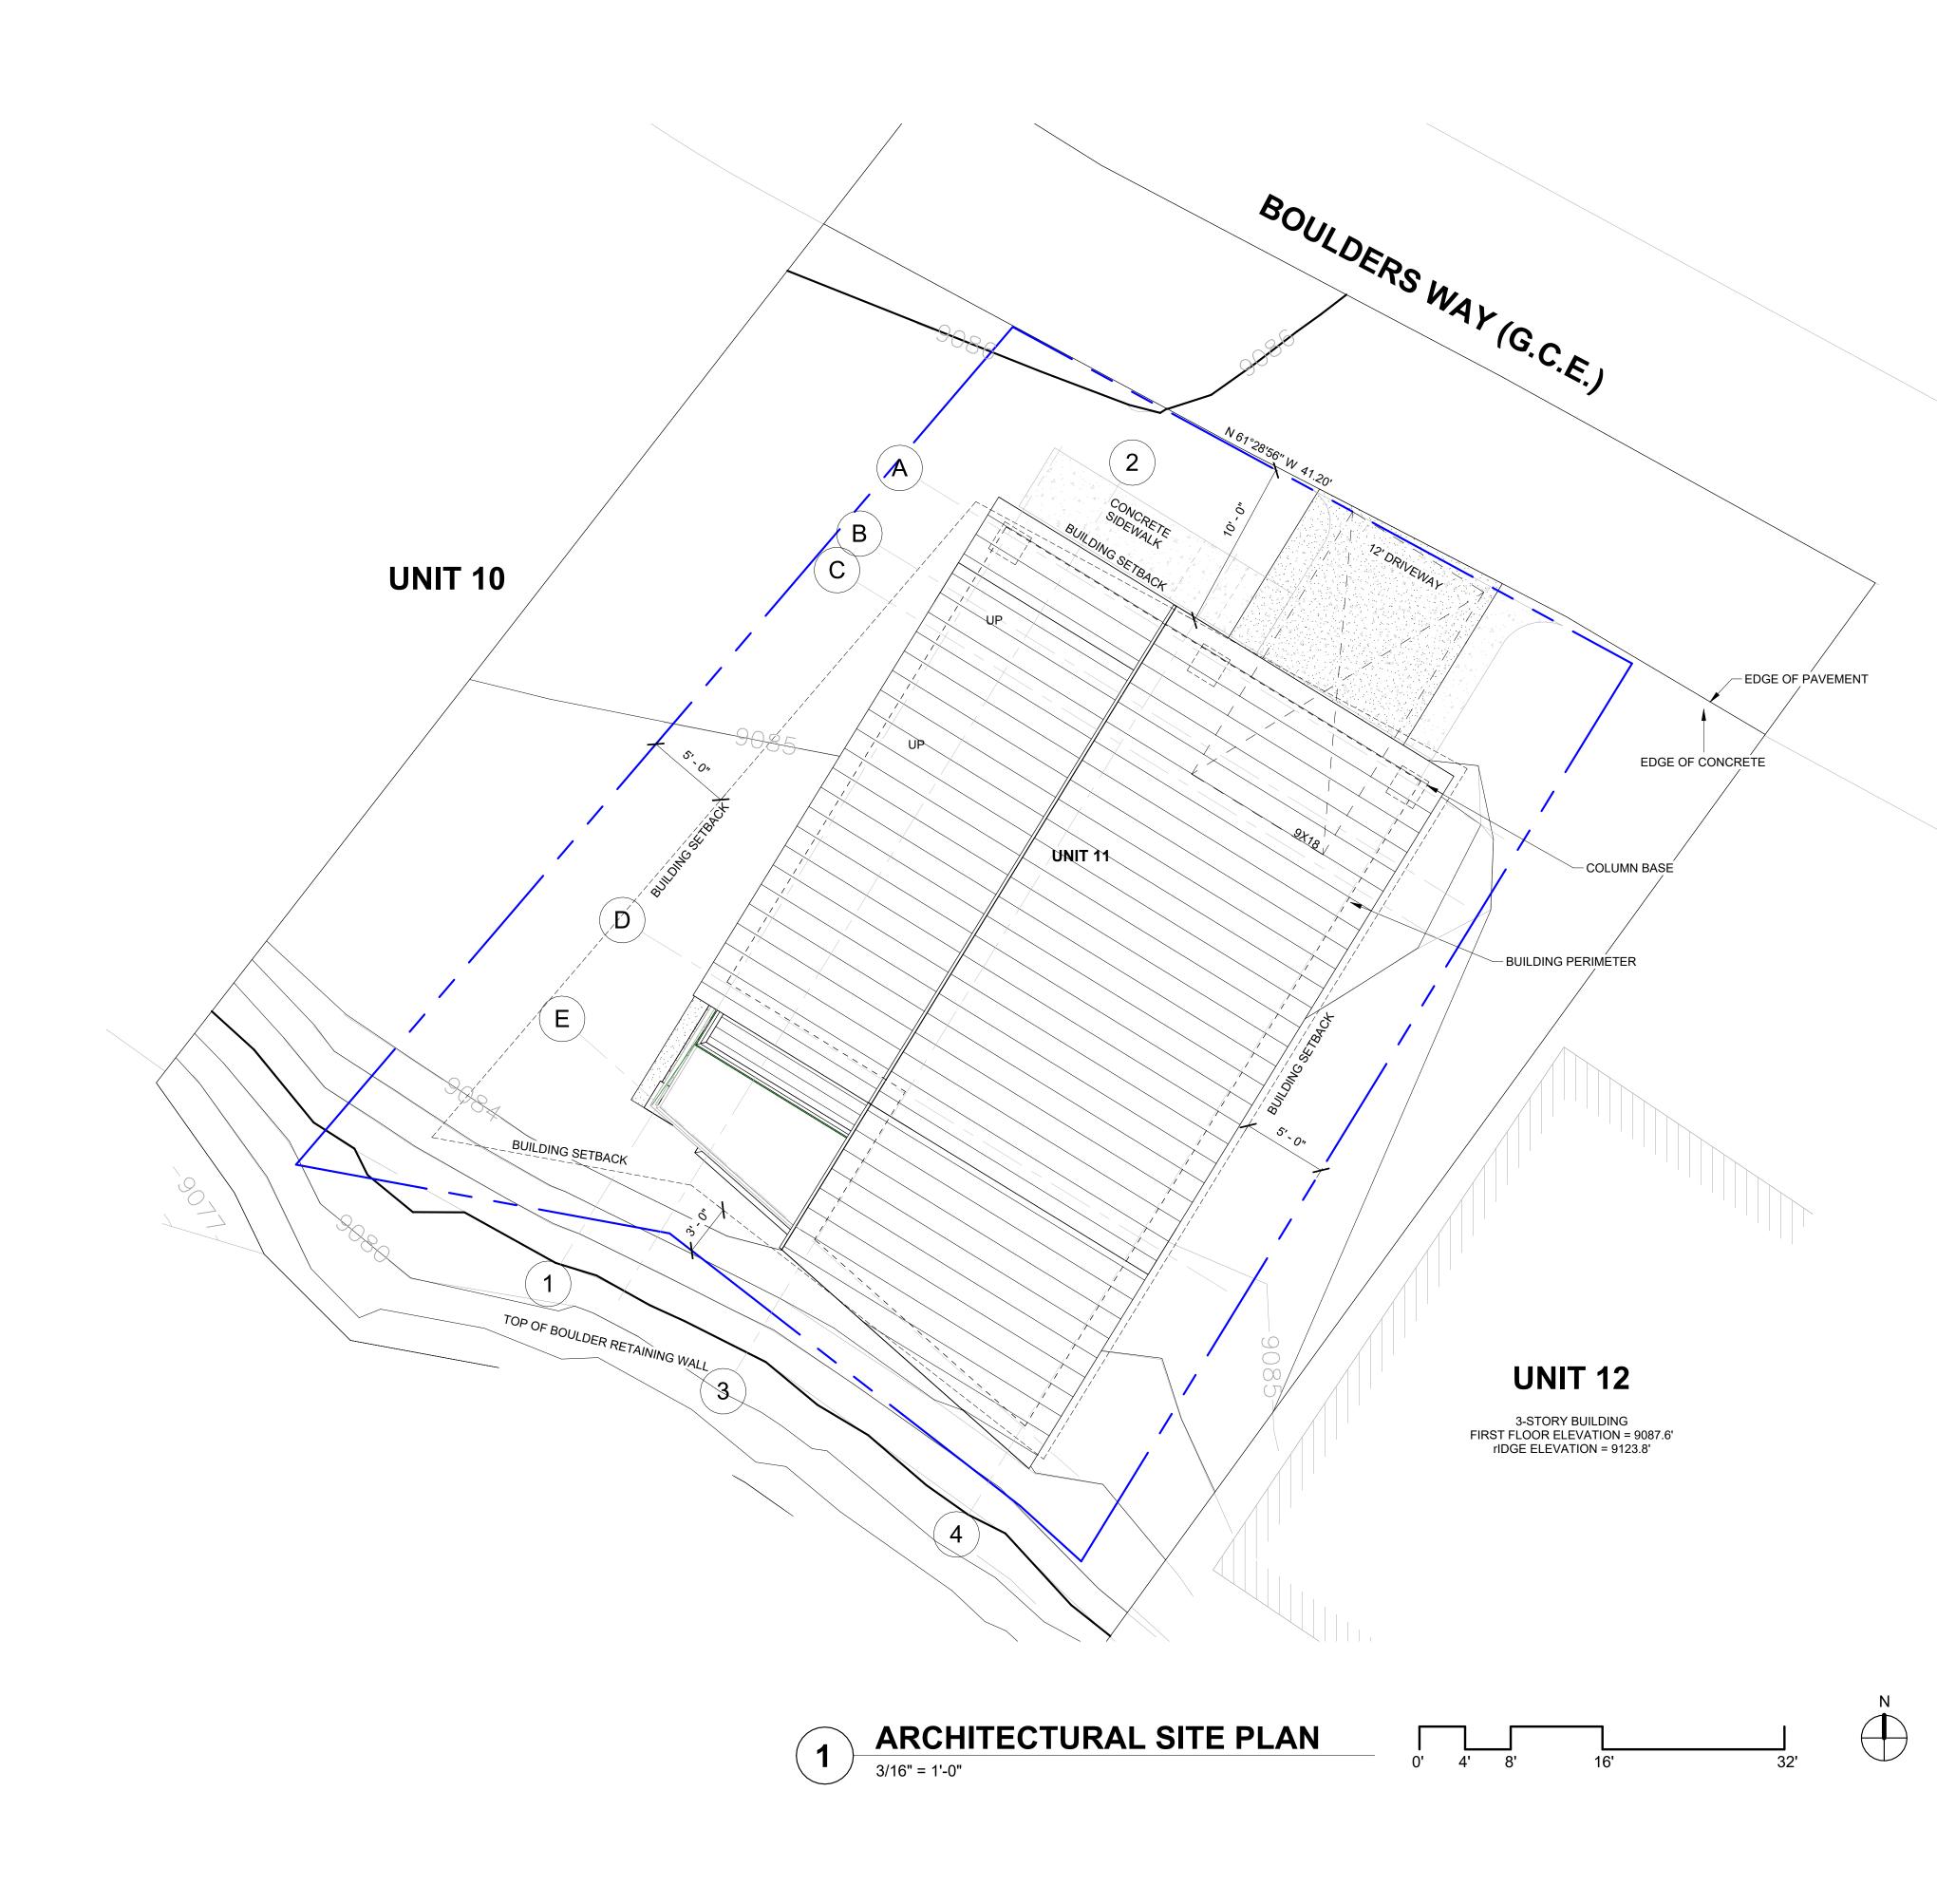

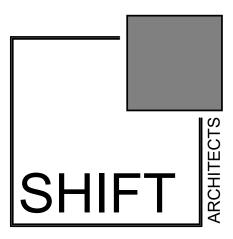


PROJECT ISSUE DATE: 02.20.24 REVISED DRB SUBMITTAL




oulders Way, Mountain Village elluride, CO 81435, USA

ARCHITECTURAL SITE PLAN



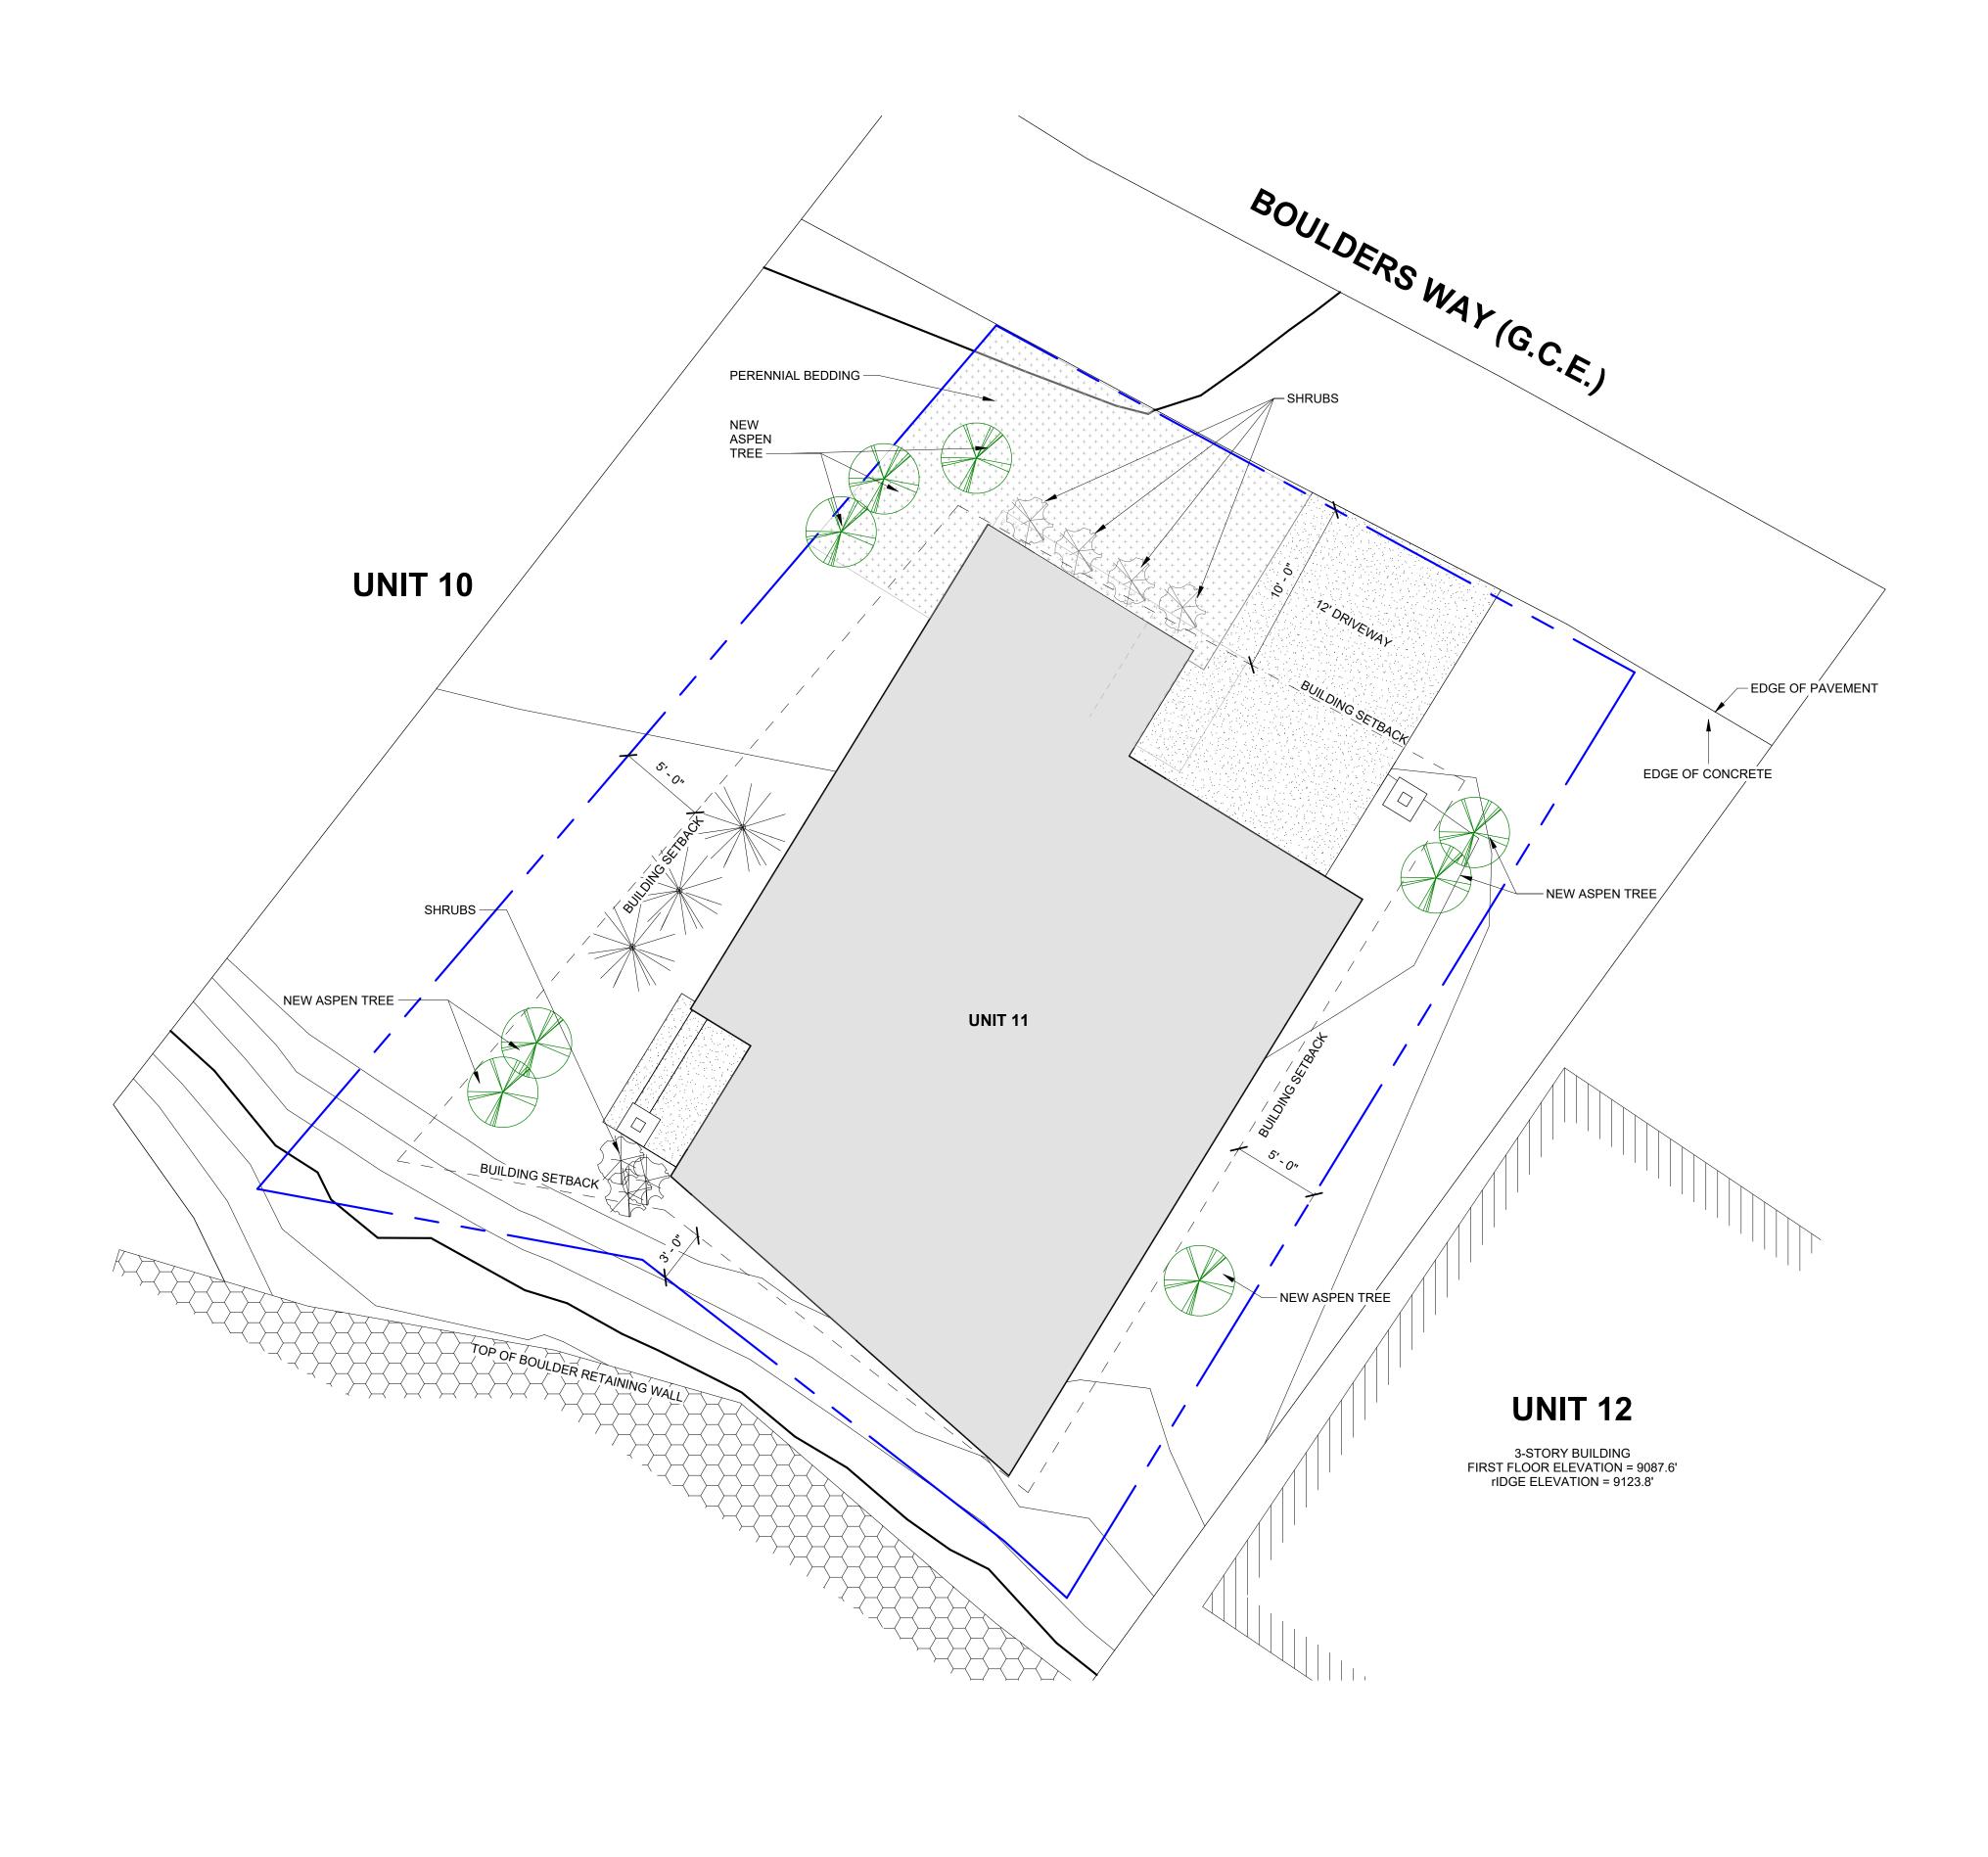

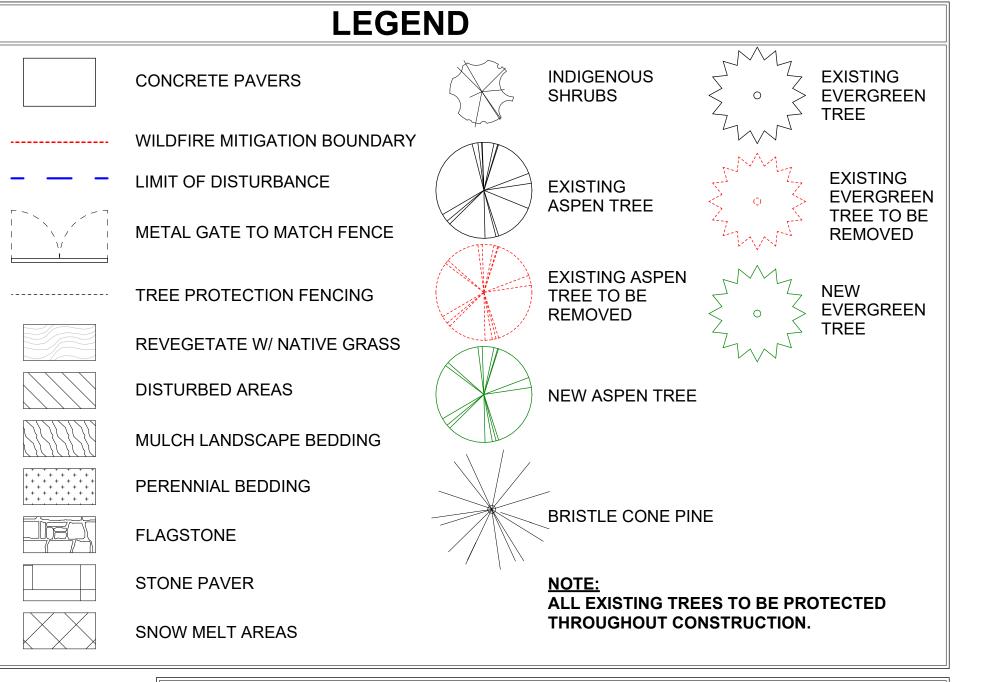

NOXIOUS WEEDS:

REVEGETATION NOTES:

RATE OF 12 LBS. PER ACRE. SPECIES PURE LIVE SEED PER ACRE WESTERN YARROW 5% TALL FESCUE 10% ARIZONA FESCUE 5% HARD FESCUE 5% CREEPING RED FESCUE 10% ALPINE BLUEGRASS 15% CANADA BLUEGRASS 10% 15% PERENNIAL RYEGRASS SLENDER WHEATGRASS 10% MOUNTAIN BROME 15% **PLANT SCHEDULE** COMMON NAME <u>QTY</u> **BOTANICAL NAME** <u>SIZE</u> POPULUS TREMULOIDES

16'

PINUS ARISTATA

WOODS ROSE PERENNIALS - BED A PERENNIALS - BED B

0' 4' 8'



GENERAL NOTES:

1. ALL TREES AND SHRUBS TO BE LOCATED BY PROJECT ARCHITECT / OWNER. 2. ALL TREES AND SHRUBS SHALL BE BACKED FILLED WITH A TOPSOIL / ORGANIC FERTILIZER MIXTURE AT A 2:1 RATIO.

3. NECESSARY TREES SHALL BE STAKED WITH 4' METAL POSTS. TREES SHALL BE GUYED WITH 12 GAUGE GALVANIZED WIRE AND POLYPROPYLENE TREE RACE STRIPS 4. PERENNIAL PLANTING BEDS SHALL BE TILLED 6" DEPTH AND AMENDED WITH TOPSOIL AND ORGANIC FERTILIZER AT A 2:1 RATIO.

5. SEE PLANTING DETAILS FOR ALL DECIDUOUS AND EVERGREEN TREES. 6. MULCH ALL PERENNIAL BEDS WITH A PINE BARK SOIL CONDITIONER BY SOUTHWEST IMPORTERS; SHREDDED CEDAR BARK.

7. ALL PLANT MATERIAL TO MEET THE AMERICAN STANDARD FOR NURSERY STOCK. 8. LANDSCAPING AND TREE REMOVAL SHALL BE IN ACCORDANCE WITH DECLARATION OF CONDOMINIUM FOR KNOLL ESTATES, A CONDOMINIUM AND TOWN OF MOUNTAIN VILLAGE CDC 17.5.9 LANDSCAPING REGULATIONS AND CDC 17.6.1 ENVIRONMENTAL REGULATIONS.

1. ALL PLANTED MATERIALS INCLUDING SEEDS, SHALL BE NON NOXIOUS SPECIES AS SPECIFIED IN THE NOXIOUS WEED CDC TABLE 5-5 OR SUBSEQUENTLY DESIGNATED AS A NOXIOUS WEED BY THE STATE OF COLORADO, OR THE TOWN LANDSCAPE MAINTENANCE NOTES:

1. TURF SHALL BE AERATED 2 TO 3 TIMES PER YEAR TO INCREASE THE WATER ABSORPTION RATE. NECESSARY ORGANIC FERTILIZATION AND AMENDMENT SHALL BE INCORPORATED AT THE SAME TIME. 2. NECESSARY ORGANIC FERTILIZERS AND AMENDMENT SHALL BE ADDED TO PERENNIAL

BEDS SEASONALLY ALONG WITH MULCH. 3. ALL SHRUBS IN SNOW SHED AREAS TO BE CUT BACK IN FALL TO 12"-18" IN HEIGHT.

4. IRRIGATION SYSTEM TO BE BLOWN OUT BY OCTOBER 31ST EACH FALL AND TURNED ON BY JUNE 1ST EACH SPRING.

1. SUBSOIL SURFACE SHALL BE TILLED TO A 4" DEPTH ON NON FILL AREAS.


2. TOPSOIL SHALL BE SPREAD AT A MINIMUM DEPTH OF 4" OVER ALL AREAS TO BE REEMITTED (EXCEPT ON SLOPES GREATER THAN 3:1) AND AMENDMENTS ROTOTILLED AT A RATE OF THREE CUBIC YARDS PER THOUSAND SQUARE FEET. 3. BROADCASTING OF SEED SHALL BE DONE IMMEDIATELY AFTER TOPSOIL IS APPLIED

(WITHIN 10 DAYS) TO MINIMIZE EROSION AND WEEDS. 4. AREAS WHICH HAVE BEEN COMPACTED OR ARE RELATIVELY UNDISTURBED NEEDING

SEEDING, SHALL BE SCARIFIED BEFORE BROADCASTING OF SEED. 5. BROADCASTING WITH SPECIFIED SEED MIX AND FOLLOW WITH DRY MULCHING, STRAW OR HAY SHALL BE UNIFORMLY APPLIED OVER SEEDED AREA AT A RATE OF 1.5 TONS PER ACRE FOR HAY OR 2 TONS PER ACRE FOR STRAW, CRIMP IN.

6. ON SLOPES GREATER THAN 3:1 EROSION CONTROL BLANKET SHALL BE APPLIED IN PLACE OF STRAW MULCH AND PINNED.

7. ALL UTILITY CUTS SHALL BE REVEGETATED WITHIN TWO WEEKS AFTER INSTALLATION OF UTILITIES TO PREVENT WEED INFESTATION. 8. SEED ALL AREAS LABELED NATIVE GRASS SEED WITH THE FOLLOWING MIXTURE AT A

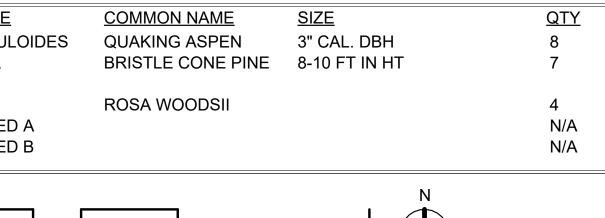

32'

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P.O. Box 3206 100 W. Colorado Suite 211 Telluride, Colorado 81435 p 970-728-8145 kristine@shift-architects.com www.shift-architects.com

PROJECT ISSUE DATE: 02.20.24 REVISED DRB SUBMITTAL

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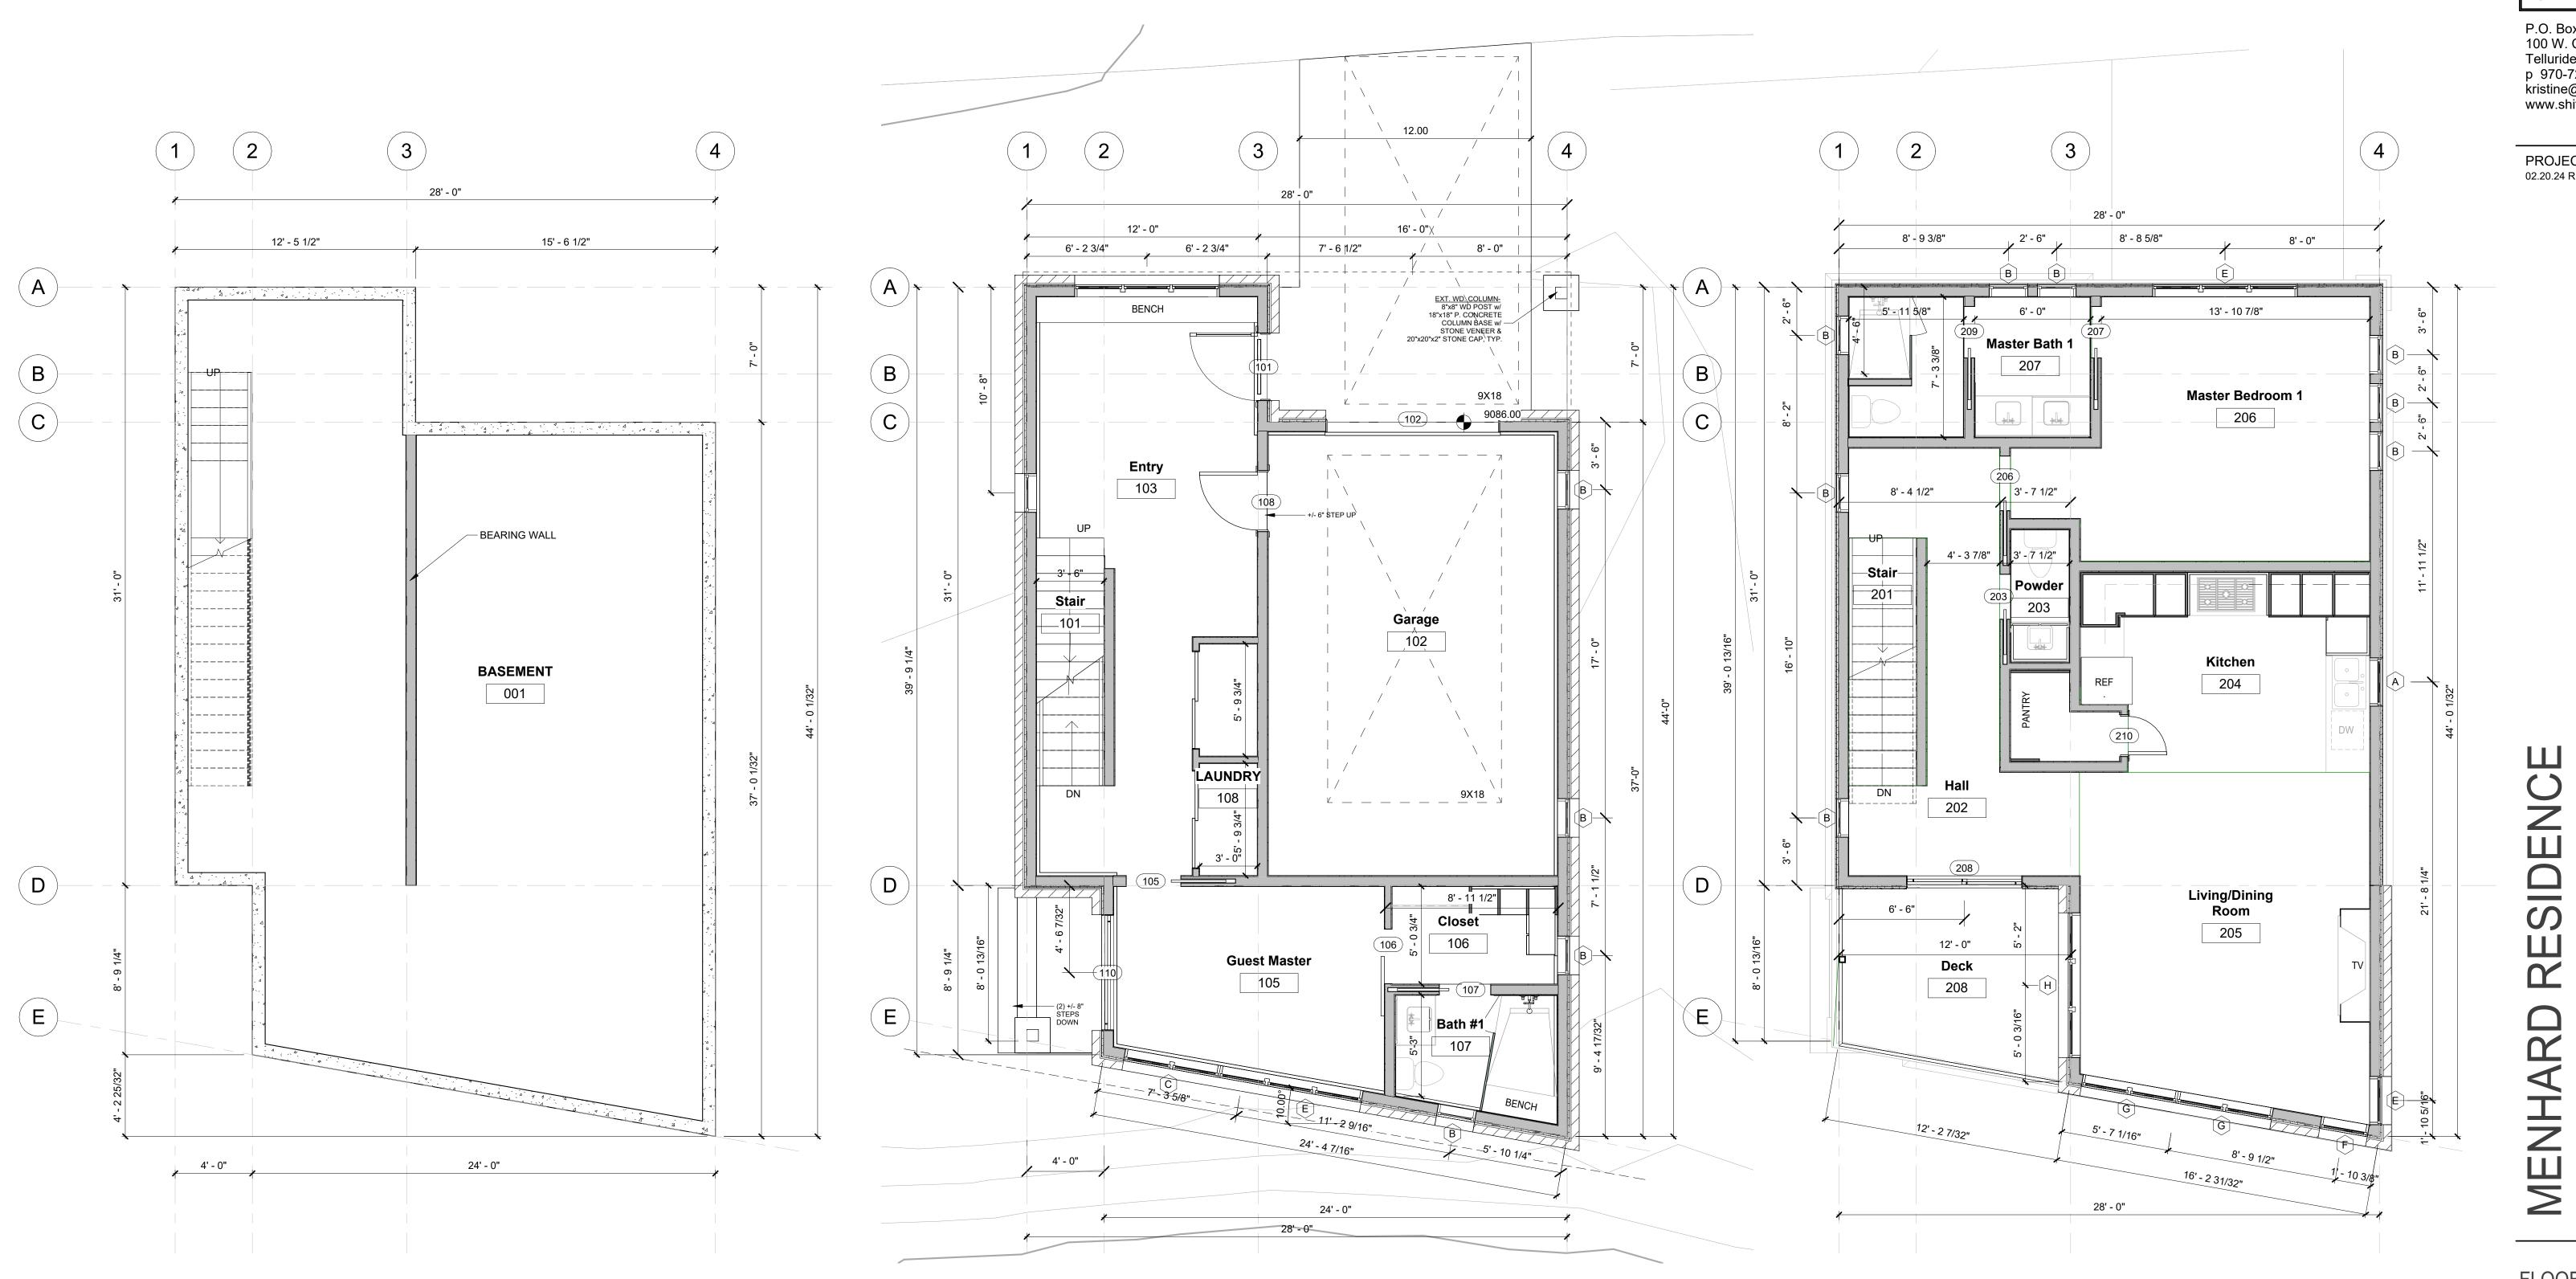
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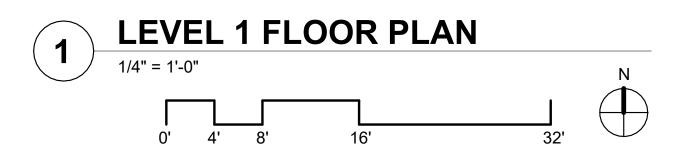
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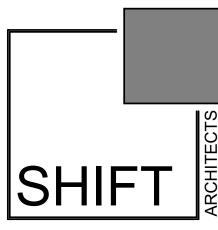












P.O. Box 3206 100 W. Colorado Suite 211 Telluride, Colorado Suite 211 Telluride, Colorado 81435 p 970-728-8145 kristine@shift-architects.com www.shift-architects.com

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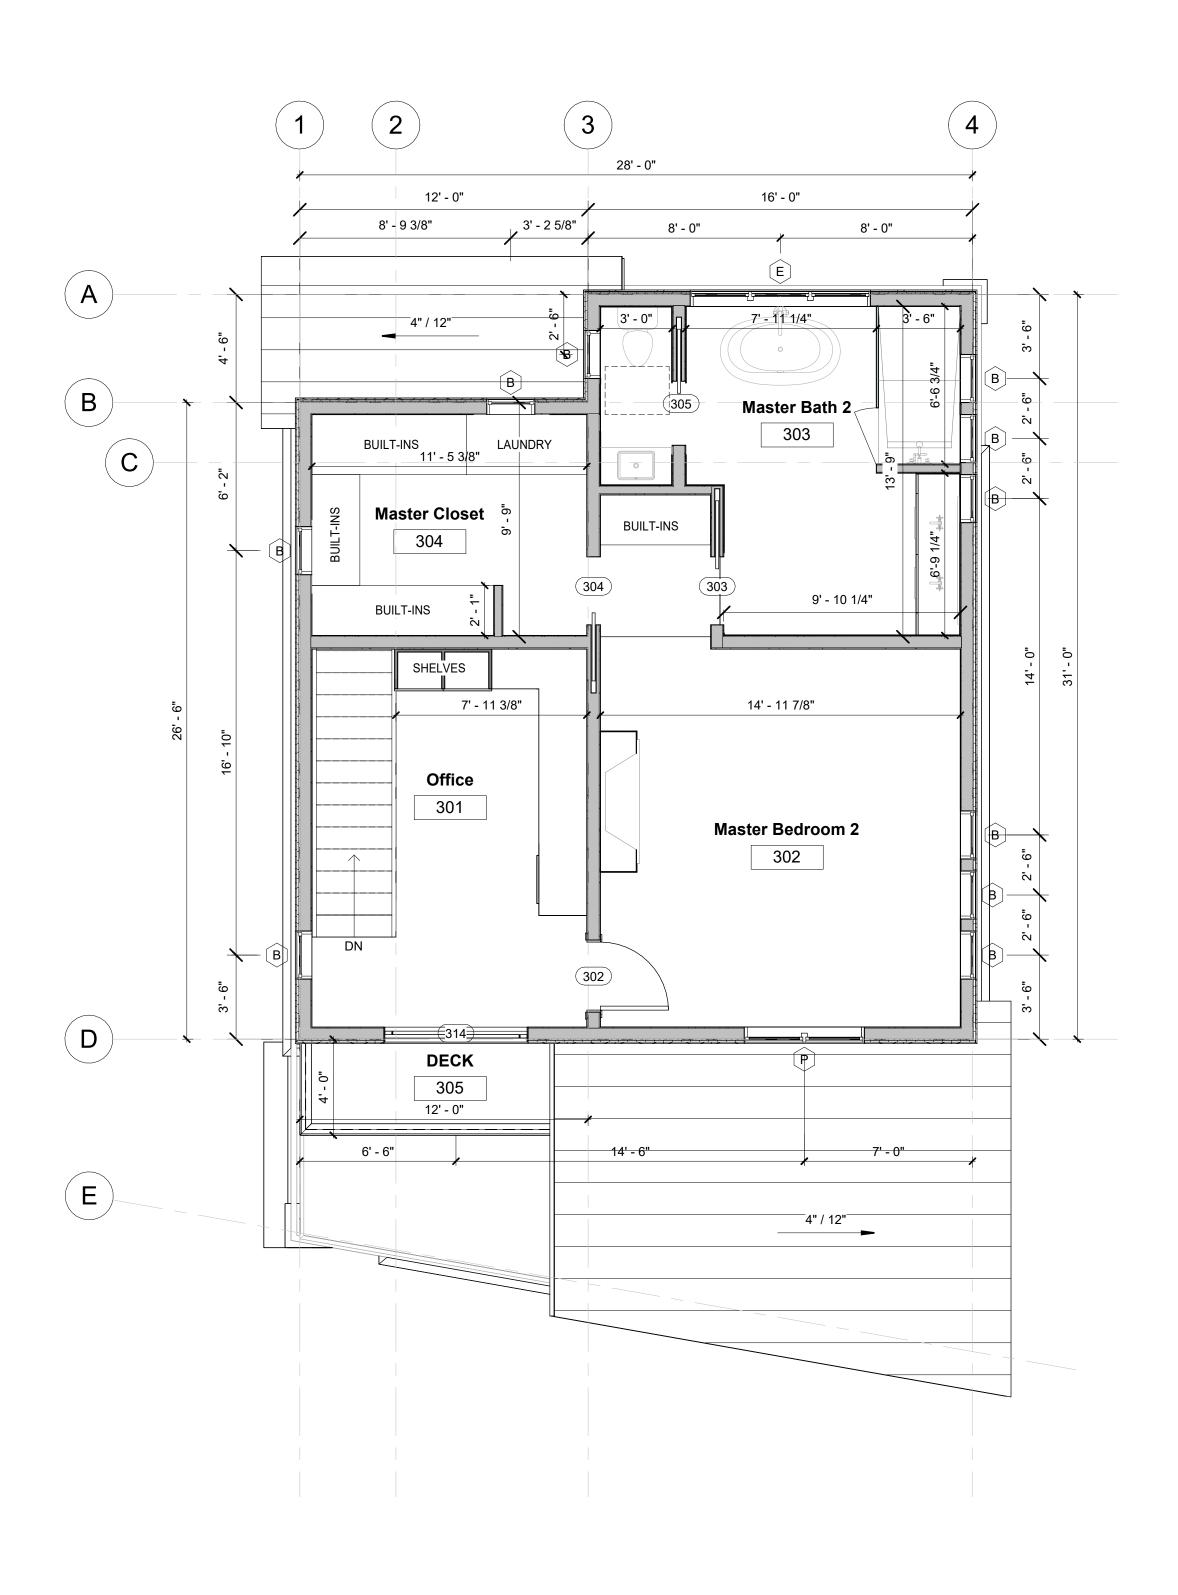
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FLOOR PLANS


MENHARD











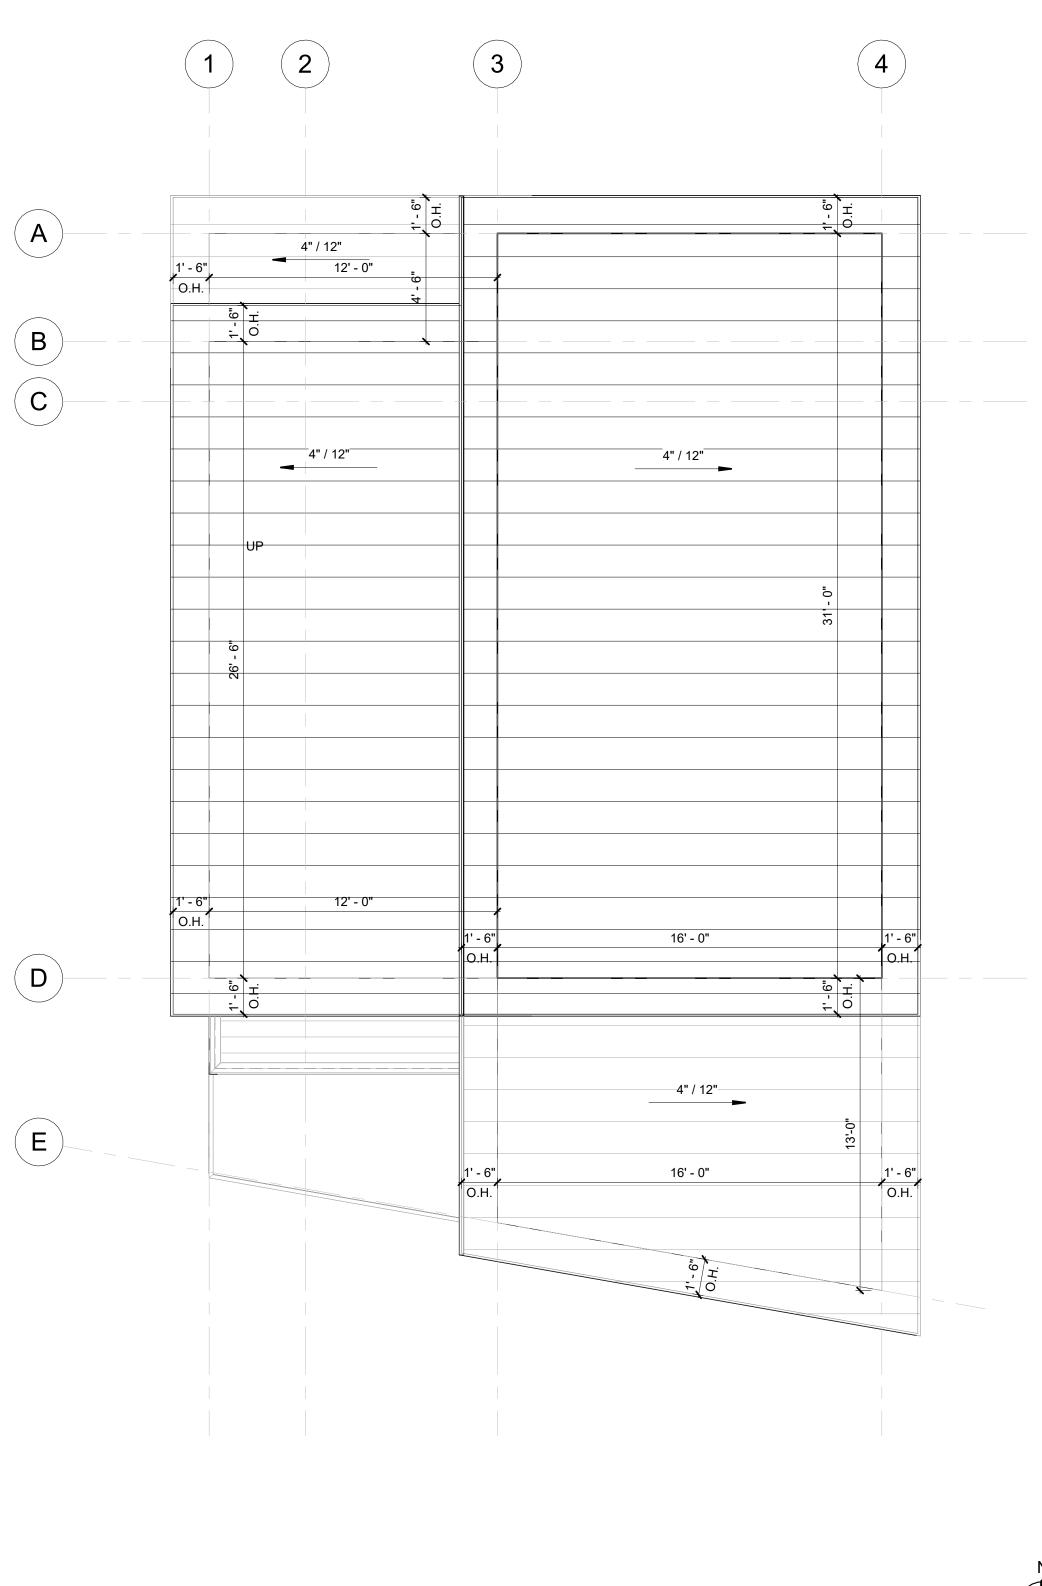



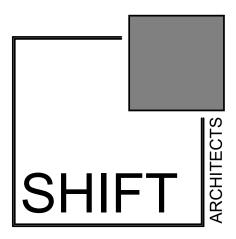

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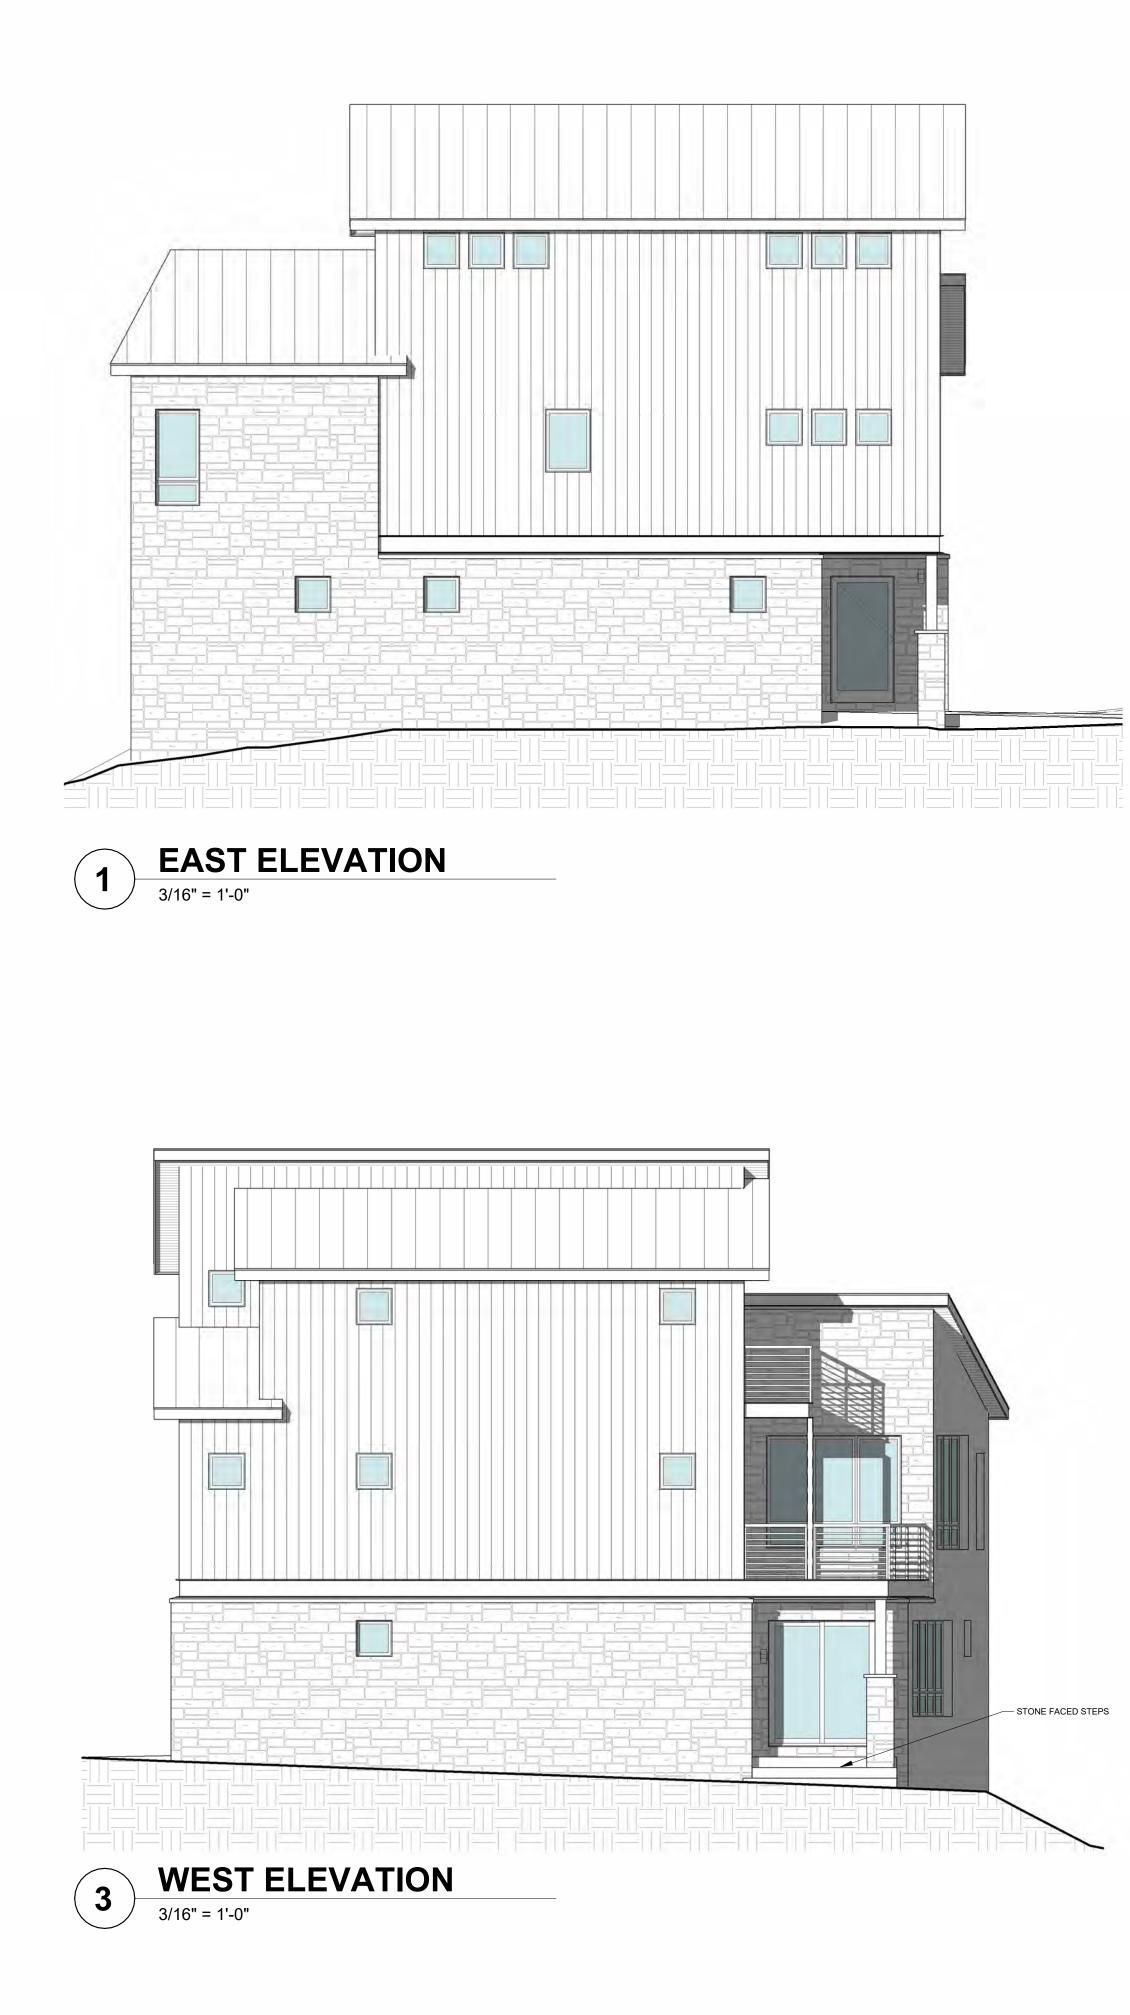


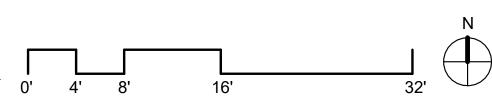MENHARD RESIDENCE

FLOOR & ROOF PLAN




















MATERIAL	CALCULA	TIONS
NORTH		
STONE	155 SF	
WOOD SIDING	454 SF	
WINDOW/DOOR GLAZING	86 SF	
WOOD DOORS	67.5 SF	
<u>TOTAL</u>	<u>762.5 SF</u>	
SOUTH		
STONE	374 SF	
WOOD SIDING	220 SF	
WINDOW/DOOR GLAZING	176 SF	
<u>TOTAL</u>	<u>770 SF</u>	
EAST		
STONE	518 SF	
WOOD SIDING	482 SF	
WINDOW/DOOR GLAZING	63 SF	
TOTAL	<u>1,063 SF</u>	
WEST		
STONE	503 SF	
WOOD SIDING	523 SF	
WINDOW/DOOR GLAZING	83 SF	
TOTALS	<u>1,109 SF</u>	
TOTALS		
TOTAL SF	3,704.5 SF	100 %
STONE	1,550 SF	41.84 %
WOOD SIDING	1,679 SF	45.32 %
WINDOW/DOOR GLAZING	408 SF	11.02 %
WOOD DOORS	67.5 SF	1.82 %

GLAZING CALCULATIONS ARE BASE ON UNIT SIZE. ACTUAL GLASS T.B.D. BY MANUFACTURER'S SPECIFICATIONS.


STONE VENEER CALCULATION REQUIREMENT PER TOWN OF MOUNTAIN VILLAGE CDC 17.5.6 EXTERIOR WALL MATERIALS E.1

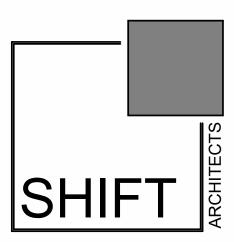

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<u>ROOF</u> BLACK STANDING SEAM



<u>WINDOWS</u> (GRAY FRAME)

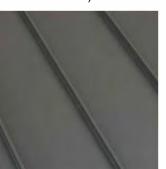

<u>SIDING / SOFFIT / FASCIA</u> (ENGINEERED ENVELLO MILLBOARD

MENHARD RESIDENCE

Way, Mou CO 8143

MATERIAL CALCULATIONS











SOUTH ELEVATION 1/4" = 1'-0"

0' 4' 8'

16'

32'

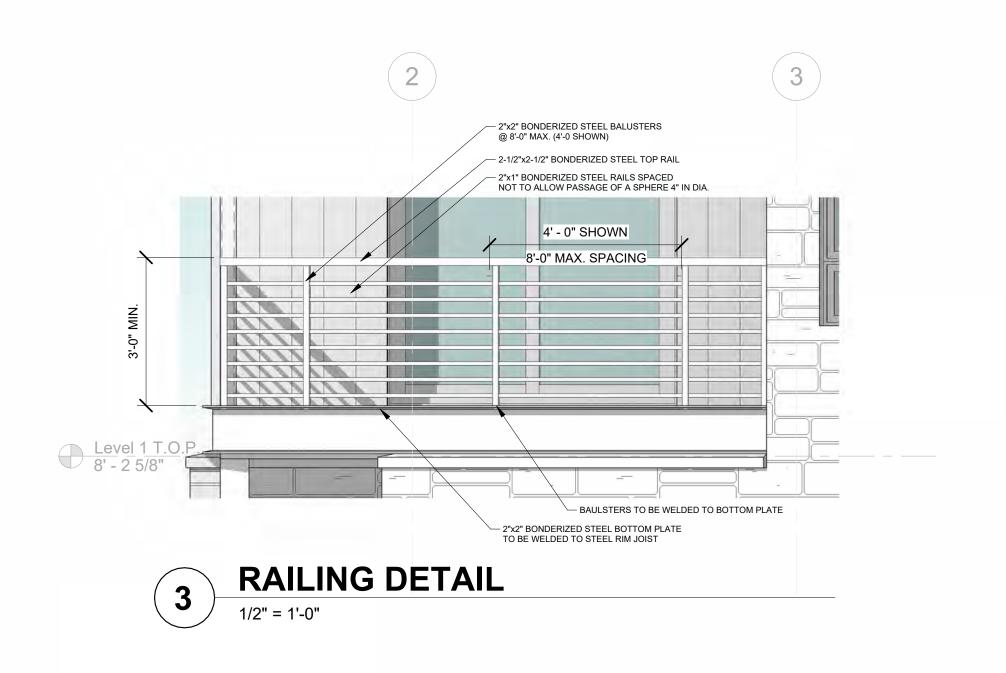

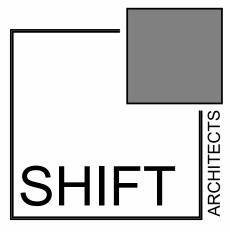

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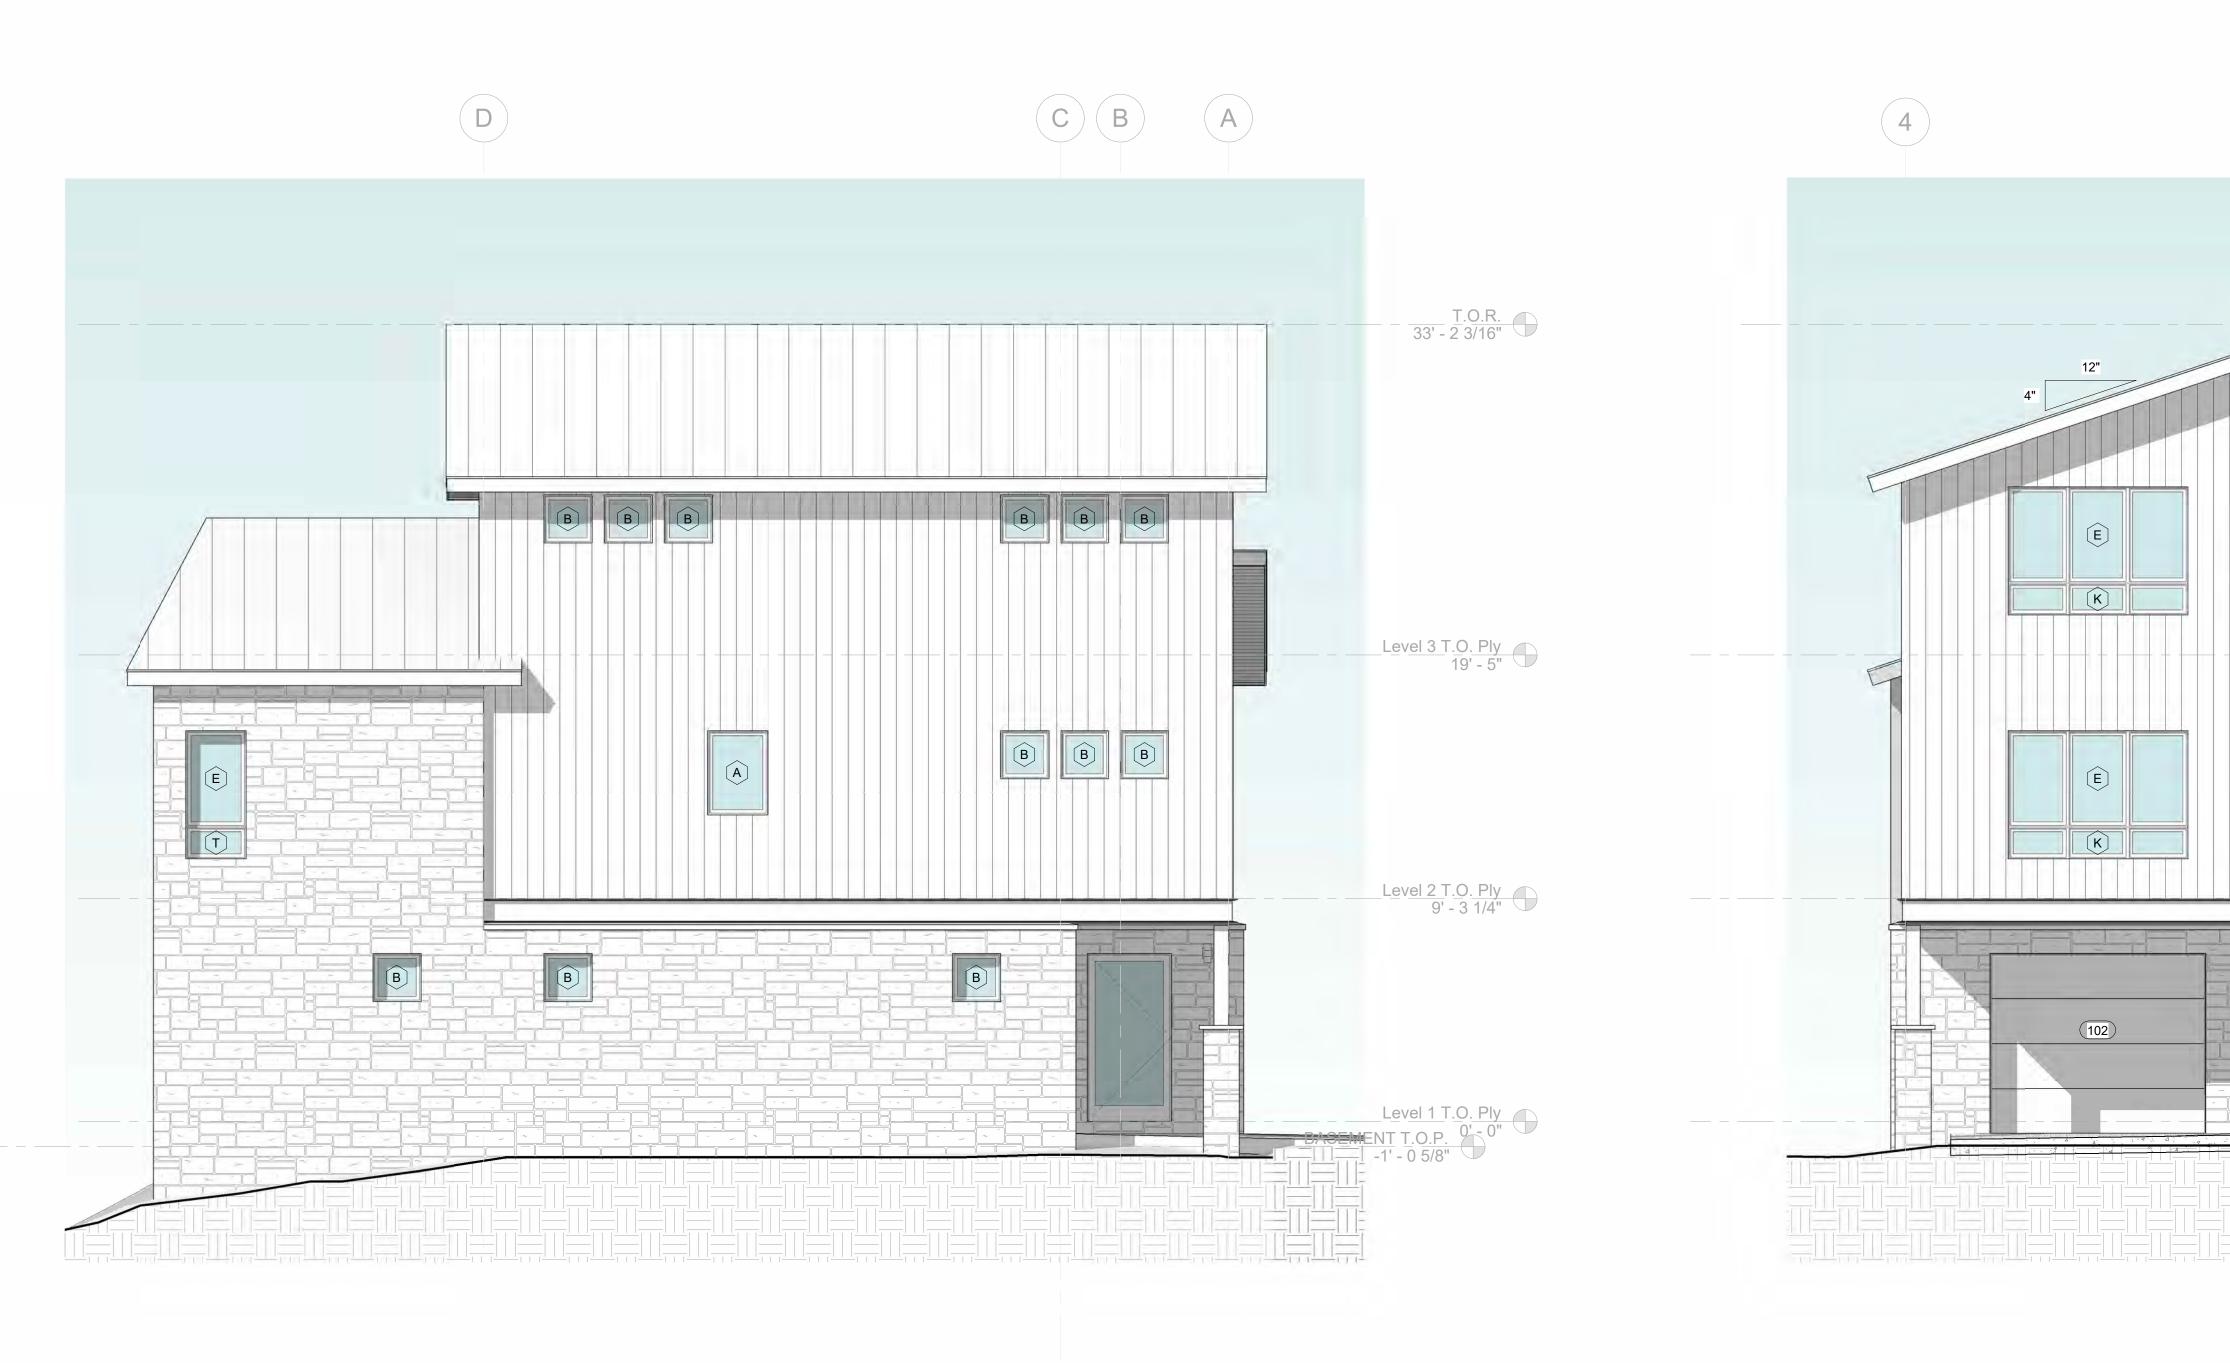
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Way, CO 8


EXTERIOR ELEVATIONS

SHEET NUMBER









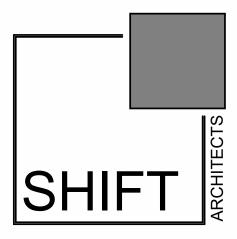

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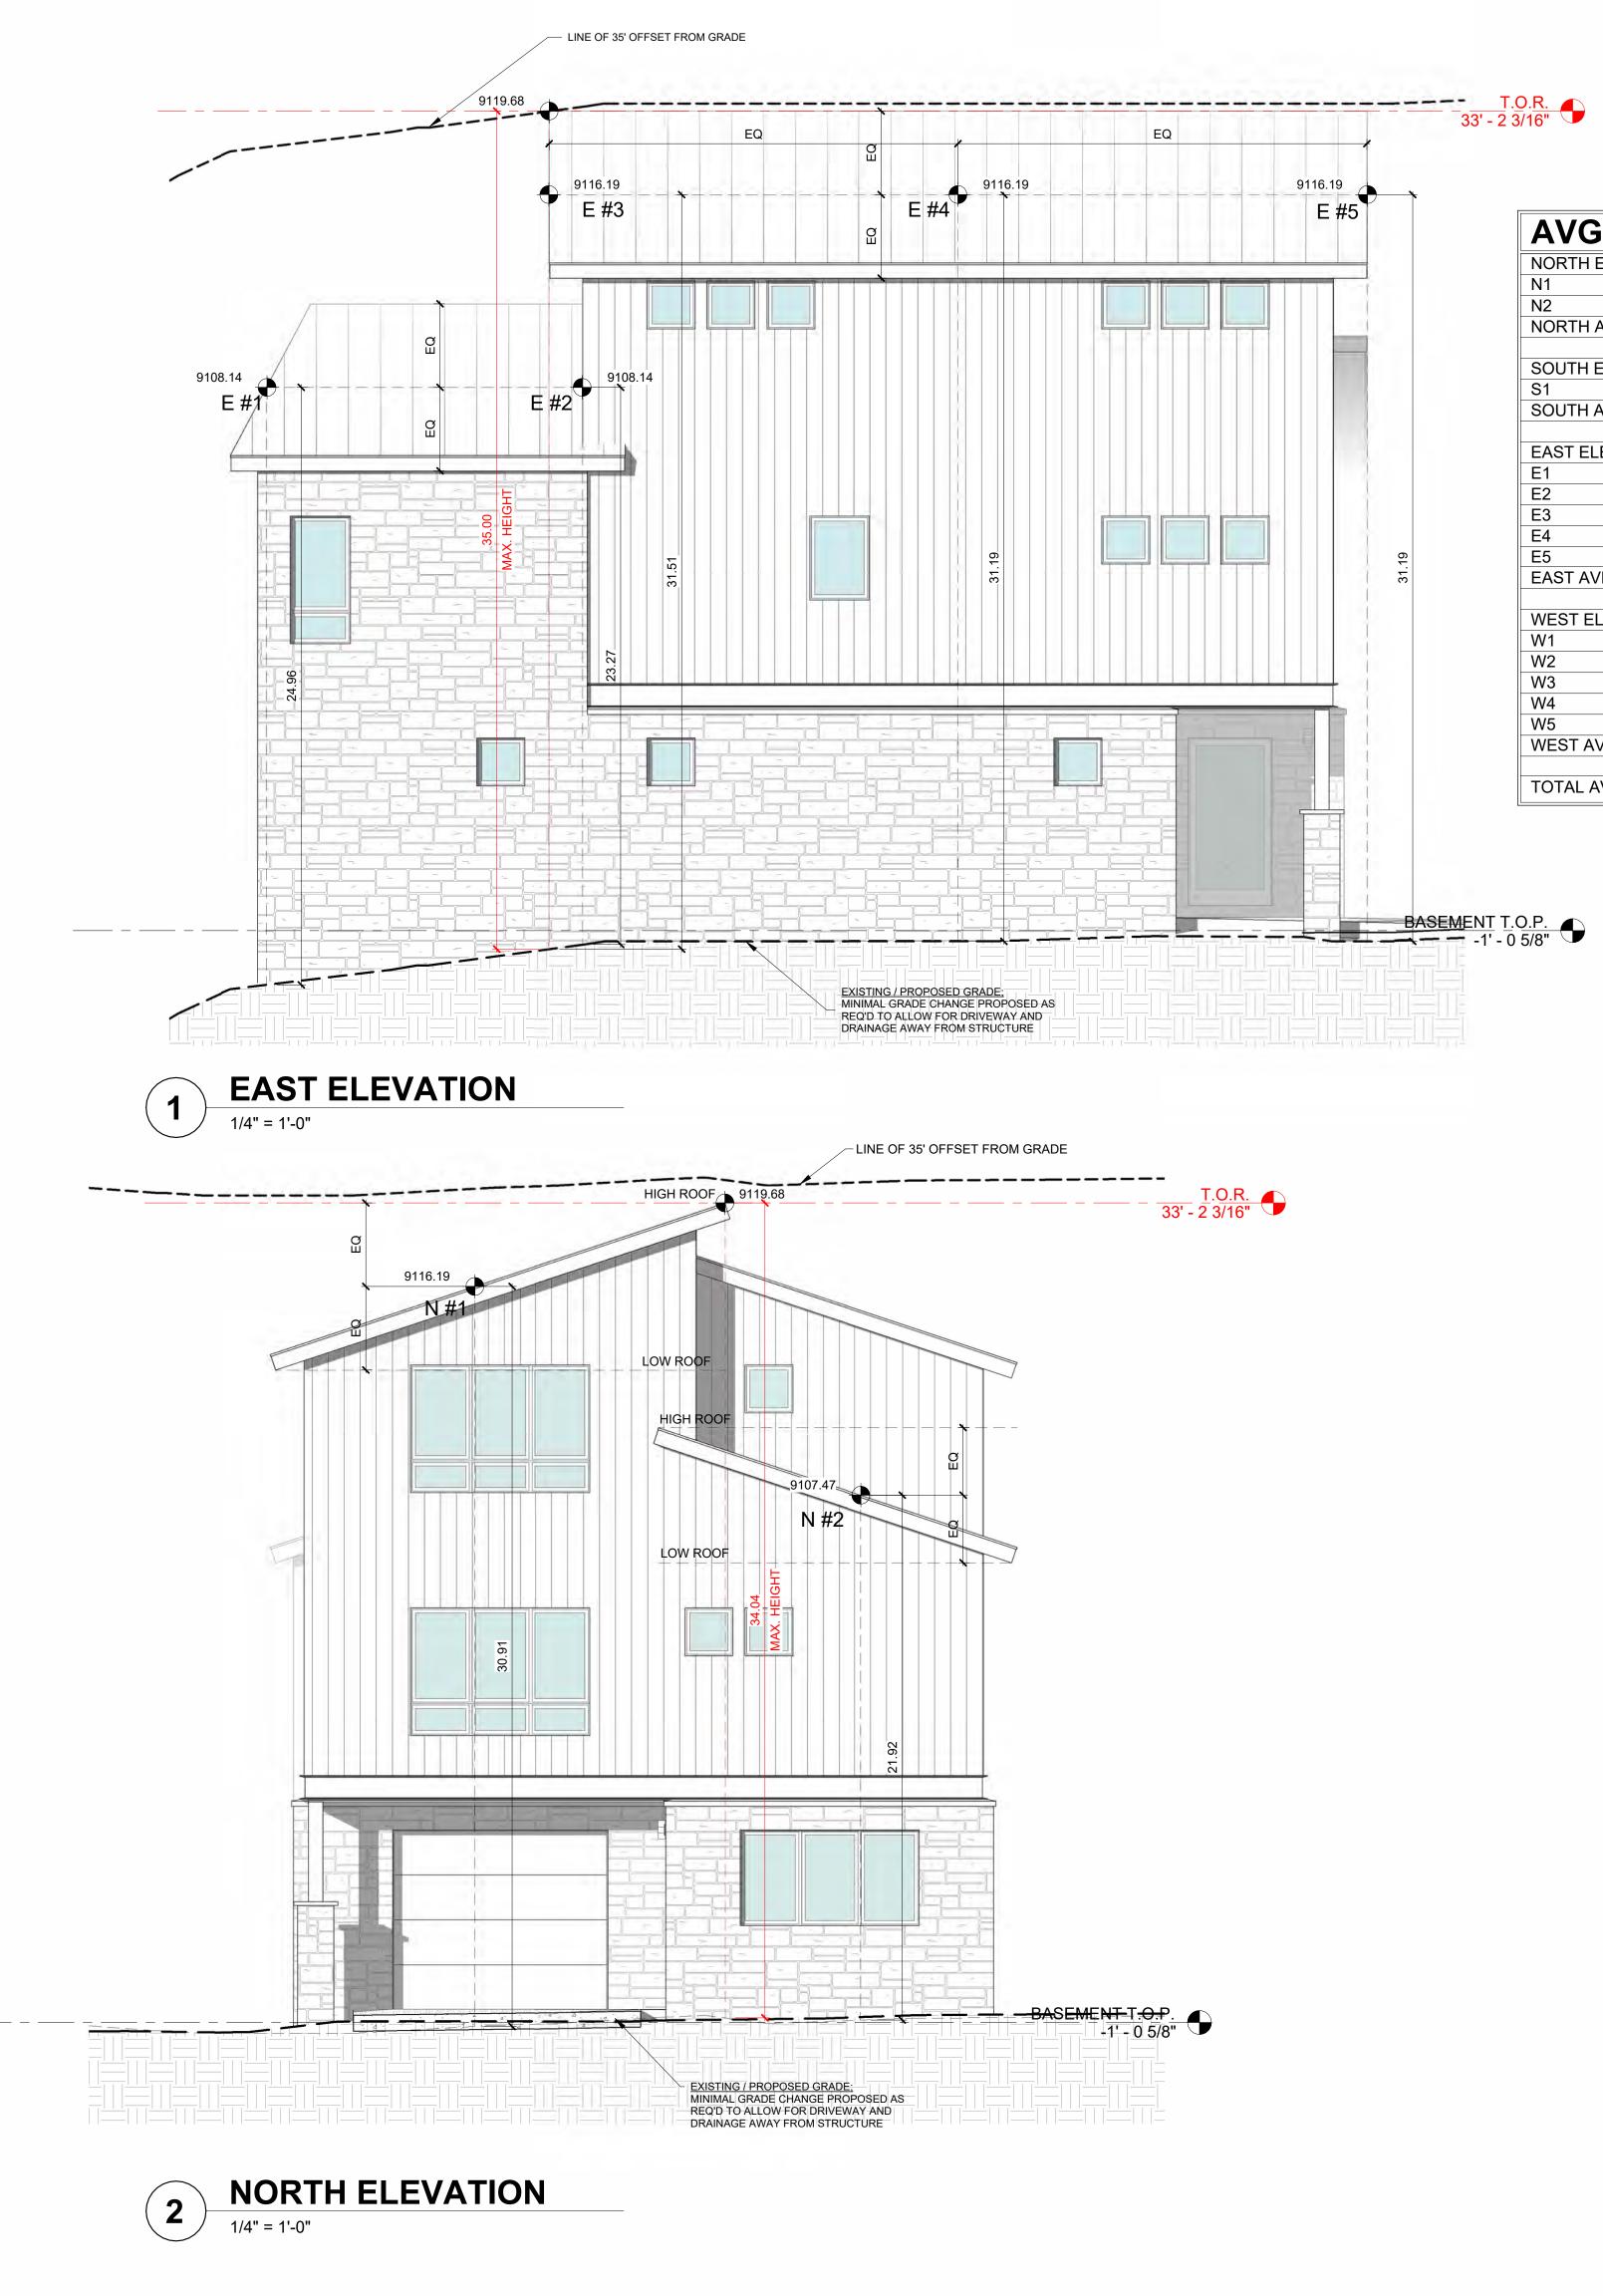
 MENHARD RESIDENCE

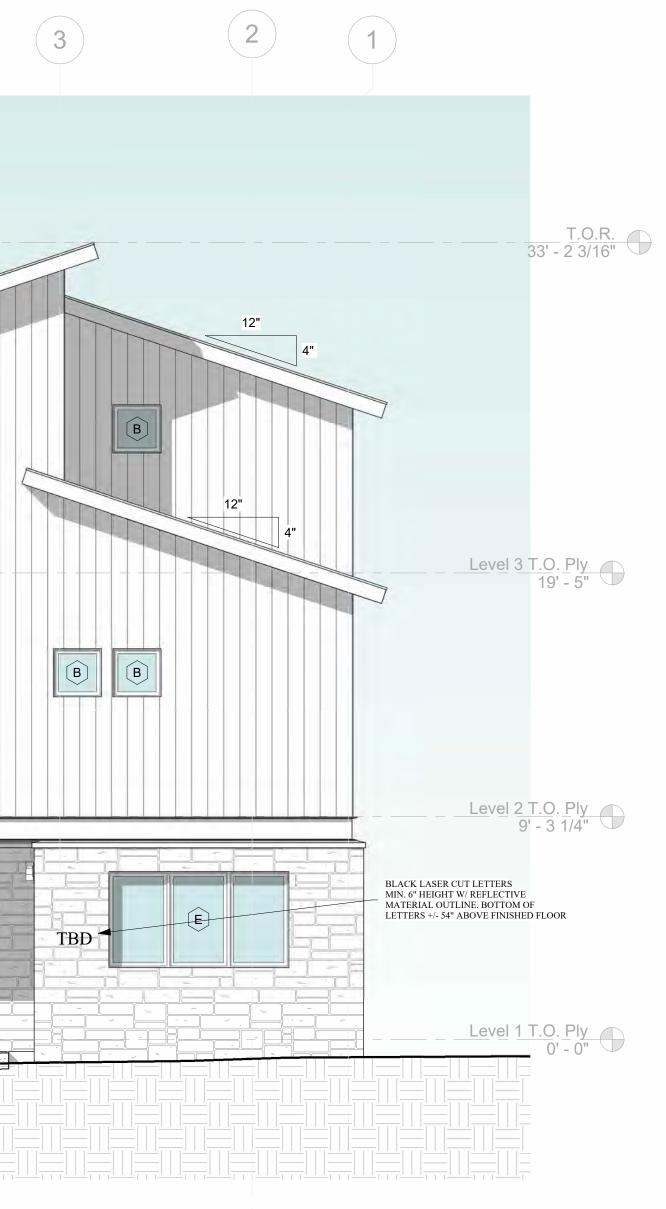 Boulders Way, Mountain Village

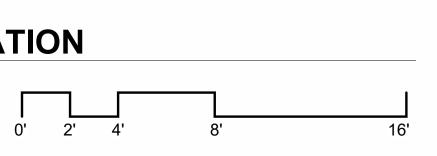 Telluride, CO 81435, USA



SHEET NUMBER




AVG ROOF	HT :
NORTH ELEVATION	
N1	30.91'
N2	21.92'
NORTH AVERAGE	26.42'
SOUTH ELEVATION	
S1	25.55'
SOUTH AVERAGE	25.55'
EAST ELEVATION	
E1	24.96'
E2	23.27'
E3	31.51'
E4	31.19'
E5	31.19'
EAST AVERAGE	28.42'
WEST ELEVATION	
W1	21.52'
W2	21.76'
W3	29.42'
W4	29.97'
W5	30.50'
WEST AVERAGE	26.63'
TOTAL AVERAGE	26.76'

MAX. RO

NORTH ELEVATI SOUTH ELEVATI EAST ELEVATIO WEST ELEVATIO

DOF	HT:
ION	34.04'
ION	29.12'
N	35.00'
ON	33.59'

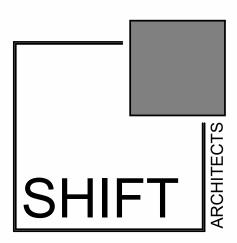

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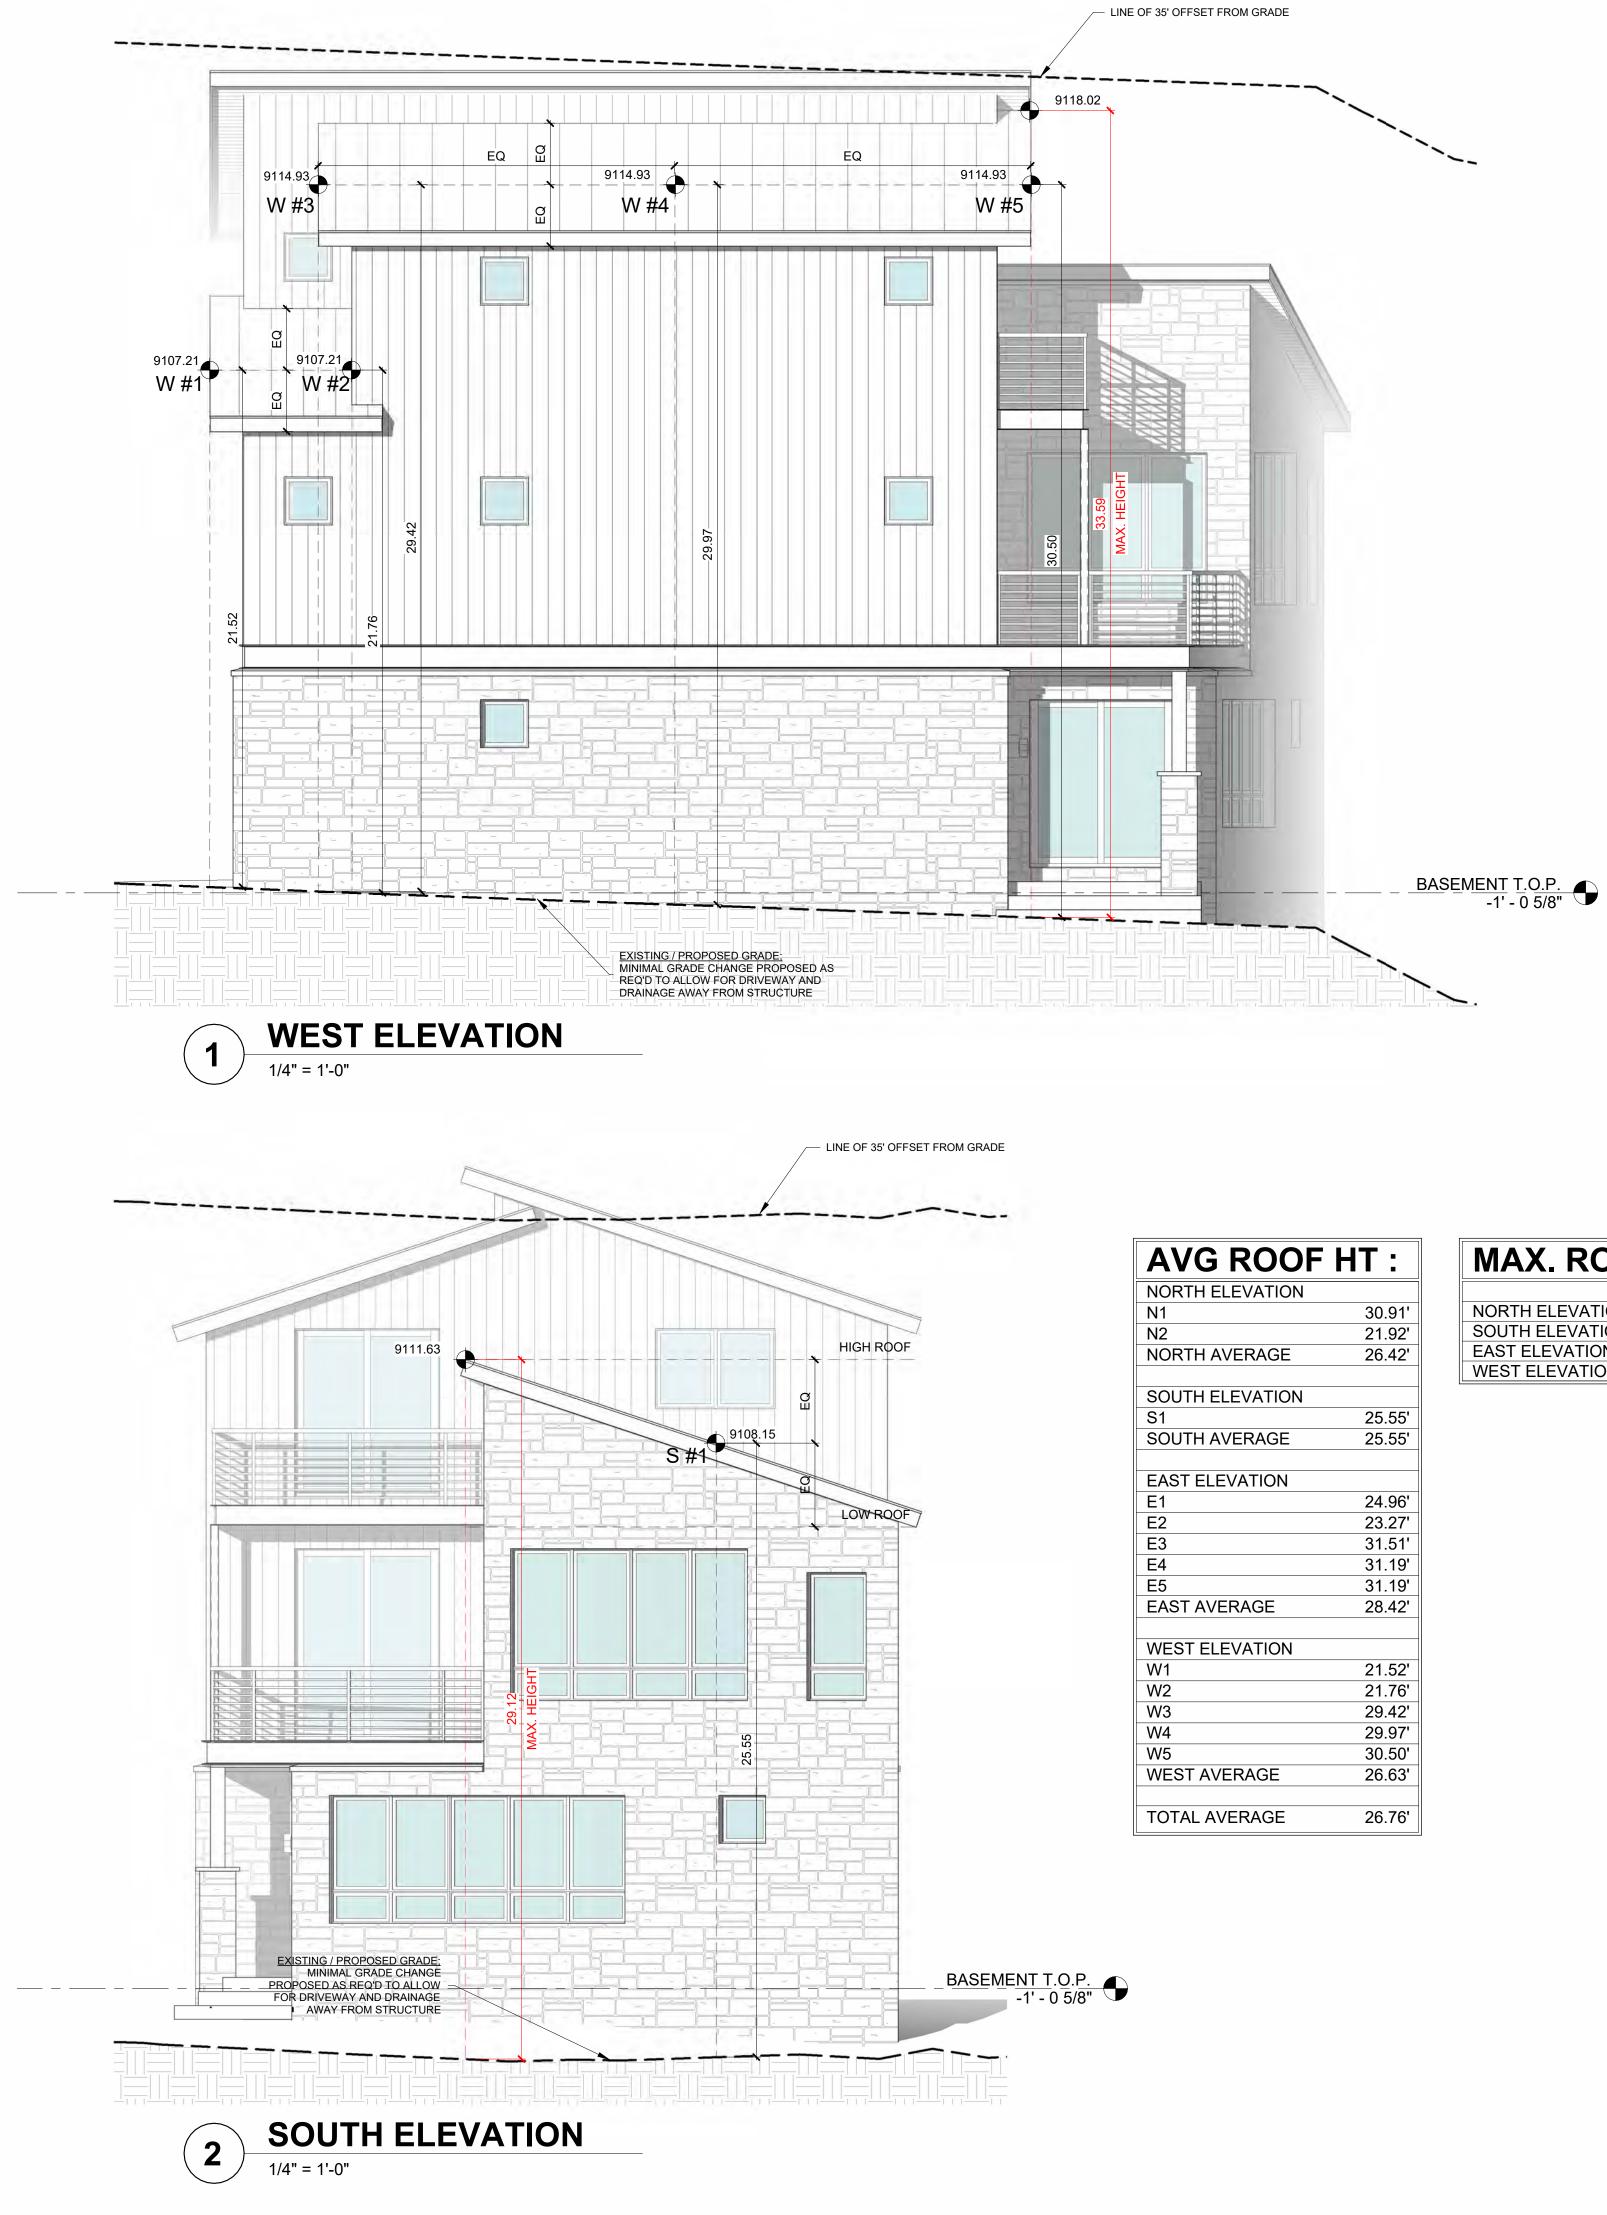
MENHARD RESIDENCE

soulders Way, Mountain Village elluride, CO 81435, USA

ELEVATION HEIGHT CALCULATIONS

© shift architects


SHEET NUMBER



AVG ROOF	HT :
NORTH ELEVATION	
N1	30.91'
N2	21.92'
NORTH AVERAGE	26.42'
SOUTH ELEVATION	
S1	25.55'
SOUTH AVERAGE	25.55'
EAST ELEVATION	
E1	24.96'
E2	23.27'
E3	31.51'
E4	31.19'
E5	31.19'
EAST AVERAGE	28.42'
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W4	29.97'
W5	30.50'
WEST AVERAGE	26.63'
TOTAL AVERAGE	26.76'

MAX.	ROOF	HT:

NORTH ELEVATION	34.04'
SOUTH ELEVATION	29.12'
EAST ELEVATION	35.00'
WEST ELEVATION	33.59'

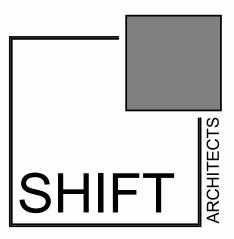


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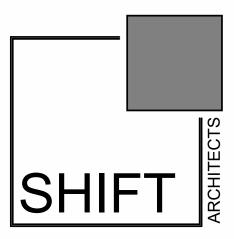
ELEVATION HEIGHT CALCULATIONS

SHEET NUMBER





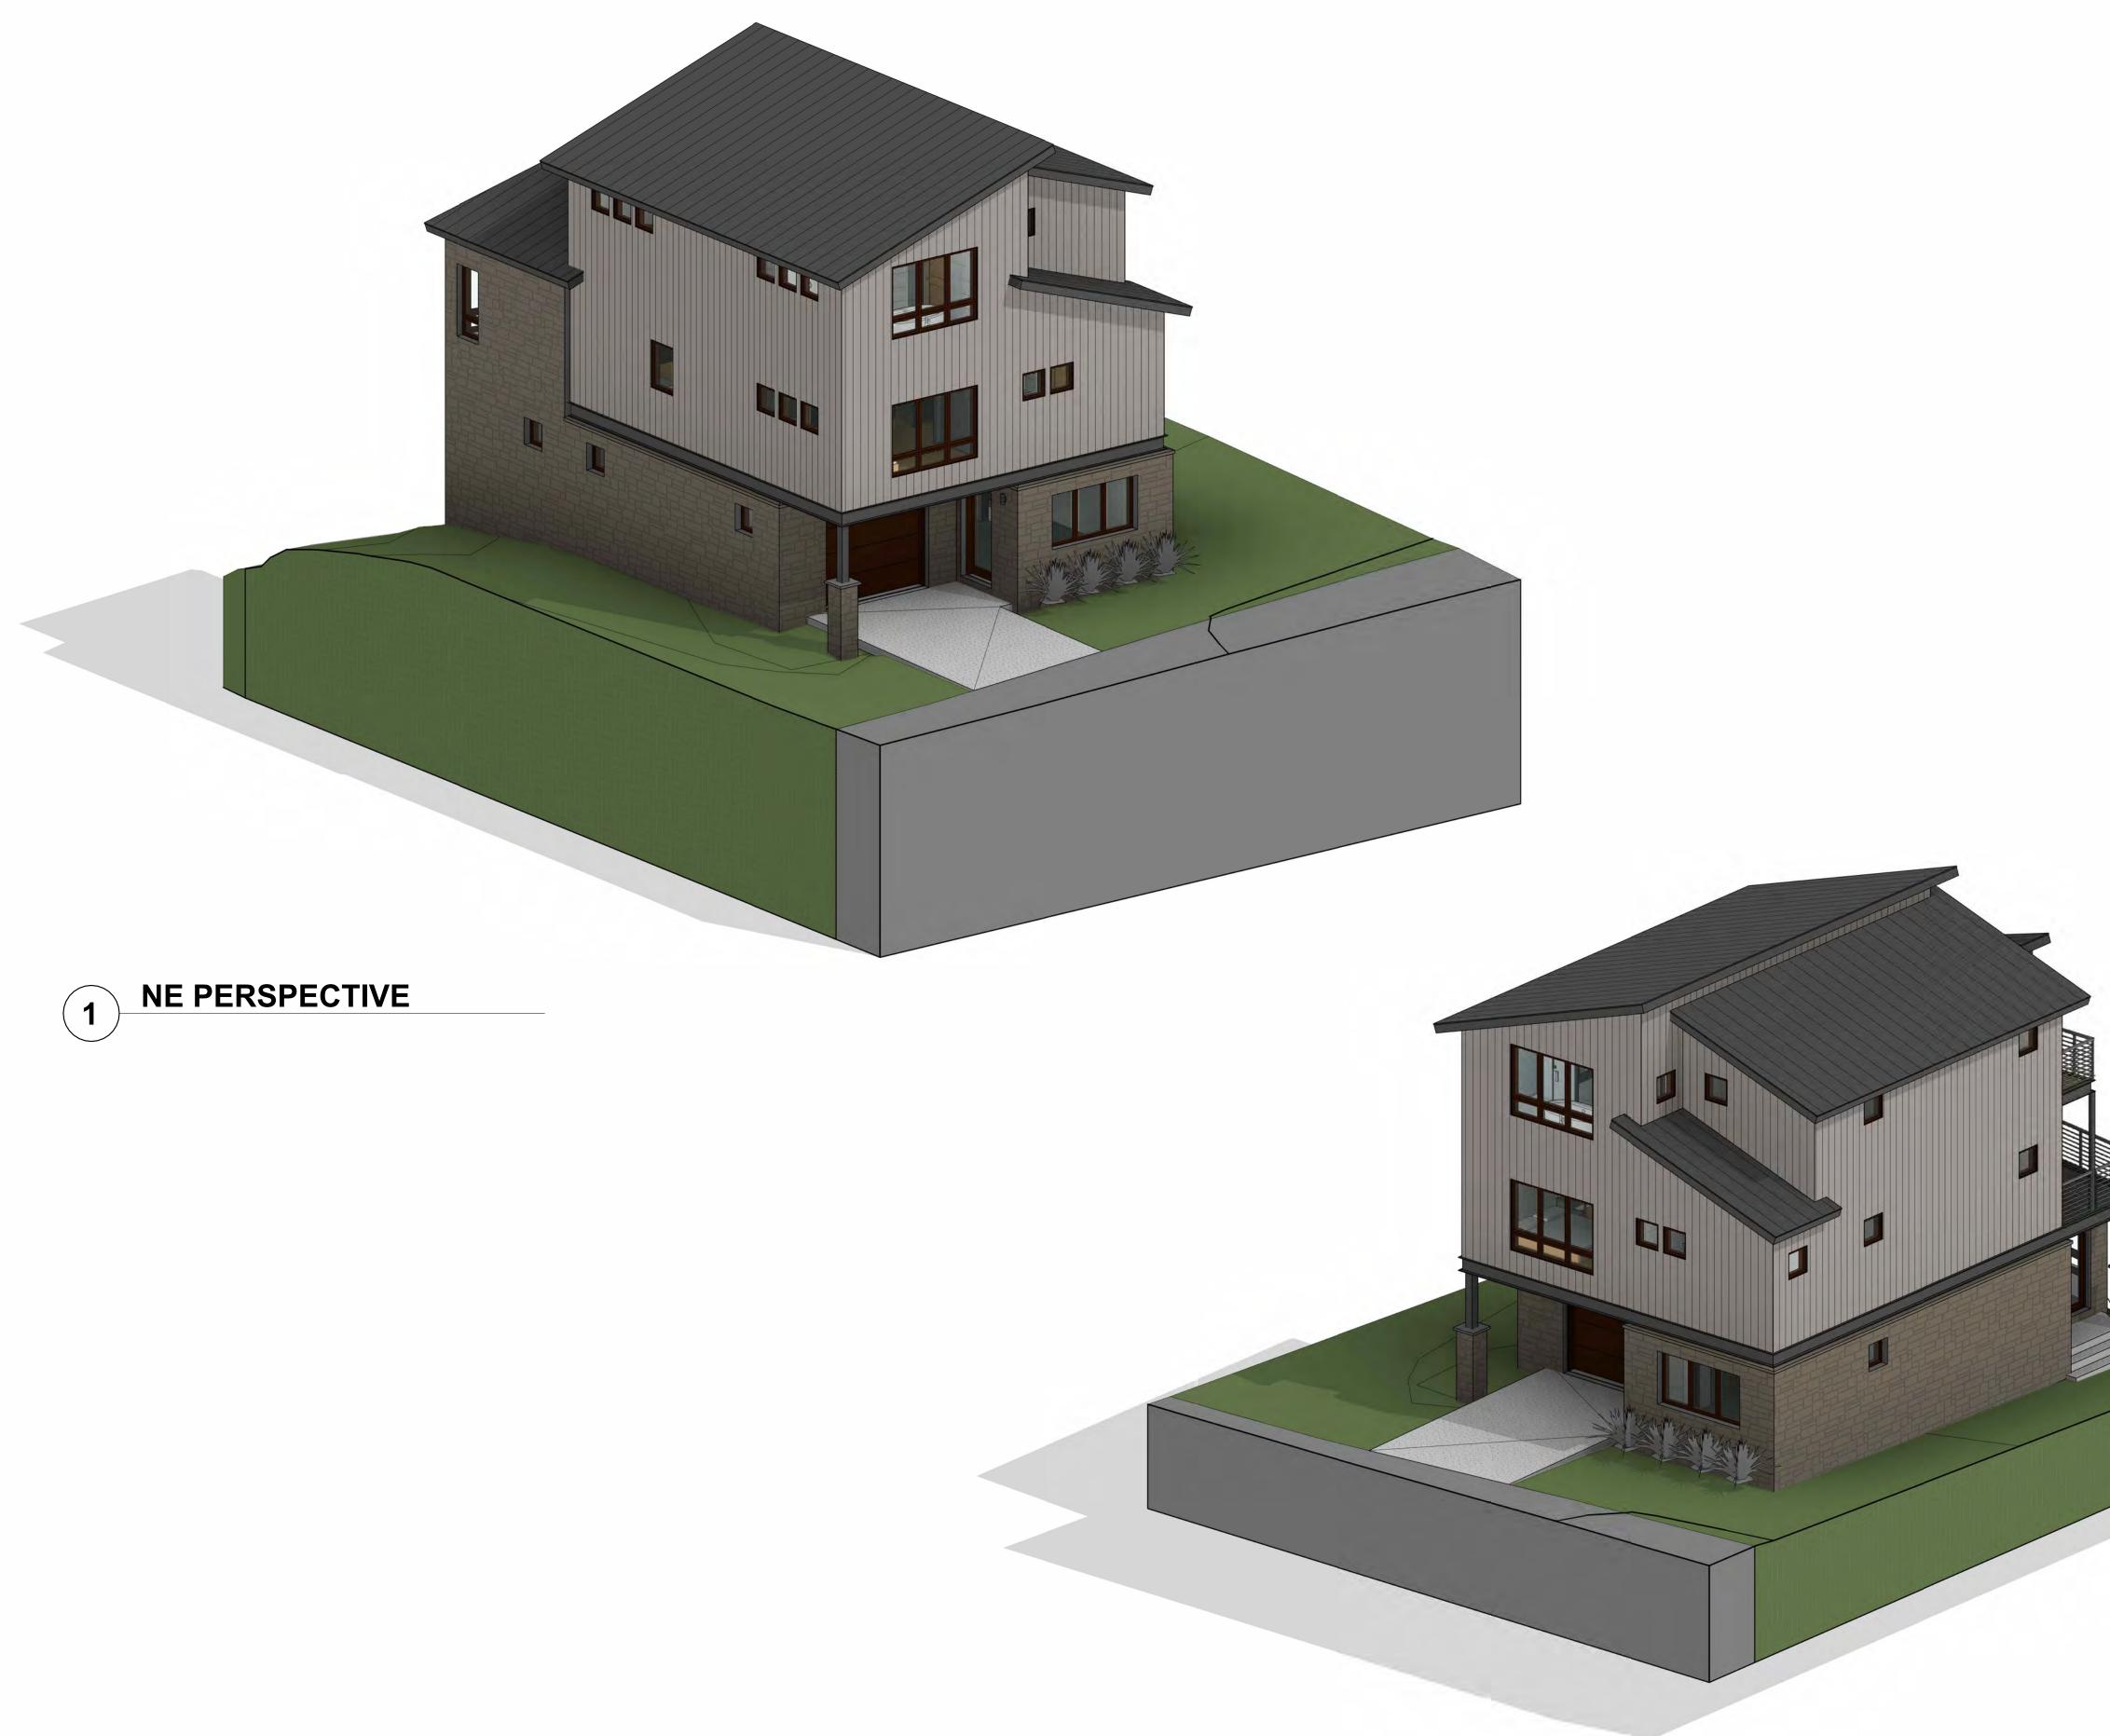



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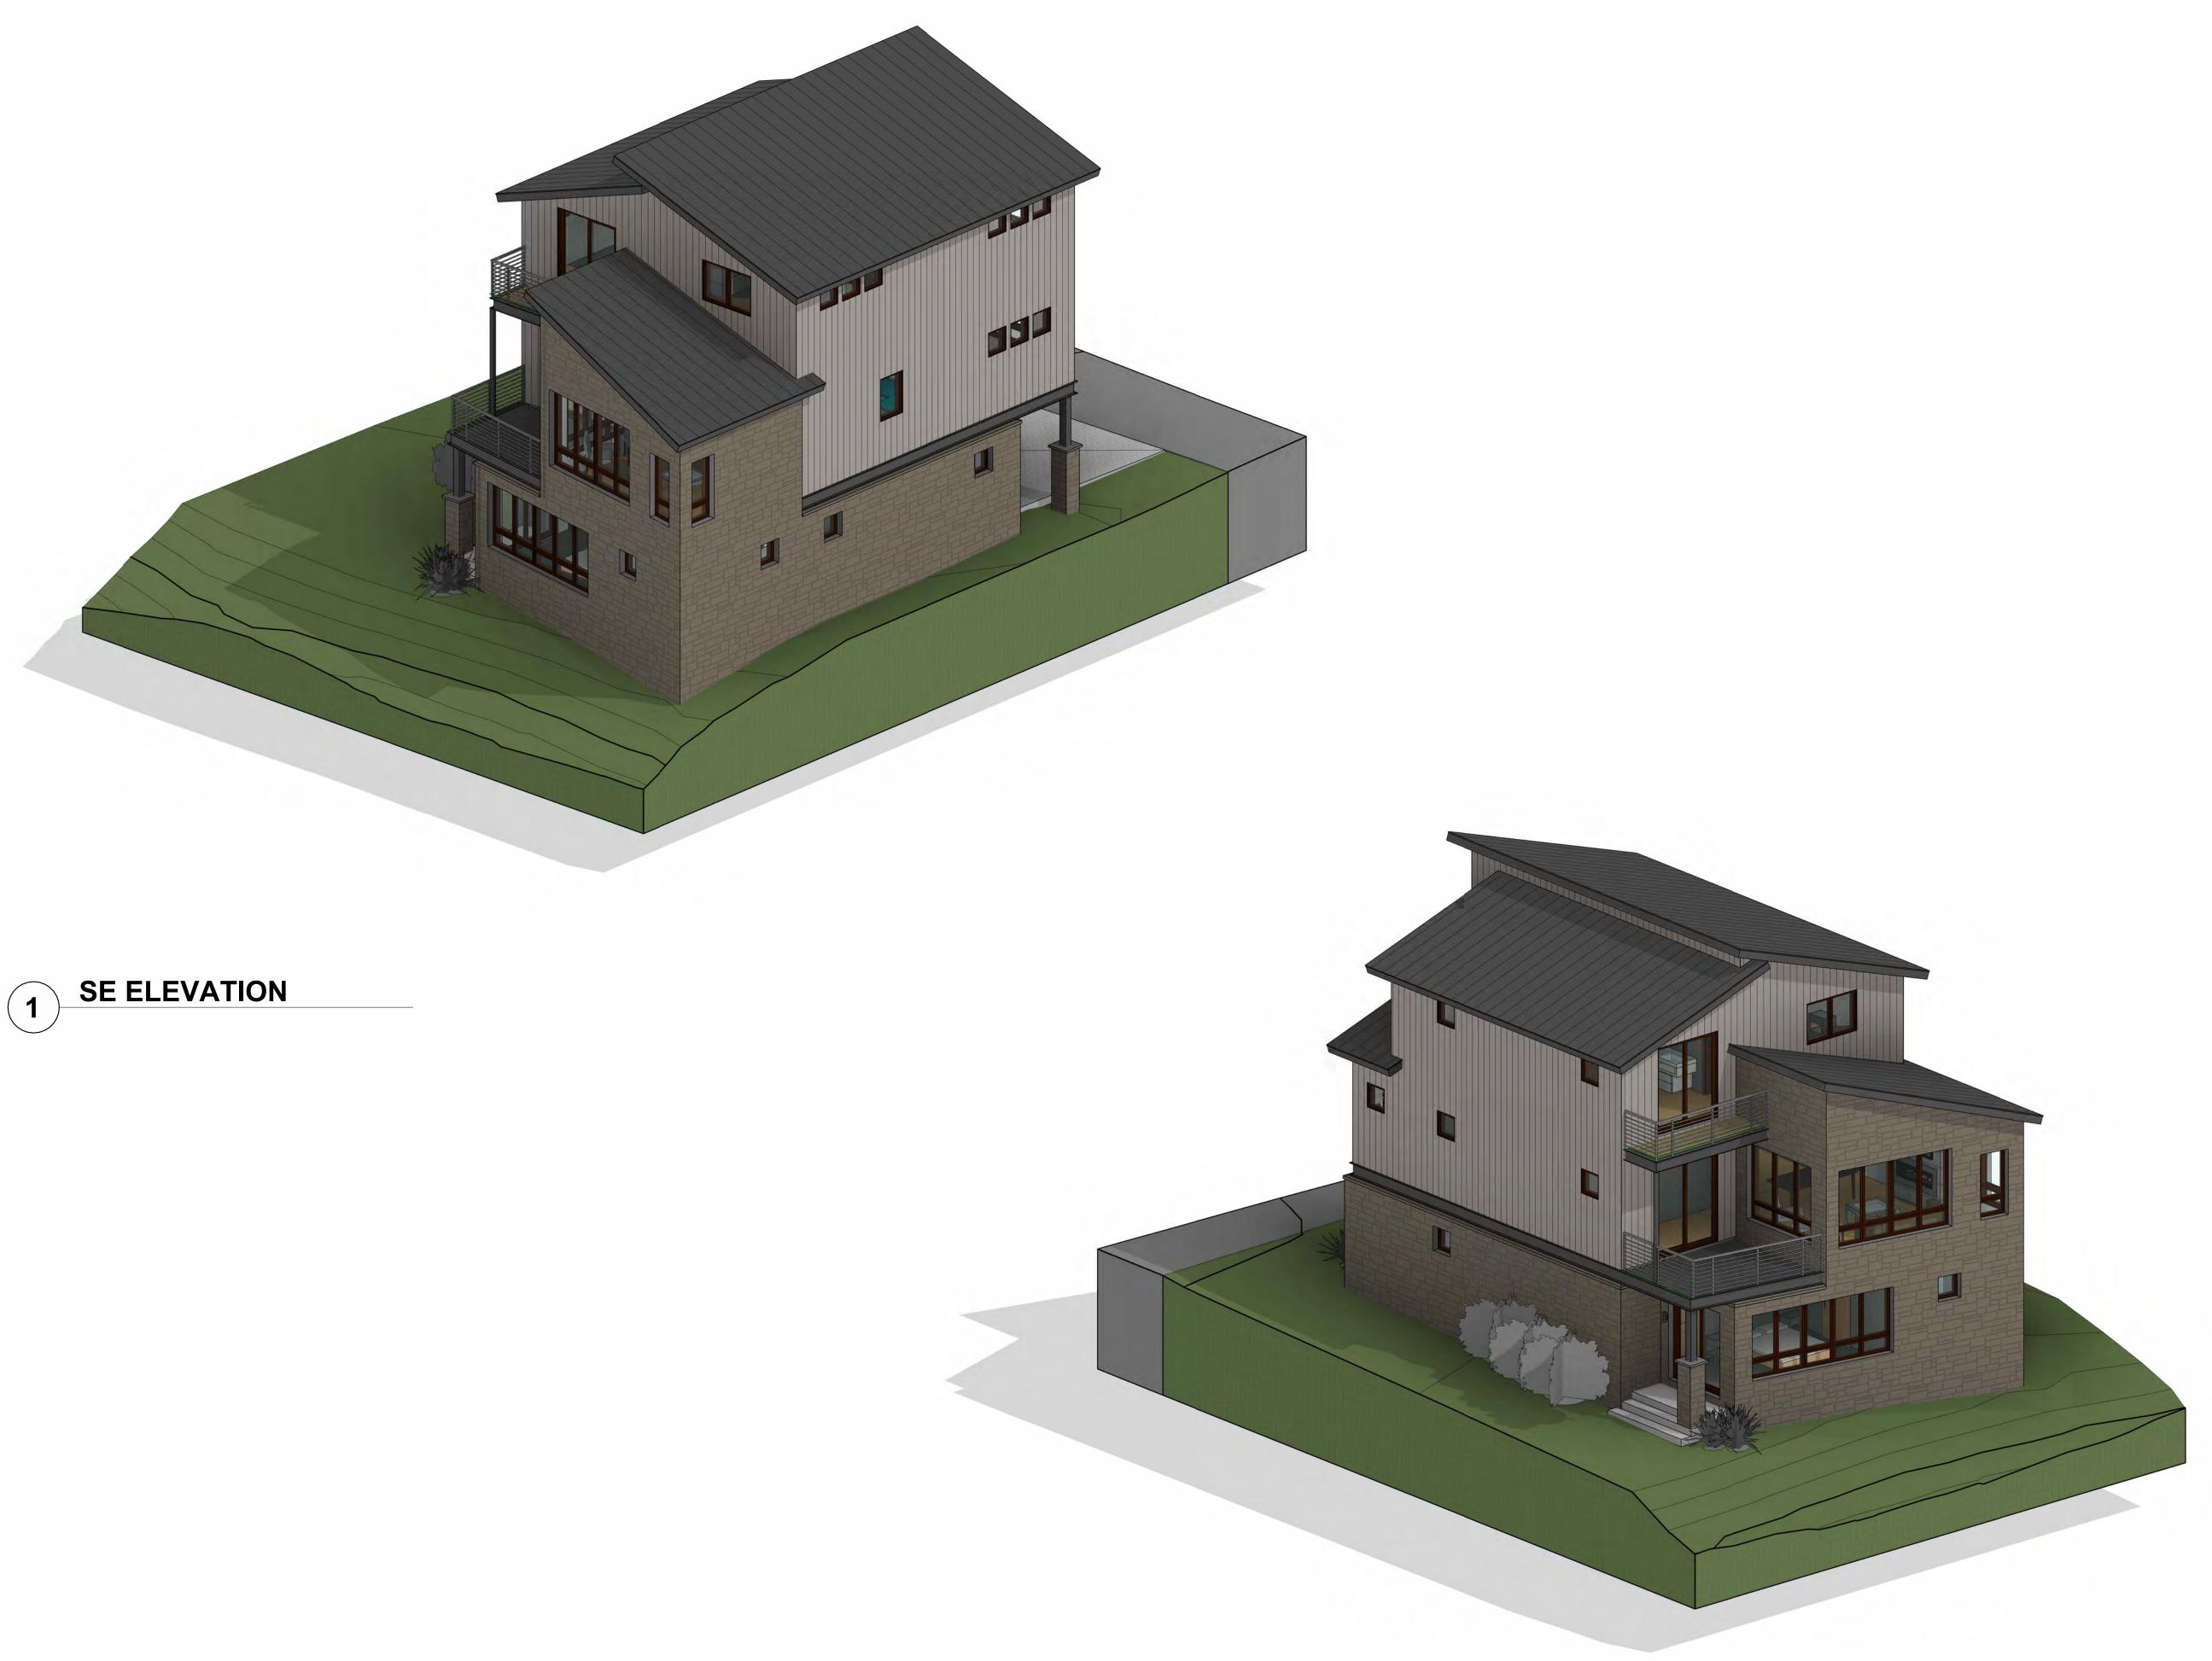


Way, Moun , CO 81435,


PERSPECTIVES

SHEET NUMBER

A6.1





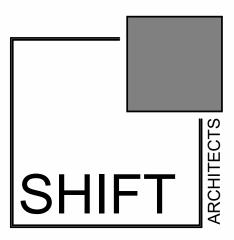

PROJECT ISSUE DATE: 02.20.24 REVISED DRB SUBMITTAL

MENHARD RESIDENCE


lers Way, Moun ide, CO 81435,

PERSPECTIVES

SHEET NUMBER

A6.2

						WINDOV	SCHEDULE	
ROOM NUMBER	ROOM NAME	TYPE MARK	UNIT WIDTH	UNIT HEIGHT	TYPE MARK	ТҮРЕ	MANUFACTURER	
102	Garage	В	2' - 0"	2' - 0"	4	Casement	Kolbe	
102	Garage	В	2' - 0"	2' - 0"	4	Casement	Kolbe	
	1		1		1	1		
103	Entry	В	2' - 0"	2' - 0"	4	Casement	Kolbe	
103	Entry	E	7' - 6"	4' - 0"	3	Casement 3-Wide	Kolbe	
	1		T			1		
105	Guest Master	С	5' - 0"	4' - 0"	2	Casement 2-Wide	Kolbe	
105	Guest Master	E	7' - 6"	4' - 0"	3	Casement 3-Wide	Kolbe	
105	Guest Master	K	7' - 6"	1' - 4"	3	Awning 3-Wide	Kolbe	
105	Guest Master	S	5' - 0"	1' - 4"	2	Awning 2-Wide	Kolbe	
			1					
106	Closet	В	2' - 0"	2' - 0"	4	Casement	Kolbe	
	I		1		1			
107	Bath #1	В	2' - 0"	2' - 0"	4	Casement	Kolbe	
	1		1		1	-		
	Hall	B	2' - 0"	2' - 0"	4	Casement	Kolbe	
202	Hall	В	2' - 0"	2' - 0"	4	Casement	Kolbe	
204	Kitchen	A	2' - 6"	3' - 6"	7	Casement	Kolbe	
				4. 0.1				
205	Living/Dining Room	E	2' - 6"	4' - 0"	1	Casement 1-Wide	Kolbe	
205	Living/Dining Room	F	2' - 6"	4' - 0"	1	Casement 1-Wide	Kolbe	
205	Living/Dining Room	G	5' - 0"	5' - 0"	2	Casement 2-Wide	Kolbe	
205	Living/Dining Room	G	5' - 0"	5' - 0"	2	Casement 2-Wide	Kolbe	
205	Living/Dining Room	H	7' - 6"	5' - 0"	3	Casement 3-Wide	Kolbe	
205	Living/Dining Room	K	7' - 6"	1' - 4"	3	Awning 3-Wide	Kolbe	
205	Living/Dining Room	S	5' - 0"	1' - 4"	2	Awning 2-Wide	Kolbe	
205	Living/Dining Room	S	5' - 0"	1' - 4"	2	Awning 2-Wide	Kolbe	
205	Living/Dining Room		2' - 6"	1' - 4"	1	Awning	Kolbe	
205	Living/Dining Room		2' - 6"	1' - 4"	1	Awning	Kolbe	
206	Master Bedroom 1	В	2' - 0"	2' - 0"	4	Casement	Kolbe	
200	Master Bedroom 1	B	2 - 0"	2'-0"	4	Casement	Kolbe	
200	Master Bedroom 1	B	2 - 0"	2'-0"	4	Casement	Kolbe	
200	Master Bedroom 1	E	7' - 6"	4' - 0"	3	Casement 3-Wide	Kolbe	E
206	Master Bedroom 1	K	7' - 6"	1' - 4"	3	Awning 3-Wide	Kolbe	L
200			1 0		0			
207	Master Bath 1	В	2' - 0"	2' - 0"	4	Casement	Kolbe	
207	Master Bath 1	B	2' - 0"	2' - 0"	4	Casement	Kolbe	
207	Master Bath 1	B	2' - 0"	2' - 0"	4	Casement	Kolbe	
301	Office	В	2' - 0"	2' - 0"	4	Casement	Kolbe	
302	Master Bedroom 2	В	2' - 0"	2' - 0"	4	Casement	Kolbe	
302	Master Bedroom 2	В	2' - 0"	2' - 0"	4	Casement	Kolbe	
302	Master Bedroom 2	В	2' - 0"	2' - 0"	4	Casement	Kolbe	
302	Master Bedroom 2	Р	5' - 0"	3' - 4"	6	Casement 2-Wide	Kolbe	E
303	Master Bath 2	В	2' - 0"	2' - 0"	4	Casement	Kolbe	
303	Master Bath 2	В	2' - 0"	2' - 0"	4	Casement	Kolbe	
303	Master Bath 2	В	2' - 0"	2' - 0"	4	Casement	Kolbe	
303	Master Bath 2	В	2' - 0"	2' - 0"	4	Casement	Kolbe	
303	Master Bath 2	E	7' - 6"	4' - 0"	3	Casement 3-Wide	Kolbe	
303	Master Bath 2	К	7' - 6"	1' - 4"	3	Awning 3-Wide	Kolbe	
304	Master Closet	В	2' - 0"	2' - 0"	4	Casement	Kolbe	
304	Master Closet	В	2' - 0"	2' - 0"	4	Casement	Kolbe	

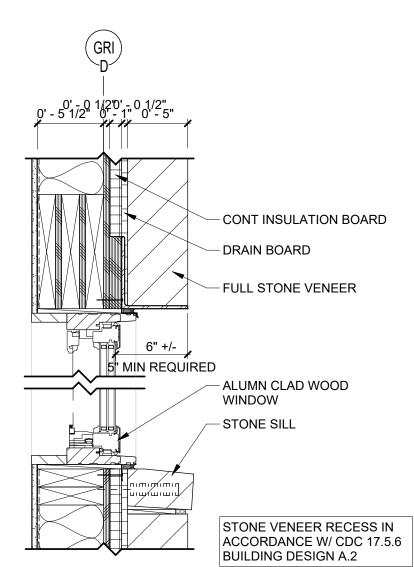

1

1 1/2" = 1'-0"

- CONT INSULATION BOARD

- FULL STONE VENEER


WINDOW DETAIL W/ STONE VENEER

- DRAIN BOARD


WINDOW NOTES:

- 1. WINDOW INSTALLATION: INSTALL WINDOWS IN ACCORDANCE WITH MANUFACTURER'S INSTALLATION INSTRUCTIONS.
- 2. SEE ELEVATIONS FOR WINDOW MULLION PATTERN.


- 5. WINDOW MANUFACTURER TO VERIFY WINDOW SWINGS.
- 6. WINDOW MANUFACTURER TO PROVIDE SHOP DRAWINGS.7. PROVIDE SCREENS FOR ALL OPERABLE WINDOWS.

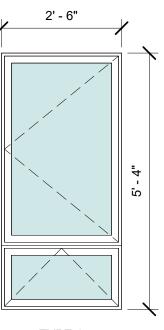


TYPE 1 CASEMENT W/ AWNING

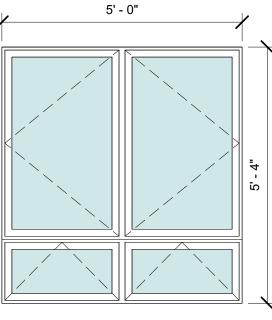



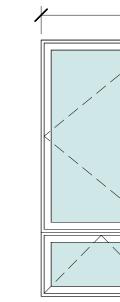

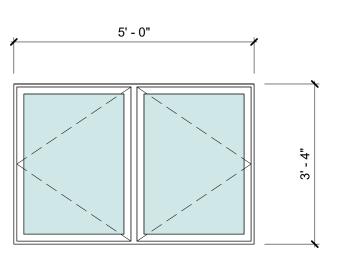


TYPE 6 CASEMENT 2-WIDE


TYPE 5 CASEMENT 3-WIDE


7' - 6"

WINDOW HARDWARE TO BE BRUSHED NICKEL OR BRUSHED STEEL.
 VERIFY ROUGH OPENINGS WITH MANUFACTURER PRIOR TO FRAMING.


_	
	COMMENTS
1	
1	
	<u> </u>
EGR	55
	<u>ee</u>
EGR	<u></u>

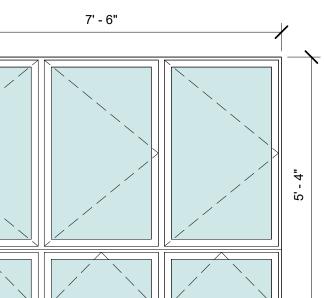

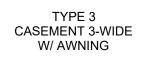


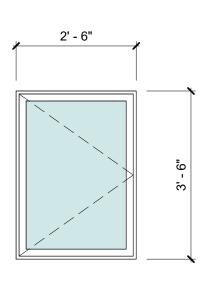

TYPE 7 CASEMENT 1-WIDE

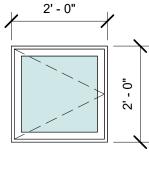

TYPE 4 CASEMNT

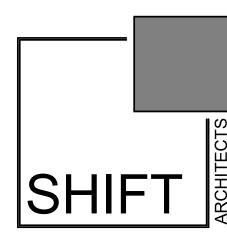


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Vay

WINDOW SCHEDULE






DOOR NOTES:

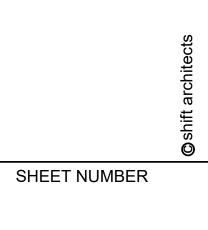
- 1. DOOR INSTALLATION: INSTALL DOORS IN ACCORDANCE WITH MANUFACTURER'S INSTALLATION INSTRUCTIONS.
- 2. SEE ELEVATIONS FOR DOOR MULLION PATTERN.
- DOOR HARDWARE TO BE BRUSHED NICKEL OR BRUSHED STEEL.
 DOOR & WINDOW MANUFACTURER: WINDSOR
- 5. VERIFY ROUGH OPENINGS WITH MANUFACTURER PRIOR TO FRAMING.


DOOR SCHEDULE									
MARK	ROOM NAME	TYPE MARK	WIDTH	HEIGHT	TYPE	MANUFACTURER	LOCATION	COMMENTS	
101	Entry	D	3' - 6"	7' - 0"	SWING		EXTERIOR		
102	Garage	E	9' - 0"	7' - 6"	OVERHEAD DOOI	२	EXTERIOR		
110	Guest Master	A	6' - 0"	7' - 0"	SLIDING	JELD-WEN	EXTERIOR		
208	Hall	A	6' - 0"	8' - 0"	SLIDING	JELD-WEN	EXTERIOR		
314	DECK	A	6' - 0"	7' - 0"	SLIDING	JELD-WEN	EXTERIOR		
105	Guest Master	В	2' - 10"	7' - 0"	POCKET		INTERIOR		
106	Closet	I	2' - 10"	7' - 0"	BARN DOOR		INTERIOR		
107	Bath #1	В	2' - 8"	7' - 0"	POCKET		INTERIOR		
108	Entry	F	3' - 0"	7' - 0"	SWING		INTERIOR		
111	Entry	J	5' - 0"	7' - 0"	SLIDING		INTERIOR		
112	Entry	J	5' - 0"	7' - 0"	SLIDING		INTERIOR		
203	Powder	В	2' - 4"	7' - 0"	POCKET		INTERIOR		
206	Hall	В	2' - 10"	7' - 0"	POCKET		INTERIOR		
207	Master Bath 1	В	2' - 8"	7' - 0"	POCKET		INTERIOR		
209	Master Bath 1	В	2' - 8"	7' - 0"	POCKET		INTERIOR		
210	Kitchen	F	2' - 0"	6' - 8"	SWING		INTERIOR		
302	Master Bedroom 2	F	2' - 10"	7' - 0"	SWING		INTERIOR		
303	Master Bath 2	В	2' - 10"	7' - 0"	POCKET		INTERIOR		
304	Master Closet	В	2' - 10"	7' - 0"	POCKET		INTERIOR		
305	Master Bath 2	В	2' - 8"	7' - 0"	POCKET		INTERIOR		

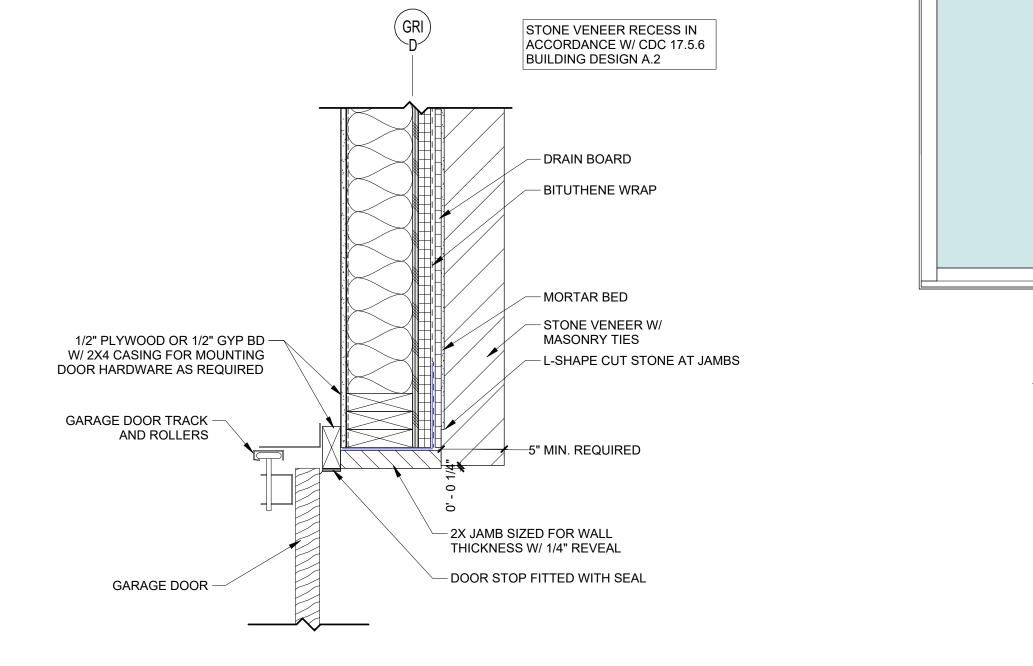




TYPE A

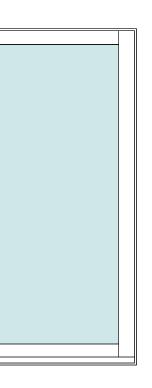


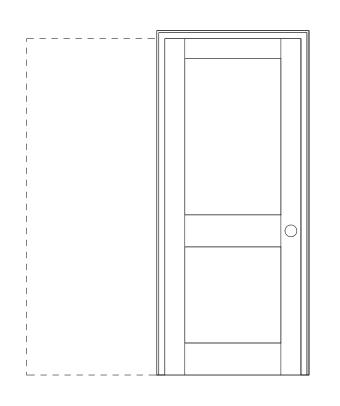


TYPE B

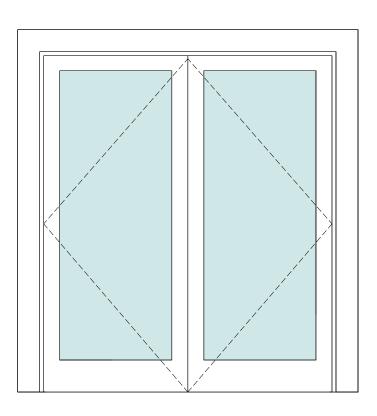


TYPE C

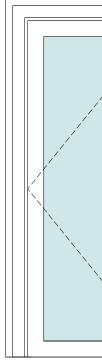


TYPE D

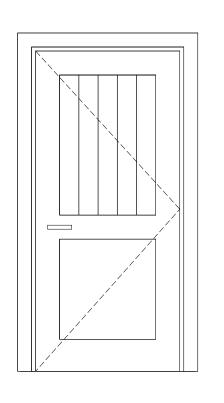

TYPE F

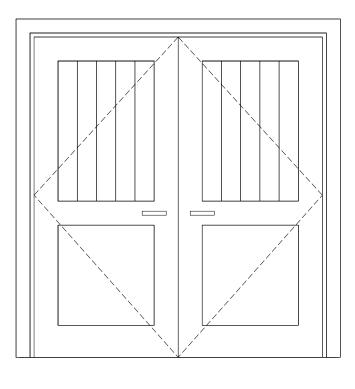

TYPE G

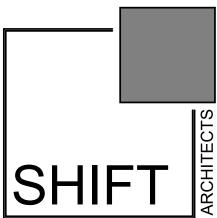

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RESIDENCE


MENHARD

Way, Moun CO 81435,

DOOR SCHEDULE

SHEET NUMBER

A8.2

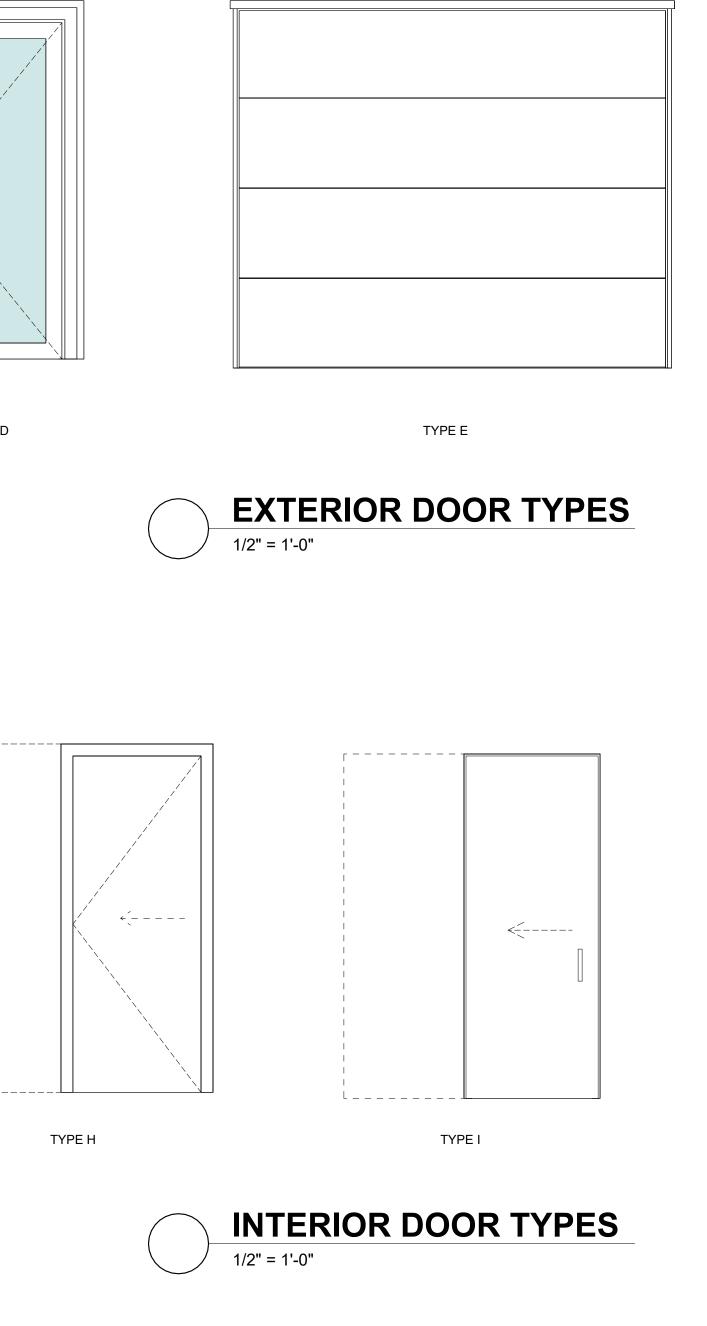



EXTERIOR E-1:


EXTERIOR TWO WAY SCONCE LIGHT


PANDORA LED INDOOR/OUTDOOR WALL SCONCE			
FINISH: BLACK			
MANUFACTURER	MODERN FORMS		
ITEM	MFM1720529		
MATERIAL	ALUMINUM		
GLASS	LED DRIVER		
WIDTH	7"		
HEIGHT	7"		
DEPTH	4.75"		
LAMP TYPE	LED		
BULB TYPE	12W		
LUMENS	270		
COLOR TEMPERATURE	3000K		
CRI	85		
RATED LIFE	50,000 HOURS		
CERTIFICATION	ADA COMPLIANT & ETL LISTED WET		
DARK SKY	YES		
VOLTAGE	120V, DIRECT WIRING		



EXTERIOR E-2: EXTERIOR STEP AND WALL LIGHT


LANDSCAPE LIGHTING LED HORIZONTAL STEP LIGHT			
FINISH: BLACK			
MANUFACTURER	WAC LIGHTING		
ITEM	WAC671977		
MATERIAL	CORRROSION RESISTANT ALUMINUM		
GLASS	ETCHED LENS		
WIDTH	5"		
HEIGHT	3"		
DEPTH	.13"		
LAMP TYPE	LED		
BULB TYPE	3.9W		
LUMENS	68		
COLOR TEMPERATURE	3000K		
CRI	83		
RATED LIFE	60,000 HOURS		
CERTIFICATION	UL LISTED FOR WET LOCATIONS		
DARK SKY	YES		
VOLTAGE	120V, DIRECT WIRING		

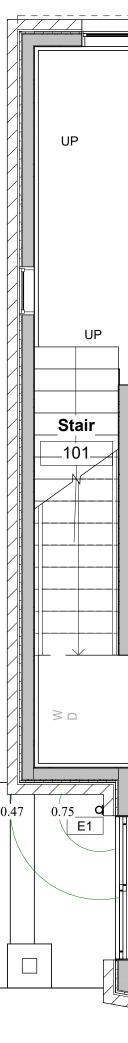


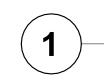



- 1. FIELD VERIFY ALL LIGHTING LOCATIONS.
- 2. TYPICAL LIGHTING LOCATION AT STAIRS: (1 EA) PER LANDING (2 EA) PER RUN
- 3. CONTRACTOR SHALL TAKE CARE IN PLANNING ROUGH FRAMING LAYOUT AS IT RELATES TO THE NEED TO CENTER FIXTURES IN HALLWAYS, RECESSES AND OTHER AREAS WHERE RELATIONSHIPS DON'T OFFER ANY LATITUDE OR FIELD ADJUSTMENTS.
- 4. ALL RECESSED FIXTURES AT INSULATED CEILINGS TO BE IC RATED AND CERTIFIED AIR TIGHT CONSTRUCTION. ALL EXTERIOR FIXTURES, SHOWER FIXTURES AND FIXTURES OVER TUBS TO BE MARKED "SUITABLE FOR DAMP LOCATIONS".
- 5. LIGHTING SHALL BE IN ACCORDANCE WITH TOWN OF MOUNTAIN VILLAGE COMMUNITY DEVELOPMENT CODE 17.5.12 LIGHTING REGULATIONS
- 6. PROVIDE FULL CUT OFF FIXTURES WITH LED 10W 2500K-2700K BULBS PER CDC REQUIREMENTS.
- 7. MOUNT FIXTURES AT 7'-0" AFF MAX PER CDC REQUIREMENTS.
- 8. EXTERIOR LIGHTING ON SECOND AND UPPER FLOORS SHALL REQUIRE EITHER A TIMER OR SENSOR TO REDUCE USAGE AND ENERGY LOSS DURING TIMES OF INACTIVITY.

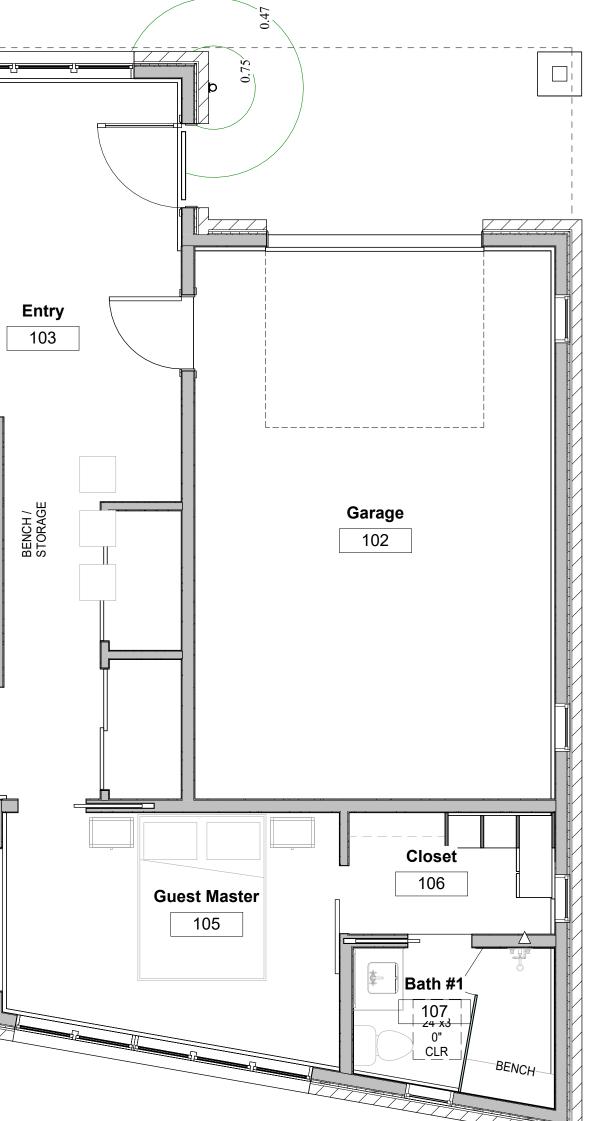

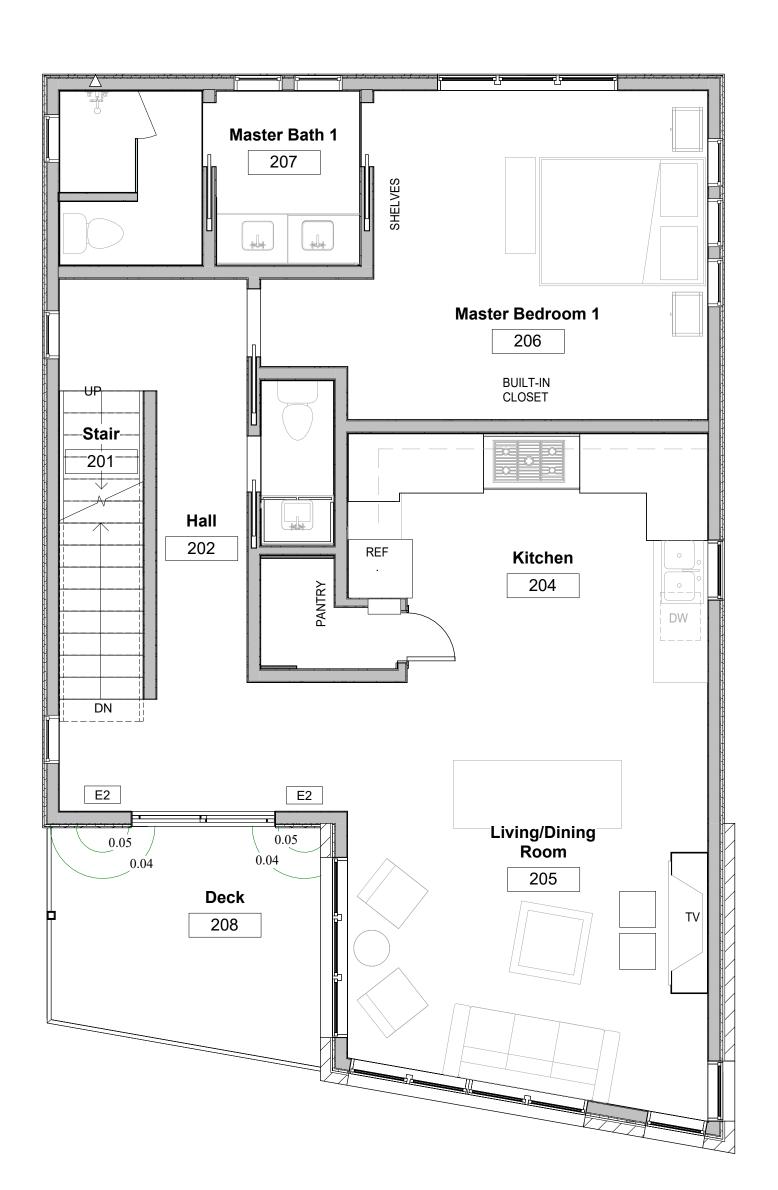




LEVEL 1 LIGHTING PLAN 1/4" = 1'-0"


LIGHTING LEGEND

\odot _{C1}	RECESSED CAN		DOUBLE HEADED MONO POINT
⊘ _{C2}	RECESSED CAN; DIRECTIONAL	MS	MOTION SENSOR
⊘ _{C3}	RECESSED CAN; WET LOCATIONS	° _P	PENDANT
⊘ _{EX}	RECESSED CAN; EXTERIOR —	– – – – _{PD}	UNDER CABINET LED STRIP
\land \land		R	RECESSED LED LIGHT
	CEILING FAN W/ LIGHT	⊕TL	TABLE LAMP RECEPTACLE
		₽FL	FLOOR LAMP RECEPTACLE
⊢ C	2' LINEAR CLOSET FIXTURE	S	WALL MOUNTED SCONCE
FN	EXHAUST FAN	ST	STEP LIGHT
FN	EXHAUST FAN WITH LIGHT	^ې 2	TWO WAY SWITCH
F	CEILING MOUNT FLUORESCENT LIGHT	^ې 3	THREE WAY SWITCH
	SURFACE MOUNT FIXTURE	TV	TV OUTLET
⊕ _{CH}	CHANDELIER	— - — - — WG	WALL GRAZING
⊕ CH	MONO POINT FIXTURE	×	EXTERIOR SCONCE
•			FIXTURE LAYOUT GRID

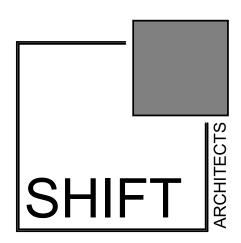

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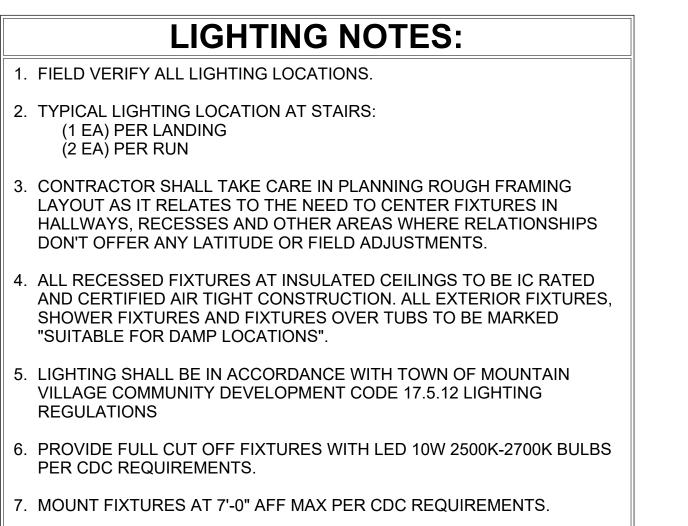


RESIDENCE MENHARD

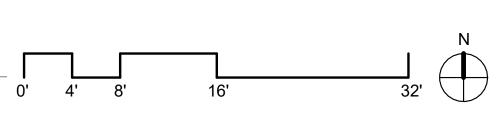
LIGHTING PLANS








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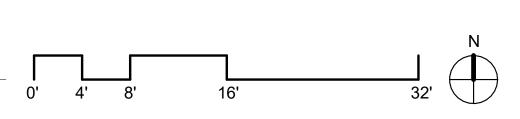
LIGHTING LEGEND
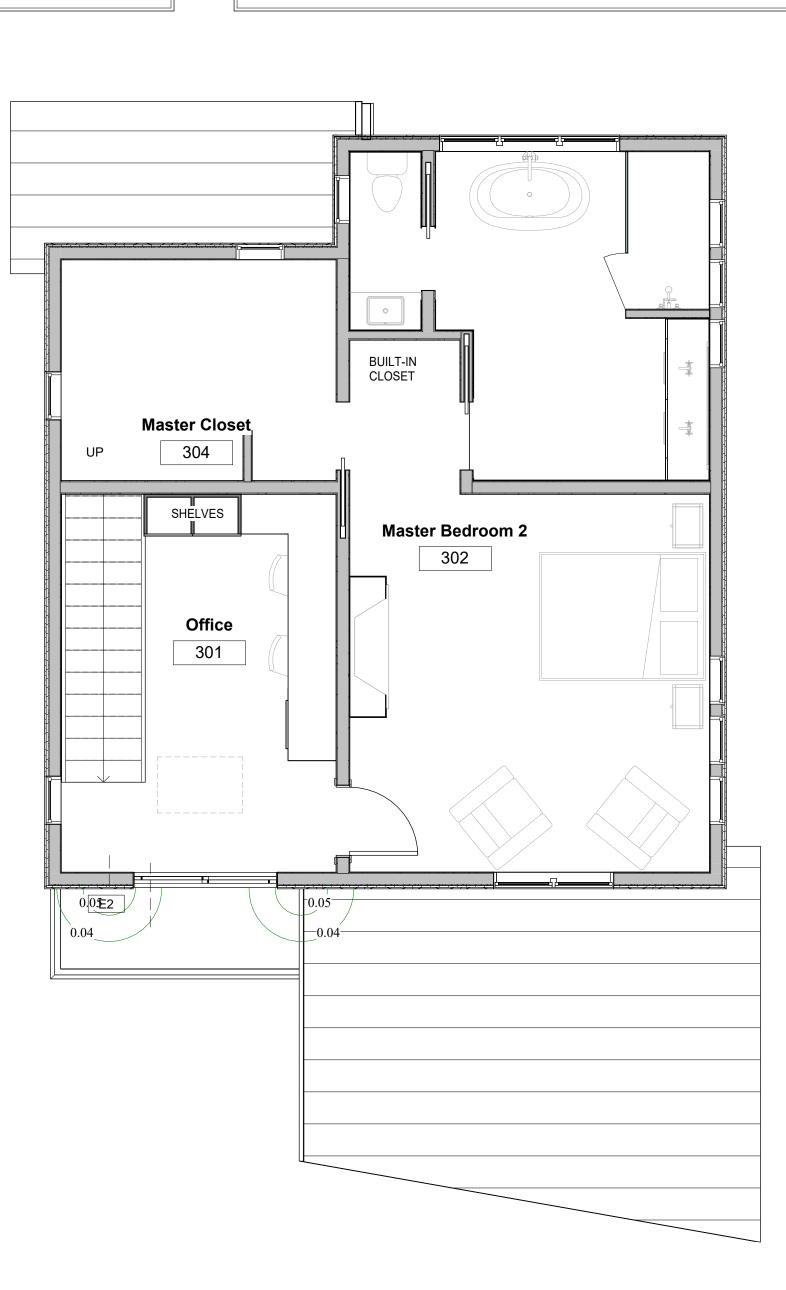
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⊘ _{C2}	RECESSED CAN; DIRECTIONAL	MS	MOTION SENSOR
⊘ _{C3}	RECESSED CAN; WET LOCATIONS	° _P	PENDANT
⊘ _{EX}	RECESSED CAN; EXTERIOR —	– – – — _{PD}	UNDER CABINET LED STRIP
\land \land		R	RECESSED LED LIGHT
	CEILING FAN W/ LIGHT	⊕TL	TABLE LAMP RECEPTACLE
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T A		— - — - — WG	WALL GRAZING
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	MONO POINT FIXTURE		FIXTURE LAYOUT GRID



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RESIDENCE MENHARD

LIGHTING PLANS

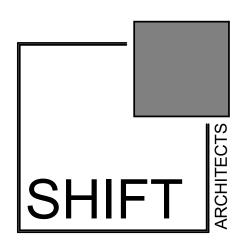