Shift Architects

Date: May 14, 2024

By: Kristine Perpar, Architect

Property address:

Lot 10; Boulders

Mountain Village, CO 81435

Sent to: MV DRB

Re: Development of a Single-Family Residence

Dear Mountain Village Design Review Board,

The proposed home for Unit 10; Lot 649R was designed for sensitivity of the restricted site, the neighbors and the existing topography.

Unit 10 is currently vacant of structures and trees. The building site is essentially flat with a slight slope at the west end.

Exterior elevations, plans and roof are simple in form. Gable and Shed roofs area at pitch of 10:12 and 2.5:12. Exterior materials; stone, metal and wood accents were selected for their sensitivity to the environment, neighboring properties and for durability.

The proposed landscape plan is simple. Aspen trees to be planted on the south side of the structure with perennials and shrubs at the front of the house.

Sincerely,

Kristine Perpar



GENERAL NOTES:

CONTRACT DOCUMENTS:

CONTRACT DOCUMENTS CONSIST OF THE AGREEMENT, GENERAL CONDITIONS, SPECIFICATIONS, DETAIL BOOK AND DRAWINGS, WHICH ARE COOPERATIVE AND CONTINUOUS. WORK INDICATED OR REASONABLY IMPLIED IN ANY ONE OF THE DOCUMENTS SHALL BE SUPPLIED AS THOUGH FULLY COVERED IN ALL. ANY DISCREPANCIES BETWEEN THE PARTS SHALL BE REPORTED TO THE ARCHITECT PRIOR TO THE COMMENCEMENT OF WORK. THESE DRAWINGS ARE PART OF THE CONTRACT DOCUMENTS FOR THIS PROJECT. THESE DRAWINGS ARE THE GRAPHIC ILLUSTRATION OF THE WORK TO BE ACCOMPLISHED. ALL DIMENSIONS NOTED TAKE PRECEDENCE OVER SCALED DIMENSIONS. DIMENSIONS NOTES WITH "N.T.S." DENOTES NOT TO SCALE

THE DRAWINGS FOLLOW A LOGICAL, INTERDISCIPLINARY FORMAT: ARCHITECTURAL DRAWINGS (A SHEETS), CIVIL DRAWINGS (C SHEETS), STRUCTURAL (S SHEETS), MECHANICAL AND PLUMBING (M SHEETS), ELECTRICAL (E SHEETS) AND LIGHTING (LTG SHEETS).

CODE COMPLIANCE:

ALL WORK, MATERIALS AND ASSEMBLIES SHALL COMPLY WITH APPLICABLE STATE AND LOCAL CODES, ORDINANCES AND REGULATIONS. THE CONTRACTOR, SUBCONTRACTORS AND JOURNEYMEN OF THE APPROPRIATE TRADES SHALL PERFORM WORK TO THE HIGHEST STANDARDS OF CRAFTSMANSHIP AND IN ACCORDANCE WITH AIA DOCUMENT A201-SECTION 3. THE BUILDING INSPECTOR SHALL BE NOTIFIED BY THE CONTRACTOR WHEN THERE IS NEED OF INSPECTION AS REQUIRED BY THE INTERNATIONAL BUILDING CODE OR ANY LOCAL CODE OR ORDINANCE.

THESE DOCUMENTS ARE INTENDED TO INCLUDE ALL LABOR, MATERIALS, EQUIPMENT AND SERVICES REQUIRED TO COMPLETE THE WORK DESCRIBED HEREIN.

COORDINATION:

THE CONTRACTOR SHALL CAREFULLY STUDY AND COMPARE THE DOCUMENTS, VERIFY ACTUAL CONDITIONS AND REPORT ANY DISCREPANCIES, ERRORS OR OMISSIONS TO THE ARCHITECT IN A TIMELY MANNER. THE ARCHITECT SHALL CLARIFY OR PROVIDE REASONABLE ADDITIONAL INFORMATION REQUIRED FOR SUCCESSFUL EXECUTION. THE CONTRACTOR SHALL VERIFY AND COORDINATE ALL OPENINGS THROUGH FLOORS, CEILINGS AND WALLS WITH ALL ARCHITECTURAL, INTERIOR, STRUCTURAL, MECHANICAL AND PLUMBING, ELECTRICAL AND LIGHTING DRAWINGS. CONTRACTOR WILL ASSUME RESPONSIBILITY OF ITEMS REQUIRING COORDINATION AND RESOLUTION DURING THE BIDDING PROCESS.

ANY MATERIALS PROPOSED FOR SUBSTITUTION OF THOSE SPECIFIED OR THE CALLED-OUT-BY-TRADE-NAME IN THESE DOCUMENTS SHALL BE PRESENTED TO THE ARCHITECT FOR REVIEW. THE CONTRACTOR SHALL SUBMIT SAMPLES WHEN REQUIRED BY THE ARCHITECT AND SUCH SAMPLES SHALL BE REVIEWED BY THE ARCHITECT BEFORE THE WORK IS PERFORMED. WORK MUST CONFORM TO THE REVIEWED SAMPLES. ANY WORK WHICH DOES NOT CONFORM SHALL BE REMOVED AND REPLACED WITH WORK WHICH CONFORMS AT THE CONTRACTOR'S EXPENSE. SUBCONTRACTORS SHALL SUBMIT REQUESTS FOR REVIEW THROUGH THE GENERAL CONTRACTOR WHEN WORK IS LET THROUGH HIM OR HER. REQUIRED VERIFICATION AND SUBMITTALS TO BE MADE IN ADEQUATE TIME AS NOT TO DELAY WORK IN PROGRESS.

SHOP DRAWINGS SHALL BE SUBMITTED TO THE ARCHITECT FOR HIS OR HER REVIEW WHERE CALLED FOR ANYWHERE IN THESE DOCUMENTS. REVIEW SHALL BE MADE BY THE ARCHITECT BEFORE WORK IS BEGUN, AND WORK SHALL CONFORM TO THE REVIEWED SHOP DRAWINGS, SUBJECT TO REPLACEMENT AS REQUIRED IN PARAGRAPH "SUBSTITUTIONS" ABOVE.

SAFETY & PROTECTION OF WORK

THE CONTRACTOR SHALL BE RESPONSIBLE FOR THE SAFETY AND CARE OF ADJACENT PROPERTIES DURING CONSTRUCTION FOR COMPLIANCE WITH FEDERAL AND STATE O.S.H.A. REGULATIONS, AND FOR THE PROTECTION OF ALL WORK UNTIL IT IS DELIVERED COMPLETED TO THE OWNER.



PROJECT CODE INFORMATION

MULTI-FAMILY ZONING:

BOULDER ESTATES SUBDIVISION:

BUILDING CODE: IRC 2018 AND ALL APPLICABLE CODES AS

REQUIRED BY THE TOWN OF MOUNTAIN VILLAGE

DESIGN REQUIRMENTS: DECLARATION AND BOULDER ESTATES DESIGN

MECHANICAL - 1 HR

COVENANTS IN ADDITION TO ANY REQUIREMENTS BY THE TOWN OF MOUNTAIN VILLAGE

DESCRIPTION: MULTI-STORY DWELLING

OCCUPANCY CLASSIFICATION: R-3

AUTOMATIC FIRE SPRINKLER: NOT REQUIRED

GARAGE - 1 HR FIRE RESISTIVE RATING:

BUILDING FOOTPRINT:

1,483.30 SF ALLOWABLE **PROPOSED** 937 SF

PROJECT INFORMATION

TYPE OF UNIT:	SINGLE FAMILY HOME	MAX BUILDING HEIGHT: ALLOWABLE	40'-0" (35'-0" + 5'-0" GABLE RIDGE, CE TABLE 3-3 FOOTNOTE 1)
GROSS FLOOR AREA: LIVING	705.05	PROPOSED	38.84'
BASEMENT GROUND LEVEL MAIN LEVEL	785 SF 481 SF 743 SF	MAX AVERAGE HEIGHT: ALLOWABLE	35'-0" (30'-0" + 5'-0" GABLE RIDGE, CE TABLE 3-3 FOOTNOTE 1)
UPPER LEVEL TOTAL:	785 SF <u>2,794 SF</u>	PROPOSED	32.90'
GARAGE	304 SF	PARKING REQUIRED:	3 SPACES PROVIDED (1 ENCLOSED IN GARAGE)
TOTAL:	3098 SF		(2 SURFACE)
LOT AREA:	2282.01 SF		

VICINITY MAP

LOCATION



PROJECT TEAM

OWNER:

DANIEL OLDMIXON PO BOX 99 TELLURIDE, CO 81435 P.970.708.9515 DANIEL@OLDMIXONCO.COM

ARCHITECT:

SHIFT ARCHITECTS KRISTINE PERPAR - ARCHITECT 100 WEST COLORADO STE. 211 TELLURIDE, CO 81435 P. 970.275.0263 kristine@shift-architects.com

GENERAL CONTRACTOR:

OLDMIXON CONSTRUCTION DANIEL OLDMIXON PO BOX 99 TELLURIDE, CO 81435 P.970.708.9515 DANIEL@OLDMIXONCO.COM **SURVEYOR**:

MECHANICAL:

LANDSCAPING:

SHIFT ARCHITECTS

TELLURIDE, CO 81435

kristine@shift-architects.com

P. 970.275.0263

KRISTINE PERPAR - ARCHITECT

100 WEST COLORADO STE. 211

TBD

FOLEY ASSOCIATES, INC. 125 W. PACIFIC, SUITE B-1 P.O. BOX 1385 TELLURIDE, CO 81435 P. 970.728.6153 F. 970.728.6050

CIVIL:

UNCOMPAHGRE ENGINEERING LLC DAVID BALLODE P.E. PO BOX 3945 TELLURIDE, CO 81435 P. 970.729.0683 dballode@msn.com

STRUCTURAL:

TBD

SHEET INDEX

GENERAL

COVER SHEET

SURVEY SURVEY / EXISTING CONDITIONS

CIVIL NOTES C1

C2 SITE DRAINAGE AND UTILITY PLAN CONSTRUCTION MITIGATION PLAN

C3 ARCHITECTURAL

A1.1 ARCHITECTURAL SITE PLAN

LANDSCAPE PLAN A1.2

A3.1 FLOOR PLANS A3.2 FLOOR & ROOF PLAN

A4.1 PROPOSED ELEVATIONS

A4.2 PROPOSED ELEVATIONS

ELEVATION HEIGHT CALCS A4.3

A4.4 **ELEVATION HEIGHT CALCS**

A4.5 COLORIZED PERSPECTIVE

A4.6 COLORIZED PERSPECTIVE

A8.1 DOOR & WINDOW SCHEDULE


LIGHTING

LTG1.1 LIGHTING PLANS LTG1.2 LIGHTING PLAN

COVER SHEET

Z

SHEET NUMBER

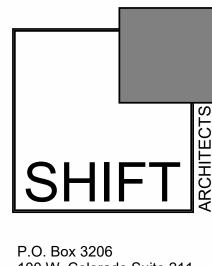

100 W. Colorado Suite 211 Telluride, Colorado 81435 p 970-728-8145 kristine@shift-architects.com www.shift-architects.com

PROJECT ISSUE DATE: 05.17.24 REVISED DRB SUBMITTAL

REVISION

NO. DATE DESC.

This Existing Conditions Plan Unit 10, The Boulders at Mountain Village, was field surveyed in August of 2021 under the direct responsibility, supervision and checking of Jeffrey C. Haskell of Foley Associates, Inc., being a Colorado Licensed Surveyor. It does not constitute a Land Survey Plat or Improvement Survey Plat as defined by section 38-51-102 C.R.S.

P.L.S. NO. 37970

PROPERTY DESCRIPTION:

UNIT 10, THE BOULDERS AT MOUNTAIN VILLAGE, ACCORDING TO THE PLAT RECORDED JANUARY 24, 2003 IN PLAT BOOK 1 AT PAGE 3096, AND AS DEFINED AND DESCRIBED IN THE DECLARATION FOR THE BOULDERS AT MOUNTAIN VILLAGE RECORDED JANUARY 24, 2003 UNDER RECEPTION NO. 354564,

COUNTY OF SAN MIGUEL, STATE OF COLORADO.

NOTES:

 \boxtimes

TRANSFORMER

- 1. Easement research and property description from Land Title Guarantee Company, Order Number TLR86011806, dated July 8, 2021 at 5:00 P.M.
- 2. According to FEMA Flood Insurance Rate Map 080168, Panel Number 0291 D, dated September 30, 1992, this parcel is within Zone X; Areas determined to be outside 500-year flood plain.
- 3. Benchmark: "CP BENCH" as shown hereon with an assumed elevation of 9086.89 feet.
- 4. Contour interval is one foot.
- 5. BASIS OF BEARINGS: Found monuments along the Western boundary of Unit 10, as shown hereon, assumed to have the record bearing of N 42°33'18" E according to Plat Book 1 at page 3096.
- 6. Slopes steeper than 30% exist on Unit 10 as shown
- 7. The utilities shown hereon are based on visible infrastructure and utility locates should be performed by respective providers prior to construction.
- 8. No trees greater than 4" in diameter exist on Unit 10.
- No known wetlands exist on Unit 10.
- 10. NOTICE: According to Colorado law, you must commence any legal action based upon any defect in this survey within three years after you first discover such defect. In no event may any action based upon any defect in this survey be commenced more than ten years from the date of the certification shown hereon.

Existing Conditions Plan

Unit 10, The Boulders at Mountain Village, located within Section 33, T.43N., R.9W., N.M.P.M., San Miguel County, Colorado

FO/MC ASSOCIATES, INC. ENGINEERING PLANNING SURVEYING Start date: 08 / 2021 Drawing path: dwg\21033 ECP 08-21 (ADJUSTED ELEV).dwg

Technician:

Technician:

Checked by:

⊠9086.46′

970-728-6153 970-728-6050 fax PO Box 1385 125 W. Pacific Ave., Suite B-1 Telluride, Colorado, 81435 Project #: 21033 Sheet1 of 1

GENERAL CIVIL ENGINEERING NOTES:

1. THE EXISTING UTILITY LINES SHOWN ON THE PLANS ARE APPROXIMATE. AT LEAST TWO (2) FULL WORKING DAYS PRIOR TO TO COMMENCING CONSTRUCTION, THE CONTRACTOR SHALL CONTACT THE UTILITY NOTIFICATION CENTER OF COLORADO @ 1-800-922-1987 OR 811 TO GET ALL UTILITIES LOCATED. IF ANY OF THESE UNDERGROUND UTILITIES ARE IN CONFLICT WITH THE CONSTRUCTION PLANS, THE CONTRACTOR SHALL NOTIFY THE ENGINEER AND WORK WITH THE ENGINEER TO FIND A SOLUTION BEFORE THE START OF CONSTRUCTION.

INSTALLATION AND SEPARATION REQUIREMENTS SHALL BE COORDINATED WITH THE INDIVIDUAL UTILITY PROVIDERS.

THE UTILITY PROVIDERS ARE:
SEWER AND WATER: TOWN OF MOUNTAIN VILLAGE
NATURAL GAS: BLACK HILLS ENERGY
POWER: SAN MIGUEL POWER
BROADBAND: CLEARNETWORX
TELEPHONE: CENTURY LINK

2. PRIOR TO BEGINNING ANY CONSTRUCTION ACTIVITIES, ALL NECESSARY PERMITS SHALL BE OBTAINED BY THE OWNER OR CONTRACTOR.

3. IT IS THE CONTRACTOR'S RESPONSIBILITY TO INSURE THAT EXCAVATED SLOPES ARE SAFE AND COMPLY WITH OSHA REQUIRIEMENTS. REFER TO THE SITE—SPECIFIC REPORT FOR THIS PROJECT FOR ADDITIONAL INFORMATION...

4. ALL TRENCHES SHALL BE ADEQUATELY SUPPORTED OR LAID BACK PER OSHA REGULATIONS.

5. ALL MATERIALS AND CONSTRUCTION SHALL BE IN CONFORMANCE WITH THE TOWN OF MOUNTAIN VILLAGE DESIGN STANDARDS LATEST EDITION. ALL CONSTRUCTION WITHIN EXISTING STREET OR ALLEY RIGHT—OF—WAY SHALL BE SUBJECT TO TOWN OF MOUNTAIN VILLAGE INSPECTION.

6. THE CONTRACTOR SHALL HAVE ONE COPY OF THE STAMPED PLANS ON THE JOB SITE AT ALL TIMES.

7. THE CONTRACTOR SHALL NOTIFY THE TOWN 48 HOURS PRIOR TO THE START OF CONSTRUCTION.

8. THE CONTRACTOR IS RESPONSIBLE FOR IMPLEMENTING AND MAINTAINING EROSION AND SEDIMENT CONTROL MEASURES AT ALL TIMES DURING CONSTRUCTION. THE ADJOINING ROADWAYS SHALL BE FREE OF DEBRIS AT THE END OF CONSTRUCTION ACTIVITIES EACH DAY.

9. THE CONTRACTOR SHALL PROVIDE, ERECT AND MAINTAIN PROPER TRAFFIC CONTROL DEVICES UNTIL THE SITE IS OPEN TO TRAFFIC. ANY TRAFFIC CLOSURES MUST BE COORDINATED WITH THE TOWN OF MOUNTAIN VILLAGE.

10. ALL DAMAGE TO PUBLIC STREETS AND ROADS, INCLUDING HAUL ROUTES, TRAILS, OR STREET IMPROVEMENTS, OR TO PRIVATE PROPERTY, SHALL BE REPAIRED AT THE SOLE EXPENSE OF THE CONTRACTOR TO THE ORIGINAL CONDITIONS.

11. WHEN AN EXISTING ASPHALT STREET IS CUT, THE STREET MUST BE RESTORED TO A CONDITION EQUAL TO OR BETTER THAN ITS ORIGINAL CONDITION. THE FINISHED PATCH SHALL BLEND SMOOTHLY INTO THE EXISTING SURFACE. ALL LARGE PATCHES SHALL BE PAVED WITH AN ASPHALT LAY—DOWN MACHINE.

12. IF DEWATERING IS REQUIRED, THE CONTRACTOR SHALL NOTIFY THE ENGINEER. ANY DISCHARGE REQUIREMENTS SHALL BE COORDINATED WITH THE TOWN OF MOUNTAIN VILLAGE.

13. CONTRACTOR SHALL NOTIFY ALL RESIDENTS IN WRITING 24 HOURS PRIOR TO ANY SHUT-OFF IN SERVICE. THE NOTICES MUST HAVE CONTRACTOR'S PHONE NUMBER AND NAME OF CONTACT PERSON, AND EMERGENCY PHONE NUMBER FOR AFTER HOURS CALLS. ALL SHUT-OFF'S MUST BE APPROVED BY THE TOWN AND TOWN VALVES AND APPURTENANCES SHALL BE OPERATED BY TOWN PERSONNEL.

14. CONTRACTOR SHALL KEEP SITE CLEAN AND LITTER FREE (INCLUDING CIGARETTE BUTTS) BY PROVIDING A CONSTRUCTION DEBRIS TRASH CONTAINER AND A BEAR-PROOF POLY-CART TRASH CONTAINER, WHICH IS TO BE LOCKED AT ALL TIMES.

15. CONTRACTOR MUST BE AWARE OF ALL TREES TO REMAIN PER THE DESIGN AND APPROVAL PROCESS AND PROTECT THEM ACCORDINGLY.

16. THE CONTRACTOR SHALL PROVIDE UNDERGROUND UTILITY AS-BUILTS TO THE TOWN.

17. ALL STRUCTURAL FILL UNDER HARDSCAPE OR ROADS MUST BE COMPACTED TO 95% MODIFIED PROCTOR (MIN.) AT PLUS OR MINUS 2% OF THE OPTIMUM MOISTURE CONTENT. NON—STRUCTURAL FILL SHALL BE PLACED AT 90% (MIN.) MODIFIED PROCTOR.

18. UNSUITABLE MATERIAL SHALL BE REMOVED AS REQUIRED BY THE SOILS ENGINEER. ALL MATERIALS SUCH AS LUMBER, LOGS, BRUSH, TOPSOIL OR ORGANIC MATERIALS OR RUBBISH SHALL BE REMOVED FROM ALL AREAS TO RECEIVE COMPACTED FILL.

19. NO MATERIAL SHALL BE COMPACTED WHEN FROZEN.

20. NATIVE TOPSOIL SHALL BE STOCKPILED TO THE EXTENT FEASIBLE ON THE SITE FOR USE ON AREAS TO BE REVEGETATED.

21. THE CONTRACTOR SHALL BE RESPONSIBLE FOR DUST ABATEMENT AND EROSION CONTROL MEASURES DEEMED NECESSARY BY THE TOWN, IF CONDITIONS WARRANT THEM.


22. ALL DISTURBED GROUND SHALL BE RE-SEEDED WITH A TOWN-APPROVED SEED MIX. REFER TO THE LANDSCAPE PLAN.

23. THE CONTRACTOR IS REQUIRED TO PROTECT ALL EXISTING SURVEY MONUMENTS AND PROPERTY CORNERS DURING GRADING AND CONSTRUCTION.

24. ALL UNDERGROUND PIPE SHALL BE PROTECTED WITH BEDDING TO PROTECT THE PIPE FROM BEING DAMAGED.

25. HOT TUBS SHALL DRAIN TO THE SANITARY SEWER (OR PUMPED TO AA CLEAN-OUT).

26. THE UTILITY PLAN DEPICTS FINAL UTILITY LOCATIONS BUT HAS BEEN COMPLETED AT A PRELIMINARY STAGE. CONTRACTOR SHALL VERIFY ALIGNMENTS WITH THE ARCHITECT PRIOR TO CONSTRUCTION.

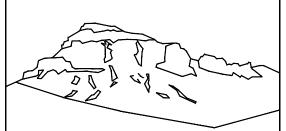

Uncompahgre Engineering, LLC

P.O. Box 3945 Telluride, CO 81435 970-729-0683

2022-03-14

2024-05-16


<u>SUBMISSIONS:</u>

SUBMITTAL SUBMITTAL

MITTAL

Oldmixon Residence Lot 10 The Boulders


Mtn. Village, CO

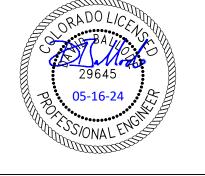



CONTRACTOR TO REVIEW AND COMPARE ALL
CHAPTERS AND INTERDISCIPLINARY DRAWINGS
AND REPORT ANY DISCREPANCIES TO THE
ARCHITECT PRIOR TO ANY FIELD WORK BEING
DONE IN ACCORDANCE WITH AIA DOCUMENT A20

Notes

C1

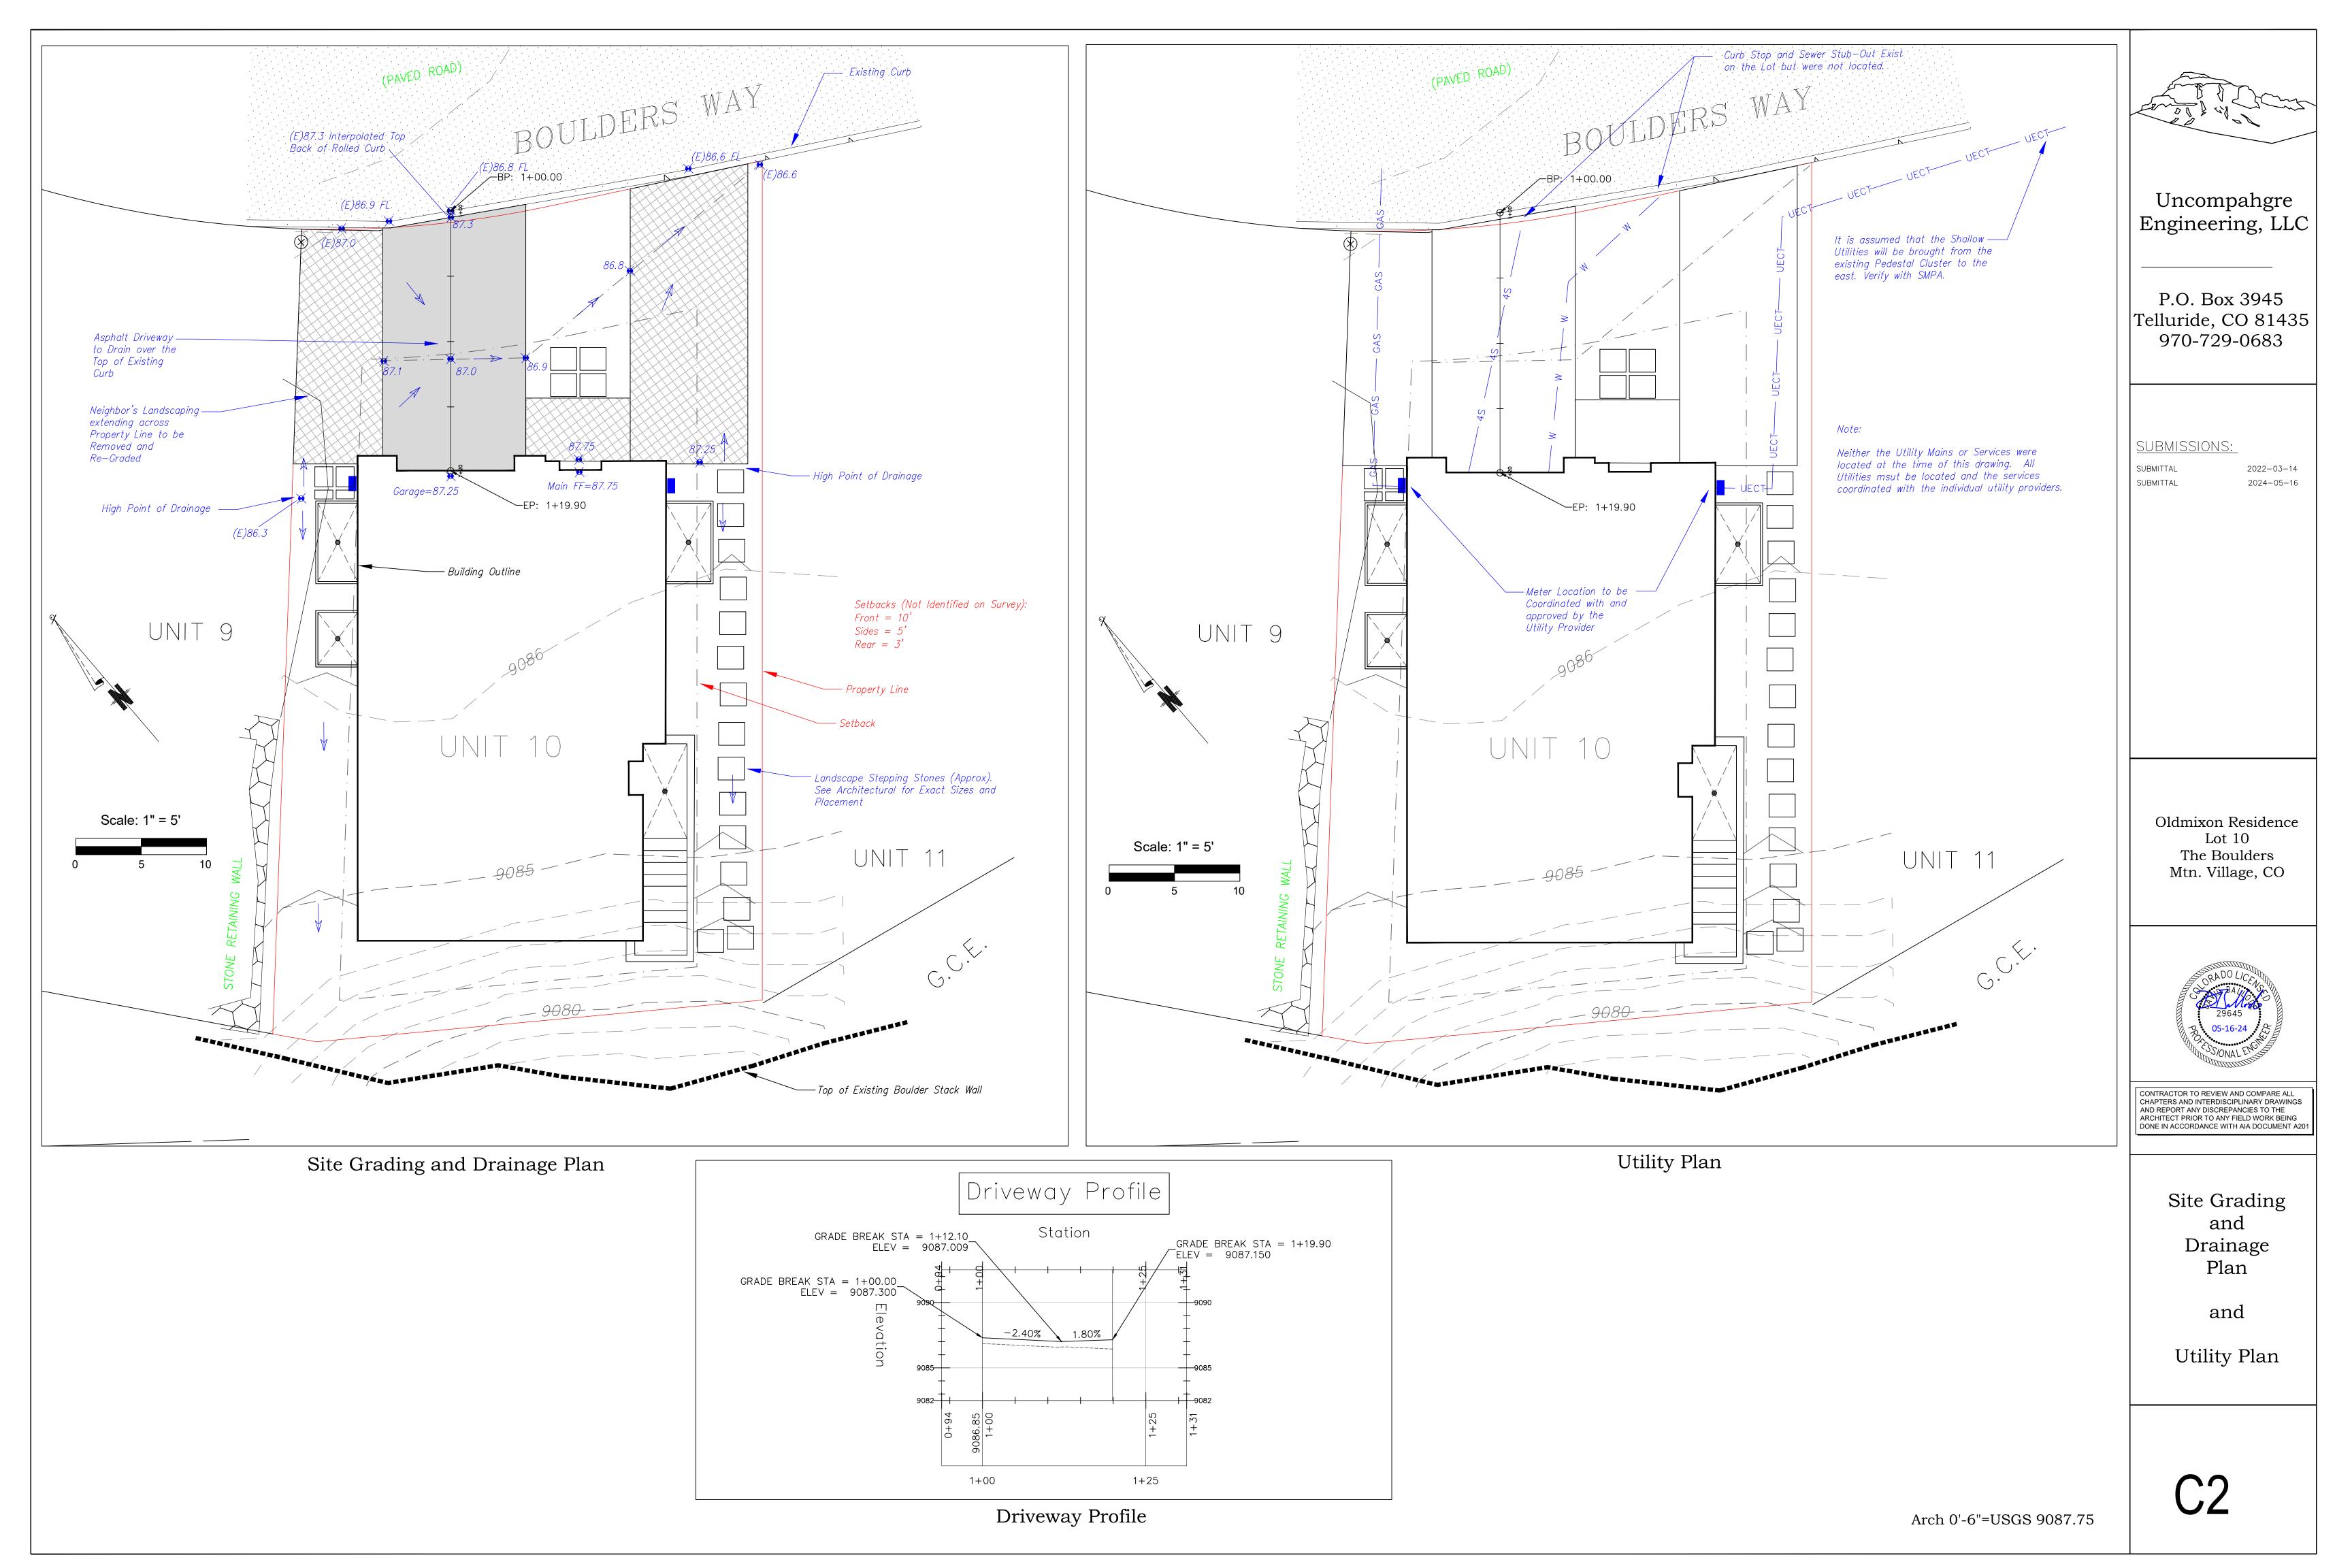

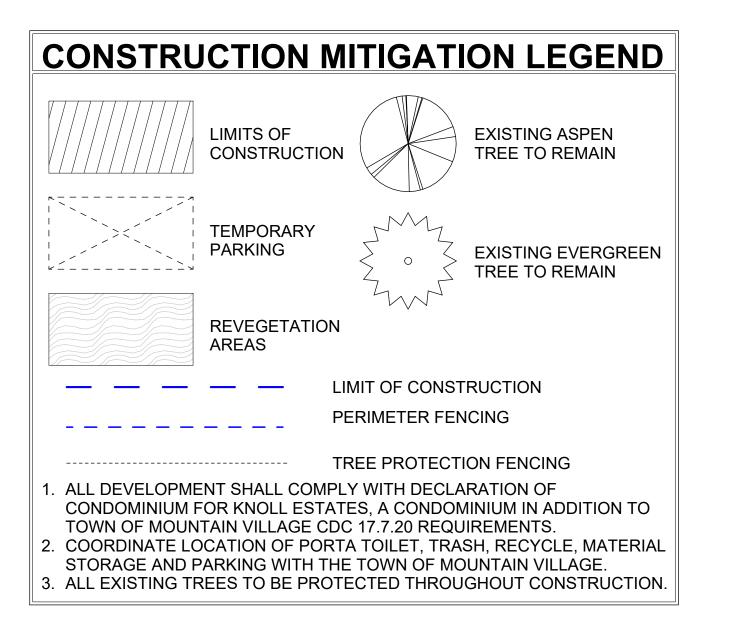


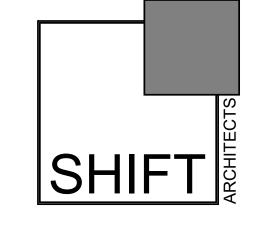

PROJECT ISSUE DATE: 05.17.24 REVISED DRB SUBMITTAL

REVISION

NO. DATE DESC.

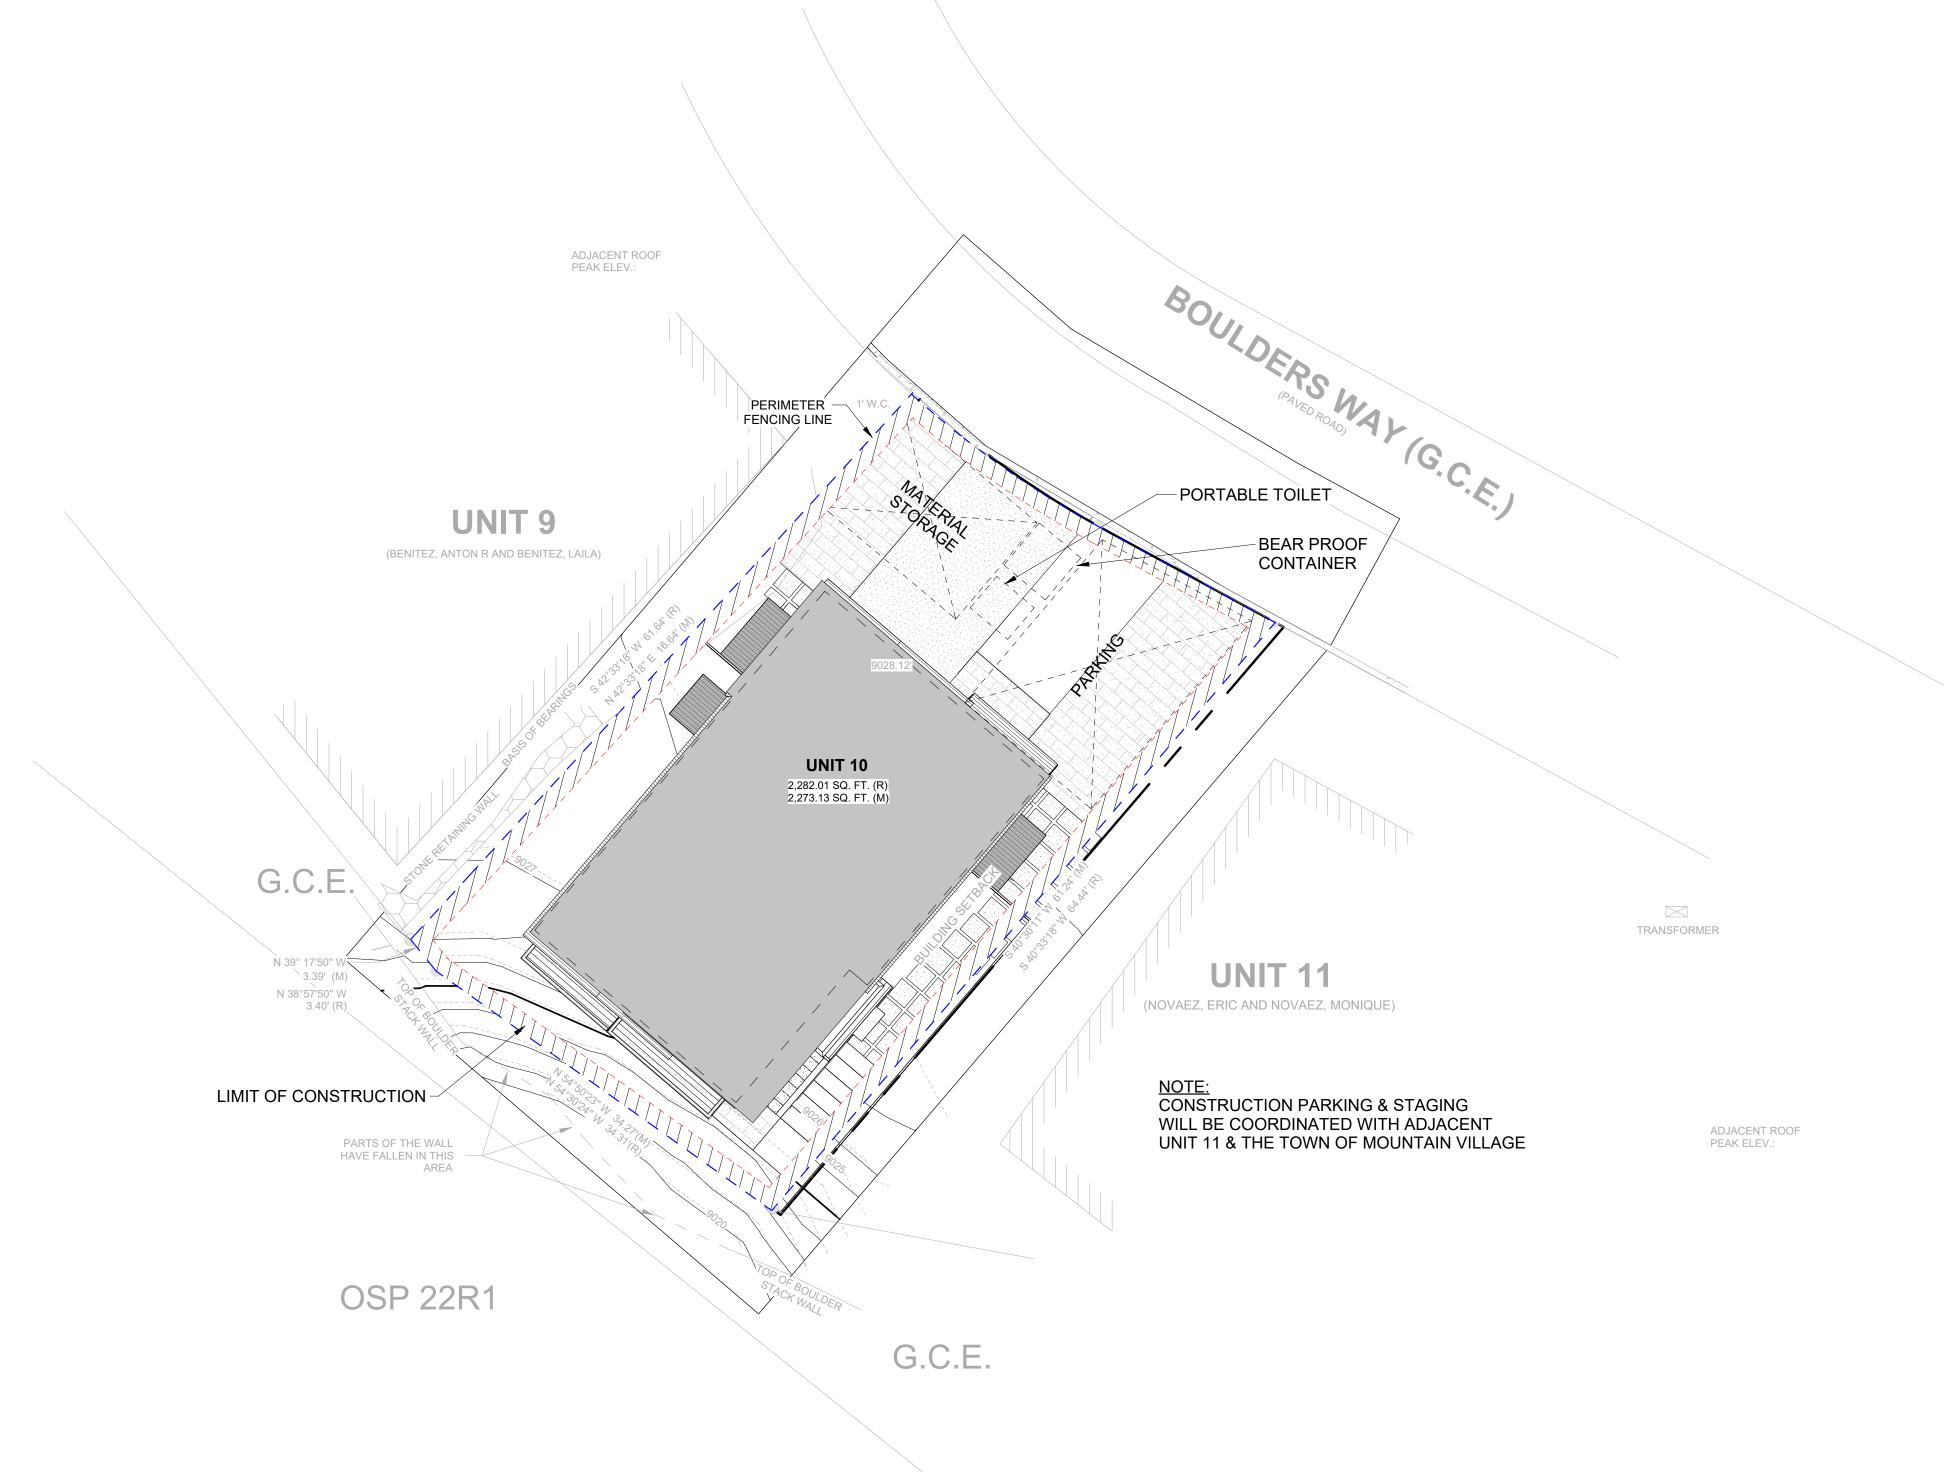

CONSTRUCTION MITIGATION PLAN

1/8" = 1'-0"

0' 4' 8' 16' 32'

CONSTRUCTION MITIGATION PLAN


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C3


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5' FENCE ELEVATION



BOULDERS WAY

CONCRETE DRIVEWAY

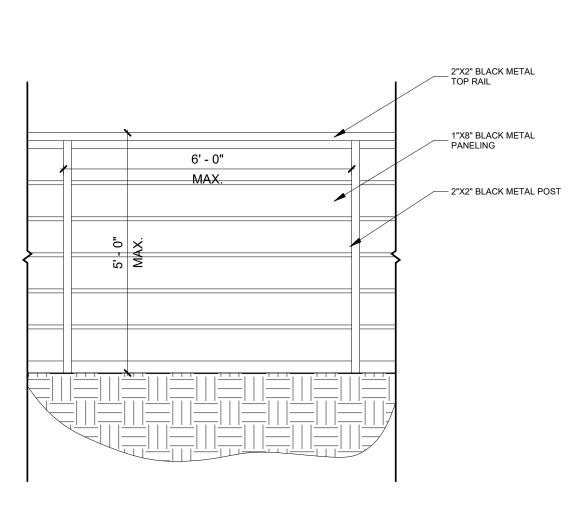___22.75'__

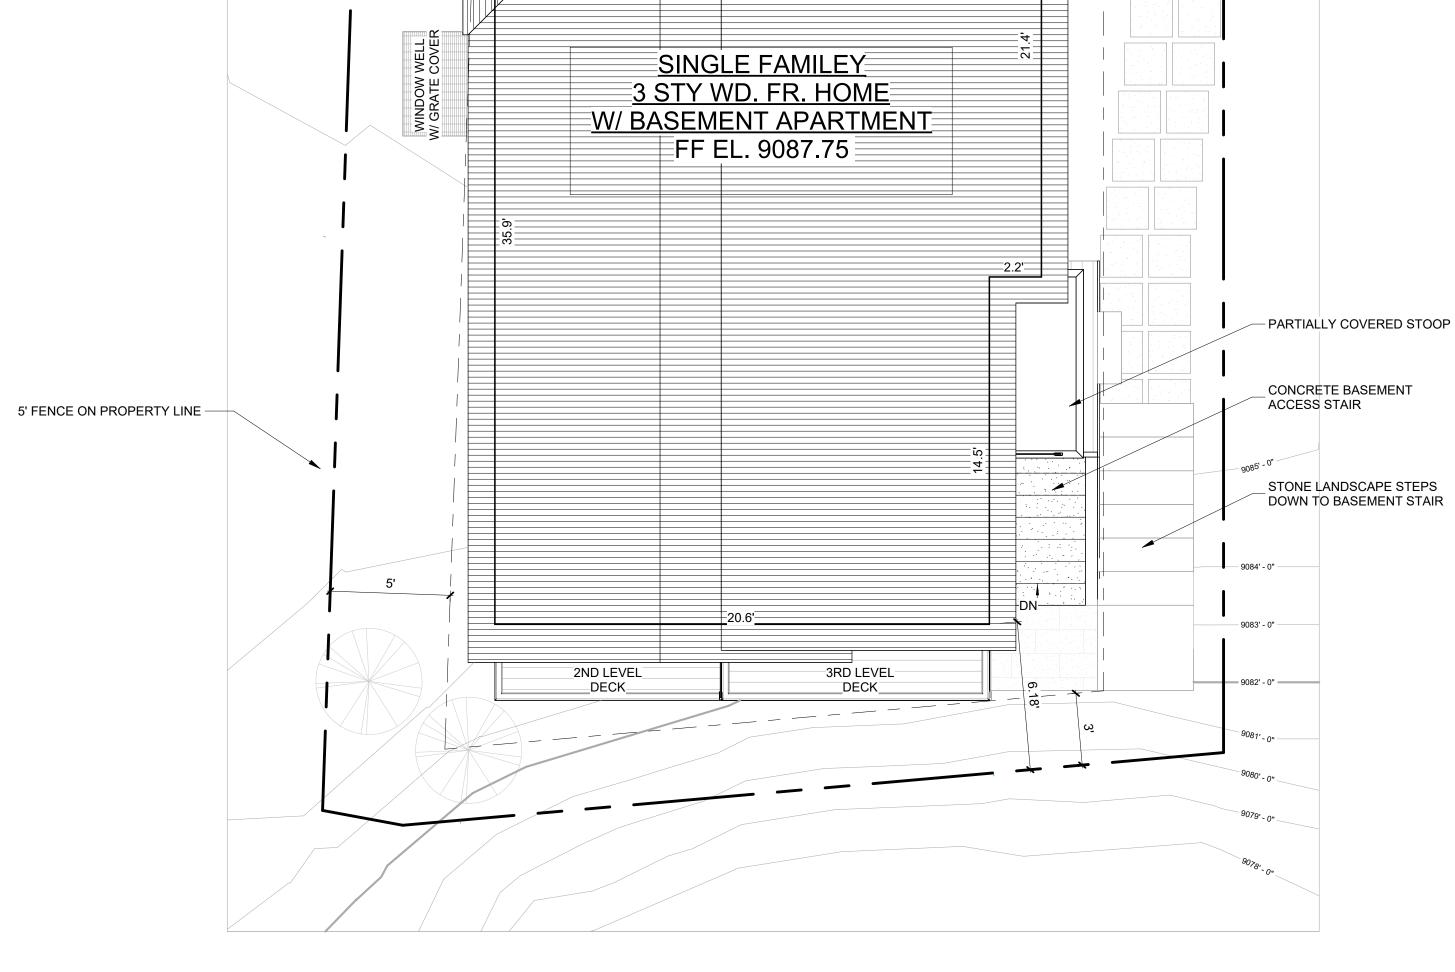- PAVERS -

5.65'

9 X 18 PARKING AREA

2ND LEVEL -DECK-

PARTIALLY COVERD FRONT STOOP

7.58'

SETBACK LINE

PROPERTY LINE



GENERAL NOTES:

- ALL TREES AND SHRUBS TO BE LOCATED BY PROJECT ARCHITECT / OWNER.
 ALL TREES AND SHRUBS SHALL BE BACKED FILLED WITH A TOPSOIL / ORGANIC FERTILIZER MIXTURE AT A 2:1 RATIO.
- 3. NECESSARY TREES SHALL BE STACKED WITH 4' METAL POSTS. TREES SHALL BE GUYED WITH 12 GAUGE GALVANIZED WIRE AND POLYPROPYLENE TREE RACE STRIPS.
- 4. PERENNIAL PLANTING BEDS SHALL BE TILLED 6" DEPTH AND AMENDED WITH
- TOPSOIL AND ORGANIC FERTILIZER AT A 2:1 RATIO.

 5. SEE PLANTING DETAILS FOR ALL DECIDUOUS AND EVERGREEN TREES.
- 6. MULCH ALL PERENNIAL BEDS WITH A PINE BARK SOIL CONDITIONER BY
- SOUTHWEST IMPORTERS; SHREDDED CEDAR BARK.

 7. ALL PLANT MATERIAL TO MEET THE AMERICAN STANDARD FOR NURSERY STOCK.
- 8. LANDSCAPING SHALL BE IN ACCORDANCE WITH L.U.C. "SECTION 3-505 MAINTENANCE, REMOVAL, OR RELOCATION OF TREES".

NOXIOUS WEEDS:

1. ALL PLANTED MATERIALS INCLUDING SEEDS, SHALL BE NON NOXIOUS SPECIES AS SPECIFIED WITHIN THE SAN MIGUEL COUNTY'S MOST CURRENT NOXIOUS WEED LIST.

LANDSCAPE MAINTENANCE NOTES:

- 1. TURF SHALL BE AERATED 2 TO 3 TIMES PER YEAR TO INCREASE THE WATER ABSORPTION RATE. NECESSARY ORGANIC FERTILIZATION AND AMENDMENT SHALL BE INCORPORATED AT THE SAME TIME.
- NECESSARY ORGANIC FERTILIZERS AND AMENDMENT SHALL BE ADDED TO PERENNIAL BEDS SEASONALLY ALONG WITH MULCH.
- ALL SHRUBS IN SNOW SHED AREAS TO BE CUT BACK IN FALL TO 12"-18" IN HEIGHT.
 IRRIGATION SYSTEM TO BE BLOWN OUT BY OCTOBER 31ST EACH FALL AND
- TURNED ON BY JUNE 1ST EACH SPRING.

REVEGETATION NOTES:

- SUBSOIL SURFACE SHALL BE TILLED TO A 4" DEPTH ON NON FILL AREAS.
 TOPSOIL SHALL BE SPREAD AT A MINIMUM DEPTH OF 4" OVER ALL AREAS TO BE REEMITTED (EXCEPT OF SLOPES GREATER THAN 3:1) AND AMENDMENT ROTOTILLED AT A RATE OF THREE CUBIC YARDS PER THOUSAND SQUARE FEET.
- 3. BROADCASTING OF SEED SHALL BE DONE IMMEDIATELY AFTER TOPSOIL IS APPLIED (WITHIN 10 DAYS) TO MINIMIZE EROSION AND WEEDS.
- 4. AREAS WHICH HAVE BEEN COMPACTED OR RELATIVELY UNDISTURBED NEEDING
- SEEDING, SHALL BE SCARIFIED BEFORE BROADCASTING THE SEED.

 5. BROADCASTING WITH SPECIFIED SEED MIX AND FOLLOW WITH DRY MULCHING, STRAW OR HAY SHALL BE UNIFORMLY APPLIED OVER SEEDED AREA AT A RATE
- OF 1.5 TONS PER ACRE FOR HAY OR 2 TONS PER ACRE FOR STRAW, CRIMP IN.

 6. ON SLOPES GREATER THAN 3:1 EROSION CONTROL BLANKET SHALL BE APPLIED
- IN PLACE OF STRAW MULCH AND PINNED.

 7. ALL UTILITY CUTS SHALL BE REVEGETATED WITHIN TWO WEEKS AFTER
- INSTALLATION OF UTILITIES TO PREVENT WEED INFESTATION.


 8 SEED ALL AREAS LABELED NATIVE GRASS SEED WITH THE FOLLOWING MIXTUE
- 8. SEED ALL AREAS LABELED NATIVE GRASS SEED WITH THE FOLLOWING MIXTURE AT A RATE OF 12 LBS. PER ACRE.


SPECIES	PURE LIVE SEED PER ACRE
WESTERN YARROW	5%
TALL FESCUE	10%
ARIZONA FESCUE	5%
HARD FESCUE	5%
CREEPING RED FESCUE	10%
ALPINE BLUEGRASS	15%
CANADA BLUEGRASS	10%
PERENNIAL RYEGRASS	15%
SLENDER WHEATGRASS	10%
MOUNTAIN BROME	15%
MOUNTAIN BROME (BROMAR)	10%

	LANDSCAPE LE	GEND	
	CONCRETE PAVERS		INDIGENOUS SHRUBS
	FENCE; WOOD FRAME AND HOGWIRE	·	
	METAL GATE TO MATCH FENCE		TREE; ASPEN
	METAL LANDSCAPE WALL	. N. M. 1.	
	METAL GRATE WITH 3' X 3' EGRESS HATCH AT WINDOW WELL	0	TREE; SPRUCE
	DISTURBED AREAS		
	MULCH LANDSCAPE BEDDING	The same of the sa	
+ + + + + + + + + + + + + + + + + + +	PERENNIAL BEDDING		- FENCE; WOOD
	FLAGSTONE		
NOTE: ALL EXISTING TREES TO BE PROTECTED THROUGHOUT CONSTRUCTION.			

PLANTING SCHEDULE				
Туре	LATIN NAME	Type Mark	SIZE	Count
WOODS DOSE	DOCA MOODCII	D1		0
WOODS ROSE	ROSA WOODSII	PT		8
QUAKING ASPEN	POPULUS TRMULOIDES	P2	3" CAL DBH	2

Grand total: 10

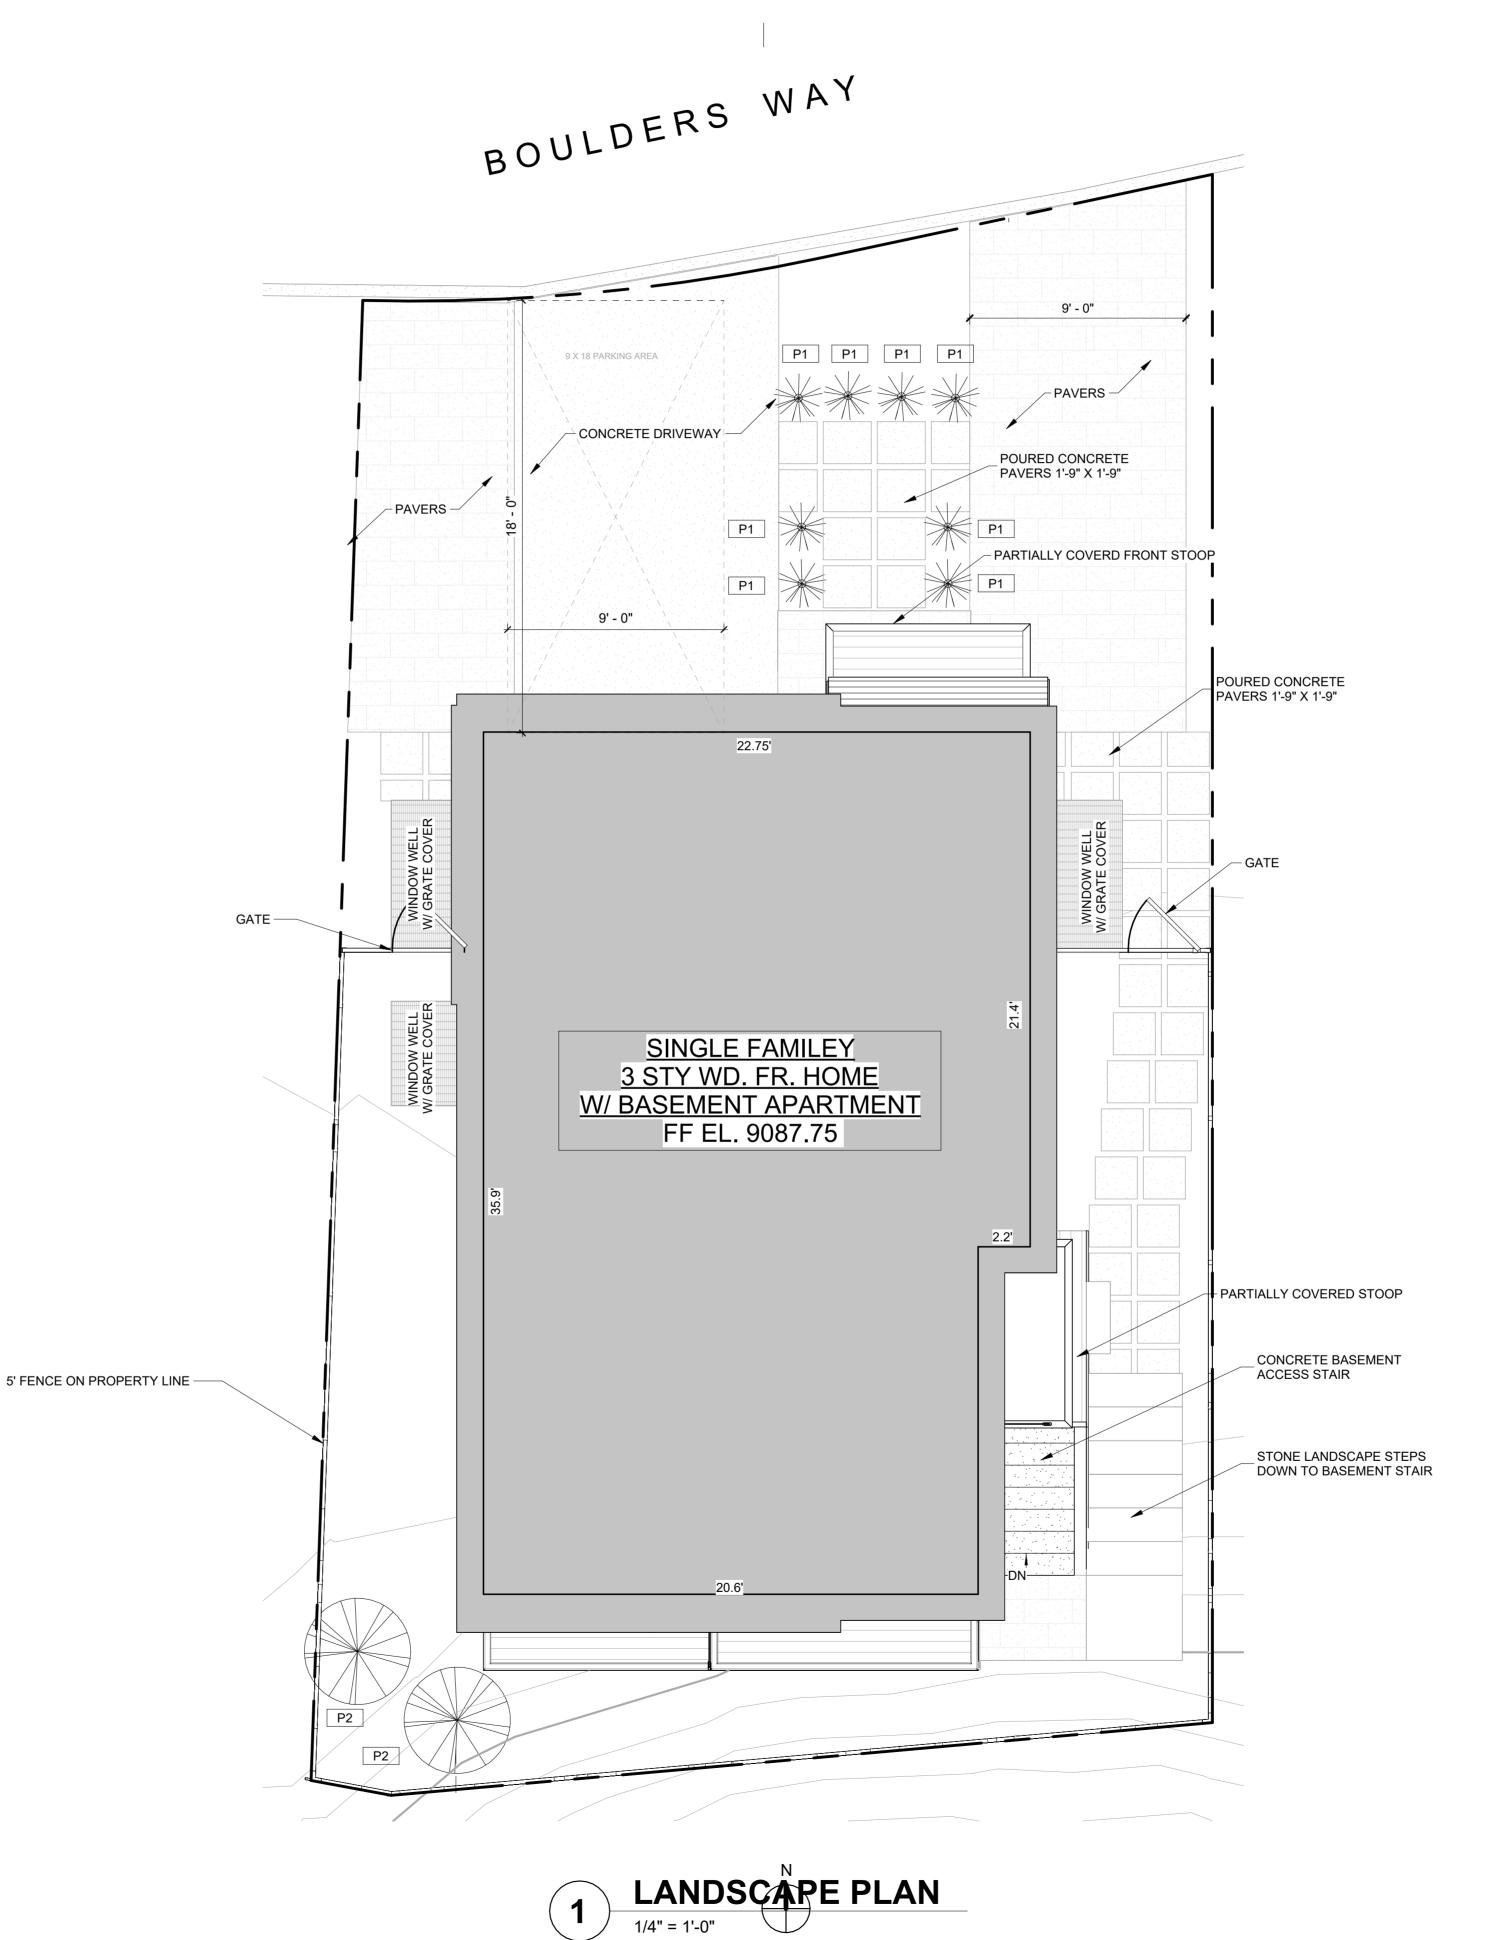

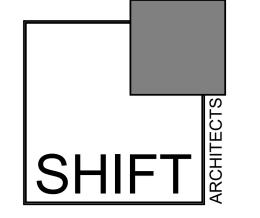

P.O. Box 3206 100 W. Colorado Suite 211 Telluride, Colorado 81435 p 970-728-8145 kristine@shift-architects.com www.shift-architects.com


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REVISION

NO. DATE DESC.

SERENITY MV

LANDSCAPE PLAN

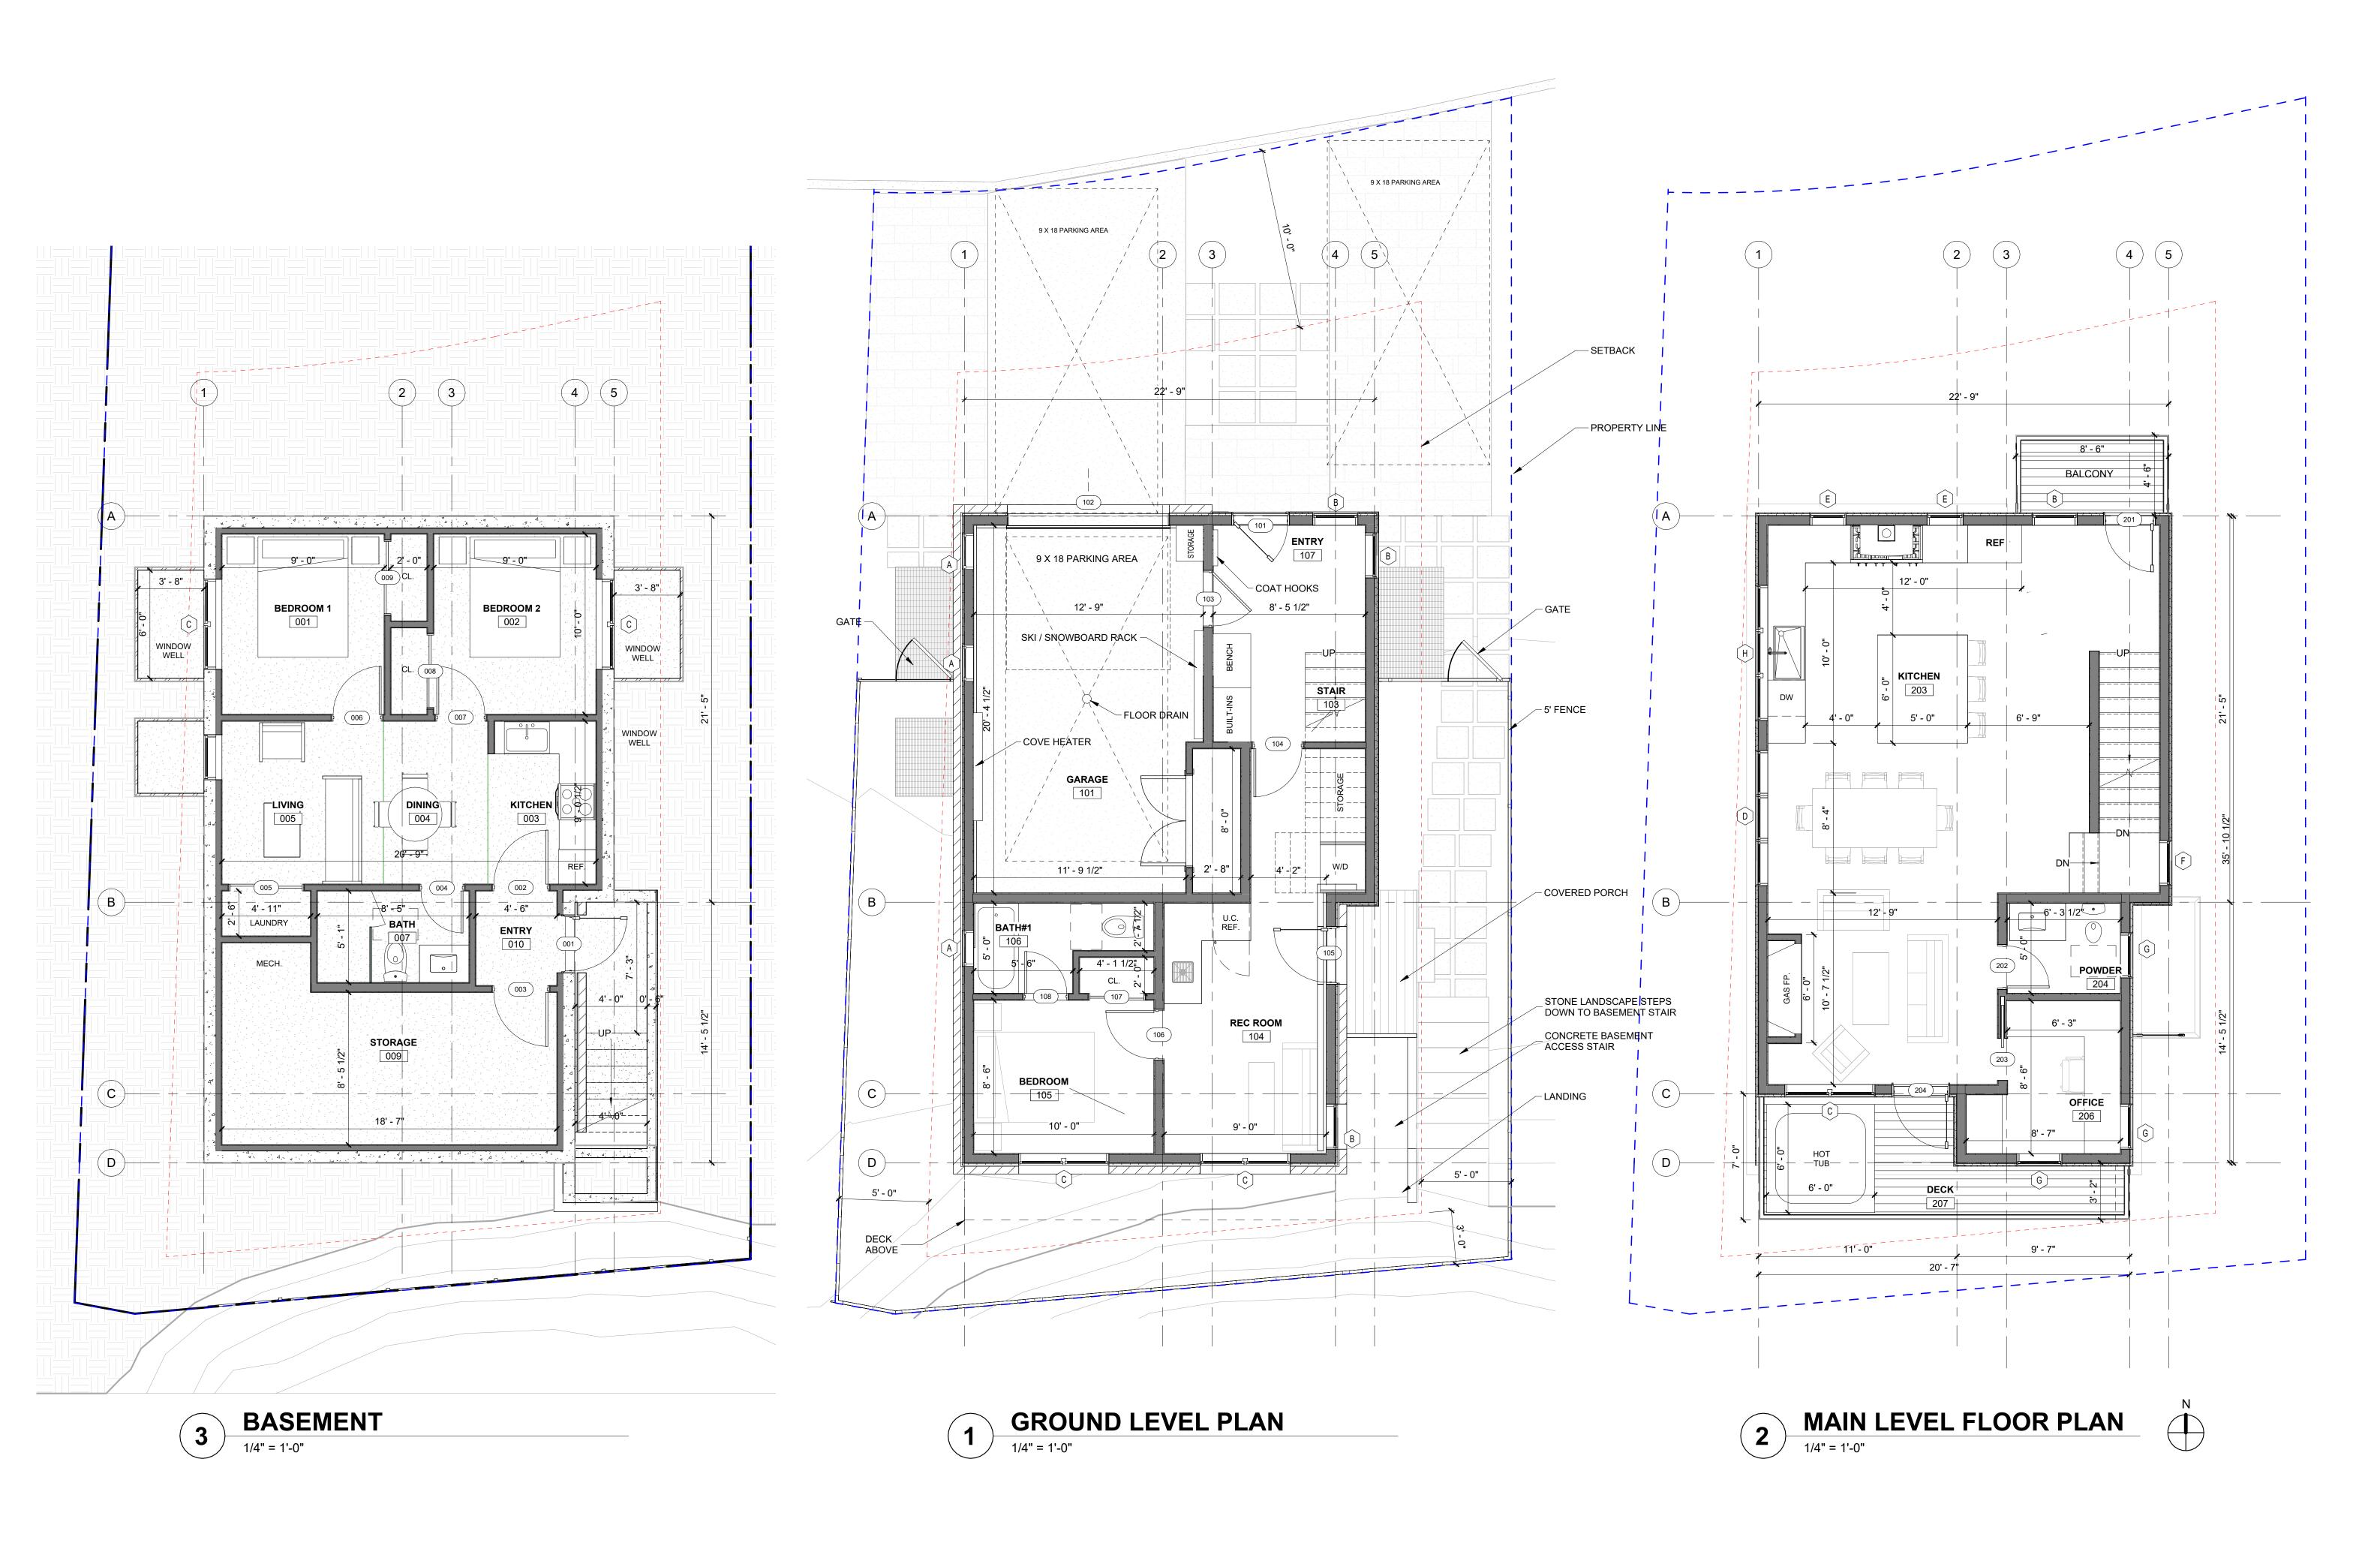

SHIFT

P.O. Box 3206 100 W. Colorado Suite 211 Telluride, Colorado 81435 p 970-728-8145 kristine@shift-architects.com www.shift-architects.com

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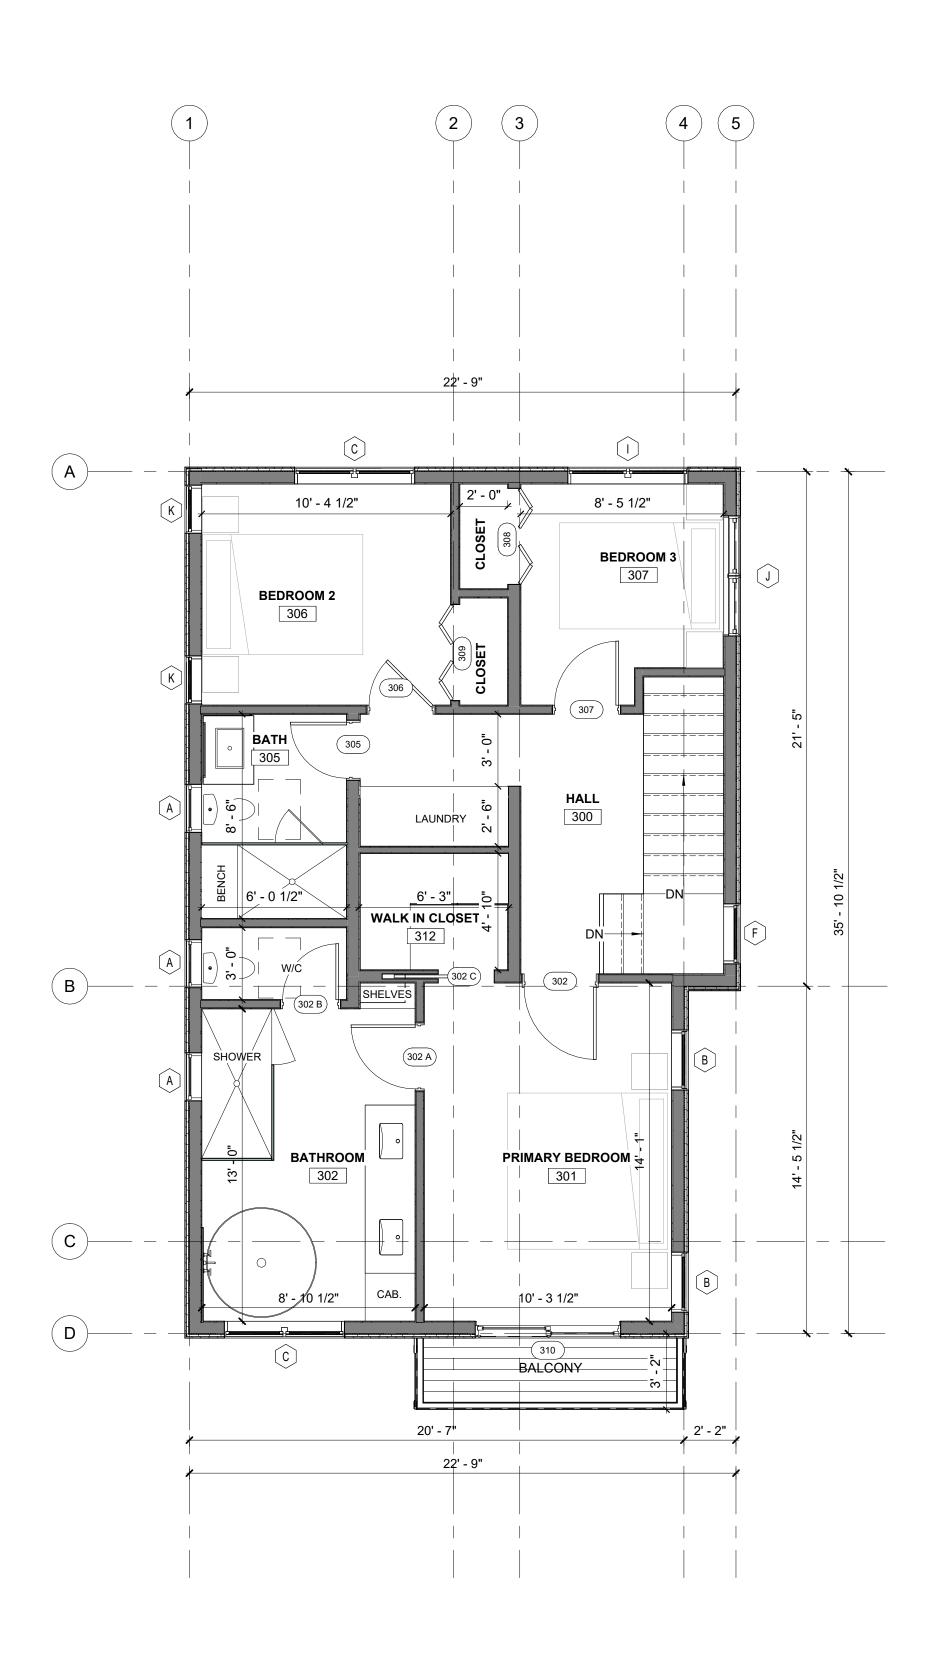
REVISION


NO. DATE DESC.

SERENITY MV

FLOOR PLANS


SHEET NII IMBED




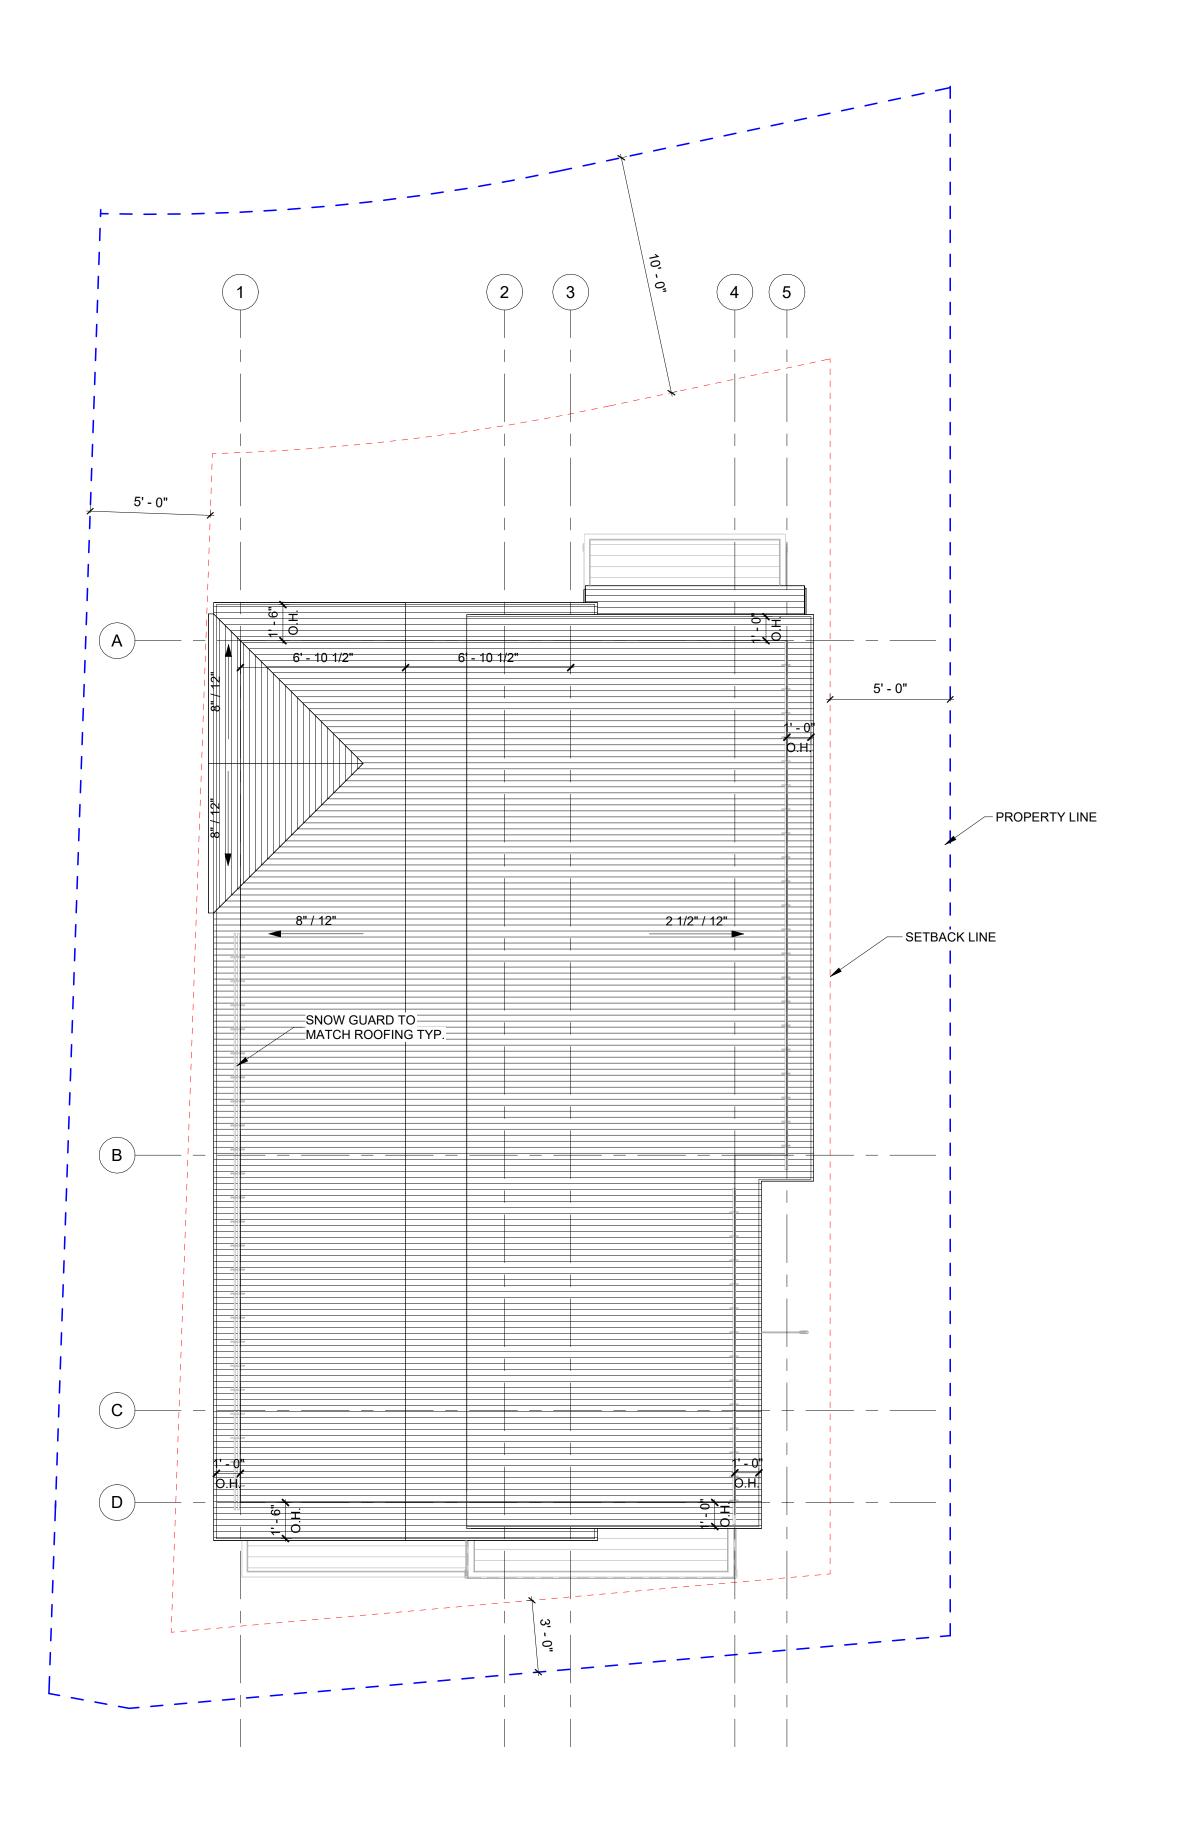

UPPER LEVEL FLOOR PLAN



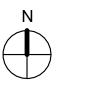

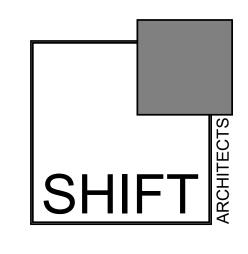


P.O. Box 3206 100 W. Colorado Suite 211 Telluride, Colorado 81435 p 970-728-8145 kristine@shift-architects.com www.shift-architects.com


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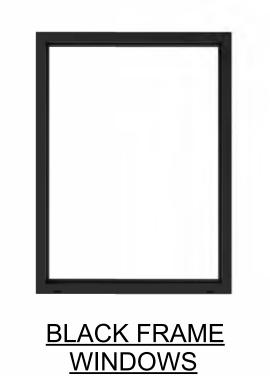
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FLOOR & ROOF PLAN







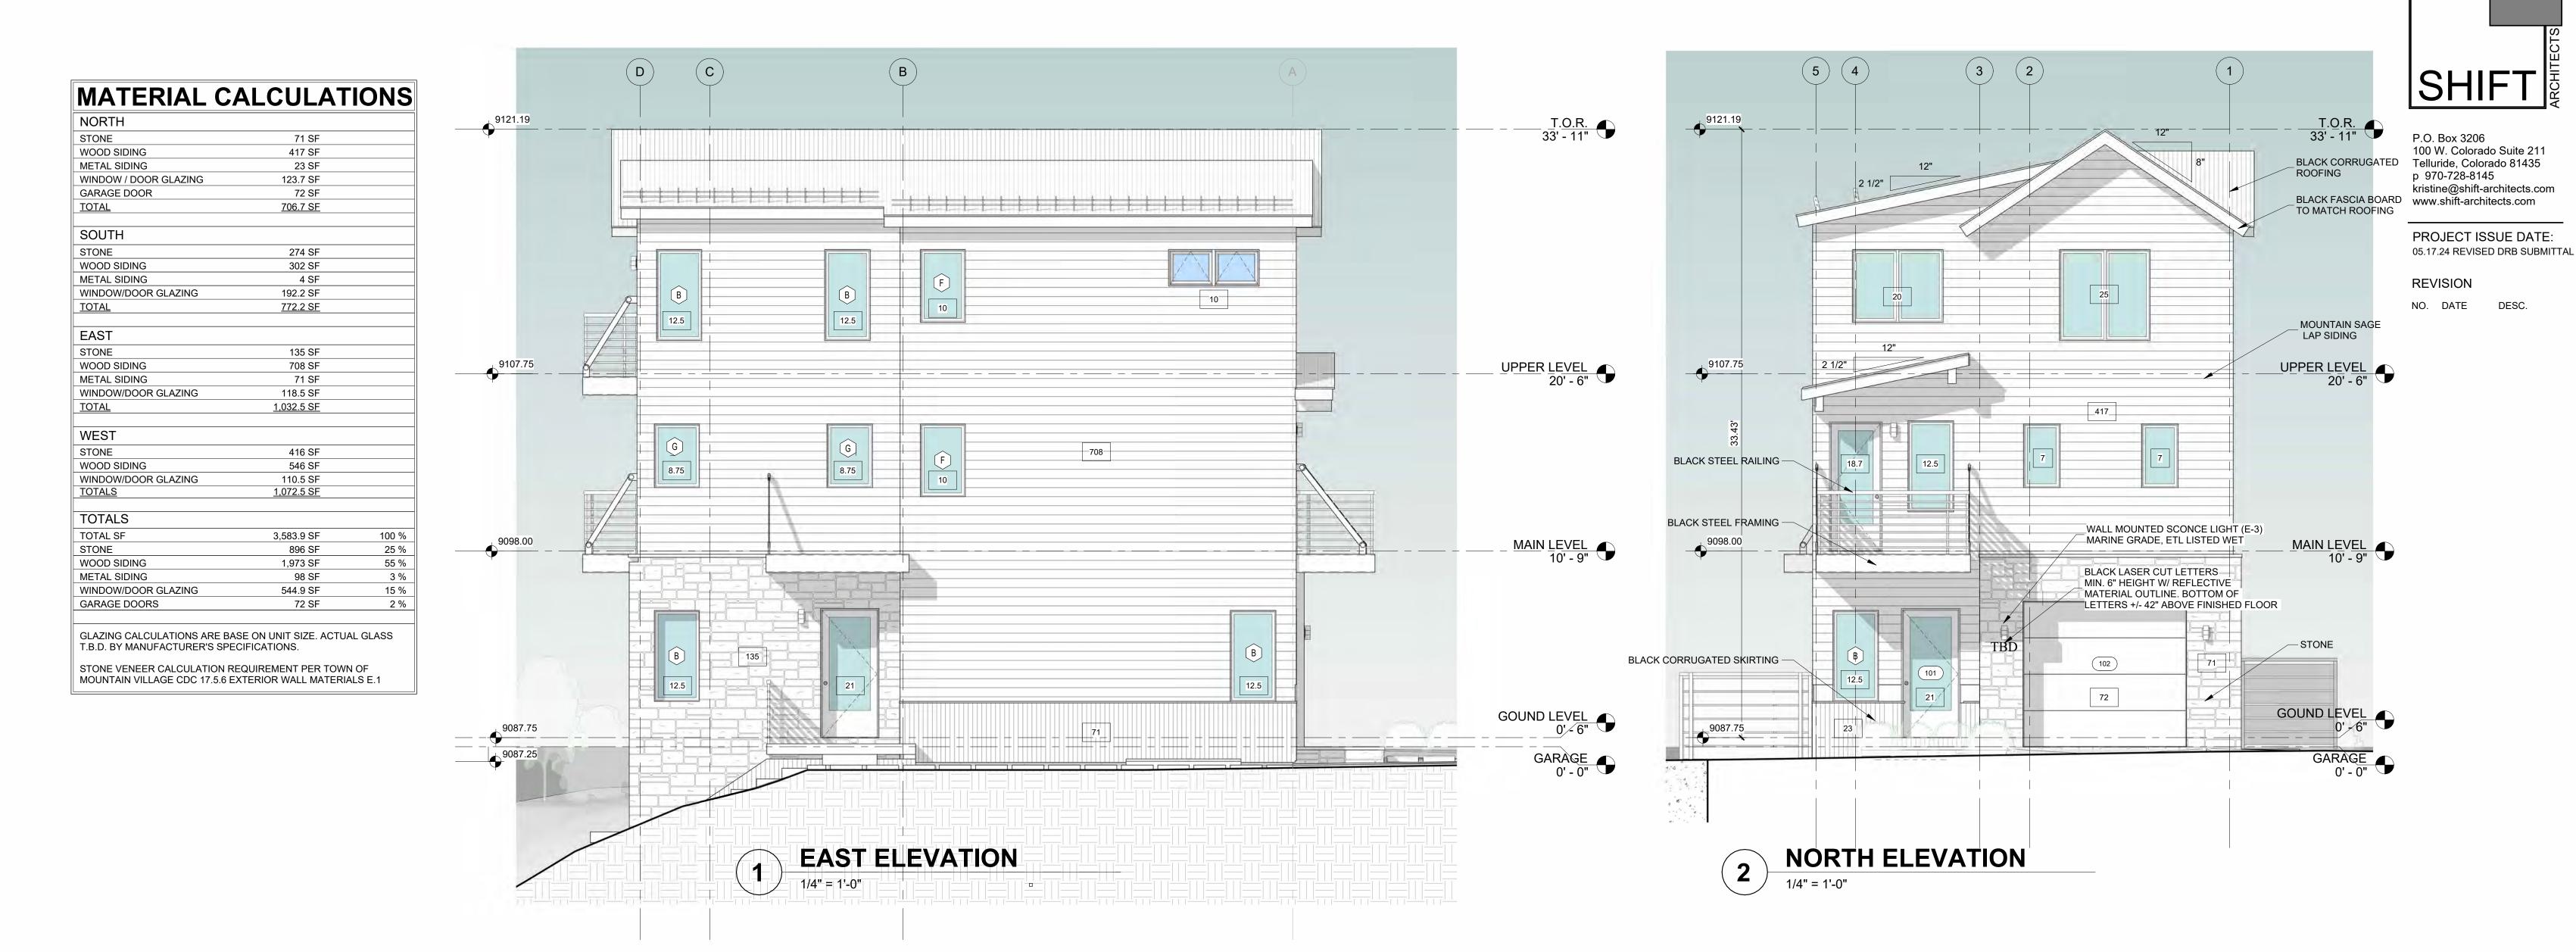
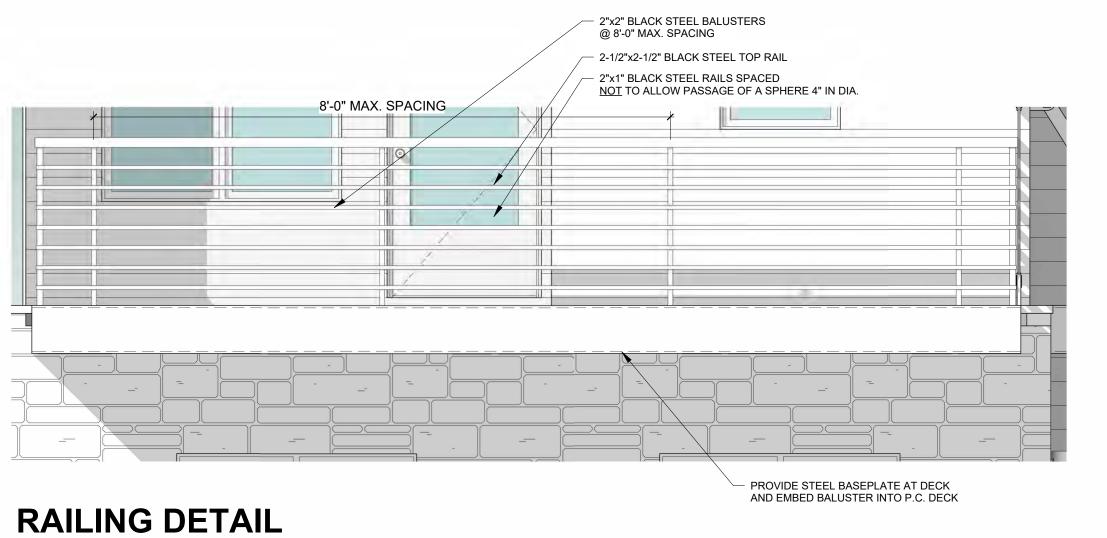
<u>& ROOFING</u>



FLINT SAWN STONE





MOUNTAIN SAGE LAP SIDING

1/2" = 1'-0"



2X6 CEDAR DECKING



12X24 LIME BLACK PAVERS

SERENII

PROPOSED **ELEVATIONS**

SHEET NUMBER


A4.1




UTTTION Boulders Way, Mountain Villa

PROPOSED ELEVATIONS

SHEET NUMBER

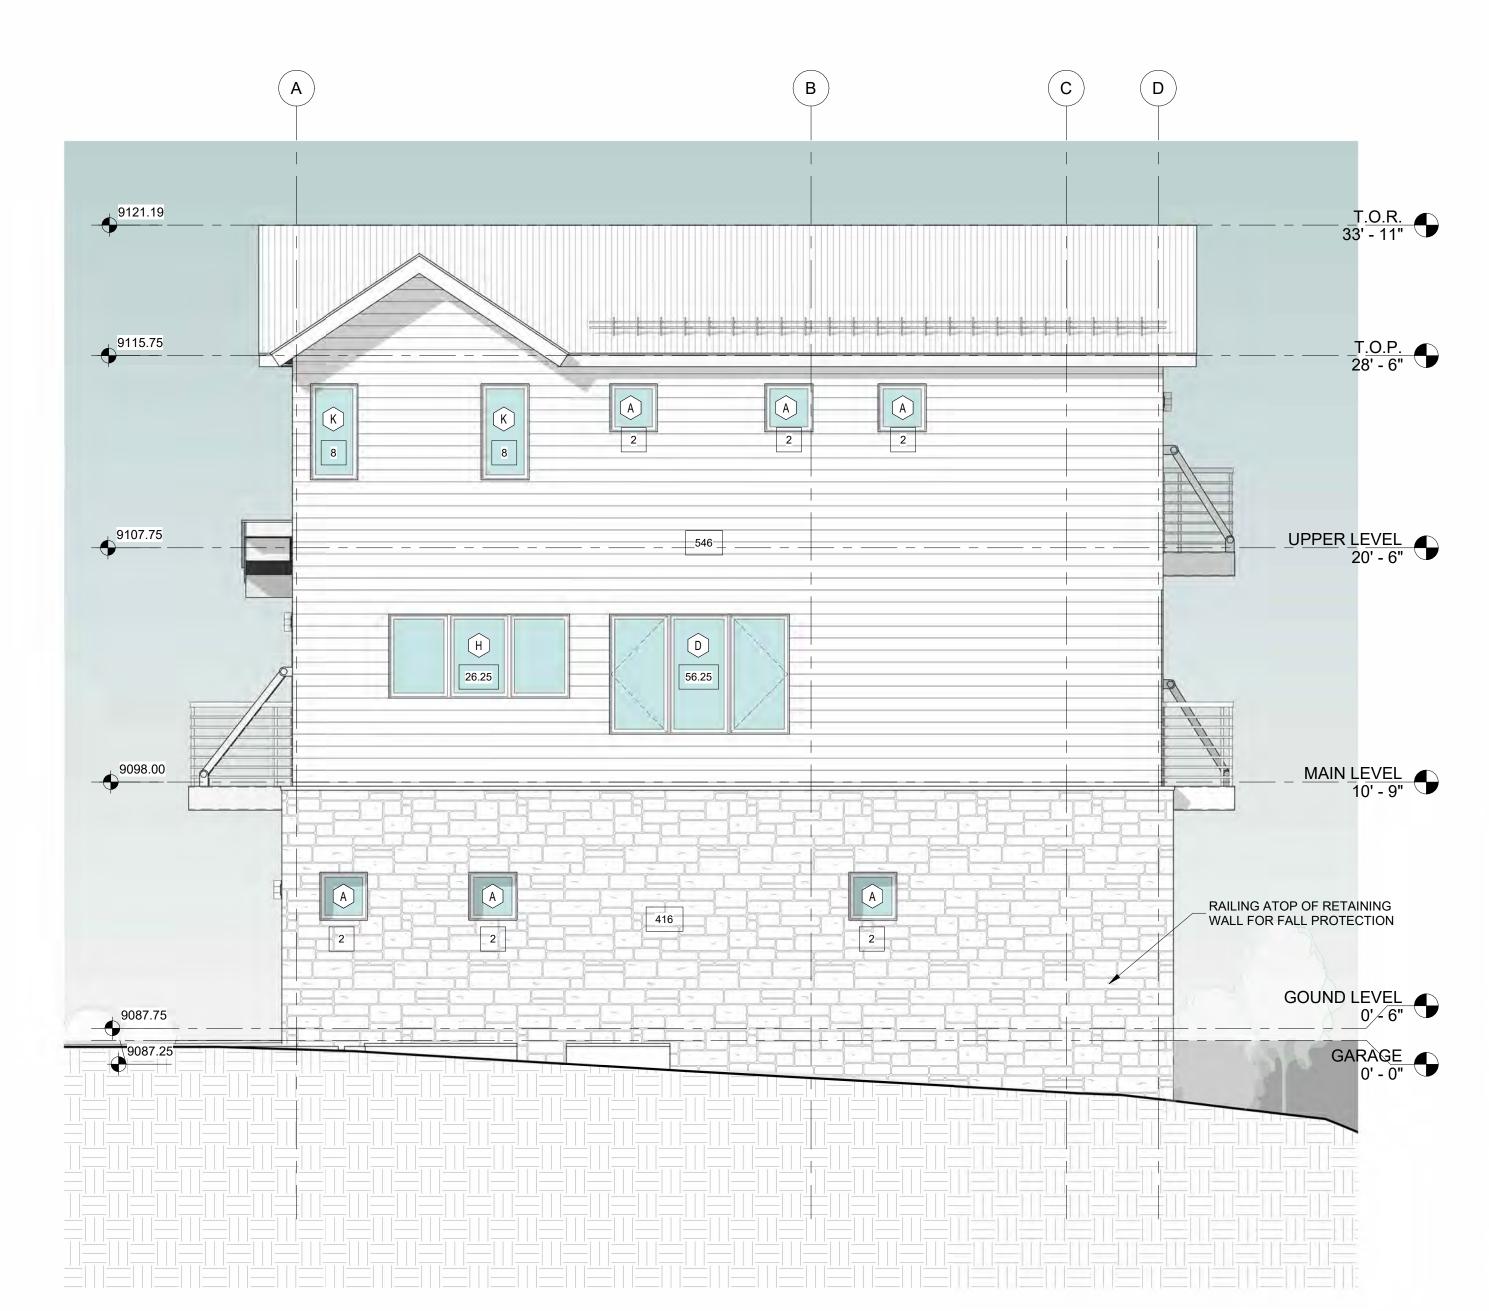

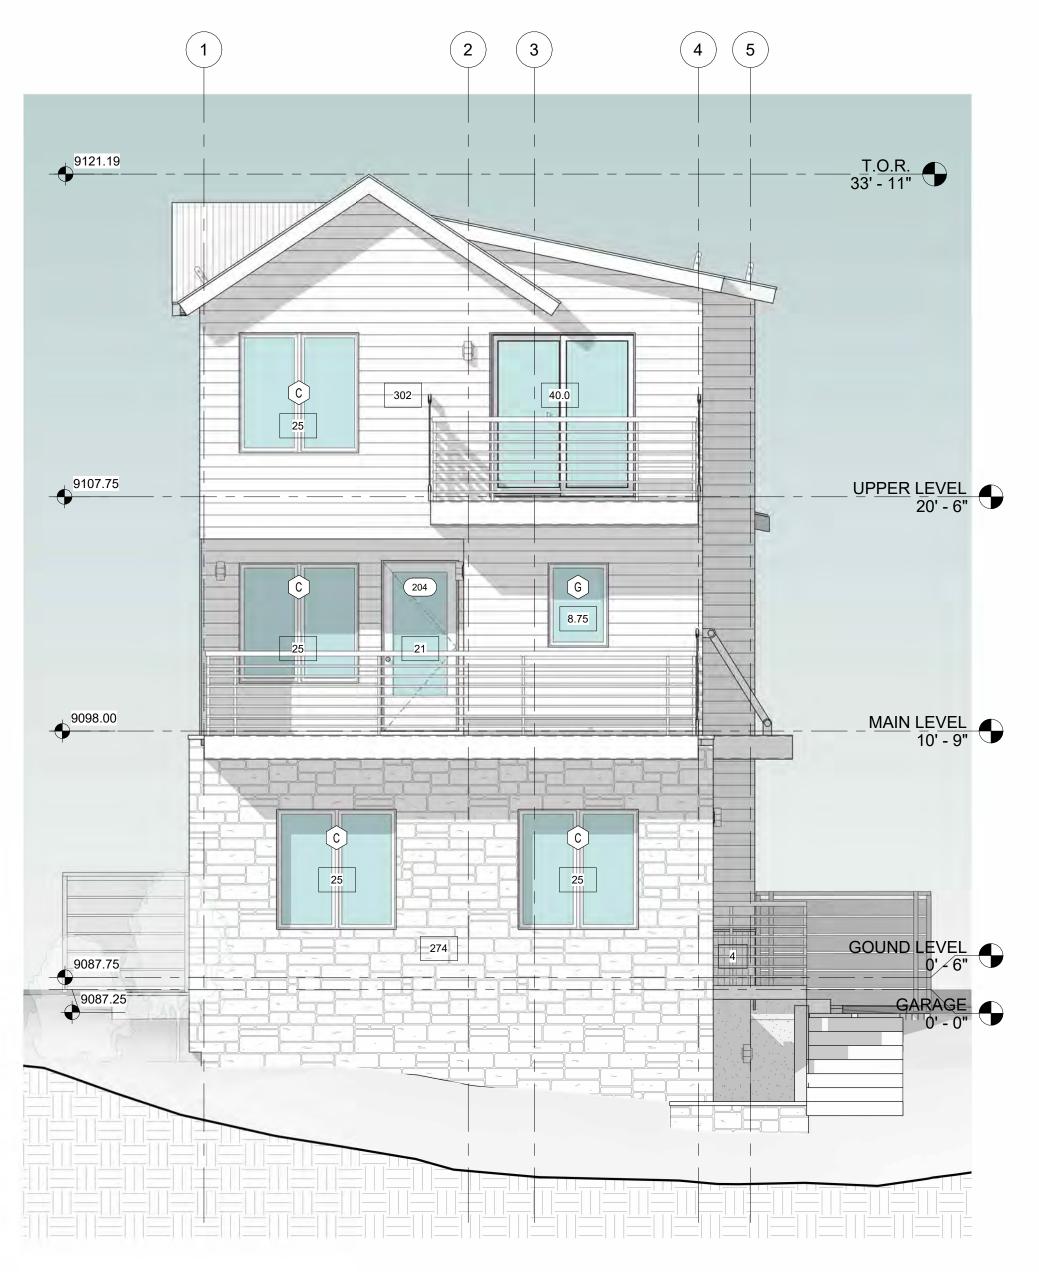

1 WEST ELEVATION


1/4" = 1'-0"

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40' OFFSET FROM
MOST RESTRICTIVE GRADE

EAST ELEVATION

POST CONSTRUCTION GRADE LINE

PRE CONSTRUCTION GRADE LINE

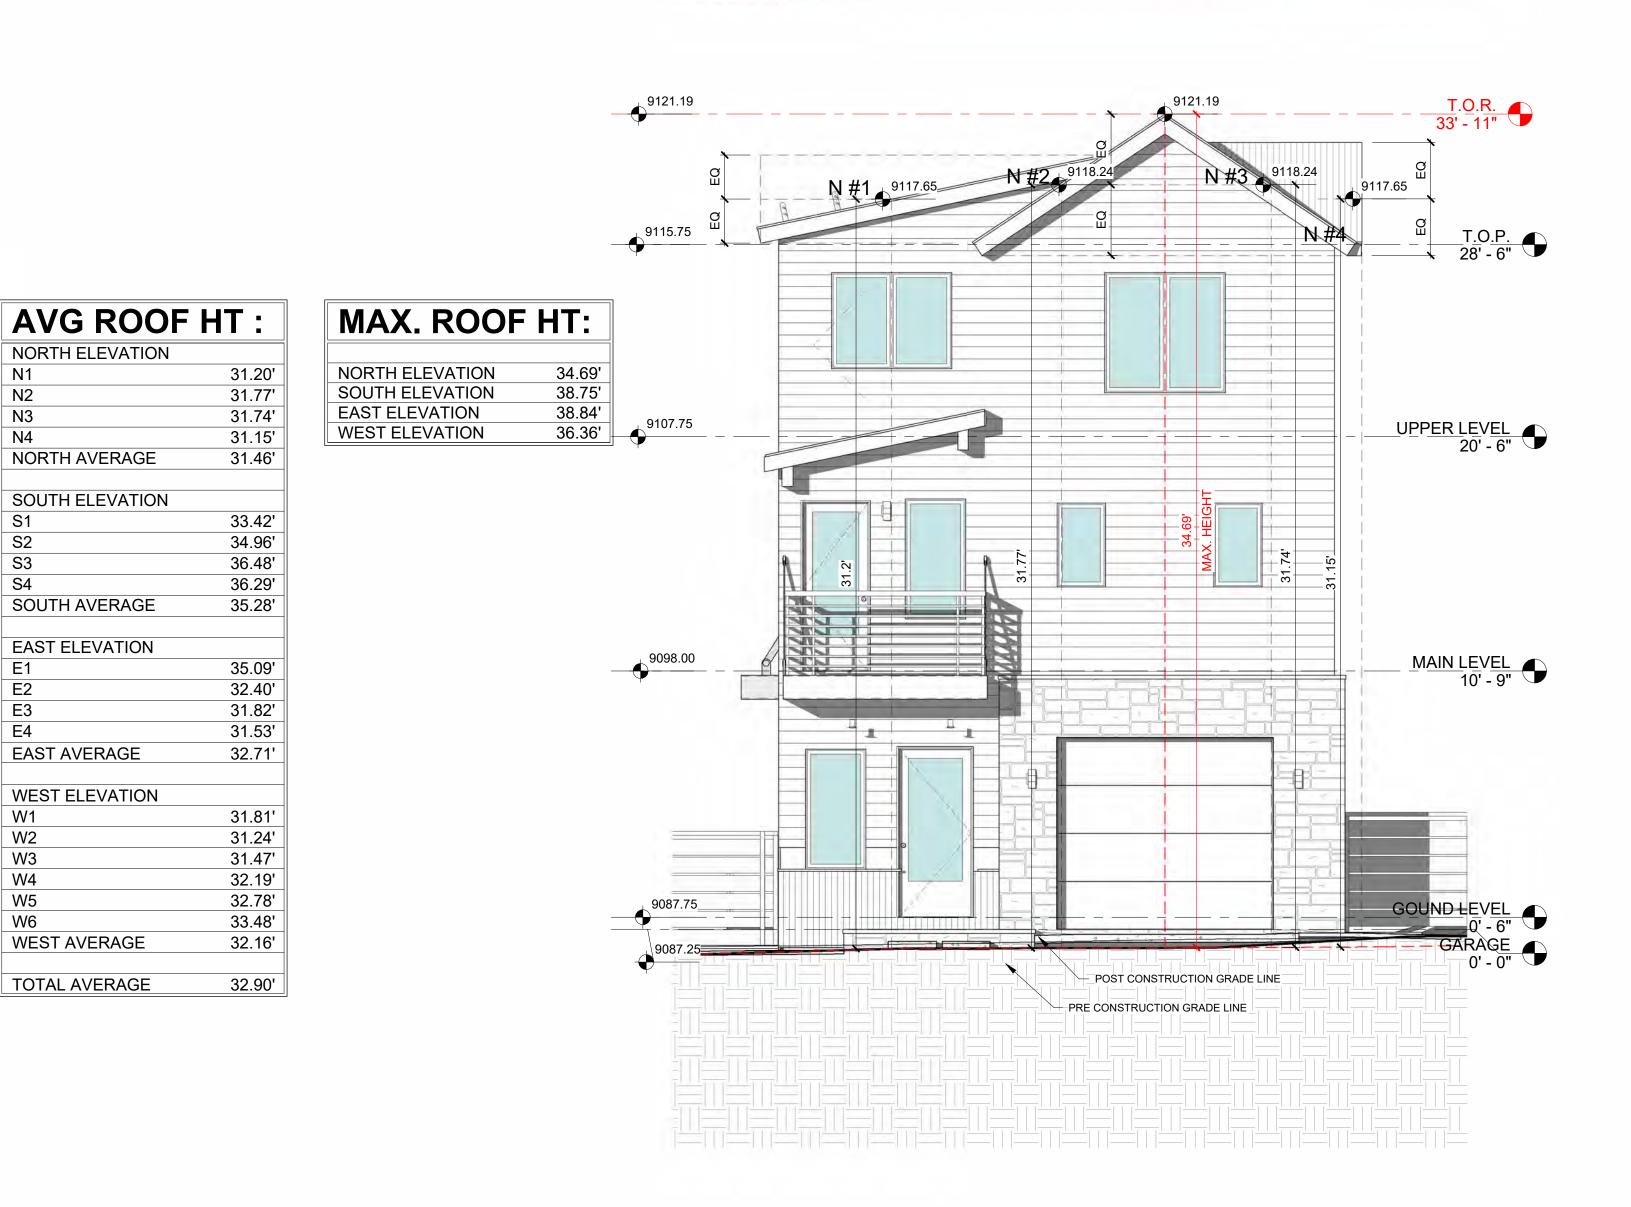40' OFFSET FROM MOST RESTRICTIVE GRADE

25.36'

E #3 9117.65

E #1 9117.65

T.O.P. 28' - 6"

<u>UPPER LEVEL</u> 20' - 6"

MAIN LEVEL 10' - 9"

GOUND LEVEL 0' - 6"

9121.19

9107.75

9098.00

9087.75

NORTH ELEVATION

NORTH AVERAGE

SOUTH ELEVATION

SOUTH AVERAGE

EAST ELEVATION

EAST AVERAGE

WEST ELEVATION


WEST AVERAGE

TOTAL AVERAGE

NORTH ELEVATION

ELEVATION HEIGHT CALCS


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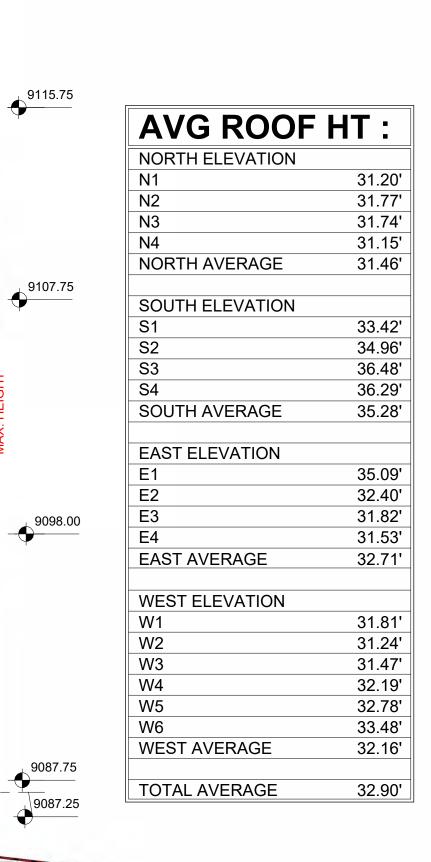

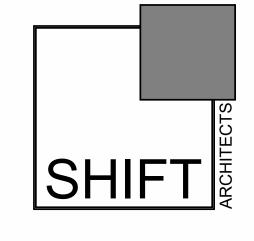
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NORTH ELEVATION SOUTH ELEVATION

EAST ELEVATION

WEST ELEVATION

9121.19

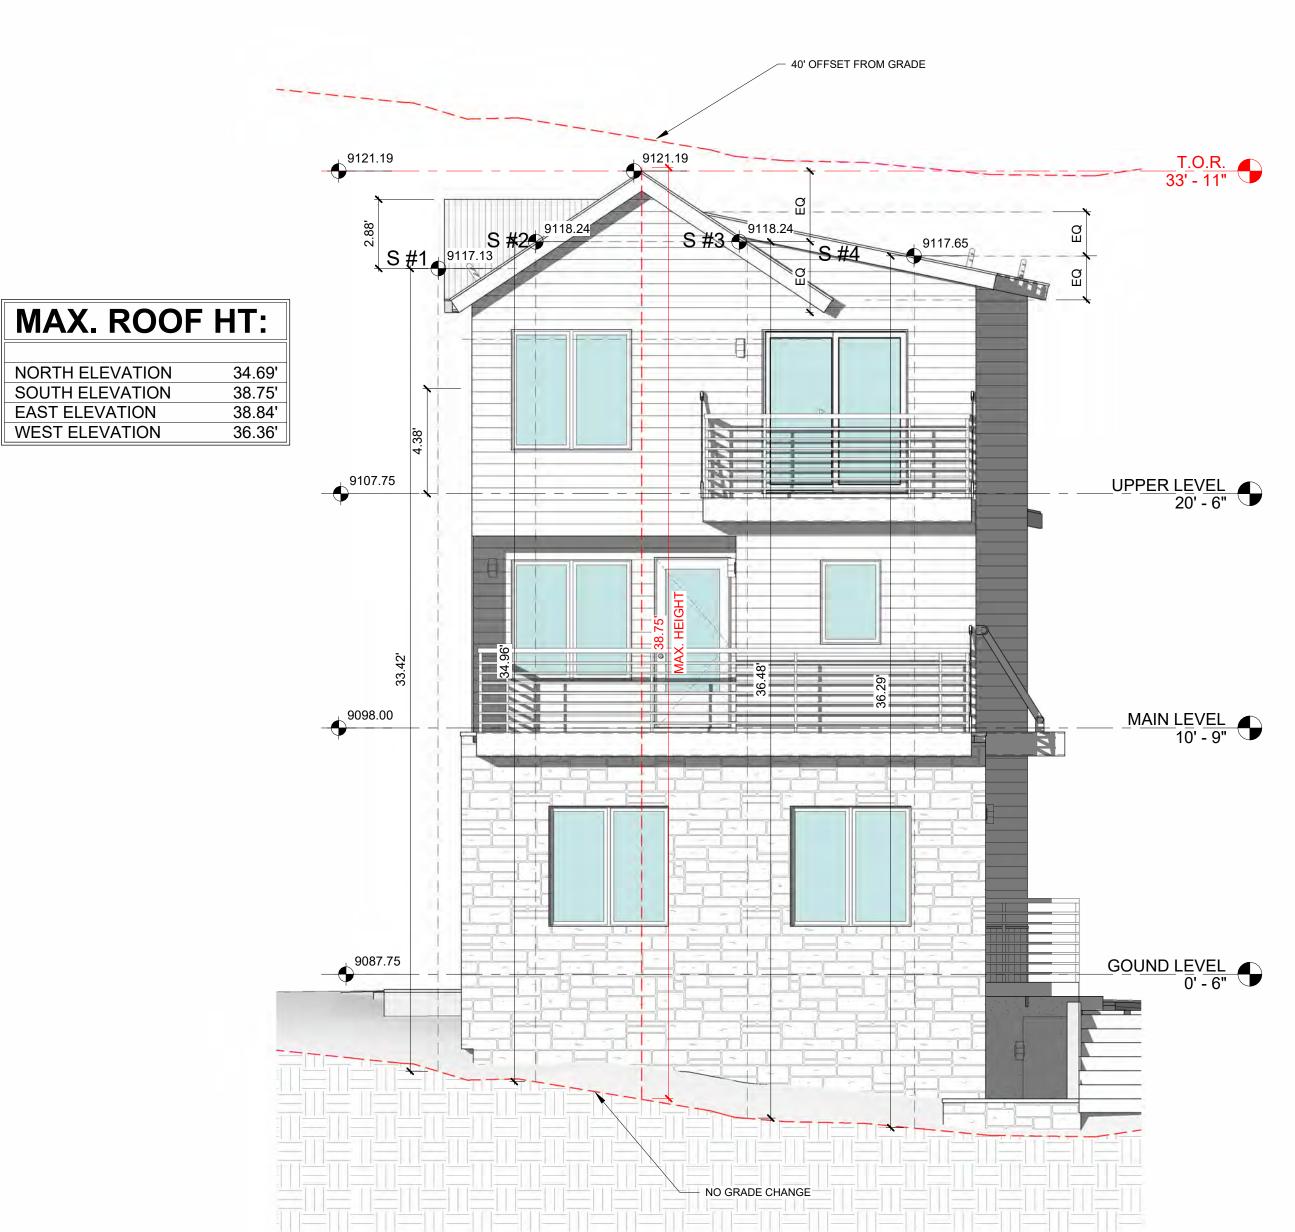W #6 9118.24

SOUTH ELEVATION

1/4" = 1'-0"

WEST ELEVATION

POST CONSTRUCTION GRADE LINE

PRE CONSTRUCTION GRADE LINE

T.O.P. 28' - 6"

UPPER LEVEL 20' - 6"

MAIN LEVEL 10' - 9"

GOUND LEVEL

0' - 6"

GARAGE

0' - 0"

- 40' OFFSET FROM MOST RESTRICTIVE GRADE

ELEVATION HEIGHT CALCS


SERENIT



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REVISION

NO. DATE DESC.

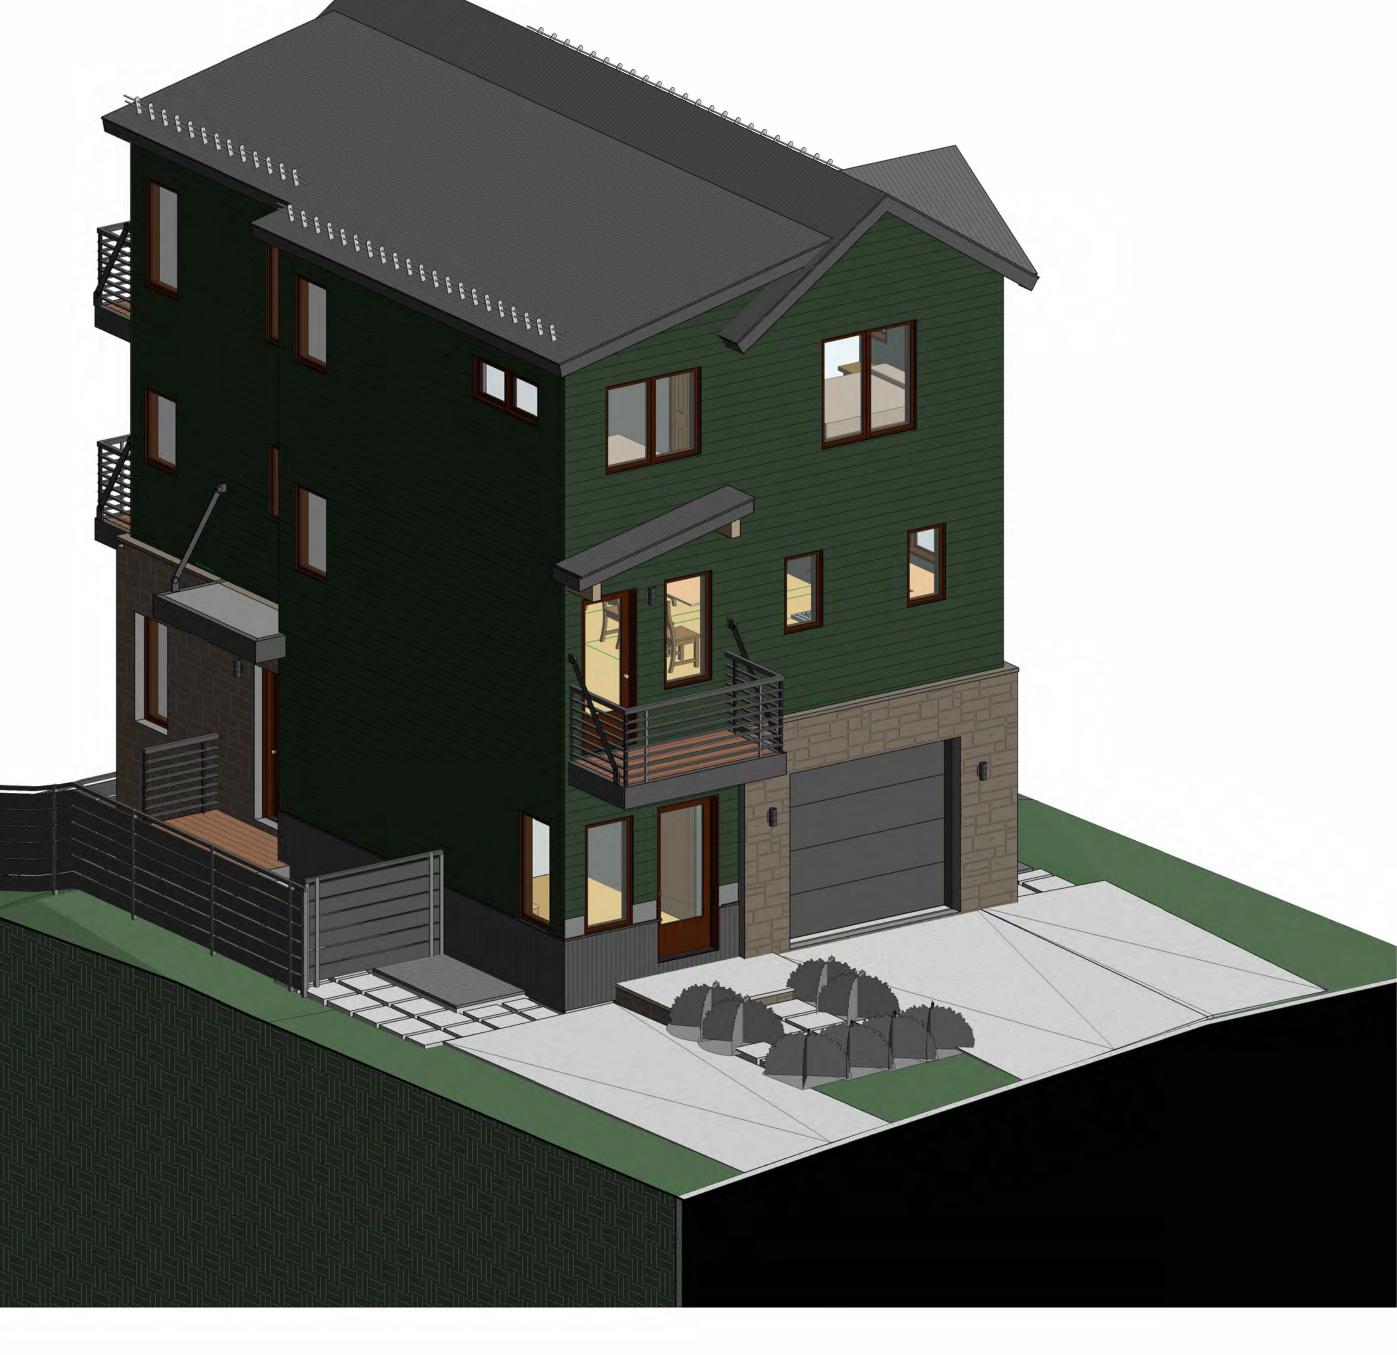


NW PERSPECTIVE

NE PERSPECTIVE

COLORIZED PERSPECTIVE

SHEET NUMBER

A4.5

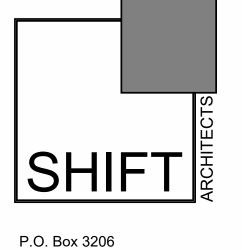


PROJECT ISSUE DATE: 05.17.24 REVISED DRB SUBMITTAL

REVISION

NO. DATE DESC.




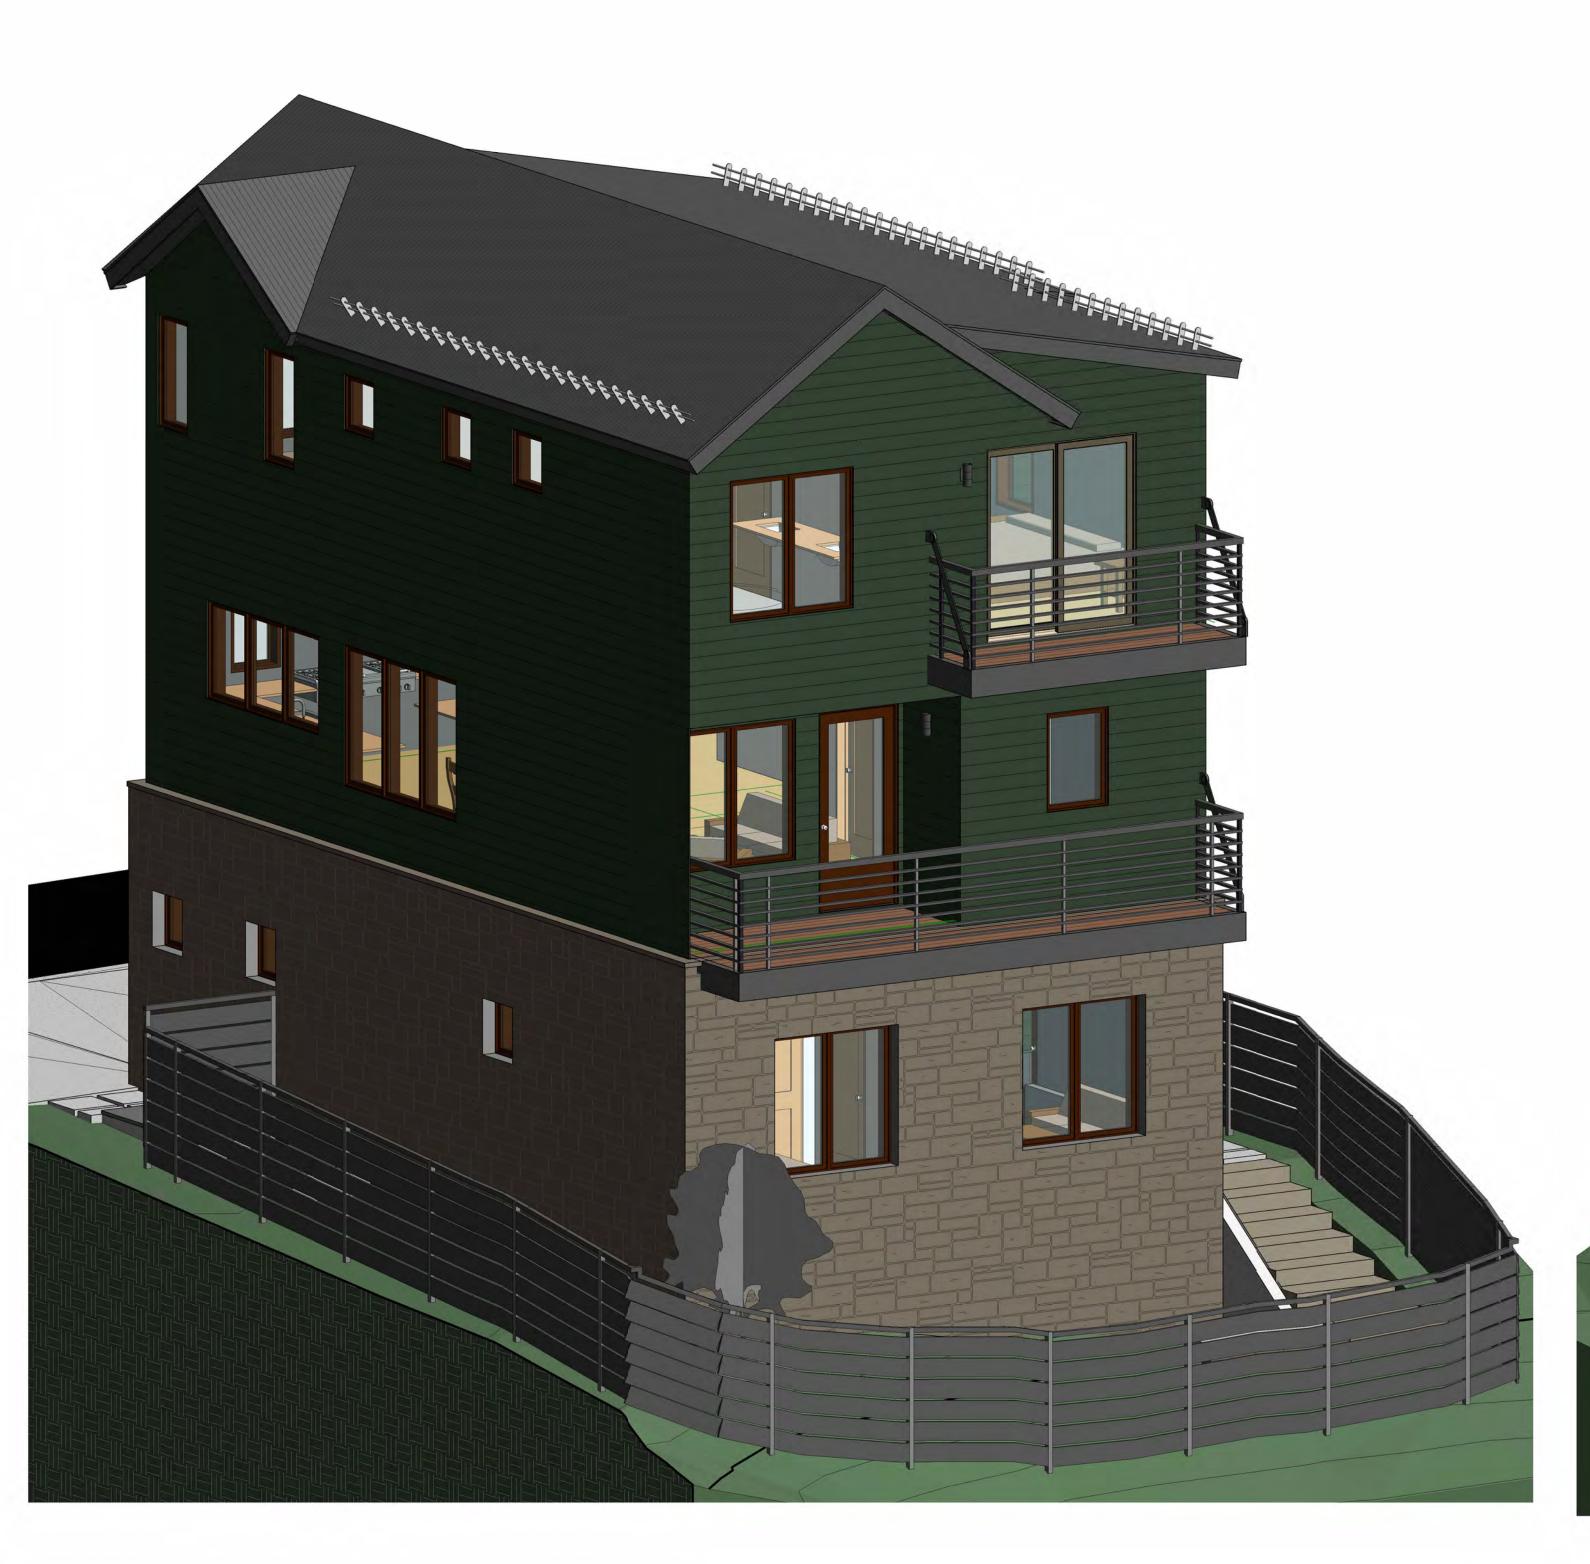


SW PERSPECTIVE


SE PERSPECTIVE

COLORIZED PERSPECTIVE

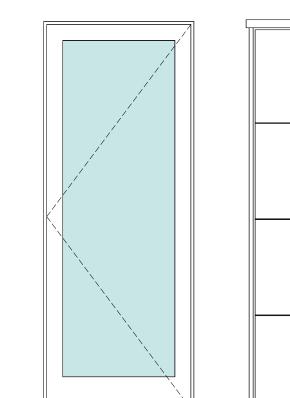


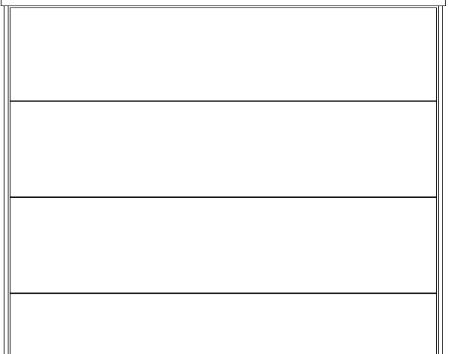

TYPE B

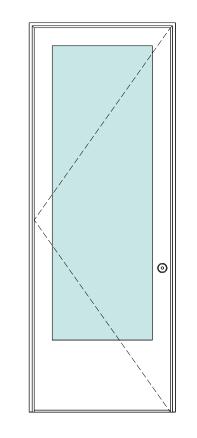

TYPE C

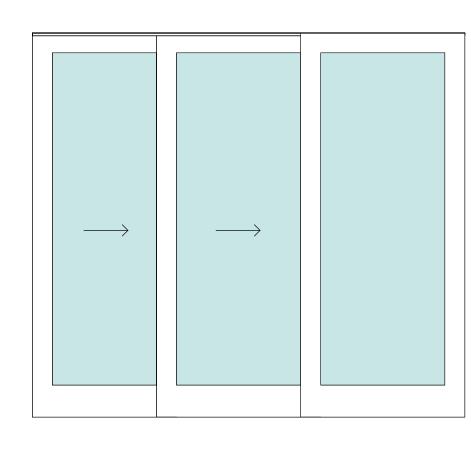

TYPE D

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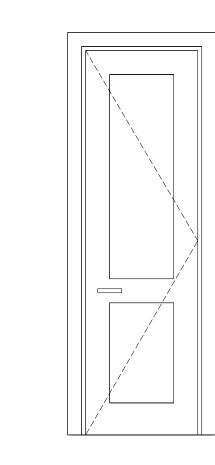
PROJECT ISSUE DATE: 05.17.24 REVISED DRB SUBMITTAL

REVISION


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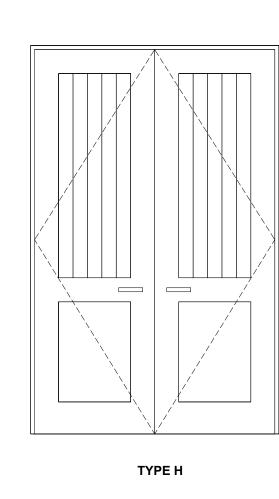
EXTERIOR DOOR TYPES


TYPE A



TYPE F



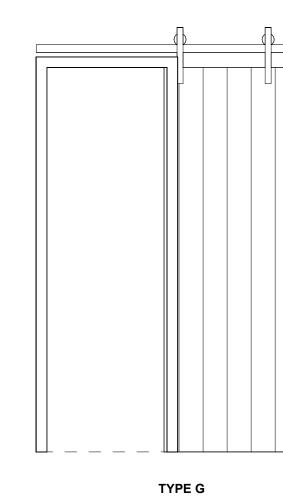

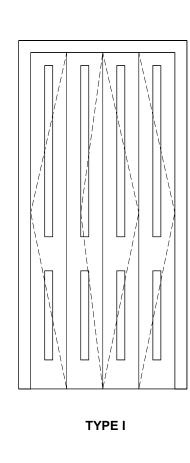

INTERIOR DOOR TYPES 1/2" = 1'-0"

TYPE E

WINDOW DETAIL W/ STONE VENEER 1 1/2" = 1'-0"

- CONT INSULATION BOARD

FULL STONE VENEER


- ALUMN CLAD WOOD

STONE VENEER RECESS IN ACCORDANCE W/ CDC 17.5.6

BUILDING DESIGN A.2

WINDOW _ STONE SILL

- DRAIN BOARD

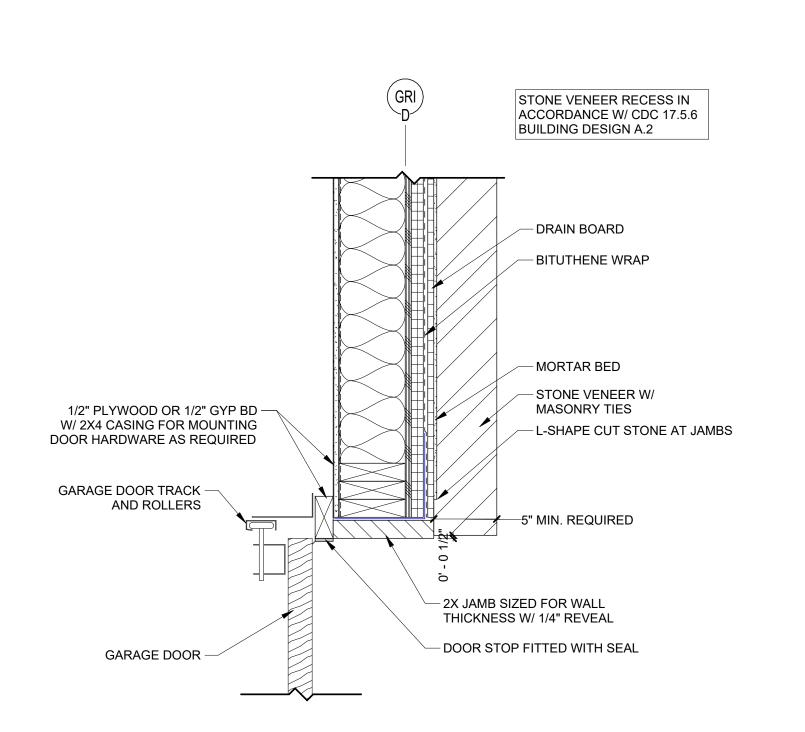



TYPE J

DOOR SCHEDULE

001

104

105

107

204

307

309

310

302 A

DOOR TYPE

EXTERIOR SINGLE GLASS PANEL

INTERIOR SINGLE SWING

INTERIOR SINGLE SWING

INTERIOR SINGLE SWING

INTERIOR DOUBLE SLIDING

INTERIOR SINGLE SWING

INTERIOR SINGLE SWING

INTERIOR DOUBLE SLIDING

INTERIOR DOUBLE SLIDING

EXTERIOR SINGLE GLASS PANEL

OVERHEAD GARAGE DOOR

INTERIOR SINGLE SWING INTERIOR SINGLE PANEL

EXTERIOR SINGLE GLASS PANEL

INTERIOR SINGLE SWING INTERIOR DOUBLE SLIDING

INTERIOR SINGLE SWING

INTERIOR DOUBLE SWING EXTERIOR SINGLE GLASS PANEL

INTERIOR SINGLE SWING INTERIOR SINGLE POCKET

EXTERIOR SINGLE GLASS PANEL

INTERIOR SINGLE SWING

INTERIOR SINGLE SWING

INTERIOR SINGLE SWING INTERIOR SINGLE POCKET

INTERIOR SINGLE SWING

INTERIOR SINGLE SWING

INTERIOR SINGLE SWING

INTERIOR BIFOLDING

INTERIOR BIFOLDING

EXTERIOR SLIDING GLASS

MARK T WIDTH HARDWARE Description

7' - 0" | 3' - 0" 7' - 0" | 3' - 0"

7' - 0" | 3' - 0"

7' - 0" | 2' - 4"

7' - 0" | 4' - 0"

7' - 0" | 2' - 8"

7' - 0" | 2' - 8"

7' - 0" | 4' - 0"

7' - 0" | 4' - 0"

7' - 0" | 3' - 0"

8' - 0" | 9' - 0" 7' - 0" | 3' - 0"

7' - 0" | 2' - 8"

7' - 0" | 3' - 0"

7' - 0" | 2' - 8"

7' - 0" | 3' - 0"

7' - 0" | 2' - 4"

7' - 0" | 2' - 6"

7' - 0" | 2' - 8" 7' - 0" | 2' - 4"

7' - 0" | 2' - 4"

7' - 0" | 3' - 0"

7' - 0" | 3' - 0"

7' - 0" | 2' - 8"

7' - 0" | 2' - 4"

7' - 0" | 2' - 4" 7' - 0" | 2' - 4"

7' - 0" | 2' - 8"


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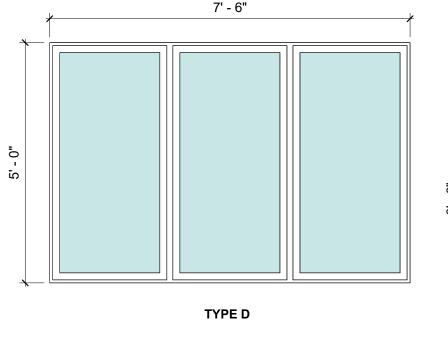
7' - 0" | 4' - 0"


7' - 0" | 4' - 0"

6' - 10" 6' - 0

1/2"



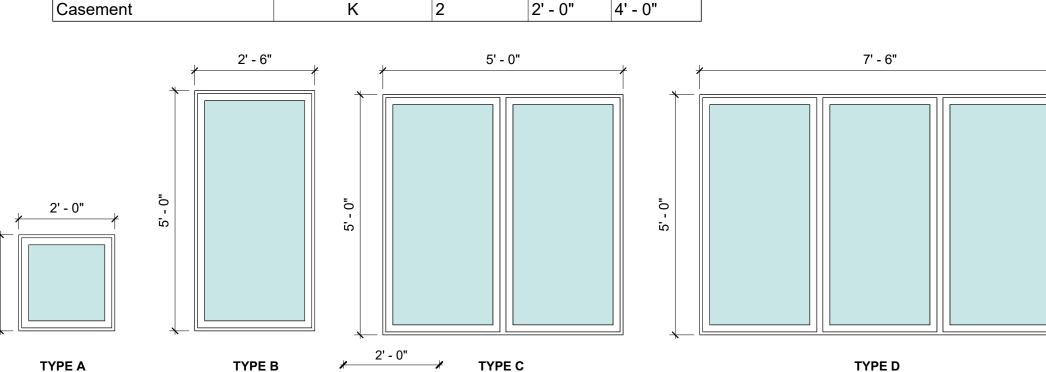

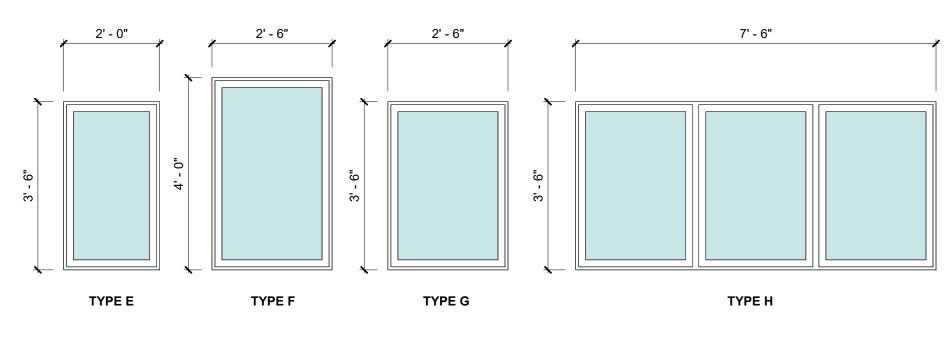


WINDOW NOTES

- 1. VERIFY ROUGH OPENINGS WITH MANUFACTURER PRIOR TO FRAMING.
- 2. WINDOW MANUFACTURER TO VERIFY WINDOW SWINGS.
- 3. WINDOW MANUFACTURER TO PROVIDE SHOP DRAWINGS. 4. PROVIDE SCREENS FOR ALL OPERABLE WINDOWS.

DOOR NOTES

- 1. NEW EXTERIOR DOORS TO BE 2/3 LITE PER GS#34.
- 2. DOOR HARDWARE TO BE BRUSHED NICKEL OR BRUSHED STEEL 3. DOOR & WINDOW MANUFACTURER: LOEWEN ALUMN CLAD WOOD OR SIMILAR.
- 4. VERIFY ROUGH OPENINGS WITH MANUFACTURER PRIOR TO FRAMING.

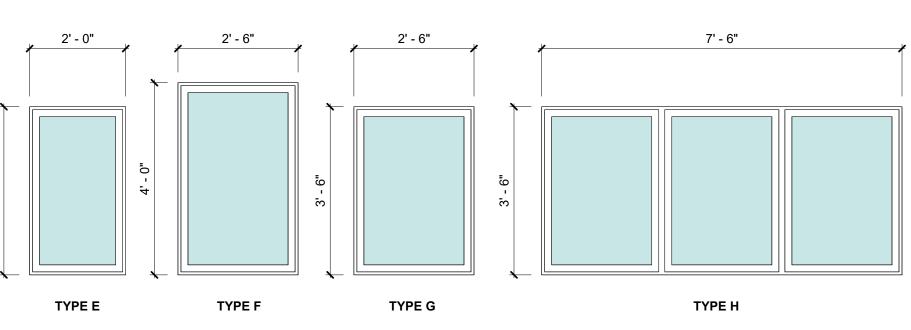

TYPE I

5' - 0"

WINDOW TYPES 1/2" = 1'-0"

SHEET NUMBER


DOOR & WINDOW


SCHEDULE

ERENI

LIGHTING NOTES:

- 1. FIELD VERIFY ALL LIGHTING LOCATIONS.
- 2. TYPICAL LIGHTING LOCATION AT STAIRS: (1 EA) PER LANDING (2 EA) PER RUN
- 3. CONTRACTOR SHALL TAKE CARE IN PLANNING ROUGH FRAMING LAYOUT AS IT RELATES TO THE NEED TO CENTER FIXTURES IN HALLWAYS, RECESSES AND OTHER AREAS WHERE RELATIONSHIPS DON'T OFFER ANY LATITUDE OR FIELD ADJUSTMENTS.
- 4. ALL RECESSED FIXTURES AT INSULATED CEILINGS TO BE IC RATED AND CERTIFIED AIR TIGHT CONSTRUCTION. ALL EXTERIOR FIXTURES, SHOWER FIXTURES AND FIXTURES OVER TUBS TO BE MARKED "SUITABLE FOR DAMP LOCATIONS".
- 5. LIGHTING SHALL BE IN ACCORDANCE WITH TOWN OF MOUNTAIN VILLAGE COMMUNITY DEVELOPMENT CODE 17.5.12 LIGHTING REGULATIONS
- 6. PROVIDE FULL CUT OFF FIXTURES WITH LED 10W 2500K-2700K BULBS PER CDC REQUIREMENTS.
- 7. MOUNT FIXTURES AT 7'-0" AFF MAX PER CDC REQUIREMENTS.
- 8. EXTERIOR LIGHTING ON SECOND AND UPPER FLOORS SHALL REQUIRE EITHER A TIMER OR SENSOR TO REDUCE USAGE AND ENERGY LOSS DURING TIMES OF INACTIVITY.

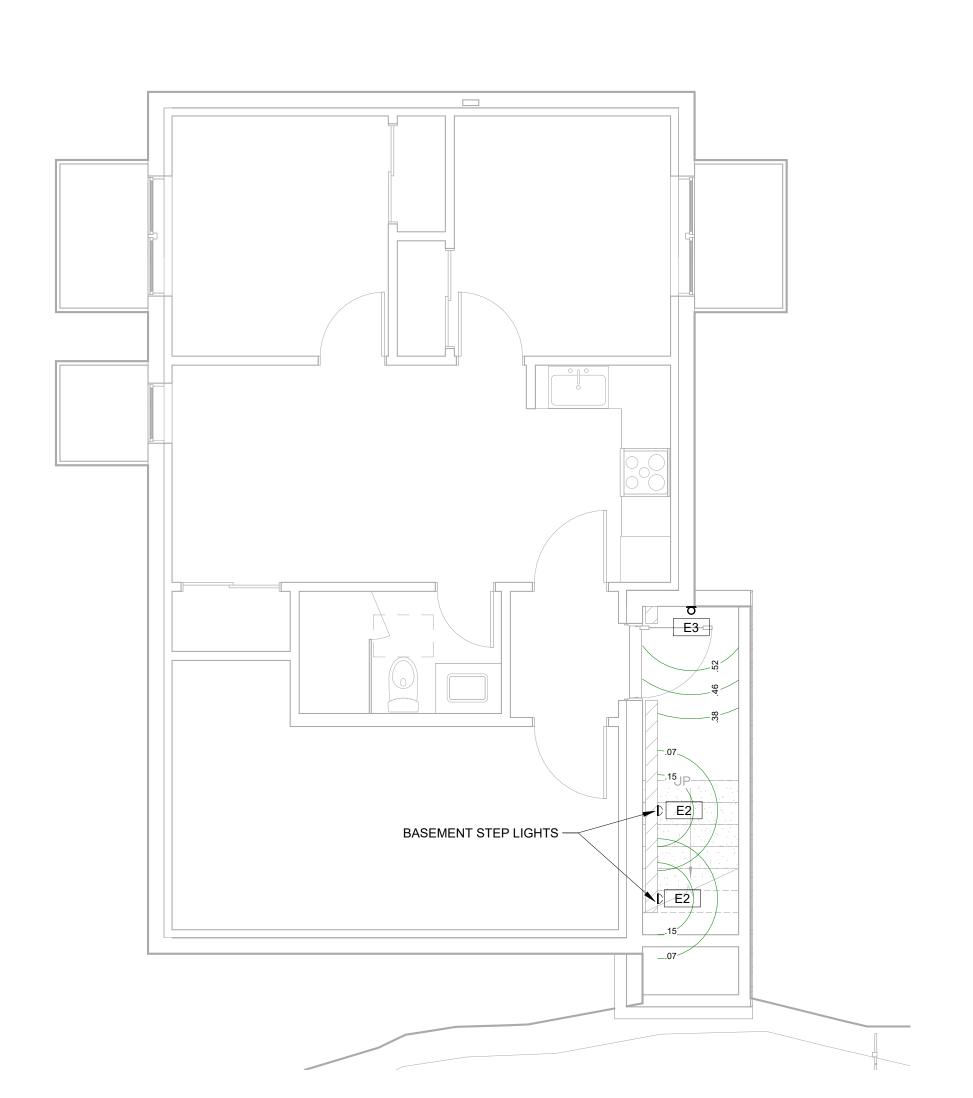

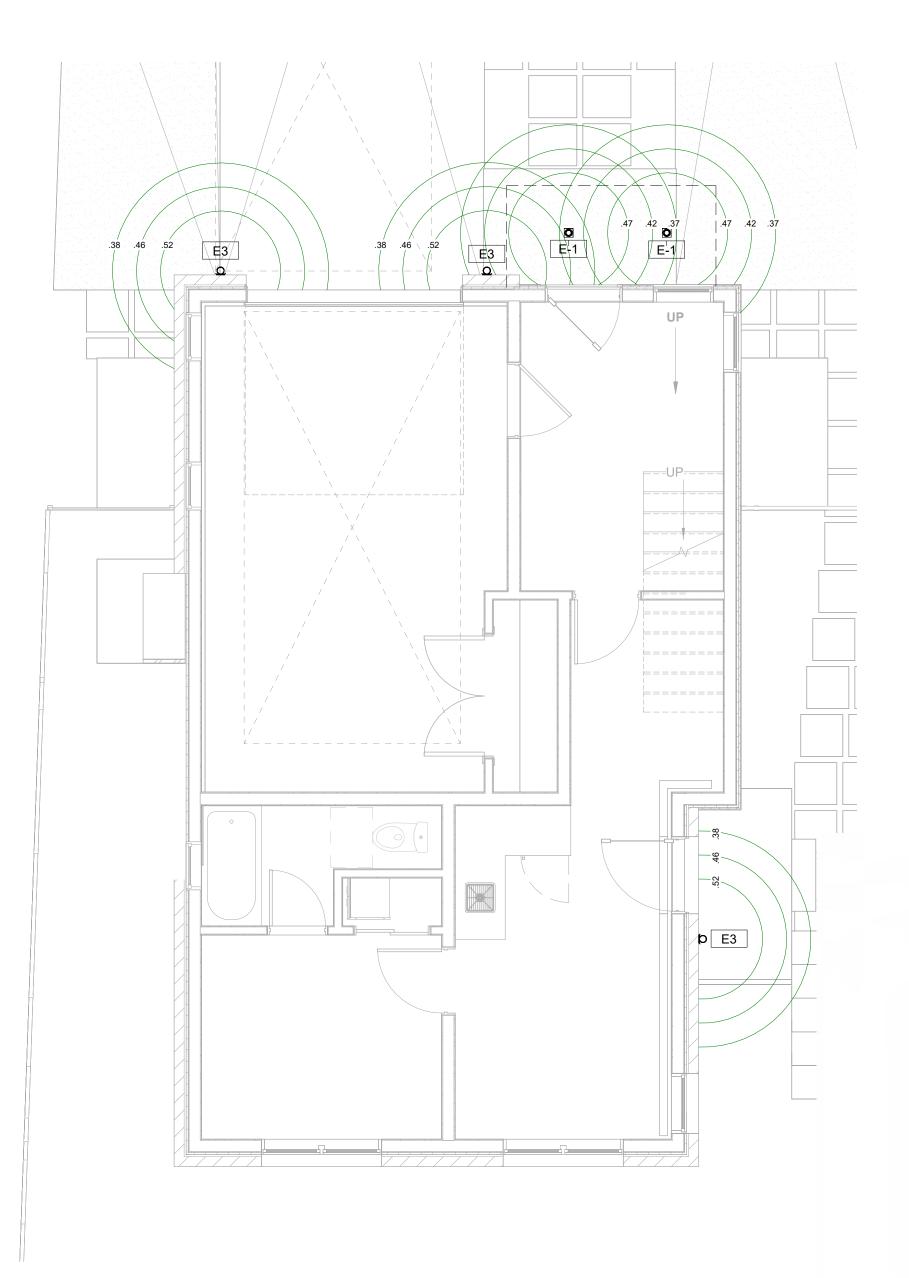



EXTERIOR E-1:

EXTERIOR RECESSED LED CAN

FINISH: BRUSHED NICKEL	
MANUFACTURER	WAC LIGHTING
ITEM	WAC514031
MATERIAL	DIE-CAST ALUMINIUM
GLASS	ETCHED LENSE
WIDTH	4.25" DIA.
HEIGHT	4.25" DIA.
DEPTH	.13"
LAMP TYPE	LED
BULB TYPE	14.5W
LUMENS	535
COLOR TEMPERATURE	2700K
CRI	85
RATED LIFE	90,000 HOURS
CERTIFICATION	IP66, UL & cUL LISDTED FOR WET LOCATIONS
DARK SKY	YES
VOLTAGE	120V, DIRECT WIRING

EXTERIOR E-2:

EXTERIOR STEP AND WALL LIGHT

FINISH: BLACK		
MANUFACTURER	WAC LIGHTING	
ITEM	WAC671977	
MATERIAL	CORROSION RESISTANT ALUMINUM	
GLASS	ETCHED LENS	
WIDTH	5"	
HEIGHT	3"	
DEPTH	.13"	
LAMP TYPE	LED	
BULB TYPE	3.9W	
LUMENS	68	
COLOR TEMPERATURE	3000K	
CRI	83	
RATED LIFE	60,000 HOURS	
CERTIFICATION	UL LISTED FOR WET LOCATIONS	
DARK SKY	YES	
VOLTAGE	120V, DIRECT WIRING	

EXTERIOR E-3:

EXTERIOR WALL SCONCE

FINISH: BRONZE	
MANUFACTURER	MODERN FORMS
ITEM	MFM1720529
MATERIAL	ALUMINUM
GLASS	LED DRIVER
WIDTH	7"
HEIGHT	7"
DEPTH	4.75"
LAMP TYPE	LED
BULB TYPE	12W
LUMENS	270
COLOR TEMPERATURE	3000K
CRI	85
RATED LIFE	50,000 HOURS
CERTIFICATION	ADA COMPLIANT & ETL LISTED WET
DARK SKY	YES
VOLTAGE	120V, DIRECT WIRING

PANDORA LED INDOOR/OUTDOOR WALL SCONCE				
FINISH: BRONZE				
MANUFACTURER	MODERN FORMS			
ITEM	MFM1720529			
MATERIAL	ALUMINUM			
GLASS	LED DRIVER			
WIDTH	7"			
HEIGHT	7"			
DEPTH	4.75"			
LAMP TYPE	LED			
BULB TYPE	12W			
LUMENS	270			
COLOR TEMPERATURE	3000K			
CRI	85			
RATED LIFE	50,000 HOURS			
CERTIFICATION	ADA COMPLIANT & ETL LISTED WET			
DARK SKY	YES			
VOLTAGE	120V, DIRECT WIRING			

LIGHTING PLANS

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REVISION

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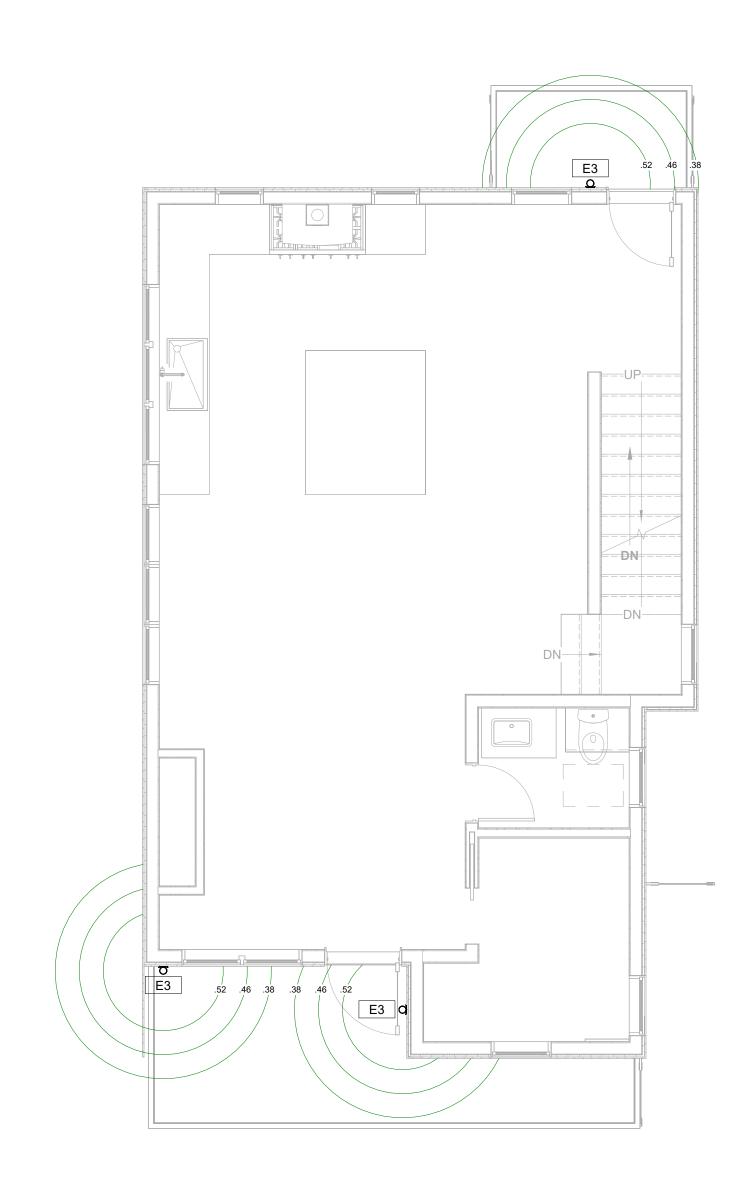
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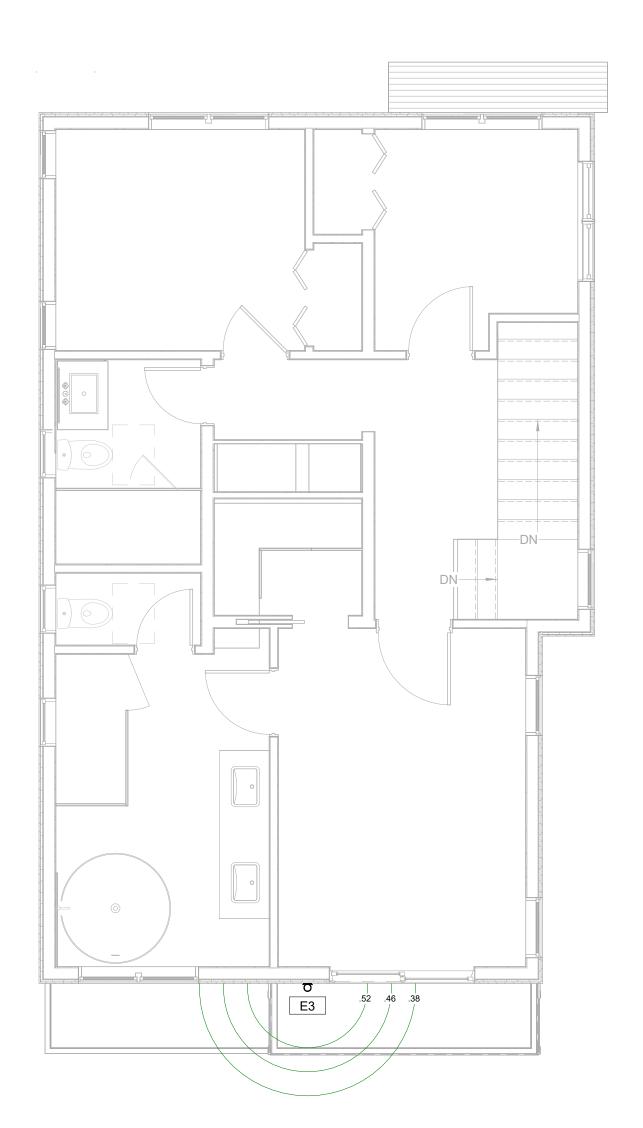
SHEET NUMBER



LOWER LEVEL EXTERIOR LIGHTING PLAN




MAIN LEVEL EXTERIOR LIGHTING PLAN



UPPER LEVEL EXTERIOR LIGHTING PLAN

1/4" = 1'-0"

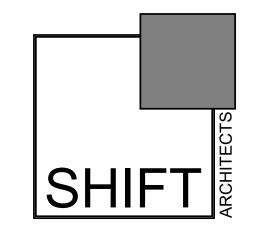

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LIGHTING PLAN