

PROJECT: 106 Cabins Lane

REGARDING: TOMV Preliminary Design Review Narrative

DATE: 03.06.2025

Site

The vacant site is located on the East side of Cabins Lane, within the Gold Hill neighborhood. The terrain slopes down to the East toward a drainage at the bottom of the hill leaving the building envelope confined to the Western portion of the lot. The orientation of the B.E. is generally running East / West, and the primary long views are to the North.

Design

Most of the homes on the East side of Cabins Lane employ an Architectural configuration consisting of the garage being the first element that a visitor would encounter with the front door being set backwards some amount. The design of the home at Gold Hill Lot 6 follows suit by using the same organizational concept. The driveway slopes down from Cabins Lane and the front entry is located to the South and beyond relative to the Garage door. The entry of the home is at the same level of the Garage, the occupant would descend about 4 feet to the Living / Dining / Kitchen area. The upper most level of the home is host to the Primary bedroom which offers spectacular views to the North. The lower level has 2 bedrooms, a bunk room and a family room. The lower deck offers connection to grade. Grade flanking the sides of the home will equal approximately existing grade. The topography of the lot does not allow for occupiable landscape areas and as a result outdoor living will occur on decks. The Architectural character of this home is meant to fit in well with the neighborhood from a geometry and material standpoint.

Lighting

We work within the constraints of the night sky initiative frequently. The Entry of the home has a combination of ceiling mounted lights and a singular wall sconce at the front door. Step lights have been placed at the exterior of the building at walkways and doorways to assist the occupant in safely navigating the property while not creating an oppressive beacon of light in the night. The back decks also have ceiling mounted lights per TOMV code.

Construction

This steep lot is bracketed by existing homes on both sides and is only accessible from the street side. It will be up to the general contractor to coordinate sequencing to avoid impacts to the neighboring properties. Contractor parking will need to be coordinated to minimize the nuisance of construction within the neighborhood. Only a certain number of spaces will be available on site, the General Contractor may have to implement a shuttle or other means to convey laborers to the site. Parking will be addressed in the Construction Management Plan.

Property and Zoning Information

Legal Description: LOT GH-6, THE CABINS AT GOLD HILL, AN AMENDMENT TO THE FINAL PLAT OF LOTS 166B, 166C, 166D, 166E, AND 166F, TELLURIDE MOUNTAIN VILLAGE, FILING 31, TOWN OF MOUNTAIN VILLAGE, ACCORDING TO THE PLAT RECORDED APRIL 16, 1997 IN PLAT BOOK 1 AT PAGE 2228, COUNTY OF SAN MIGUEL, STATE OF COLORADO

Parcel ID: 477910100071

Address: 106 Cabins Lane Mountain Village, CO 81435

Lot Size: 7,675 SF

Zone District: Single Family

Max Building Height: Required = 40' for Gable Roof. Proposed = 38.7"

Average Building Height: Required = 30'. Proposed = 28.3' Lot Coverage: Required = 40% Max. Proposed = 38.9%

Setbacks:

Front: Required = 5'. Proposed = 15'-8"

Sides: Required = 5". Proposed North = 6'-6". Proposed South = 6'-6"

Rear: Required = 64'. Proposed = 65' Roof Pitches: Primary 8"/12". Secondary 5"/12"

Exterior Materials:

Stone: Required = 35% Minimum. Proposed = 38.65% Windows: Required 40% Maximum. Proposed = 18.27% Parking: Required = 2 Enclosed. Proposed 2 Enclosed

17.5.4.F: Town Design Theme

- 1. The home is sited very similarly to the other homes located on the East side of Cabins Lane, garage and entry doors located on the West side of the home. The prominent views are to the North, although largely obscured by trees and other homes on all levels excluding the upper level. All trees surrounding the building envelope will need to be removed, trees to the East (down the hill) will remain as much as able within the constraints of fire mitigation.
- 2. The simple massing steps down with the topography and appears low from the street view.
- 3. All uncovered portions of the home at grade are resting upon a rusticated base to withstand the alpine snow conditions. Covered or otherwise exposed facades will have a hefty base flashing to combat the alpine snow conditions.
- 4. All roofs to be guttered and contain snow retention bars for the safety of the occupants and their surroundings.
- 5 & 6. Exterior materials have been chosen for their natural quality and their ability to fit in with the neighborhood.

15.5.5.A. Building Siting Design

1. The siting of the building and routing of driveway and walkways are designed in a similar manner to the other homes in the neighborhood. Utility meters are located to be screened somewhat from the street, but still provide access for maintenance. Drainage will be directed away from the home and largely follow the existing topography; down the hill.

Design Variation: 17.3.13 D: We will likely be asking for on grade utility access stairs to be located outside of the B.E.

- 2. The building siting, foundation plan and construction plan envisions minimizing the amount of site disturbance as reasonable while allowing for tree and fire mitigation as noted on the Civil plans.
- 3. All roofs will be guttered and contain snow retention bars for the safety of the occupants and their surroundings.


17.5.6.A Building Form

The form of the building has a substantially grounded base. The massing of the overall building is broken into smaller elements in floor plan and in elevation. Masonry walls have only a select few windows located, they will be recessed back from the face of the masonry to reveal a 5" depth to convey heavy, thick massing.

17.5.6.B Exterior Wall Form

Walls of varied materials overall are simple in design allowing the larger expanses of windows to express views from the interior with overhangs assisting in shielding the glass from the adjacent view lines. A heavy stone base supports the majority of the home.

SYMBOL LEGEND

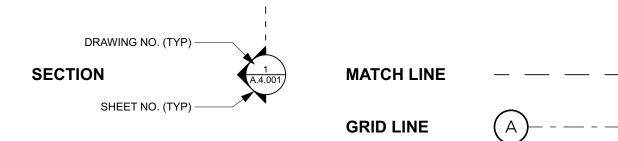



EXTERIOR ELEVATION

ROOM NAME & NUMBER LIVING

DOOR MARK

ASSEMBLY MARK

DRAWING REVISION

INTERIOR ELEVATION

PROJECT DIRECTORY

VANTAGE RETIREMENT PLANS LLC... 8742 E Via De Commercio Scottsdale, AZ 85258

ARCHITECT

KA DesignWorks, Inc. 525 Basalt Avenue, Unit I-201 Basalt, CO 81621

XXX

CONTRACTOR

XXX Main Street City, CO 12345 **CIVIL ENGINEER**

PO Box 3945 Telluride, CO 81435

Uncompangre Engineering, LLC

STRUCTURAL ENGINEER XXX

XXX Main Street City, CO 12345

LANDSCAPE ARCHITECT

XXX Main Street City, CO 12345

SURVEYOR

XXX Main Street City, CO 12345 **ENERGY CONSULTANT**

XXX Main Street

City, CO 12345

XXX Main Street

CONTACT: Amit Sahasrabudhe

amit1124@gmail.com

CONTACT: Kenneth Adler (970) 948-9510 ken@ka-designworks.com

CONTACT: XXX XXXX (XXX) XXX-XXXX contractor@email.com

CONTACT: David Ballode (970) 729-0683 dballode@msn.com

CONTACT: XXX XXXX (XXX) XXX-XXXX structural@email.com

CONTACT: XXX XXXX (XXX) XXX-XXXX landscape@email.com


CONTACT: XXX XXXX (XXX) XXX-XXXX surveyor@email.com

CONTACT: XXX XXXX (XXX) XXX-XXXX energy@email.com

GEOTECHNICAL ENGINEER

CONTACT: XXX XXXX (XXX) XXX-XXXX City, CO 12345 geotech@email.com

VICINITY MAP

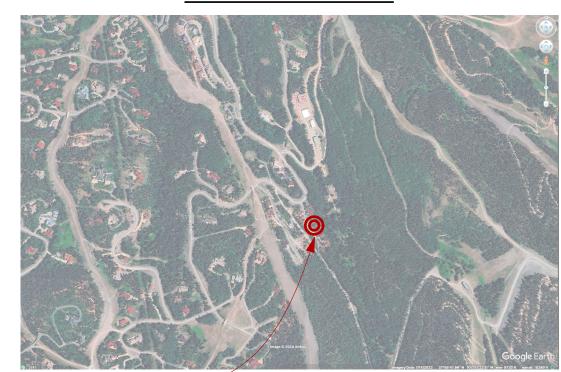


PROJECT LOCATION -

Gold Hill Lot 6 Town of Mountain Village, CO

TOMV Preliminary - 03/06/25

PROJECT INFO:		CODE & ZONING INFORMATION:		PROJECT SCOPE:
PROJECT ADDRESS:	106 Cabins LN Town of Mountain Village CO 81435	IRC EDITION:	2018	Single family residence to be constructed on vacant land.
JURISDICTION:	Town of Mountain Village	IECC EDITION:	2021	
PARCEL ID:	477910100071	CLIMATE ZONE:	6B	
LEGAL DESCRIPTION:	LOT GH 6 THE CABINS AT GOLD HILL	ZONING DISTRICT:	Single-Family	
SUBDIVISION:	CABINS AT GOLD HILL-7034	HOA:	THE CABINS AT GOLD HILL	
BLOCK:	Section 10 Township 42 Range 09			
LOT NUMBER:	Lot 6			
LOT SIZE:	7675 SF			

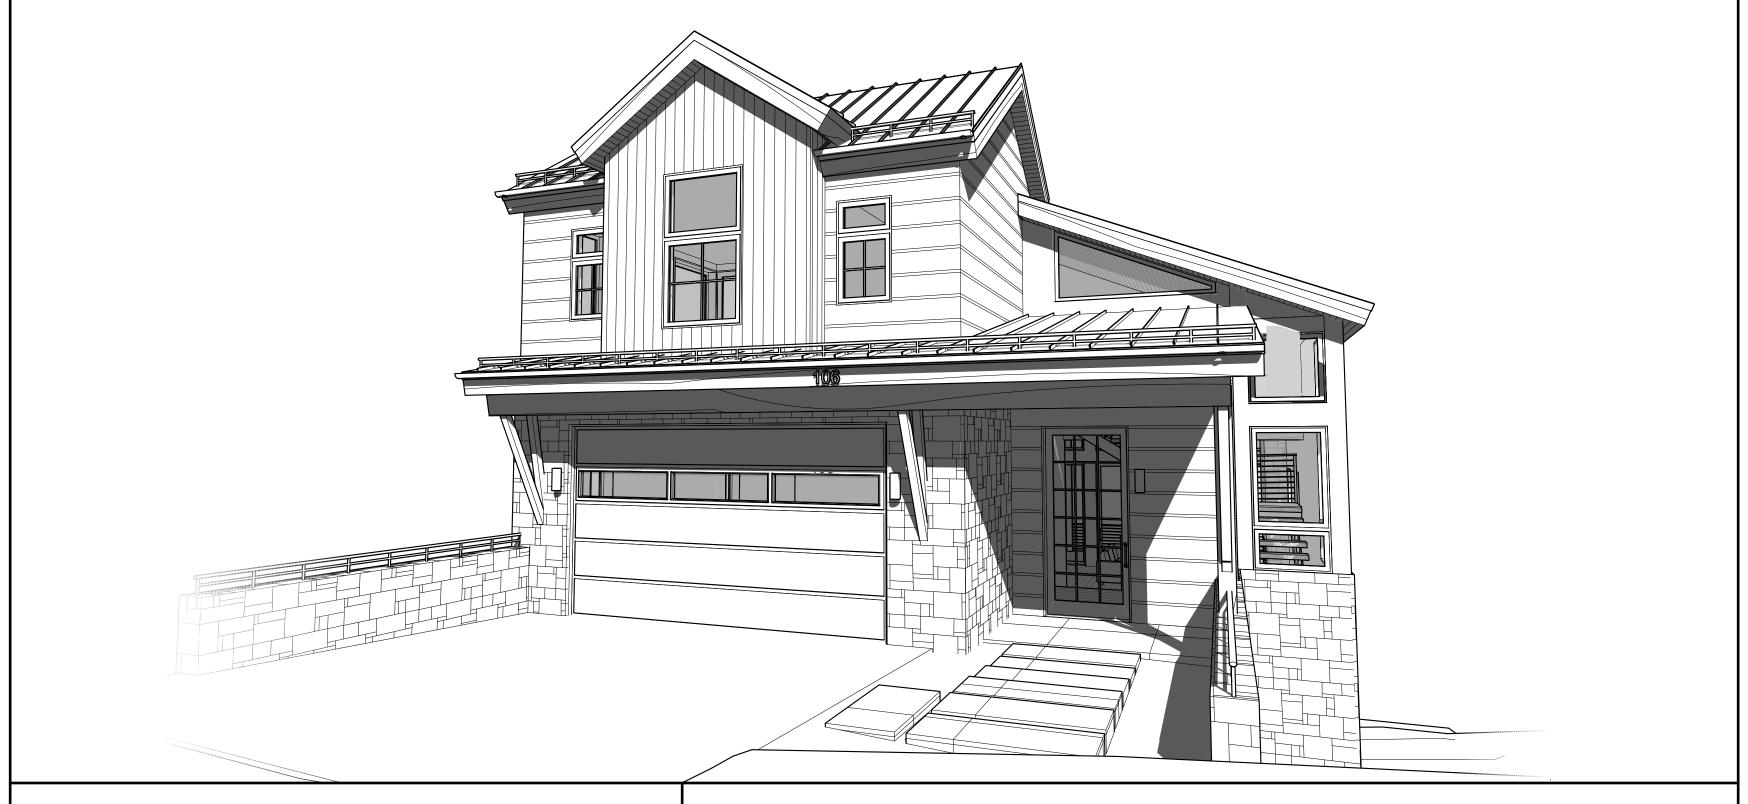

ABBREVIATIONS

	Attic Access Door	GALV	Galvanized	RW	Roof Window
	Addendum	GC	General Contractor	RO	Rough Opening
	Adjacent	GL	Glass	SAN	Sanitary
	Area of Refuge	GR	Grade	SECT	Section
	Aggregate	GLB	Laminated Wood Beam	SEW	Sewer
	Above Finished Floor	GYP	Gypsum	SHT	Sheet
	Alternate	GWB	Gypsum Wallboard	SHLV	Shelves
	Architectural	HDW	Hardware	SIM	Similar
	Beam	HD	Head	SL	Sliding
	Bearing	HVAC	Heating, Ventilating,	SM	Sheet Metal
	Between		and Air Conditioning	STC	Sound- Transmission
	Board	HT	Height	SPEC	Specification
	Both Sides	HWY	Highway	SQ	Square
	Bottom Of	HOR	Horizontal	STD	Standard
	Building	ID	Inside Diameter	STL	Steel
	Cabinet	INT	Interior	STRUCT	Structure (al)
	Centerline	JT	Joint	SUB	Substitute
	Ceramic	LAM	Laminate	SUPPL	Supplement (al)
	Clear	LAV	Lavatory	SUSP	Suspend (ed)
	Closet	MFG	Manufacturer	TEL	Telephone
	Concrete Masonry Unit	MO		TV	Television
	Column	MTL	Masonry Opening Material	TEMP	
		MAX			Tempered
•	Concrete		Maximum	IE	That Is
	Construction Joint	MC	Medicine Cabinet	THK	Thick
	Continuous	MECH	Mechanical	TPH	Toilet Paper Holder
	Damproofing	MIN	Minimum	T&G	Tounge and Groove
	Detail	MISC	Miscellaneous	T&B	Top and Bottom
	Diameter	NIC	Not In Contract	TO	Top Of
	Dimension	NA	Not Applicable	T	Tread
	Dishwasher	NTS	Not to Scale	TS	Tube Steel
	Down	OC	On Center	TYP	Typical
	Drain	OPG	Opening	UG	Underground
	Downspout	OPP	Opposite	U.N.O.	Unless Noted Otherw
3	Drawing	OPH	Opposite Hand	UNFIN	Unfinished
	Each	OD	Outside Diameter	UBC	Uniform Building Cod
	Elevation	d	Penny (nails, etc.)	USG	United States Gage
	Equal	PERF	Perforated (d)	VAR	Variable
	Existing	PFSM	Prefinished Sheet Metal	VENT	Ventilate
	Expansion Joint	PL	Plate	VIF	Verify In Field
	Exterior	PLY	Plywood	VERT	Vertical
	Fire Extinguisher Cabinet	PROD	Product	VAT	Vinyl Asbestos Tile
	Face Of Concrete	PROJ	Project	V	Voltage
	Face Of Stud	PROP	Property	WC	Water Closet
	Finish	R	Radius or Riser	WP	Waterproof
	Fireproof	REF	Refer	WT	Weight
	Floor	REFR	Refrigerator	WIN	Window
	Floor Drain	REINF	Reinforce (d)	W/	With (comb. form)
	Footing	REQ'D	Required	W/O	Without
	Foundation	RHSM	Round Head Sheet Metal Screw	WD	Wood
	Guage	RM	Room		

CER CLR CLOS CMU COL CONC

FTG FDN

GENERAL NOTES

- A. THE AIA DOCUMENT 201, "GENERAL CONDITIONS OF THE CONTRACT FOR CONSTRUCTION", 2017, ARE HEREBY MADE A PART OF THESE CONTRACT DOCUMENTS. COPIES ARE ON FILE AND ARE AVAILABLE FOR INSPECTION AT THE OFFICES OF THE ARCHITECT.
- B. THE CONTRACT DOCUMENTS CONSIST OF THE AGREEMENT, THE GENERAL NOTES, THE SPECIFICATIONS, AND THE DRAWINGS, WHICH ARE COOPERATIVE AND CONTINUOUS. WORK INDICATED OR REASONABLY IMPLIED IN ANY ONE OF THE DOCUMENTS SHALL BE SUPPLIED AS THOUGH FULLY COVERED IN ALL. ANY DISCREPANCY BETWEEN THE DIFFERENT PARTS SHOULD BE REPORTED TO THE ARCHITECT IMMEDIATELY.
- C. ALL WORK SHALL COMPLY WITH ALL STATE AND LOCAL CODES AND ORDINANCES, AND SHALL BE PERFORMED TO THE HIGHEST STANDARDS OF CRAFTSMANSHIP BY JOURNEYMEN OF THE APPROPRIATE TRADES. GENERALLY, ALL MATERIALS TO BE INSTALLED IN ACCORDANCE WITH MANUFACTURER'S SPECIFICATIONS, UNLESS OTHERWISE REGULATED OR SPECIFIED BY ARCHITECT OR GOVERNING BODIES
- D. IT IS THE RESPONSIBILITY OF THE CONTRACTOR TO BRING TO THE ATTENTION OF THE ARCHITECT ANY CONDITIONS WHICH WILL NOT PERMIT CONSTRUCTION ACCORDING TO THE INTENTIONS OF THESE DOCUMENTS.
- ANY MATERIALS PROPOSED FOR SUBSTITUTION OF THOSE SPECIFIED OR CALLED OUT BY TRADE NAME IN THESE DOCUMENTS SHALL BE PRESENTED TO THE ARCHITECT FOR REVIEW. THE CONTRACTOR SHALL SUBMIT SAMPLES WHEN REQUIRED BY THE ARCHITECT. AND ALL SUCH SAMPLES SHALL BE REVIEWED BY THE ARCHITECT BEFORE THE MATERIALS ARE ORDERED AND WORK HAS COMMENCED. WORK MUST CONFORM TO THE REVIEWED SAMPLES. ANY WORK WHICH DOES NOT CONFORM SHALL BE REMOVED AND REPLACED WITH WORK WHICH CONFORMS AT THE REQUESTS AND SAMPLES FOR REVIEW THROUGH THE GENERAL CONTRACTOR'S EXPENSE. SUBCONTRACTORS SHALL SUBMIT CONTRACTOR WHEN WORK IS LET THROUGH HIM OR HER. REQUIRED VERIFICATIONS AND SUBMITTALS TO BE MADE IN ADEQUATE TIME AS NOT TO DELAY WORK IN PROGRESS.

F. SHOP DRAWINGS SHALL BE SUBMITTED TO THE ARCHITECT FOR HIS OR HER REVIEW WHERE CALLED FOR ANYWHERE IN THESE DOCUMENTS. REVIEW SHALL BE MADE BY THE ARCHITECT BEFORE WORK IS BEGUN, AND WORK SHALL CONFORM TO THE REVIEWED SHOP DRAWINGS, SUBJECT TO REPLACEMENT AS REQUIRED IN

PARAGRAPH E, ABOVE.

- G. THE BUILDING INSPECTOR SHALL BE NOTIFIED BY THE CONTRACTOR WHEN THERE IS NEED OF INSPECTION AS REQUIRED BY THE UNIFORM BUILDING CODE OR ANY LOCAL CODE OR ORDINANCE.
- H. THE CONTRACTOR SHALL BE RESPONSIBLE FOR THE SAFETY AND CARE OF ADJACENT PROPERTIES DURING CONSTRUCTION, FOR COMPLIANCE WITH FEDERAL AND STATE O.S.H.A. REGULATIONS, AND FOR THE PROTECTION OF ALL WORK UNTIL IT IS DELIVERED COMPLETED TO THE OWNER.
- ALL DIMENSIONS NOTED TAKE PRECEDENCE OVER SCALED. DIMENSIONS NOTED WITH "N.T.S." DENOTES NOT TO SCALE. DRAWINGS NOT TO BE SCALED, NOTIFY ARCHITECT OF ANY CONFLICTS
- J. CONTRACTOR SHALL VERIFY AND COORDINATE ALL OPENINGS THROUGH FLOORS, CEILINGS, AND WALLS WITH ALL ARCHITECTURAL, STRUCTURAL, MECHANICAL, PLUMBING AND ELECTRICAL DRAWINGS.
- K. CONTRACTOR WILL ASSUME RESPONSIBILITY OF ITEMS REQUIRING COORDINATION AND RESOLUTION DURING THE BIDDING PROCESS.
- L. CONTRACTOR TO PROVIDE PHYSICAL EXTERIOR MATERIAL SAMPLES INCLUDING COLORS/FINISHES AND CONFIGURATIONS FOR OWNER APPROVAL PRIOR TO PROCUREMENT AND INSTALLATION.

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A003 HEIGHT PLANS

A004 EXTERIOR MATERIAL AREAS

A005 LANDSCAPE

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C3 UTILITIES

C4 CONSTRUCTION MITIGATION AND ACCESS

C5 FIRE MITIGATION

ARCHITECTURAL

A101 LOWER LEVEL PLAN

A102 MAIN LEVEL PLAN A103 UPPER LEVEL PLAN

A104 ROOF PLAN


A201 ELEVATIONS

A202 ELEVATIONS A203 3D EXTERIOR 1

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A301 BUILDING SECTIONS A601 DOOR & WINDOW SCHEDULE

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Schematic Design HOA Prelim #2 TOMV Initial

09.11.24

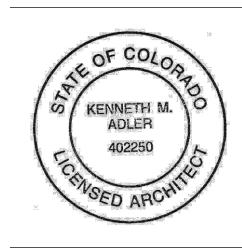11.08.24

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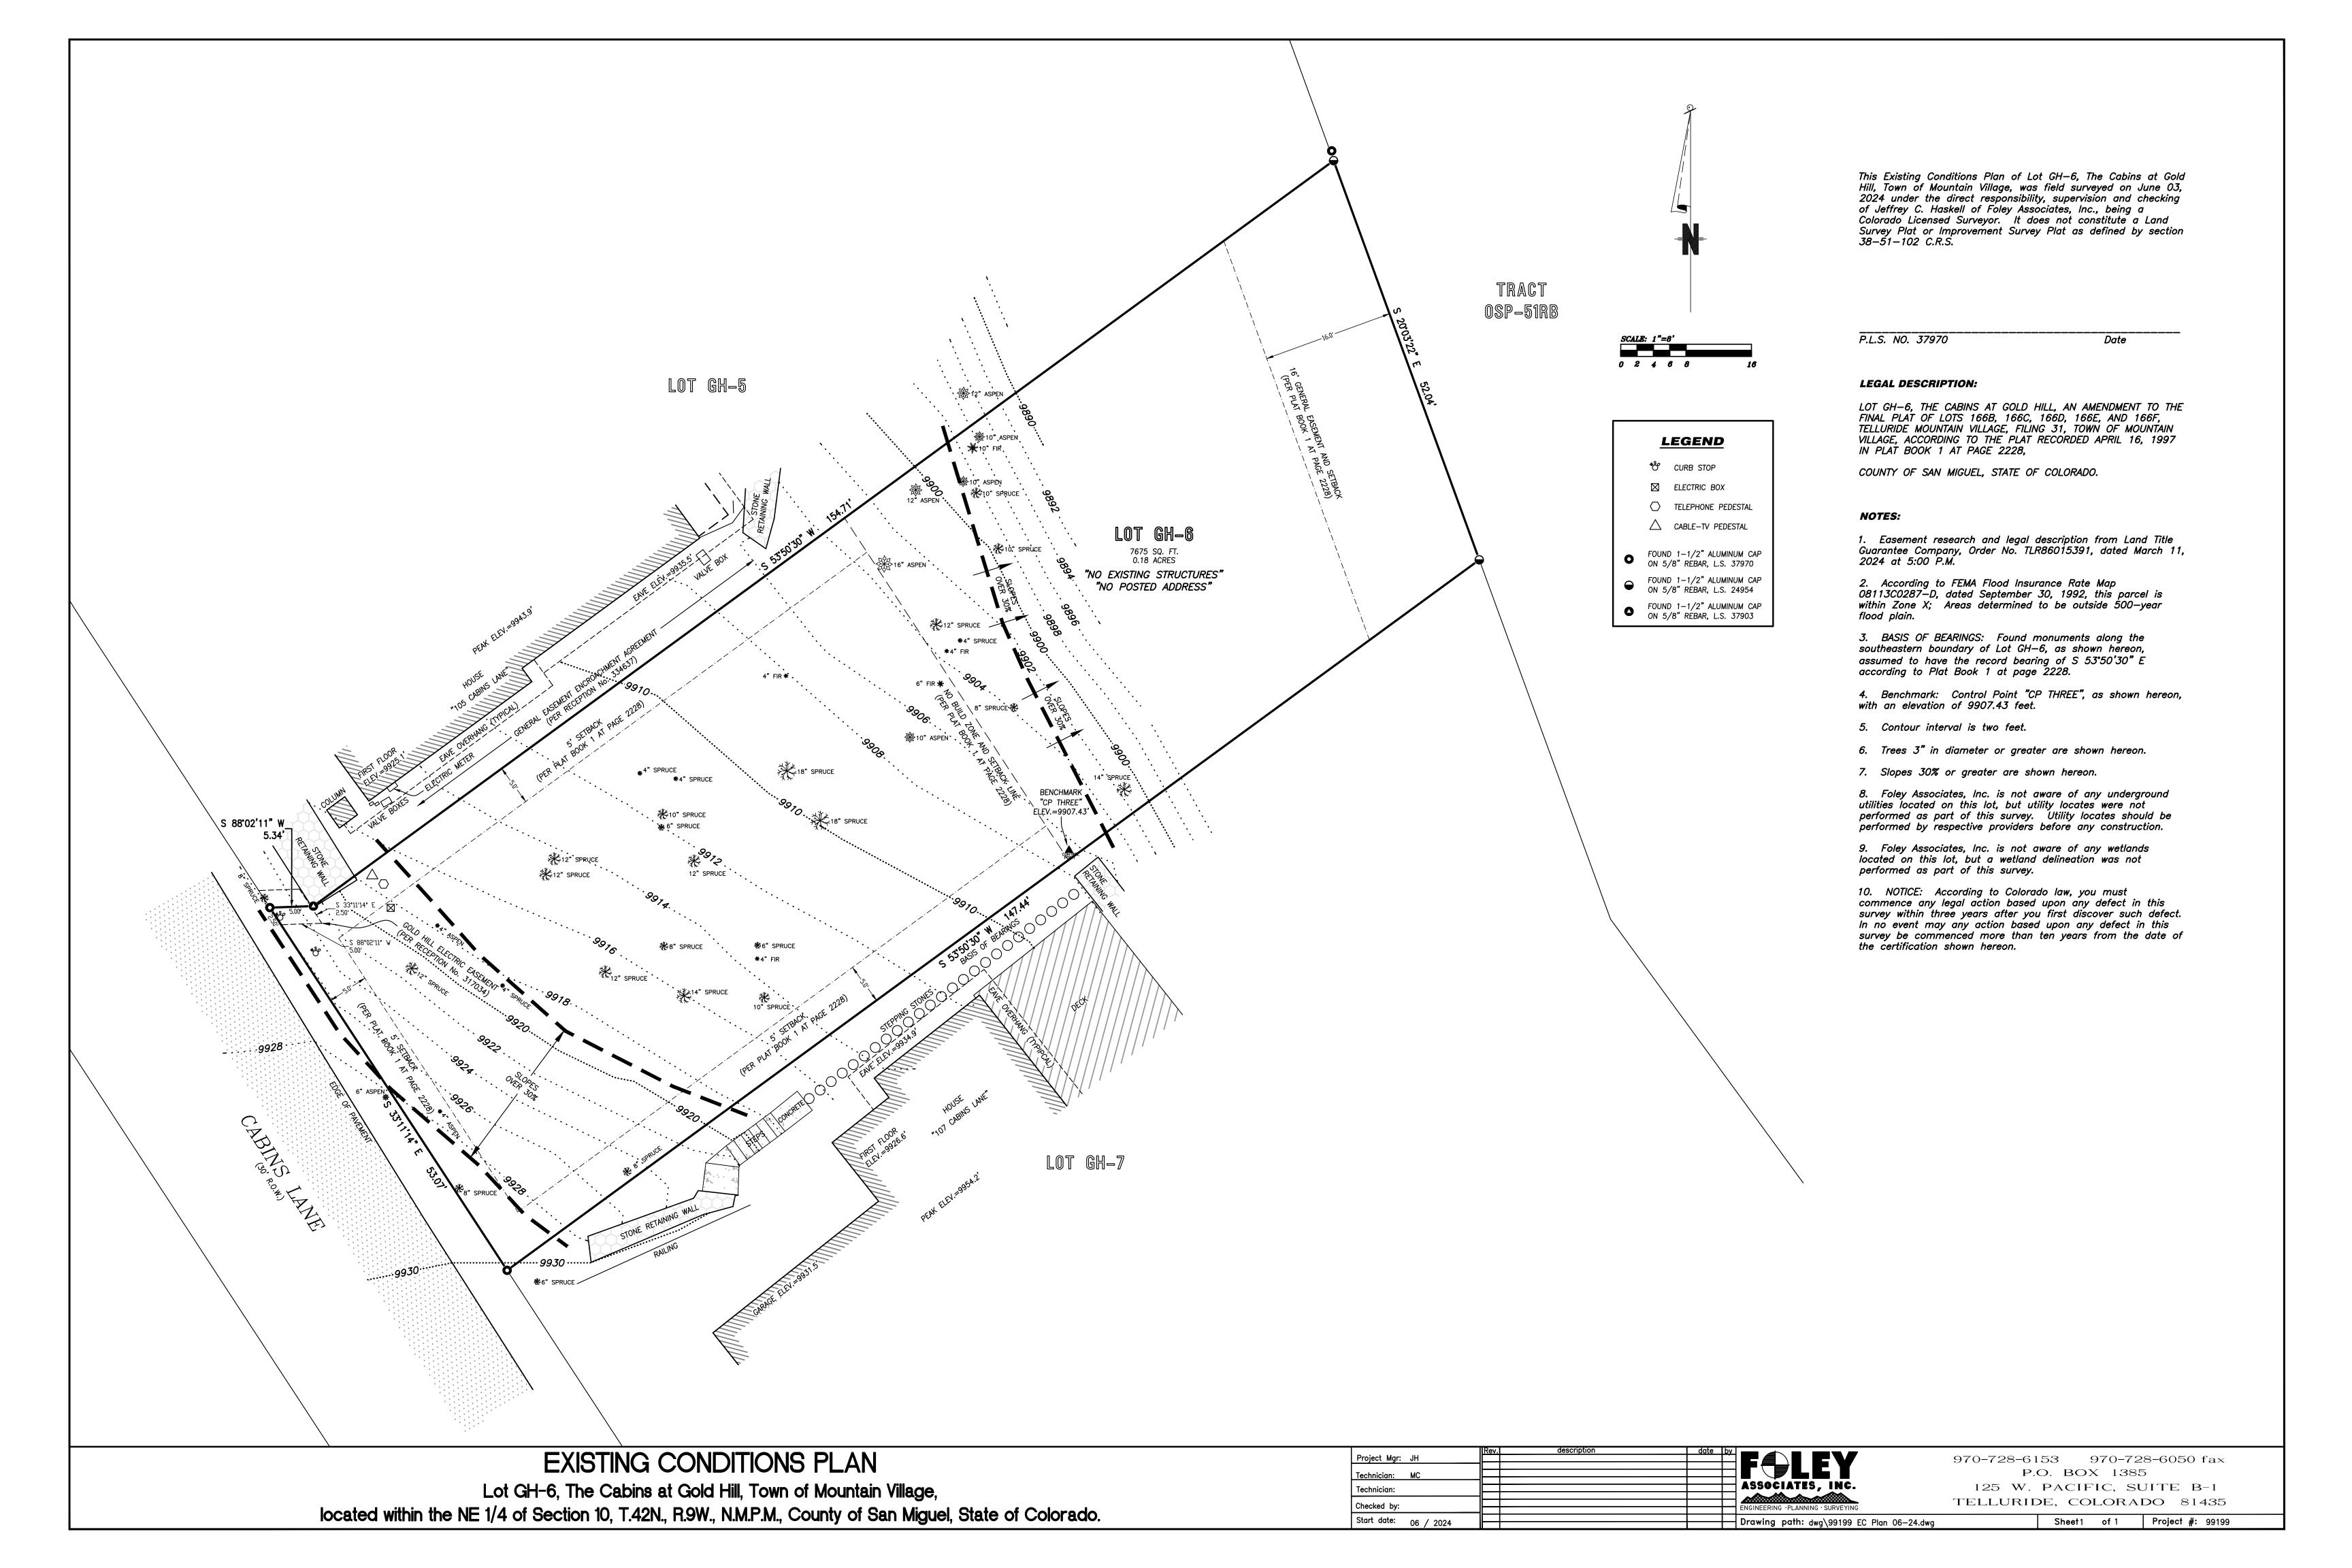
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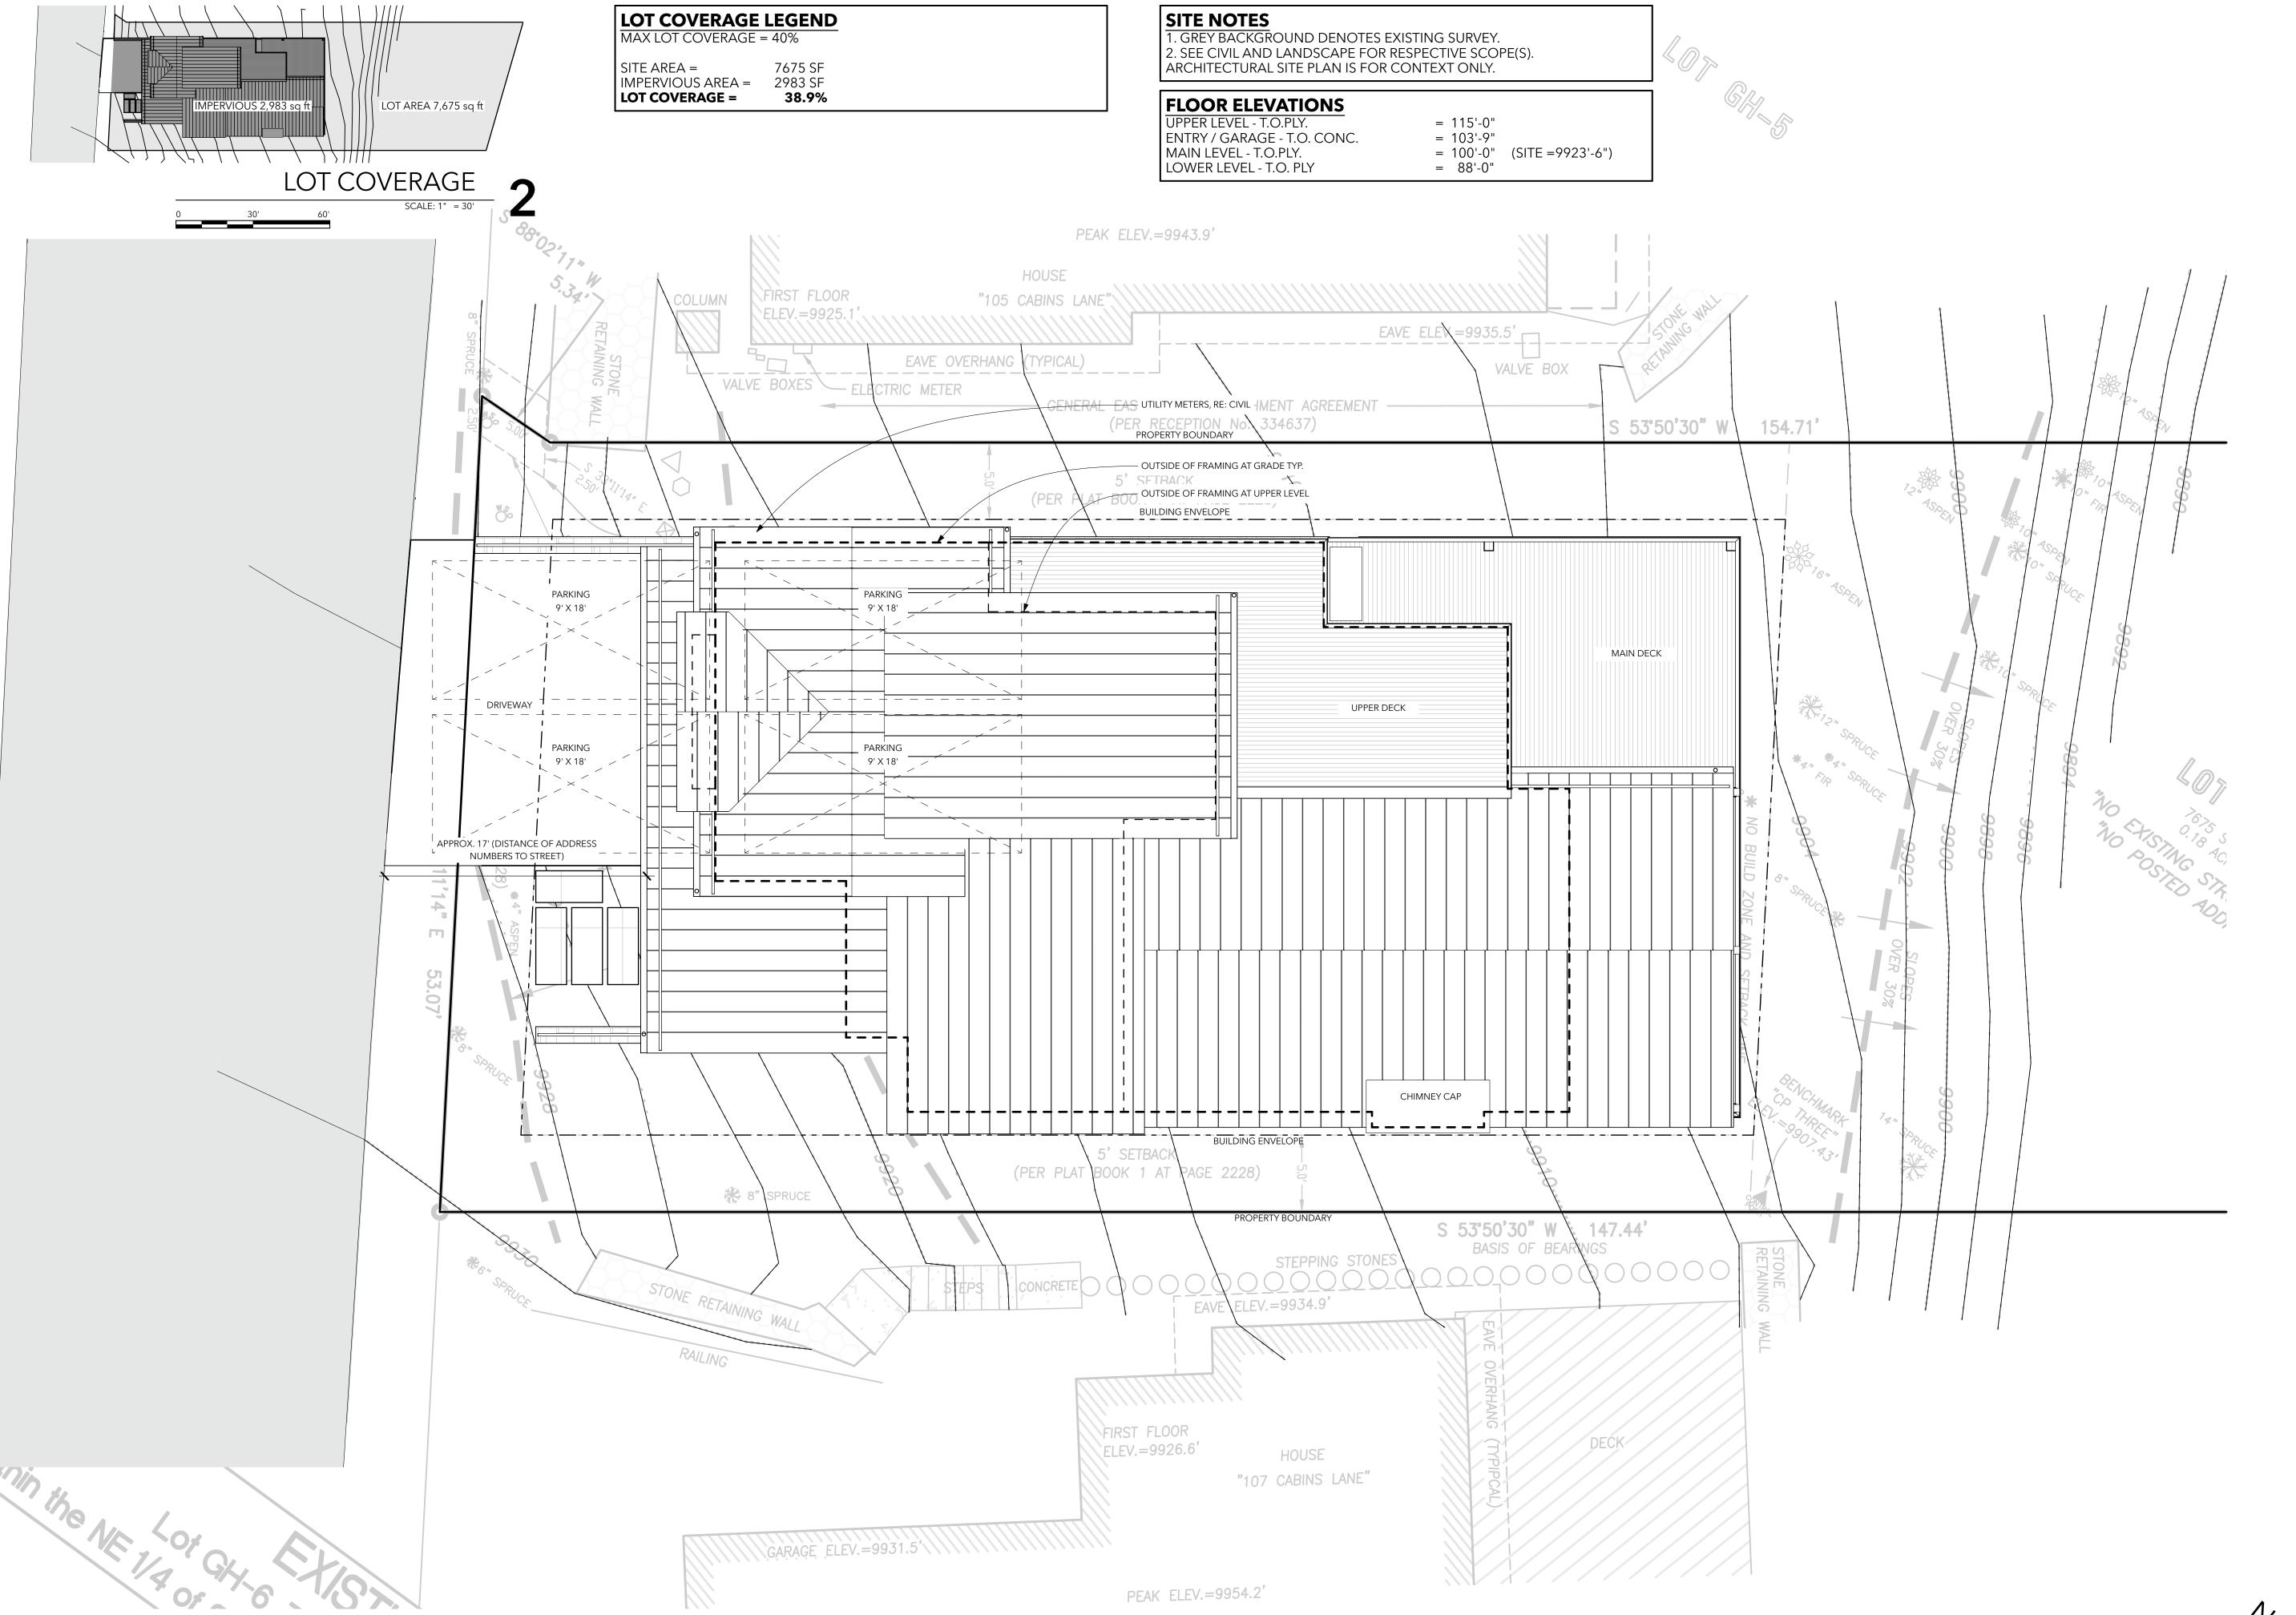
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SHEET TITLE

COVER SHEET






D E S I G N W O R K S

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Id Hill Lot 6
106 Cabins LN
Mountain Village, CO 81435

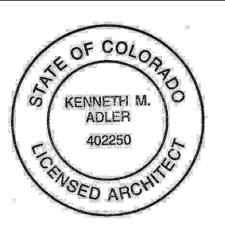

ISSUE Schematic Design HOA Prelim #2 TOMV Initial

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SHEET TITLE
SITE PLAN

SITE PLAN

SCALE: 1" = 5'

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266	3	M1 9,954.36'		806	906	7
	M6 9,953.36'		M2 9,948.26			

MAXIMUM HEIGHT Per TOMV code 17.3.11 which allows for the ridge of gable or similar pitched roof for a total of 40'.

Below

9916.90

9906.20

9914.60

9918.10

37.46

27.16

24.01


Roof Height Above Proposed Grade

Natural Grade

37.46

37.26

38.73

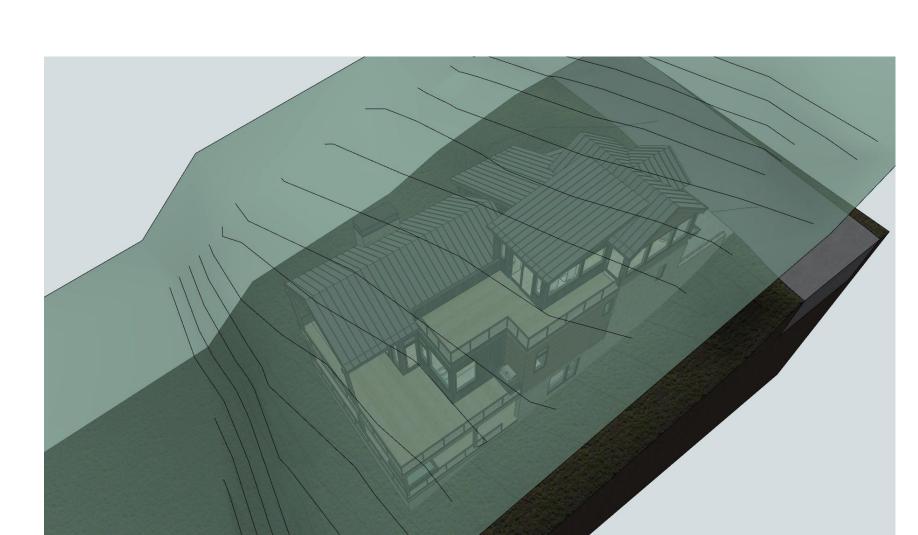

Natural Grade

9911.00

9906.20

9914.60

9918.10

Roof Point Roof Point Elevation

M 3

9948.26


9944.93

9942.11 9953.36

40' Height Conformance Exhibit - 62% of roofs are Gables

Roof Point	Roof Mid Point Elevation	Natural Grade Below	Proposed Grade Below	NG = Natural Grade PG = Proposed Grade	Roof Height Above Most Restrictive Grade
A 1.0	9939.07	9918.20	9927.20	NG	20.87
A 1.1	9938.07	9920.10	9927.20	NG	17.97
A1.2	9938.07	9922.00	9927.20	NG	16.07
A1.3	9940.37	9919.40	9927.20	NG	20.97
A1.4	9940.37	9921.60	9921.60	NG	18.77
A2.0	9951.07	9916.10	9916.10	NG	34.97
A2.1	9951.07	9919.50	9927.20	NG	31.57
A3.0	9950.60	9912.90	NA	NG	37.70
A3.1	9950.60	9914.50	NA	NG	36.10
A4.0	9945.76	9917.80	NA	NG	27.96
A4.1	9945.76	9913.70	NA	NG	32.06
A5.0	9941.10	9913.60	NA	NG	27.50
A5.1	9941.10	9909.60	NA	NG	31.50
A5.2	9941.10	9905.50	NA	NG	35.60
A6.0	9941.10	9914.30	NA	NG	26.80
A6.1	9941.10	9910.70	NA	NG	30.40
A6.2	9941.10	9906.30	NA	NG	34.80
				AVERAGE HEIGHT	28.33

AVERAGE HEIGHT Per TOMV code 17.3.11 which defines the maximum average roof height of

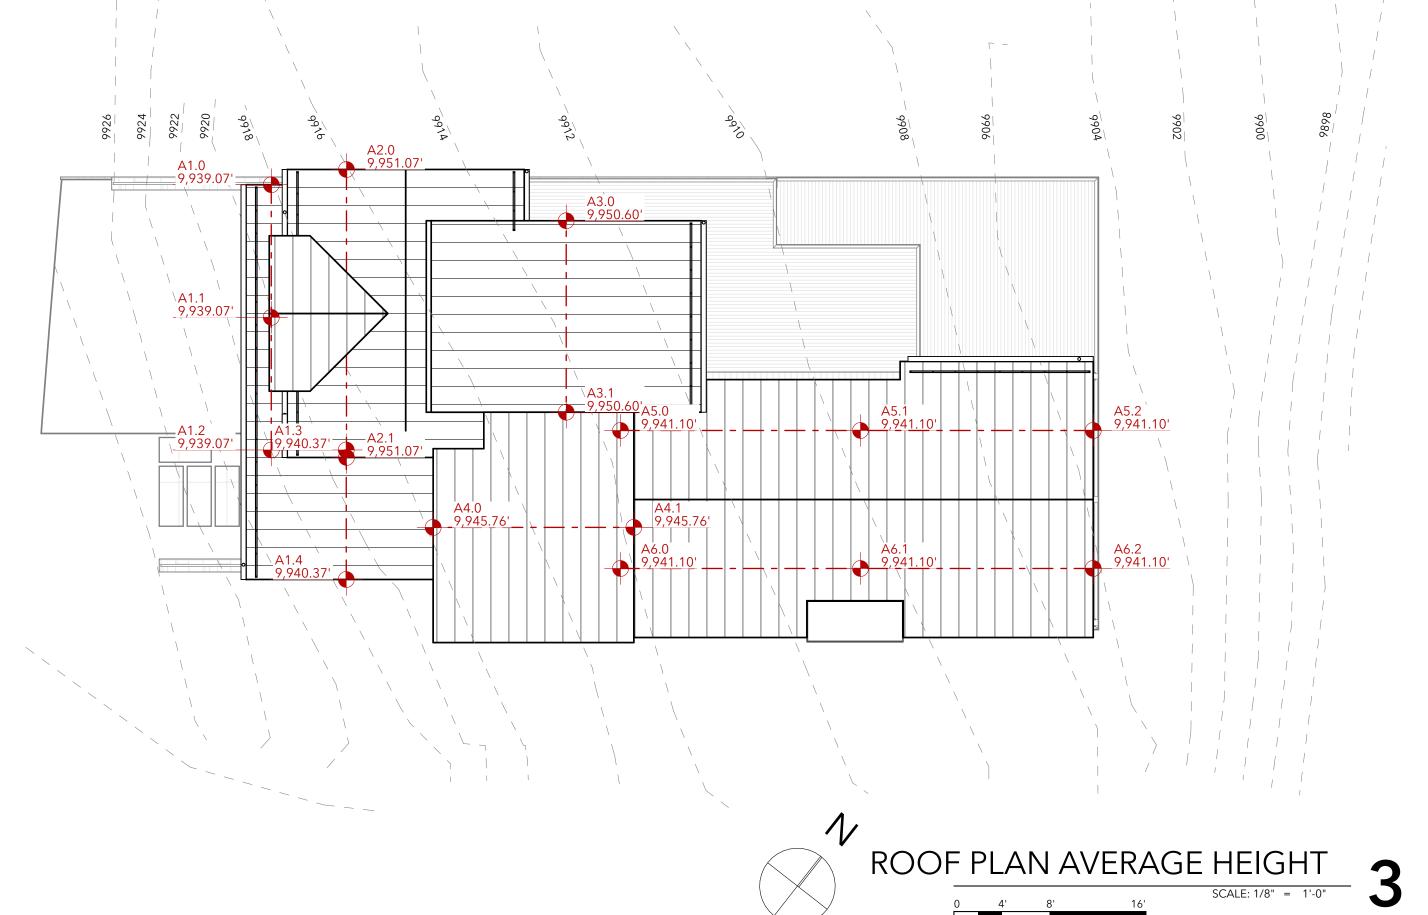

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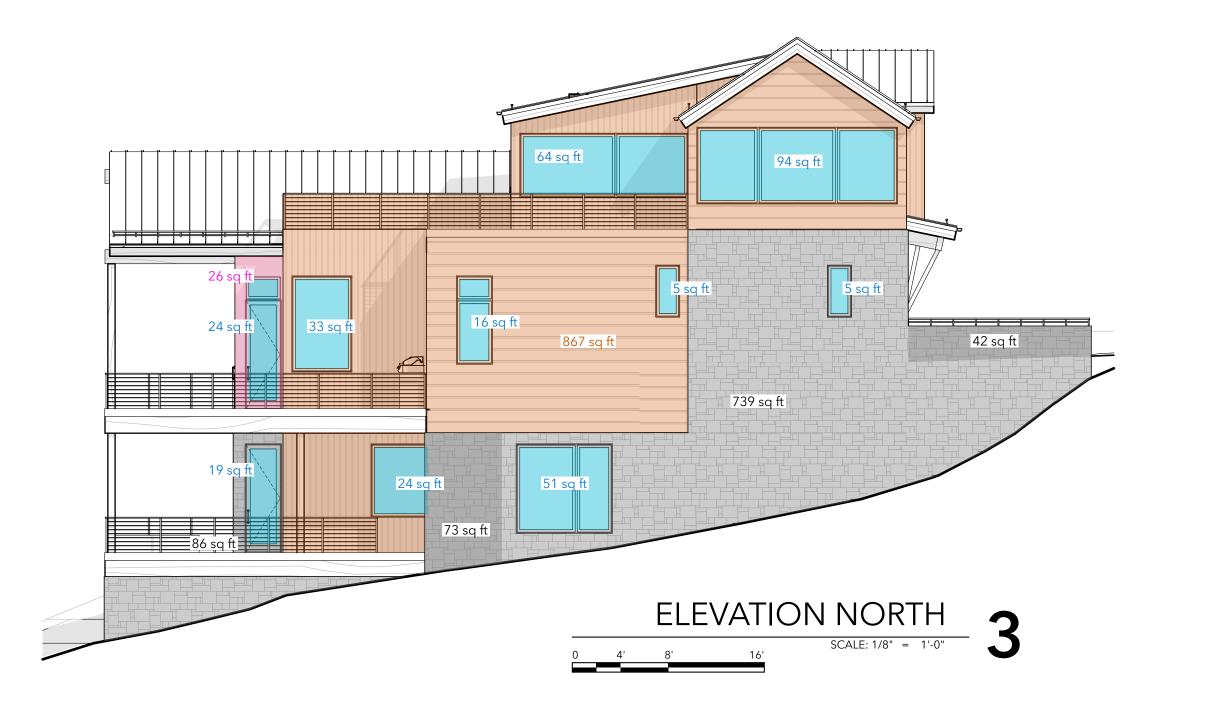
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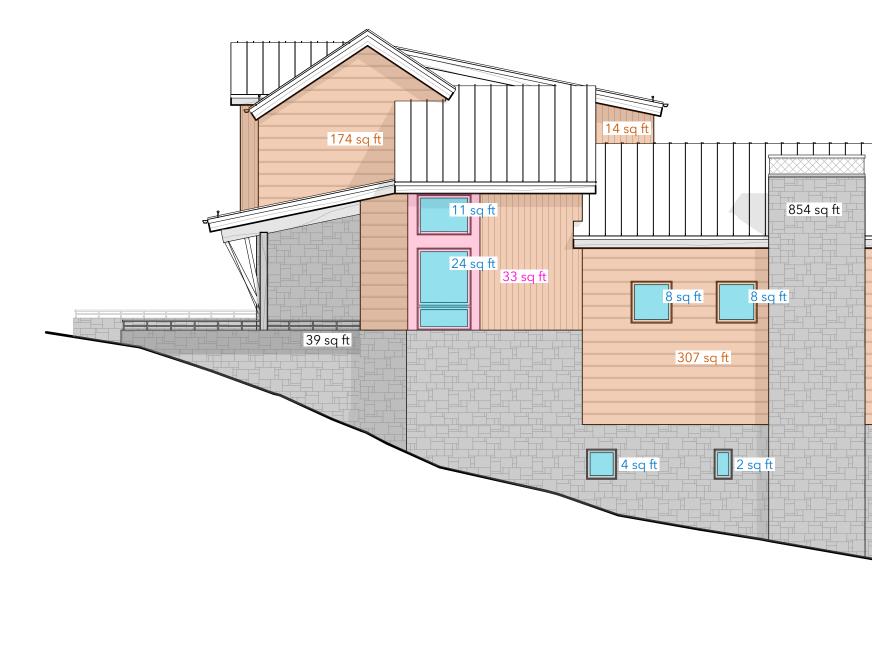
SHEET TITLE

HEIGHT PLANS









ELEVATION EAST

O 4' 8' 16'

SCALE: 1/8" = 1'-0"


ELEVATION SOUTH


SCALE: 1/8" = 1'-0"

MATERIALS	SQ FT	% OF TOTAL WALL AREA
ELEVATION NORTH		
STONE	825	40.19%
GLASS	335	16.32%
WOOD	867	42.23%
METAL	26	1.27%
TOTAL	2053	100.00%
ELEVATION EAST		
STONE	371	27.46%
GLASS	491	36.34%
WOOD	388	28.72%
METAL	101	7.48%
TOTAL	1351	100.00%
ELEVATION SOUTH		
STONE	854	56.26%
GLASS	65	4.28%
WOOD	566	37.29%
METAL	33	2.17%
TOTAL	1518	100.00%
ELEVATION WEST		
STONE	87	14.33%
GLASS	119	19.60%
WOOD	349	57.50%
METAL	52	8.57%
TOTAL	607	100.00%
TOTAL WALL AREA		
STONE	2137	38.65%
GLASS	1010	18.27%
WOOD	2170	39.25%
	0.10	3.83%
METAL	212	3.037

WALLAREAS SCALE: 1' = 1'-0"



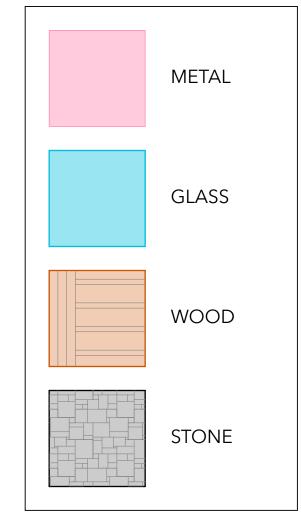

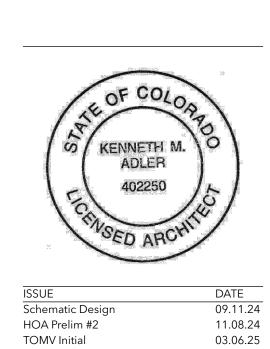

Gold Hill

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SHEET TITLE

EXTERIOR MATERIAL AREAS

GENERAL NOTES

ALL TREES AND SHRUBS TO BE LOCATED BY ARCHITECT / OWNER. CONSULT WITH TOMV FORESTER PRIOR TO ORDERING AND PLANTING TREES / SHRUBS.

2. ALL TREES AND SHRUBS SHALL BE BACK FILLED WITH A TOPSOIL / ORGANIC FERTILIZER MIXTURE

3. NECESSARY TREES SHALL BE STAKED WITH 4' METAL "T" POSTS. TREES SHALL BE GUYED WITH 12 GAUGE GALVANIZED WIRE AND POLYPROPYLENE TREE RACE STRIPS. 4. PERENNIAL PLANTING BEDS SHALL BE TILLED 6" DEEP AND AMENDED WITH TOPSOIL AND ORGANIC FERTILIZER AT A 2:1 RATIO.

5. SEE PLANTING DETAILS FOR ALL DECIDUOUS AND EVERGREEN TREES.

6. MULCH ALL PERENNIAL BEDS WITH LAVA ROCK.

7. ALL PLANT MATERIAL TO MEET THE AMERICAN STANDARD FOR NURSERY STOCK. 8. LANDSCAPING AND TREE REMOVAL SHALL BE IN ACCORDANCE WITH CDC 17.5.9, LANDSCAPE REGULATIONS AND CDC 17.6.1 ENVIRONMENTAL REGULATIONS.

1ST EACH SPRING.

9. ALL PLANTED MATERIALS, INCLUDING SEEDS, SHALL BE NON NOXIOUS SPECIES AS SPECIFIED IN THE NOXIOUS WEED CDC TABLE 5-5 OR SUBSEQUENTLY DESIGNATED AS A NOXIOUS WEED BY THE STATE OF COLORADO, OR THE TOWN.

LANDSCAPE MAINTENANCE NOTES:

10. TURF SHALL BE AERATED 2 TO 3 TIMES PER YEAR TO INCREASE THE WATER ABSORPTION RATE. NECESSARY ORGANIC FERTILIZATION AND AMENDMENT SHALL BE INCORPORATED AT THE SAME

11. NECESSARY ORGANIC FERTILIZERS AND AMENDMENT SHALL BE ADDED TO PERENNIAL BEDS SEASONALLY ALONG WITH MULCH. 12. ALL SHRUBS IN THE SNOW SHED AREAS TO BE CUT BACK IN FALL TO 12"-18" IN HEIGHT. 13. IRRIGATION SYSTEM TO BE BLOWN OUT BY OCTOBER 31ST EACH FALL AND TURNED ON BY JUNE

TREE PROTECTION / REMOVAL NOTES

. TREE PROTECTION FENCING IS REQUIRED BY THE CEC TO BE INSTALLED AT OR BEYOND THE CROWN DRIPLINE OF EACH TREE THAT WILL REMAIN (TREE PROTECTION ZONE) IN ACCORDANCE WITH CDC: 17.6.1.

2. TREE PROTECTION FENCING MUST BE INSTALLED AND APPROVED BY THE TOWN FORESTER BEFORE EXCAVATION MAY BEGIN.

3. TOWN FORESTER MUST BE CONTACTED BEFORE EXCAVATION BEGINS TO MARK OR APPROVE THE TREES TO BE REMOVED AND TO APPROVE THE PLACEMENT OF THE TREE PROTECTION FENCING. A TREE REMOVAL PERMIT MUST BE OBTAINED FROM THE TOWN FORESTER BEFORE TREE REMOVAL OPERATION MAY BEGIN.

4. NO BACKFILL, STORAGE, OR STAGIN IS PERMITTED INSIDE THE TREE PROTECTION AREA INSIDE THE TREE PROTECTION FENCING.

TREE PLANTING NOTES

1. TREE PLANTING SHALL ADHERE TO CDC 17.5.9.

2. TREES AND SHRUBS SHALL BE MULCHED UPON INITIAL PLANTING AND AS NEEDED TO REUCE WATER EVAPORATION

3. TREES AND SHRUB HOLES SHALL BE DUG SIX INCHES (6") DEEPER THAN THE ROOT BALL SIZE TO FACILITATE THE PLACEMENT OF APPROPRIATE MULCH MATERIAL AND FACILITATE GROWTH. 4. TREES SHALL BE STAKED AND HELD IN PLACE BY WEBBING AND WIRE TO ENSURE SUCCESSFUL ROOT ESTABLISHMENT FOR A PERIOD OF TWO (2) FULL GROWING SEASONS. 5. BURLAP AND WIRE SHALL BE REMOVED FOM THE ROOT BALL AS PART OF INSTALLATION. IF THE WIRE CANNOT BE REMOVED DUE TO THE SIZE OF THE TREE, THEN TWO-THIRDS OF THE WIRE SHALL BE REMOVED FROM THE UPPER PORTION OF THE ROOT BALL. ENUSRE ALL WIRE / TWINE IS REMOVED FROM AROUND THE TRUNK.

PLANT SCHEDULE		
BOTANICAL NAME	COMMON NAME	SIZE
PICEA ENGELMANNII	ENGLEMANN SPRUCE (ES)	8-10 FT IN HT W/ 30% 10 FT OR LARGER
PSEUDOTSUGA MENZIESII	DOUGLAS FIR (DF)	8-10 FT IN HT W/ 30% 10 FT OR LARGER
POPULUS TREMULOIDES	ASPEN (AS)	2 IN CALLIPER W 3 IN OR LARC
ACER GINNALA	AMUR MAPLE (AM)	3-4 FT IN H 4-5 FT IN H
PRUNUS VIRGINIANA	CHOKE CHERRY (CC)	4-5 FT IN HT W/ 30% 5-6 FT IN HT

REVEGETATION NOTES

SUBSOIL SURFACE SHALL BE TILLED TO A 4" DEPTH ON NON FILL AREAS 2. BROADCASTING OF SEED SHALL BE DONE IMMEDIATELY AFTER TOPSOIL IS APPLIED (WITHIN 10 DAYS) TO MINIMIZE EROSION AND WEEDS. 3. AREAS WHICH HAVE BEEN COMPACTED OR ARE RELATIVELY UNDISTURBED NEEDING SEEDING

SHALL BE SCARIFIED BEFORE BROADCASTING OF SEED. 4. BROADCASTING WITH SPECIFIED SEED MEX AND FOLLOW WITH DRY MULCHING, STRAW OR HAY

SHALL BE UNIFORMLY APPLIED OVER SEEDED AREA AT A RATE OF 1.5 TONS PER ACRE FOR HAY OR 2 TONS PER ACRE FRO STRAW, CRIMP IN.

5. ON SLOPES GREATER THAN 3:1 EROSION CONTROL BLANKET SHALL BE APPLIED IN PLACE OF STRAW MULCH AND PINNED.

6. ALL UTILITY CUTS SHALL BE REVEGETATED WITHIN TWO WEEKS AFTER INSTALLATION OF UTILITIES TO PREVENT WEED INFESTATION.

7. SEED ALL AREAS LABLED NATIVE GRASS SEED WITH THE FOLLOWING MIXTURE AT A RATE OF 12 LBS. PER ACRE. 8. REVEGETATION WILL REQUIRE 12" OF EXISTING TOP SOIL TO BE REMOVED AND STORED UNTIL

REVEGETATION HAPPENS. 9. TOPSOIL SPECIFICATION: REPLACE WITH ORIGINAL EXCAVATED FROM THE SITE AND SUPPLEMENT WITH LOCAL NATIVE TOPSOIL. TOPSOIL WILL CONTAIN 5-8% ORGANIC MATTER WHICH SHALL BE MIXED IN DURING THE RESTORATION PROCESS (THE ORGANIC MATTER SHOULD BE DERIVED FROM

DISEASE AND HERBICIDE FREE PARTIALLY DECOMPOSED, CURED WOOD CHIPS). 10. REVEGETATION WILL BE BROUGHT BACK TO ORIGINAL GRADE.

NATIVE GRASS SEED MIX:

I NATIVE GRASS SEED MIX.	
SPECIES	PURE LIVE SEED PER ACRE
WESTERN YARROW	5%
TALL FESCUE	10%
ARIZONA FESCUE	5%
HARD FESCUE	5%
CREEPING RED FESCUE	10%
ALPINE BLUEGRASS	15%
CANADA BLUEGRASS	10%
PERENNIAL RYEGRASS	15%
SLENDER WHEATGRASS	10%
MOLINITAINI BROME	15%


LANDSCAPE LEGEND EXISTING TREE TO REMAIN TREE PROTECTION FENCING EXISTING TREE TO BE REMOVED PROPOSED CONIFEROUS TREE PROPOSED DECIDUOUS TREE PERENNIAL BED (SHRUBS) AREA TO BE REVEGETATED (NATIVE SEED MIX)




ASPEN | BASALT | COLORADO

P:970.948.9510

KA-DESIGNWORKS.COM

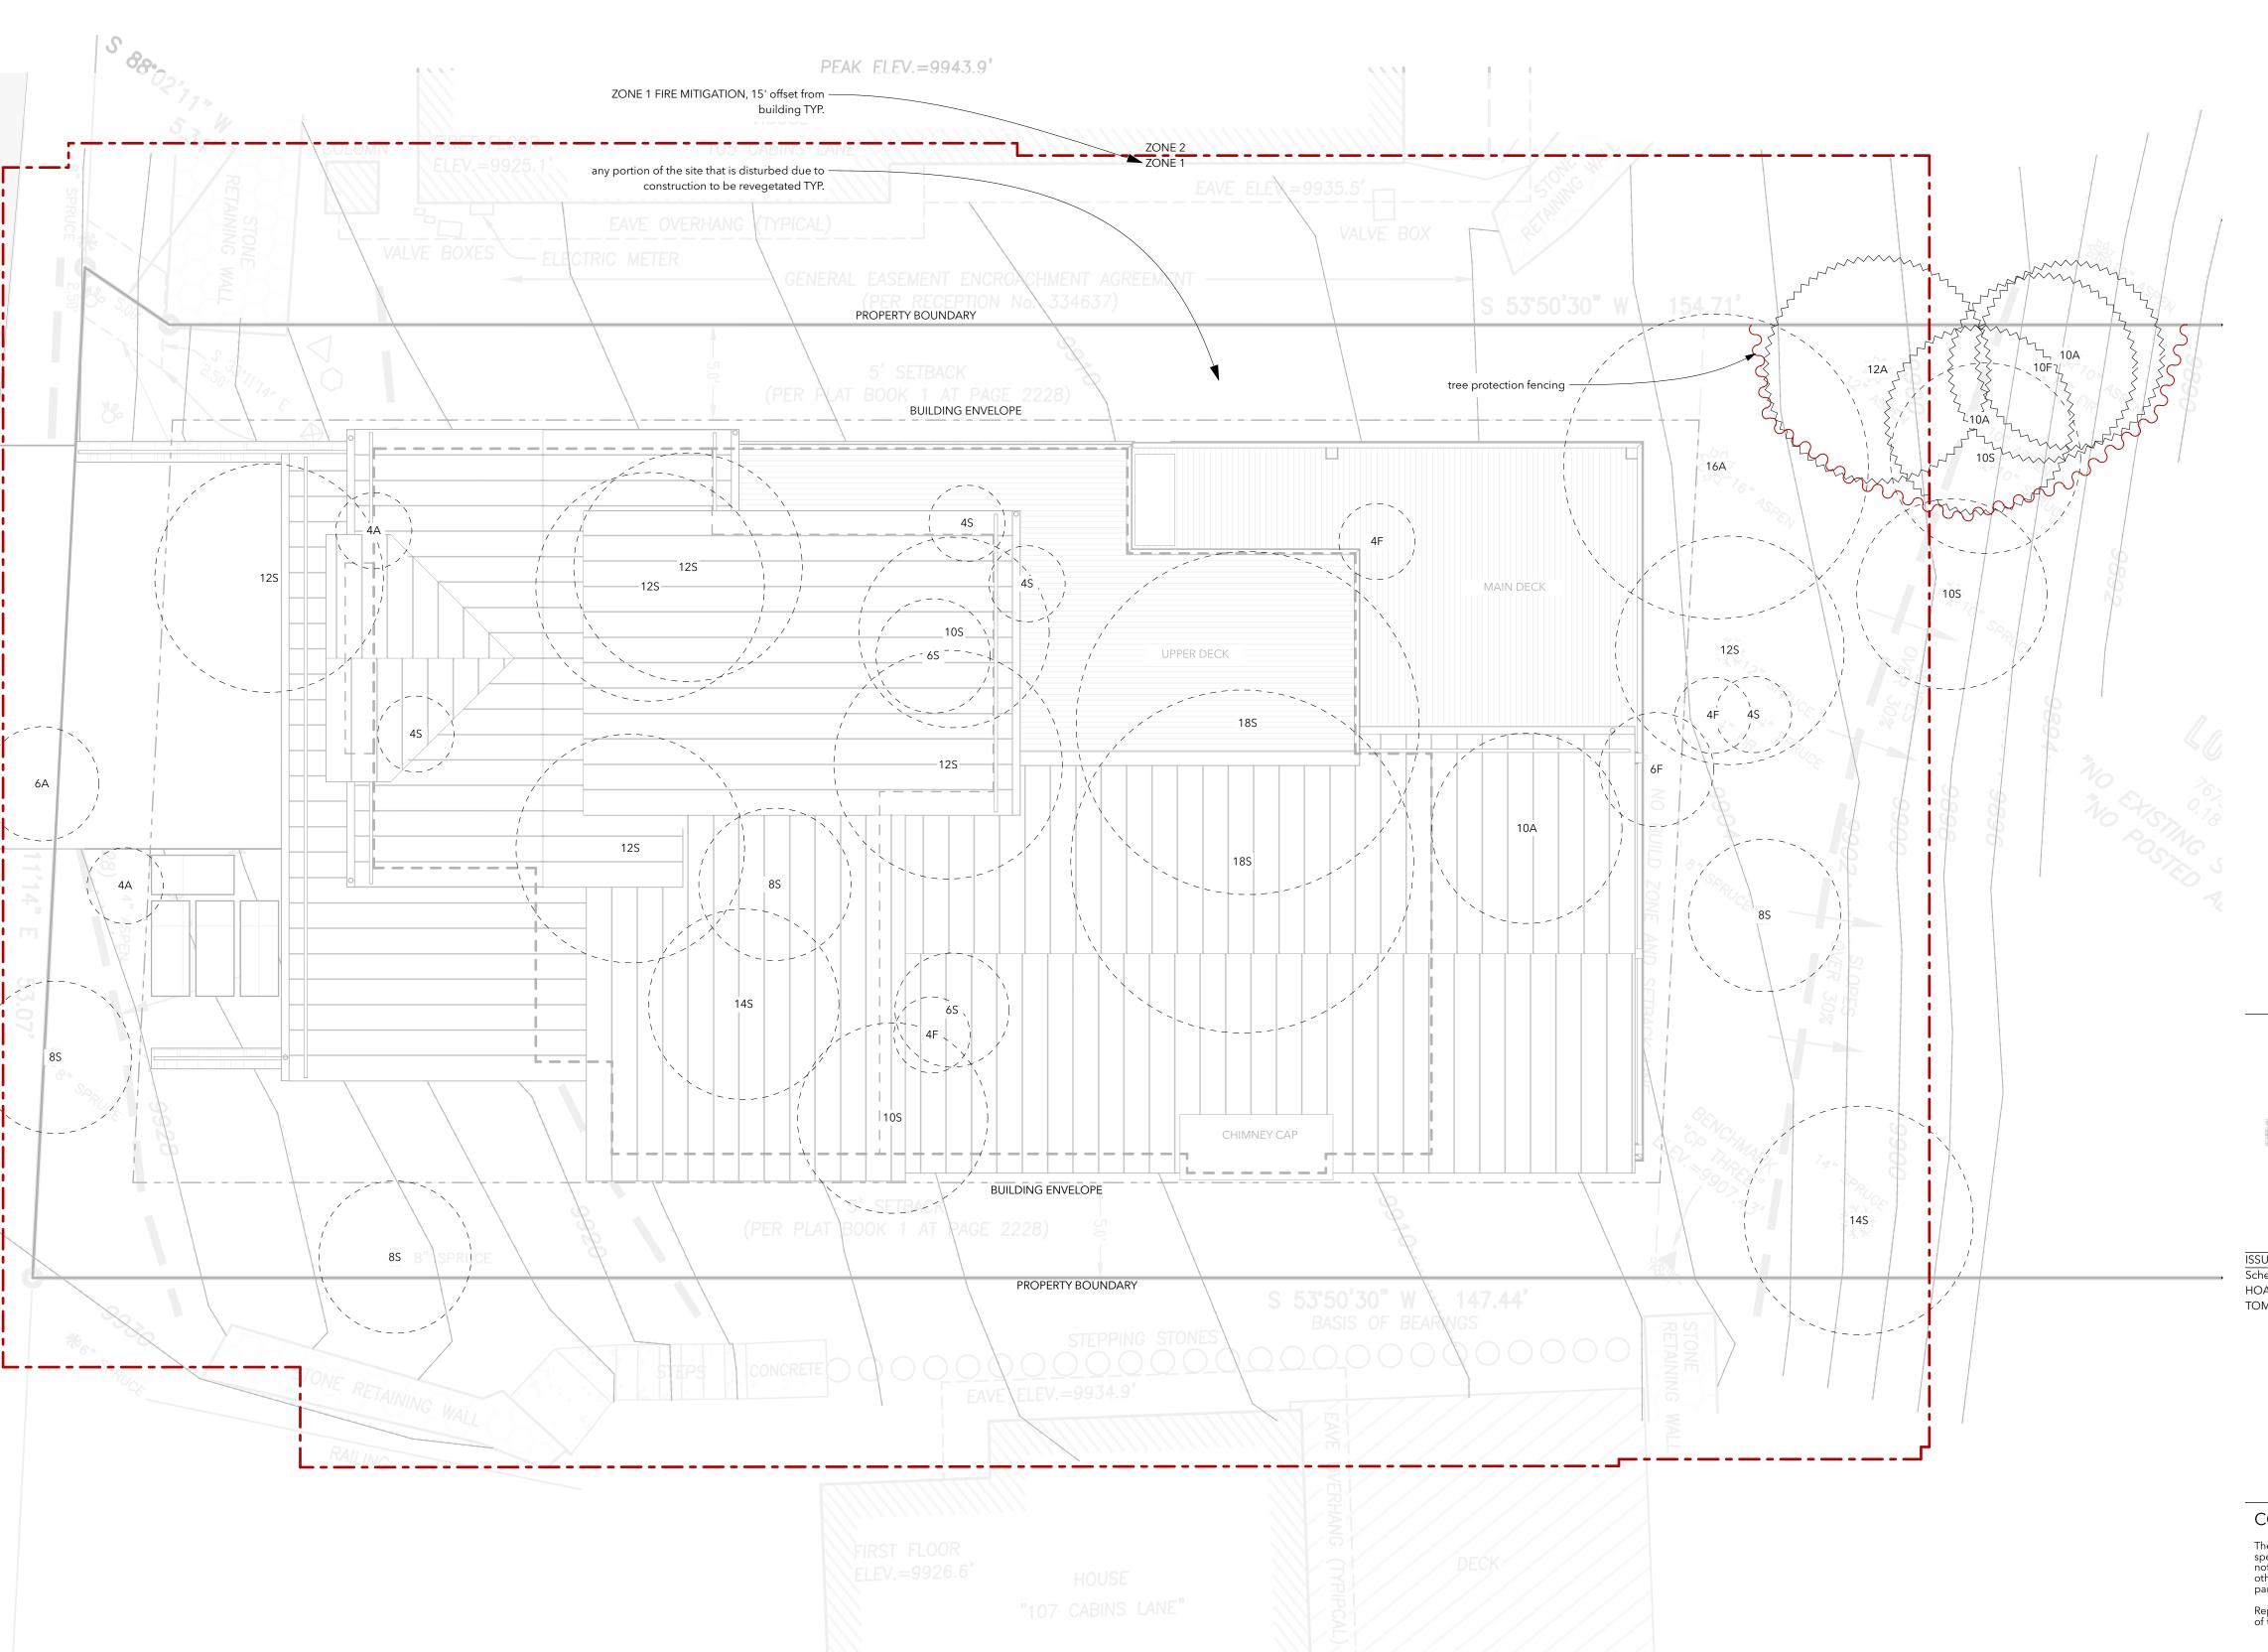

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Schematic Design HOA Prelim #2 **TOMV** Initial

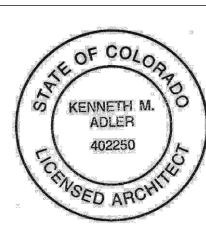CONSTRUCTION

09.11.24

11.08.24

03.06.25

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SHEET TITLE

LANDSCAPE

LANDSCAPE

GENERAL CIVIL ENGINEERING NOTES:

1. THE EXISTING UTILITY LINES SHOWN ON THE PLANS ARE APPROXIMATE. AT LEAST TWO (2) FULL WORKING DAYS PRIOR TO TO COMMENCING CONSTRUCTION, THE CONTRACTOR SHALL CONTACT THE UTILITY NOTIFICATION CENTER OF COLORADO @ 1-800-922-1987 OR 811 TO GET ALL UTILITIES LOCATED. IF ANY OF THESE UNDERGROUND UTILITIES ARE IN CONFLICT WITH THE CONSTRUCTION PLANS, THE CONTRACTOR SHALL NOTIFY THE ENGINEER AND WORK WITH THE ENGINEER TO FIND A SOLUTION BEFORE THE START OF CONSTRUCTION.

INSTALLATION AND SEPARATION REQUIREMENTS SHALL BE COORDINATED WITH THE INDIVIDUAL UTILITY PROVIDERS.

THE UTILITY PROVIDERS ARE:
SEWER AND WATER: TOWN OF MOUNTAIN VILLAGE
NATURAL GAS: BLACK HILLS ENERGY
POWER: SAN MIGUEL POWER
TELEPHONE: CENTURY LINK
BROADBAND: CLEARNETWORX

2. PRIOR TO BEGINNING ANY CONSTRUCTION ACTIVITIES, ALL NECESSARY PERMITS SHALL BE OBTAINED BY THE OWNER OR CONTRACTOR.

3. IT IS THE CONTRACTOR'S RESPONSIBILITY TO INSURE THAT EXCAVATED SLOPES ARE SAFE AND COMPLY WITH OSHA REQUIRIEMENTS. REFER TO THE SITE—SPECIFIC REPORT FOR THIS PROJECT FOR ADDITIONAL INFORMATION.

4. ALL TRENCHES SHALL BE ADEQUATELY SUPPORTED OR LAID BACK PER OSHA REGULATIONS.

5. ALL MATERIALS AND CONSTRUCTION SHALL BE IN CONFORMANCE WITH THE TOWN OF MOUNTAIN VILLAGE DESIGN STANDARDS LATEST EDITION. ALL CONSTRUCTION WITHIN EXISTING STREET OR ALLEY RIGHT—OF—WAY SHALL BE SUBJECT TO TOWN OF MOUNTAIN VILLAGE INSPECTION.

6. THE CONTRACTOR SHALL HAVE ONE COPY OF THE STAMPED PLANS ON THE JOB SITE AT ALL TIMES.

7. THE CONTRACTOR SHALL NOTIFY THE TOWN 48 HOURS PRIOR TO THE START OF CONSTRUCTION.

8. THE CONTRACTOR IS RESPONSIBLE FOR IMPLEMENTING AND MAINTAINING EROSION AND SEDIMENT CONTROL MEASURES AT ALL TIMES DURING CONSTRUCTION. THE ADJOINING ROADWAYS SHALL BE FREE OF DEBRIS AT THE END OF CONSTRUCTION ACTIVITIES EACH DAY.

9. THE CONTRACTOR SHALL PROVIDE, ERECT AND MAINTAIN PROPER TRAFFIC CONTROL DEVICES UNTIL THE SITE IS OPEN TO TRAFFIC. ANY TRAFFIC CLOSURES MUST BE COORDINATED WITH THE TOWN OF MOUNTAIN VILLAGE.

10. ALL DAMAGE TO PUBLIC STREETS AND ROADS, INCLUDING HAUL ROUTES, TRAILS, OR STREET IMPROVEMENTS, OR TO PRIVATE PROPERTY, SHALL BE REPAIRED AT THE SOLE EXPENSE OF THE CONTRACTOR TO THE ORIGINAL CONDITIONS.

11. WHEN AN EXISTING ASPHALT STREET IS CUT, THE STREET MUST BE RESTORED TO A CONDITION EQUAL TO OR BETTER THAN ITS ORIGINAL CONDITION. THE FINISHED PATCH SHALL BLEND SMOOTHLY INTO THE EXISTING SURFACE. ALL LARGE PATCHES SHALL BE PAVED WITH AN ASPHALT LAY—DOWN MACHINE.

12. IF DEWATERING IS REQUIRED, THE CONTRACTOR SHALL NOTIFY THE ENGINEER. ANY DISCHARGE REQUIREMENTS SHALL BE COORDINATED WITH THE TOWN OF MOUNTAIN VILLAGE.

13. CONTRACTOR SHALL NOTIFY ALL RESIDENTS IN WRITING 24 HOURS PRIOR TO ANY SHUT-OFF IN SERVICE. THE NOTICES MUST HAVE CONTRACTOR'S PHONE NUMBER AND NAME OF CONTACT PERSON, AND EMERGENCY PHONE NUMBER FOR AFTER HOURS CALLS. ALL SHUT-OFF'S MUST BE APPROVED BY THE TOWN AND TOWN VALVES AND APPURTENANCES SHALL BE OPERATED BY TOWN PERSONNEL.

14. CONTRACTOR SHALL KEEP SITE CLEAN AND LITTER FREE (INCLUDING CIGARETTE BUTTS) BY PROVIDING A CONSTRUCTION DEBRIS TRASH CONTAINER AND A BEAR-PROOF POLY-CART TRASH CONTAINER, WHICH IS TO BE LOCKED AT ALL TIMES.

15. CONTRACTOR MUST BE AWARE OF ALL TREES TO REMAIN PER THE DESIGN AND APPROVAL PROCESS AND PROTECT THEM ACCORDINGLY.

16. THE CONTRACTOR SHALL PROVIDE UNDERGROUND UTILITY AS-BUILTS TO THE TOWN.

17. ALL STRUCTURAL FILL UNDER HARDSCAPE OR ROADS MUST BE COMPACTED TO 95% MODIFIED PROCTOR (MIN.) AT PLUS OR MINUS 2% OF THE OPTIMUM MOISTURE CONTENT. NON—STRUCTURAL FILL SHALL BE PLACED AT 90% (MIN.) MODIFIED PROCTOR.

18. UNSUITABLE MATERIAL SHALL BE REMOVED AS REQUIRED BY THE SOILS ENGINEER. ALL MATERIALS SUCH AS LUMBER, LOGS, BRUSH, TOPSOIL OR ORGANIC MATERIALS OR RUBBISH SHALL BE REMOVED FROM ALL AREAS TO RECEIVE COMPACTED FILL.

19. NO MATERIAL SHALL BE COMPACTED WHEN FROZEN.

20. NATIVE TOPSOIL SHALL BE STOCKPILED TO THE EXTENT FEASIBLE ON THE SITE FOR USE ON AREAS TO BE REVEGETATED.

21. THE CONTRACTOR SHALL BE RESPONSIBLE FOR DUST ABATEMENT AND EROSION CONTROL MEASURES DEEMED NECESSARY BY THE TOWN, IF CONDITIONS WARRANT THEM.


22. ALL DISTURBED GROUND SHALL BE RE-SEEDED WITH A TOWN-APPROVED SEED MIX. REFER TO THE LANDSCAPE PLAN.

23. THE CONTRACTOR IS REQUIRED TO PROTECT ALL EXISTING SURVEY MONUMENTS AND PROPERTY CORNERS DURING GRADING AND CONSTRUCTION.

24. ALL UNDERGROUND PIPE SHALL BE PROTECTED WITH BEDDING TO PROTECT THE PIPE FROM BEING DAMAGED.

25. HOT TUBS SHALL DRAIN TO THE SANITARY SEWER (OR PUMPED TO AA CLEAN-OUT).

26. THE UTILITY PLAN DEPICTS FINAL UTILITY LOCATIONS BUT HAS BEEN COMPLETED AT A PRELIMINARY STAGE. CONTRACTOR SHALL VERIFY ALIGNMENTS WITH THE ARCHITECT PRIOR TO CONSTRUCTION.

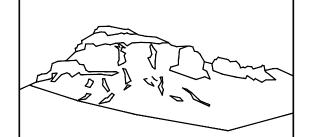

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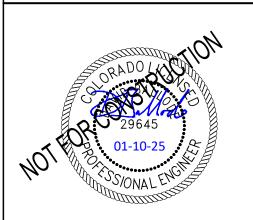
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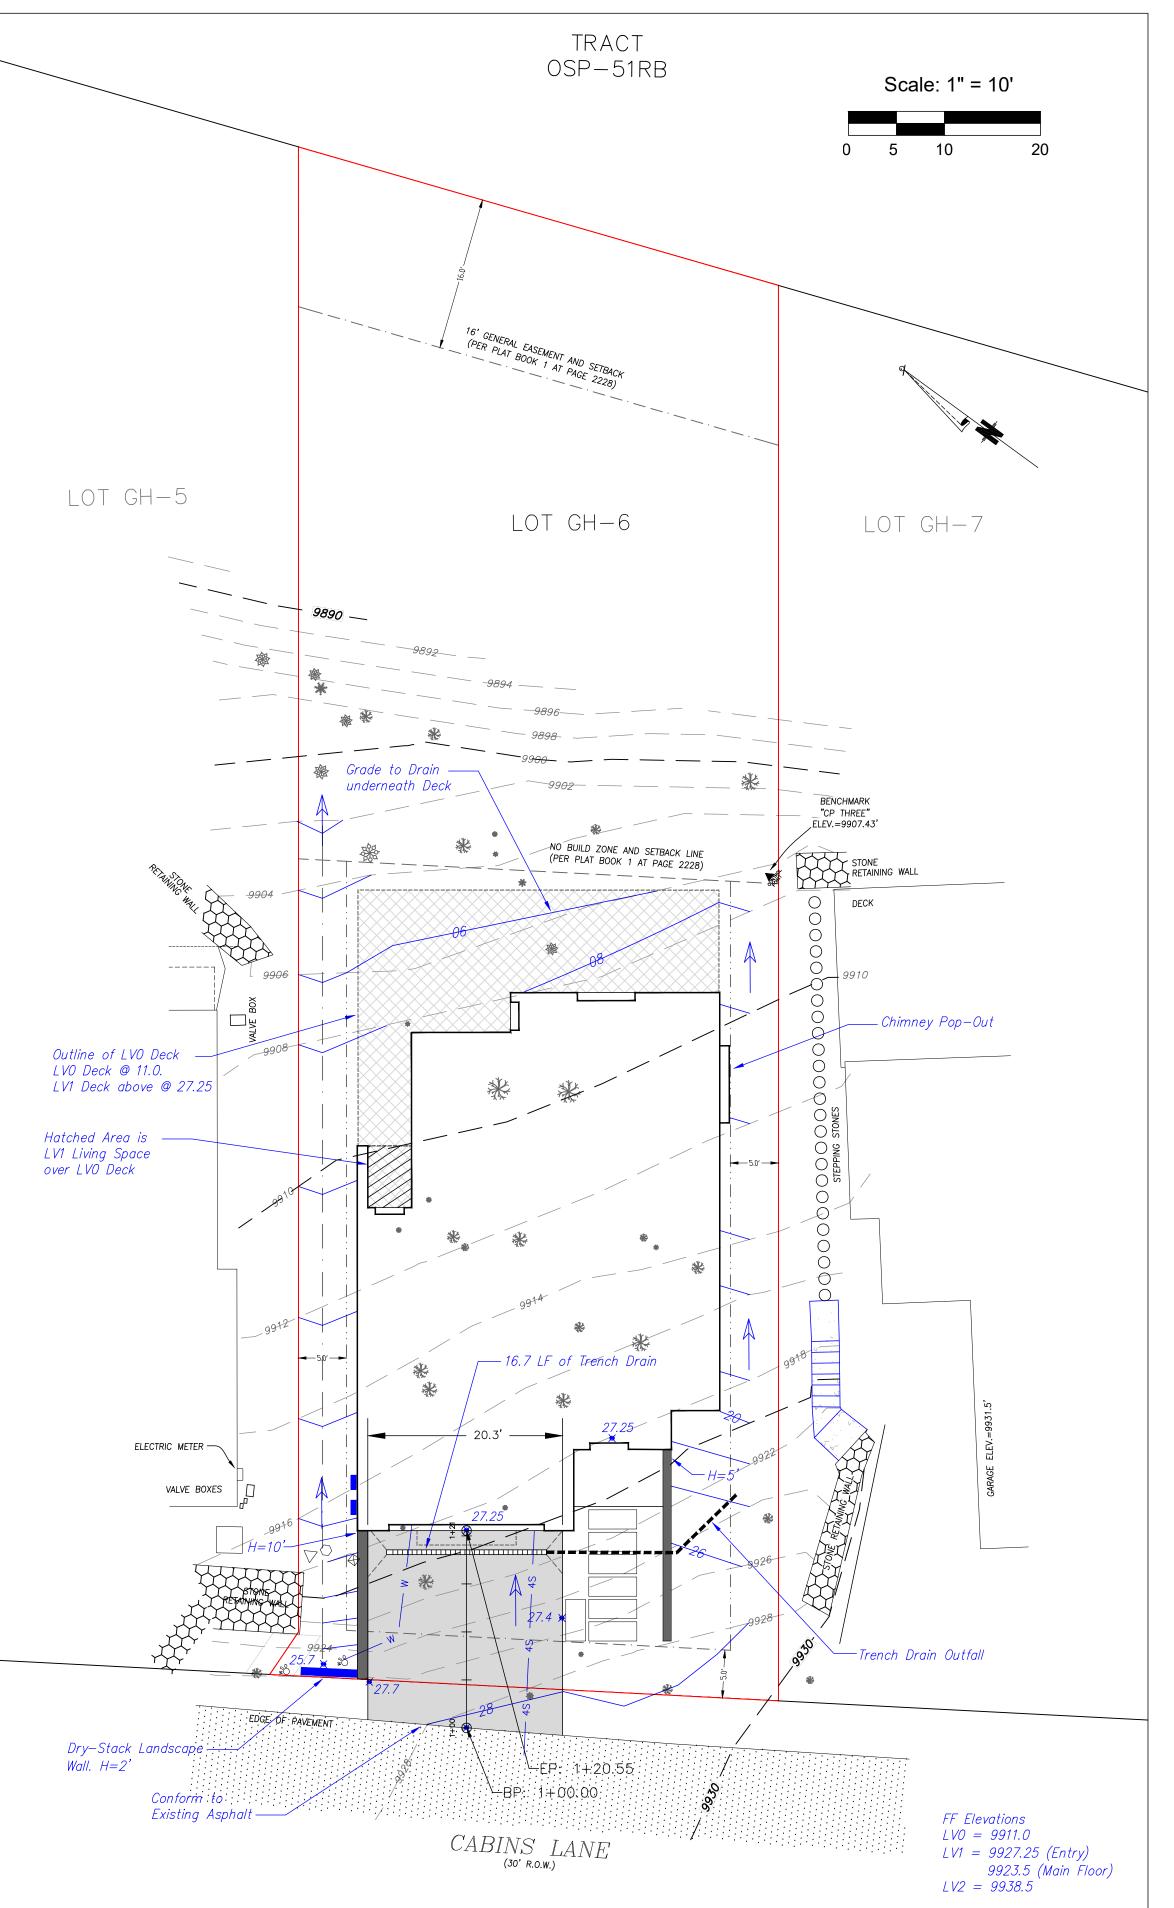
Unit 6 Gold Hill Mtn. Village, CO





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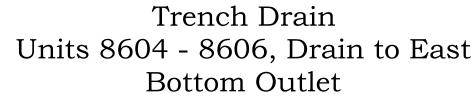
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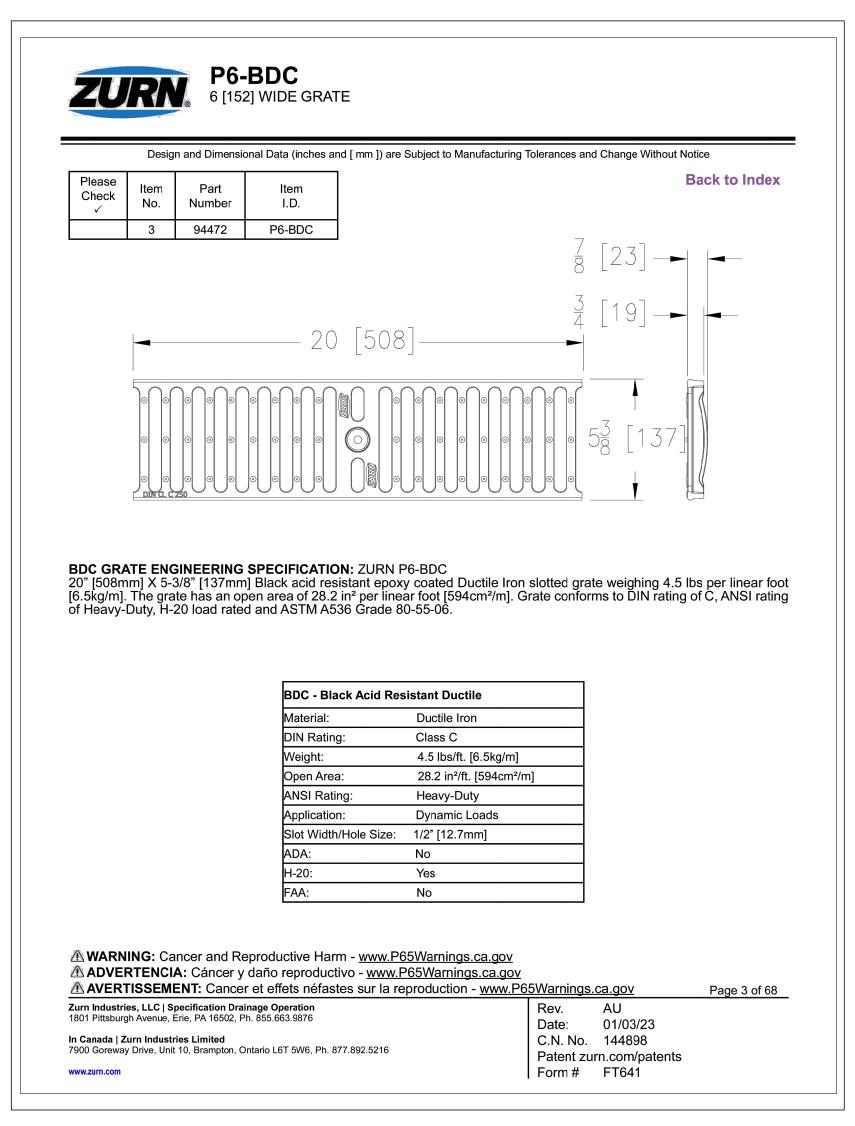
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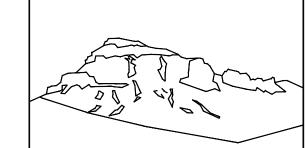






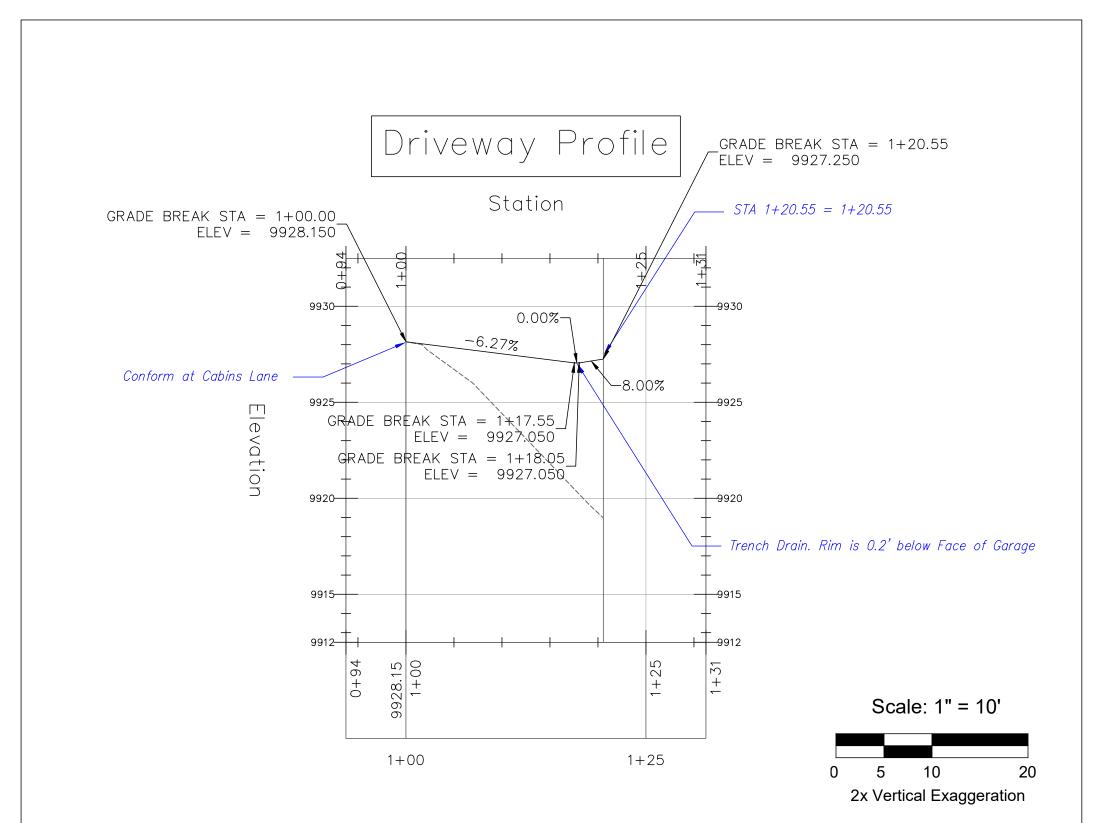

Trench Drain Grate

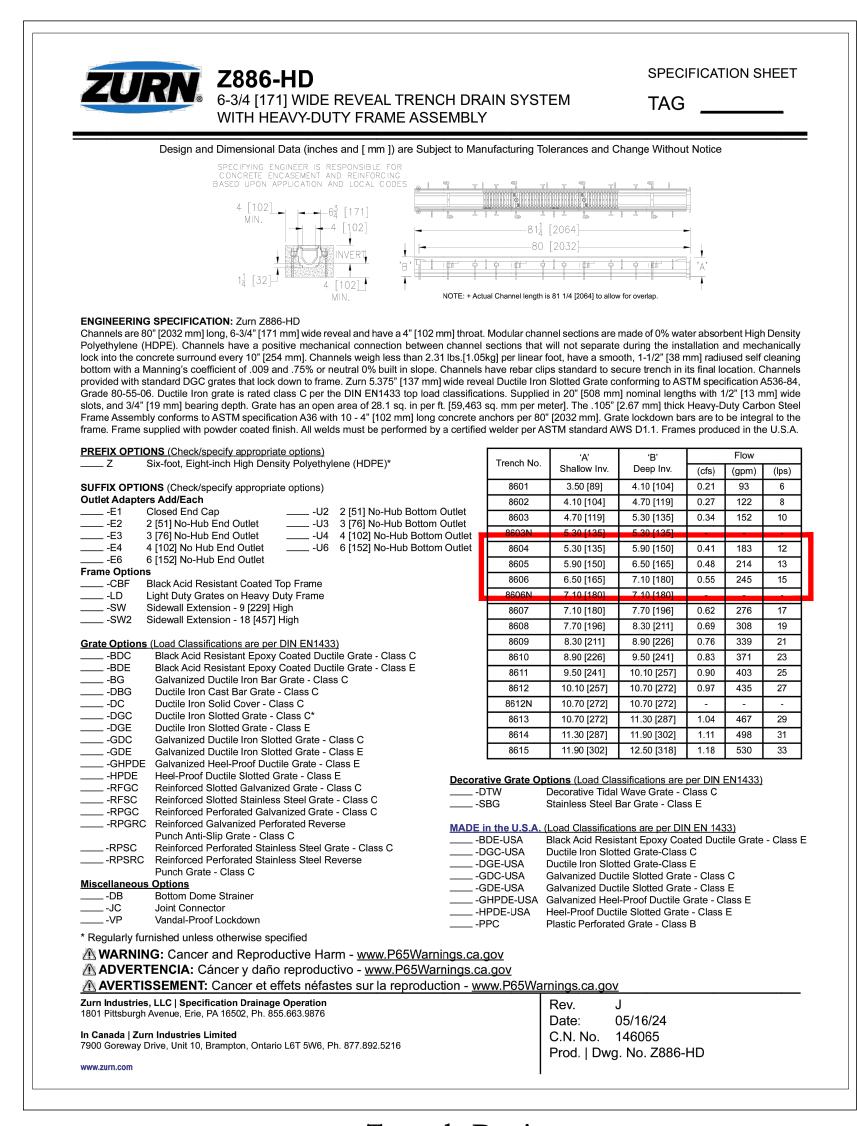

Uncompangre Engineering, LLC


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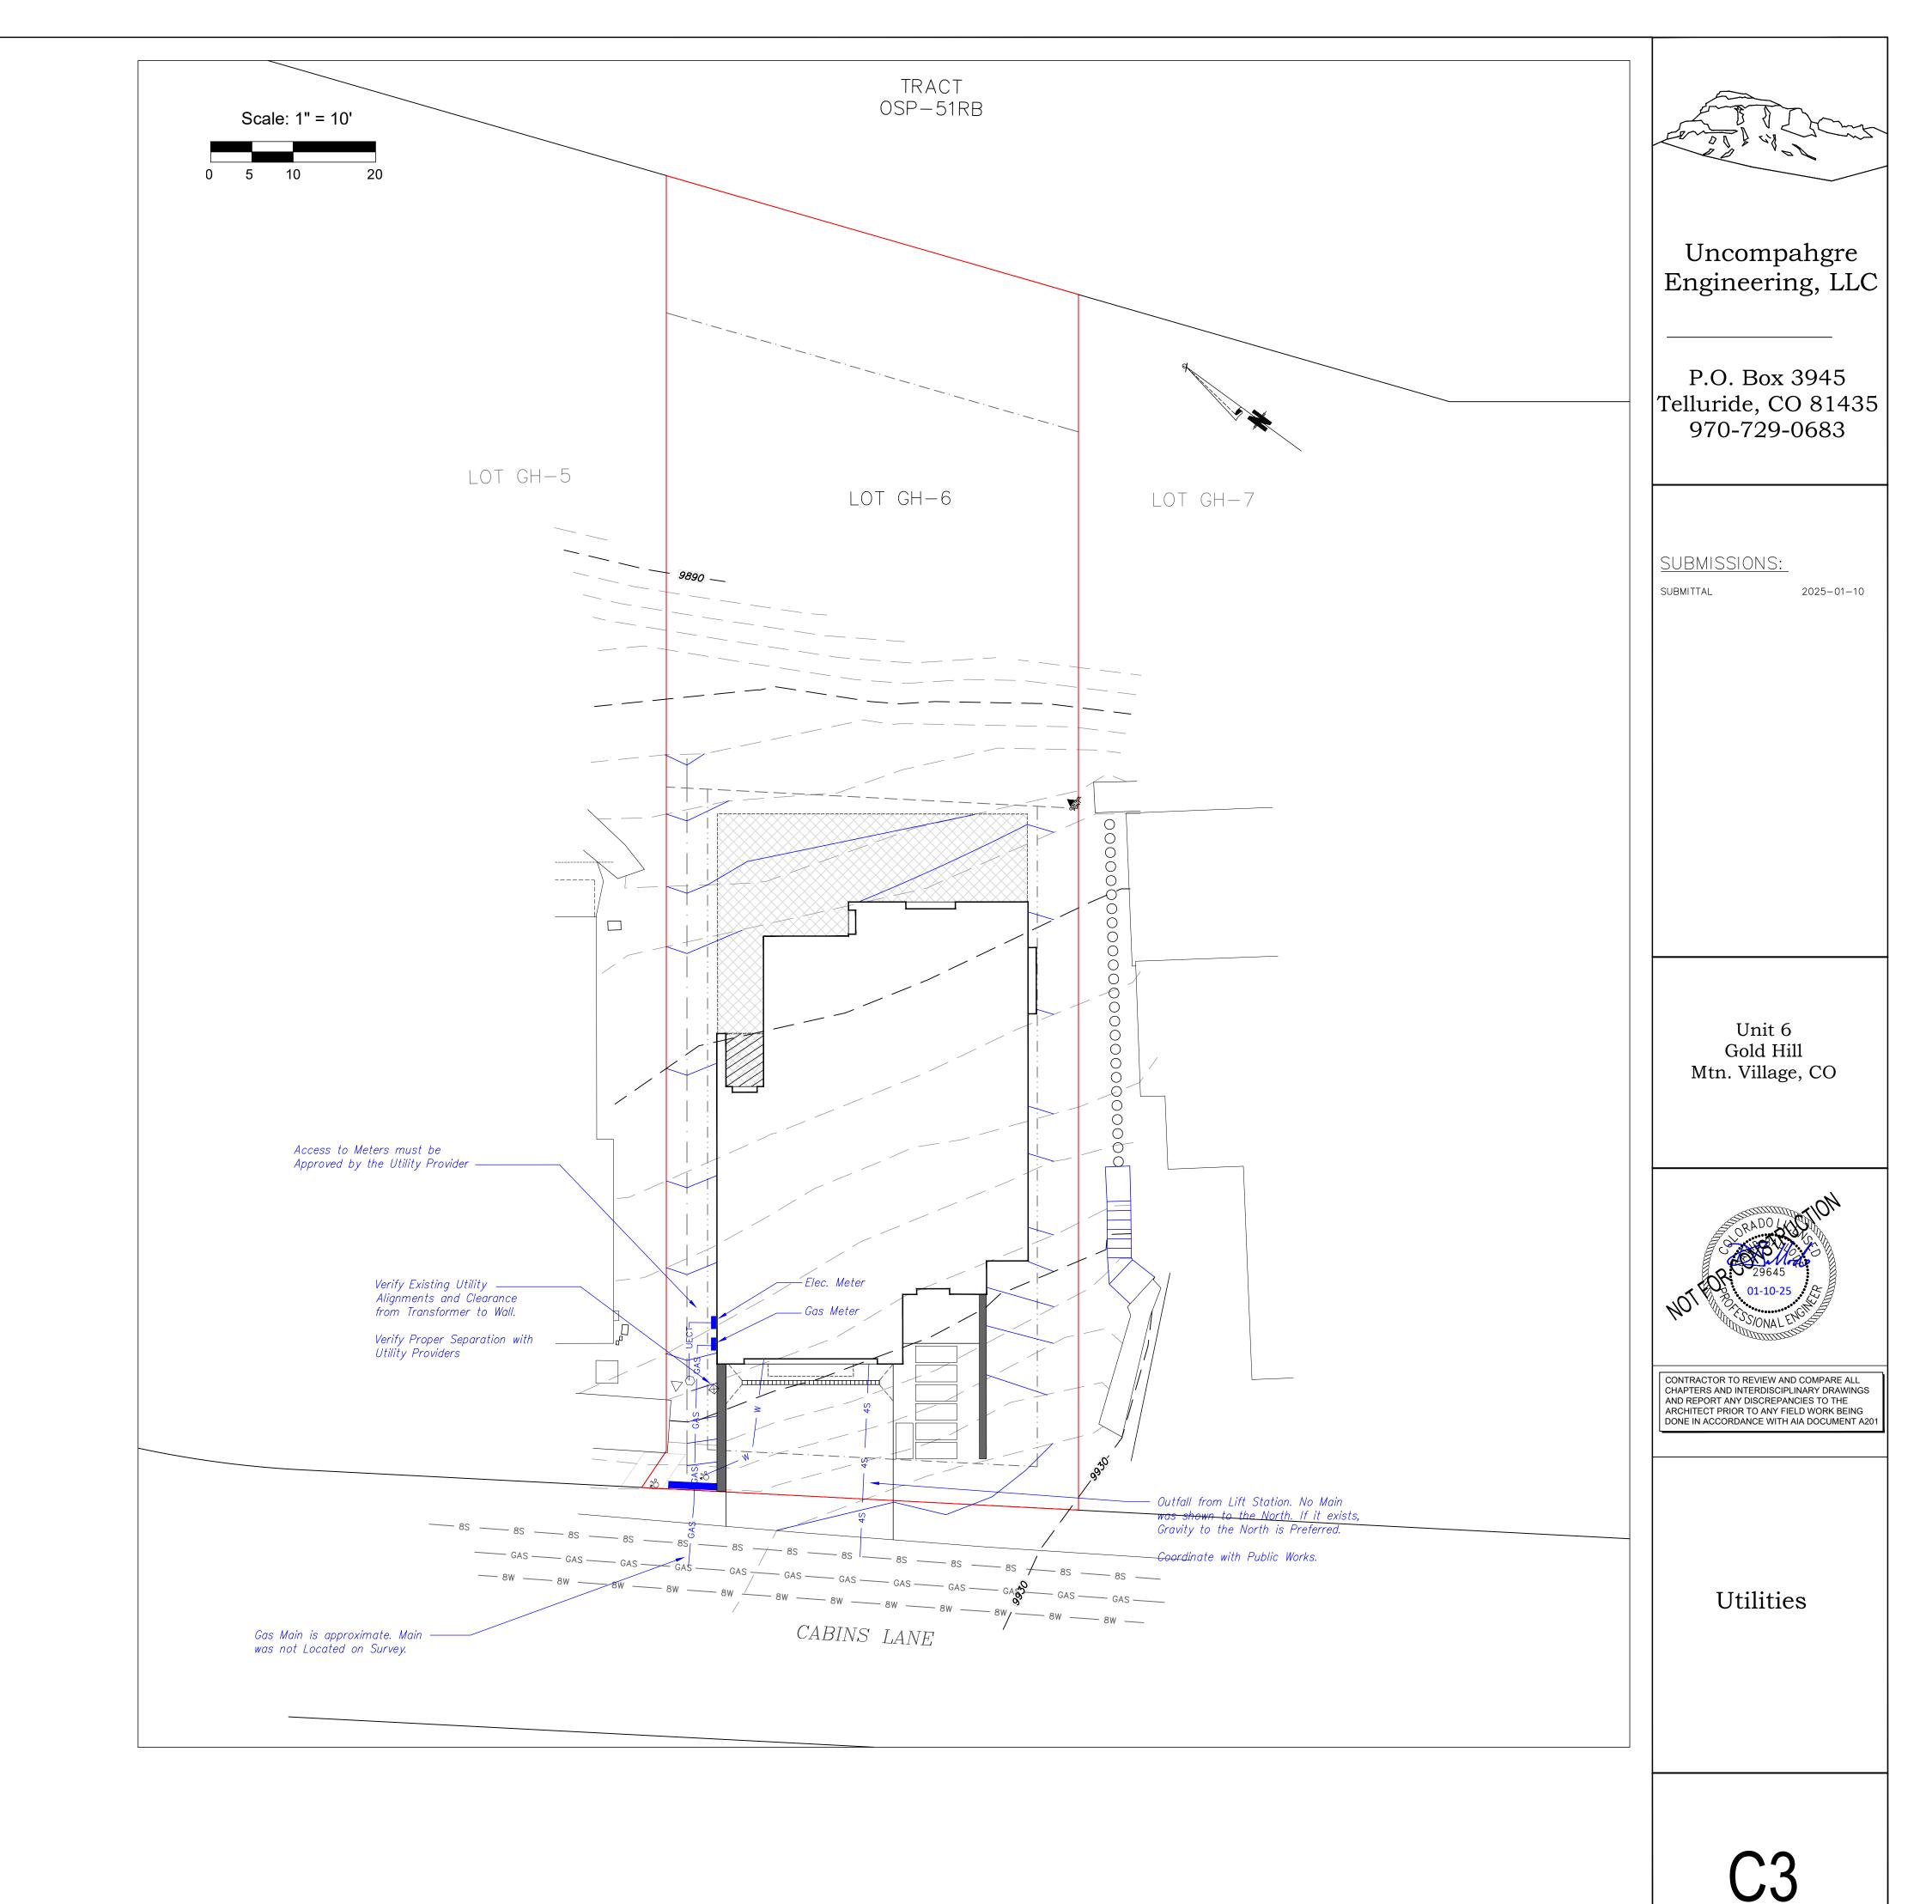
CONTRACTOR TO REVIEW AND COMPARE ALL
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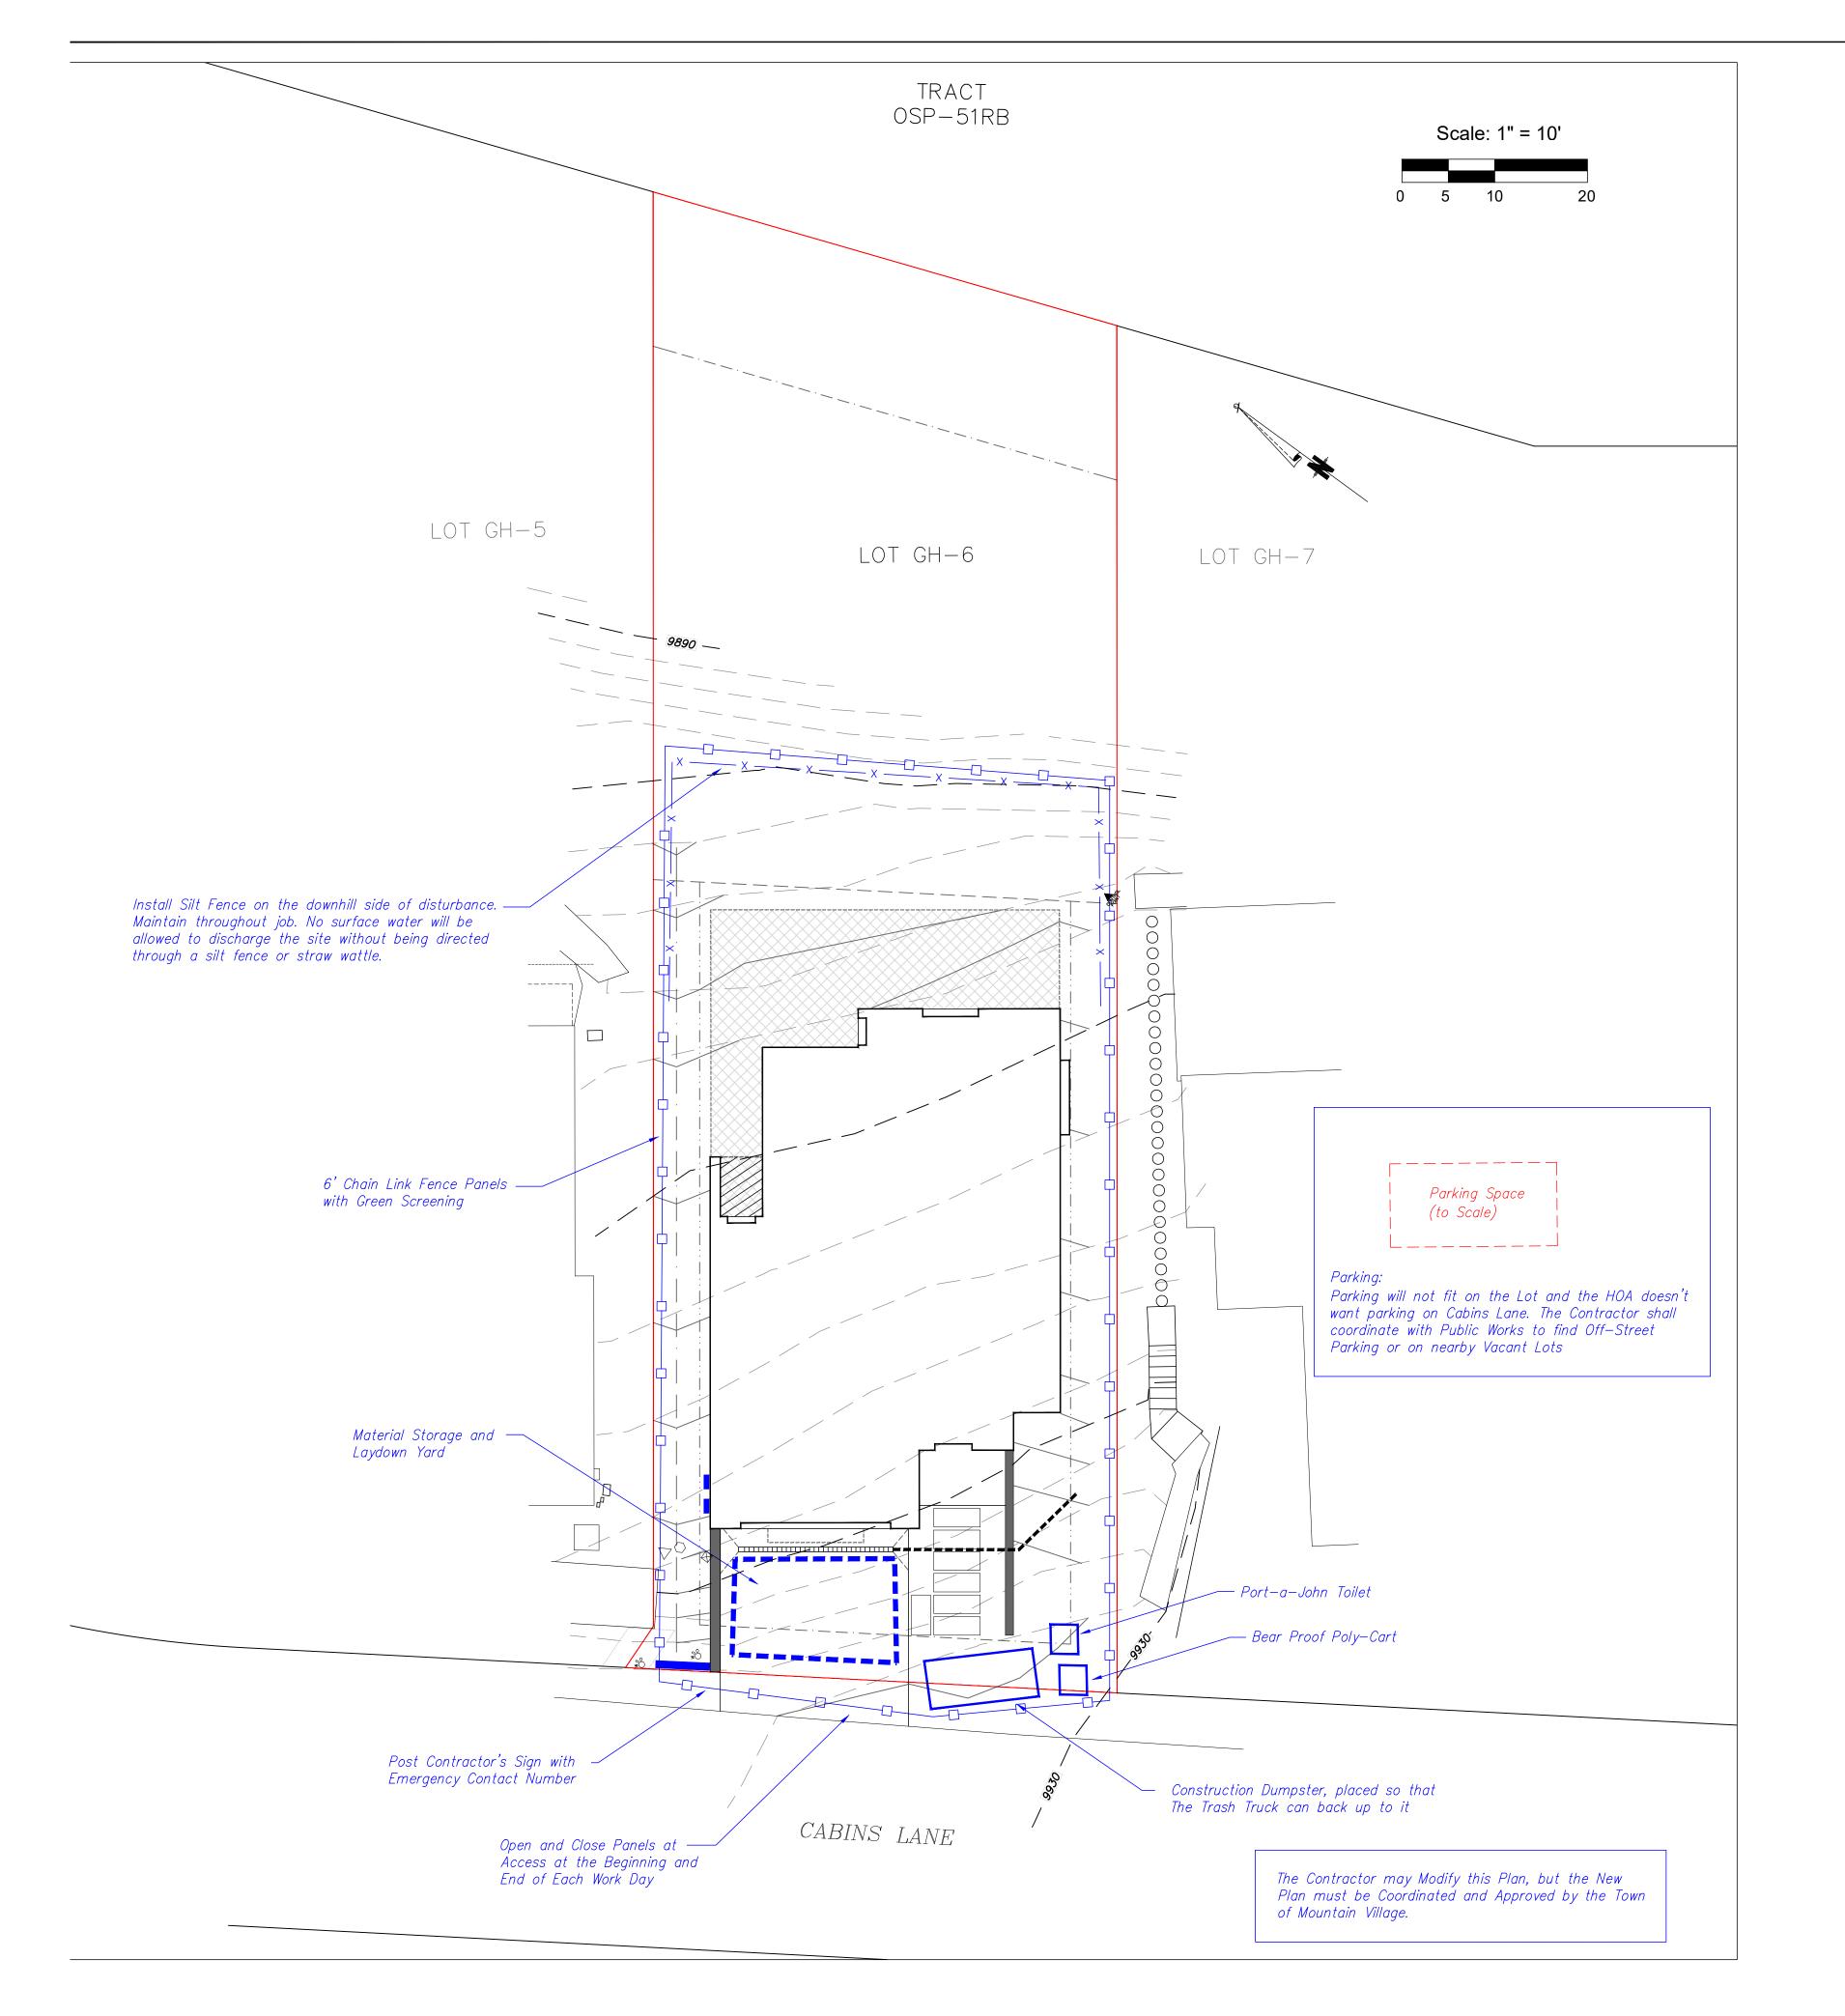
Grading and Drainage


Wildfire Mitigation Notes:

Wildfire Mitigation will be performed according to the Town of Mountain Village requirements, CDC Chapter 17.6. Zones 1, 2, and 3 are identified on the plan.

- D. The following requirements shall be followed in creating the required wildfire mitigation plan:
- i. Zone 1 is the area that consists of fifteen feet (15") around the building as measured from the outside edge of the building's dripline, including decks, planters or patios attached to the building. The following provisions shall apply in Zone 1:
- 1. (a) All slash and flammable vegetation as identified by staff shall be removed from Zone 1.
- 2. (b) All trees and shrubs located within Zone 1 shall be removed.
- 3. (c) The following exceptions apply to Zone 1:
- 1. (i.) A tree or shrub may remain within Zone 1 provided the defensible space distance is measured commencing from the vegetation's drip edge rather than from the building plane (so the tree is considered part of or an extension of the structure), and provided the distance is not limited by a lot line
- 2. (ii.) Flammable vegetation shall be allowed in planters attached to the building so long as the planter is within ten feet (10') of a building, and vegetation is not planted directly beneath windows or next to foundation vents.
- 4. (d) In the event Zone 1 encroaches upon the general easement, the review authority shall allow the creation of defensible space as required by this section.
- ii. Zone 2 is the area that extends from the outer edge of Zone 1 for the distance specified in Figure 6-1 (Sec. 17.6.1 of the CDC), Fire Mitigation Zones, based on slope, to the lot line, whichever is less.
- The following provisions shall apply in Zone 2:
 - (iii.) Dominant and co-dominant live trees with a dbh of four inches (4") or greater shall be spaced with a ten foot (10') crown-to- crown separation. All ladder fuels and slash shall be removed from the ten foot (10') crown-to-crown separation area.
 - 4. (iv.) All stressed, diseased, dead or dying trees and shrubs, as identified by staff, shall be removed except for standing dead trees that staff indicates need to be maintained since standing dead trees provide important wildlife habitat.
 - 5. (v.) Shrubs over five feet (5') tall shall have an average spacing of ten feet (10') from shrub-to-shrub.
- (A) The following exceptions apply to Zone 2:
 - 2. (i.) Groupings of trees or shrubs may be allowed provided that all of the crowns in such group of trees or the edge of the shrubs are spaced ten feet (10') from crown—to— crown or from edge of shrub to any trees or shrubs outside of such grouping.
 - 3. (ii.) Aspens, narrowleaf cottonwoods, willows and other trees and shrubs listed in CSU Cooperative Extension Publication 6.305, Firewise Plant Materials as amended from time to time, may be spaced closer than the ten foot (10') crown—to—crown separation as approved by staff.
 - 4. (iii.) Closer spacing of any trees may be allowed by staff upon a determination that the required ten foot (10') crown—to—crown spacing would put the remaining trees at undue risk of wind—throw or snow breakage.
 - 5. (iv.) Tree removal for the creation of defensible space, if such tree removal is determined to be impractical by the Town due to steep slopes, wetland or other environmental constraints, and other mitigation is provided.
 - 3. (c) Trees remaining within Zone 2 shall have branches pruned to a height of ten feet (10'), but notwithstanding said height requirement, branches need not be pruned to more than one—third (1/3) of the tree height with the following exceptions:
 - 1. (i.) Aspen trees; and
 - 2. (ii.) Isolated spruce and fir trees.
 - 4. (d) In the event that Zone 1 or 2 extends upon the general easement, the review authority shall allow the removal of trees to implement the wildfire mitigation plan.
 - 5. (e) Chipped wood and small timber may be spread throughout either Zone 2 or Zone 3 provided the wood chips have a maximum depth of two to three inches (2" 3") and small timber has a diameter of three inches (3") or less and is cut up into lengths that are three feet (3") or less.
- iii. Zone 3 is the area extending beyond Zone 2 to the edge of the lot subject to development. In Zone 3, all diseased, beetle infested, dead or dying trees, as identified by staff, shall be removed except for standing dead trees (aka tree snags) that staff indicates need to be maintained since standing dead trees provide important wildlife habitat.
- (a) For lots greater than five (5) acres in size, the Town shall only require that Zone 3 be implemented for a distance of 500 feet from the outside edge of Zone 2. A lot owner may propose to implement Zone 3 for all of the lot
- E. Firewood may only be stored on a lot that has a solid fuel burning device permit issued by the Town that meets the following limitations:
- i. Indoor storage can only occur within an enclosed room that is a part of the primary structure on the lot. ii. Outdoor storage shall only occur in the rear yard.
- iii. Up to ten (10) cubic feet of outdoor firewood storage may be located in Zone 1 or Zone 2.
- iv. Outdoor firewood storage larger than ten (10) cubic feet shall have a minimum thirty foot (30') distance from the structure.
- v. Outdoor firewood storage shall be screened from view from surrounding lots
- F. Prior to the issuance of any certificate of occupancy or certificated of completion, staff shall inspect the lot affected by the fire mitigation plan to ensure that such plan has been implemented in accordance with the approved wildfire mitigation plan.
- G. The wildfire mitigation plan shall be maintained by the lot owner as required by this section.



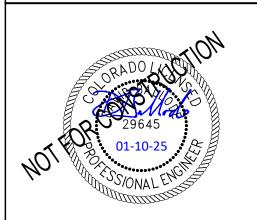

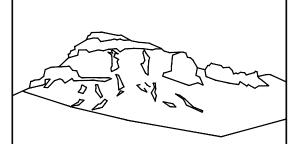

Uncompahgre Engineering, LLC

P.O. Box 3945 Telluride, CO 81435 970-729-0683

2025-01-10

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Unit 6 Gold Hill Mtn. Village, CO



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Construction Mitigation

Wildfire Mitigation Notes:


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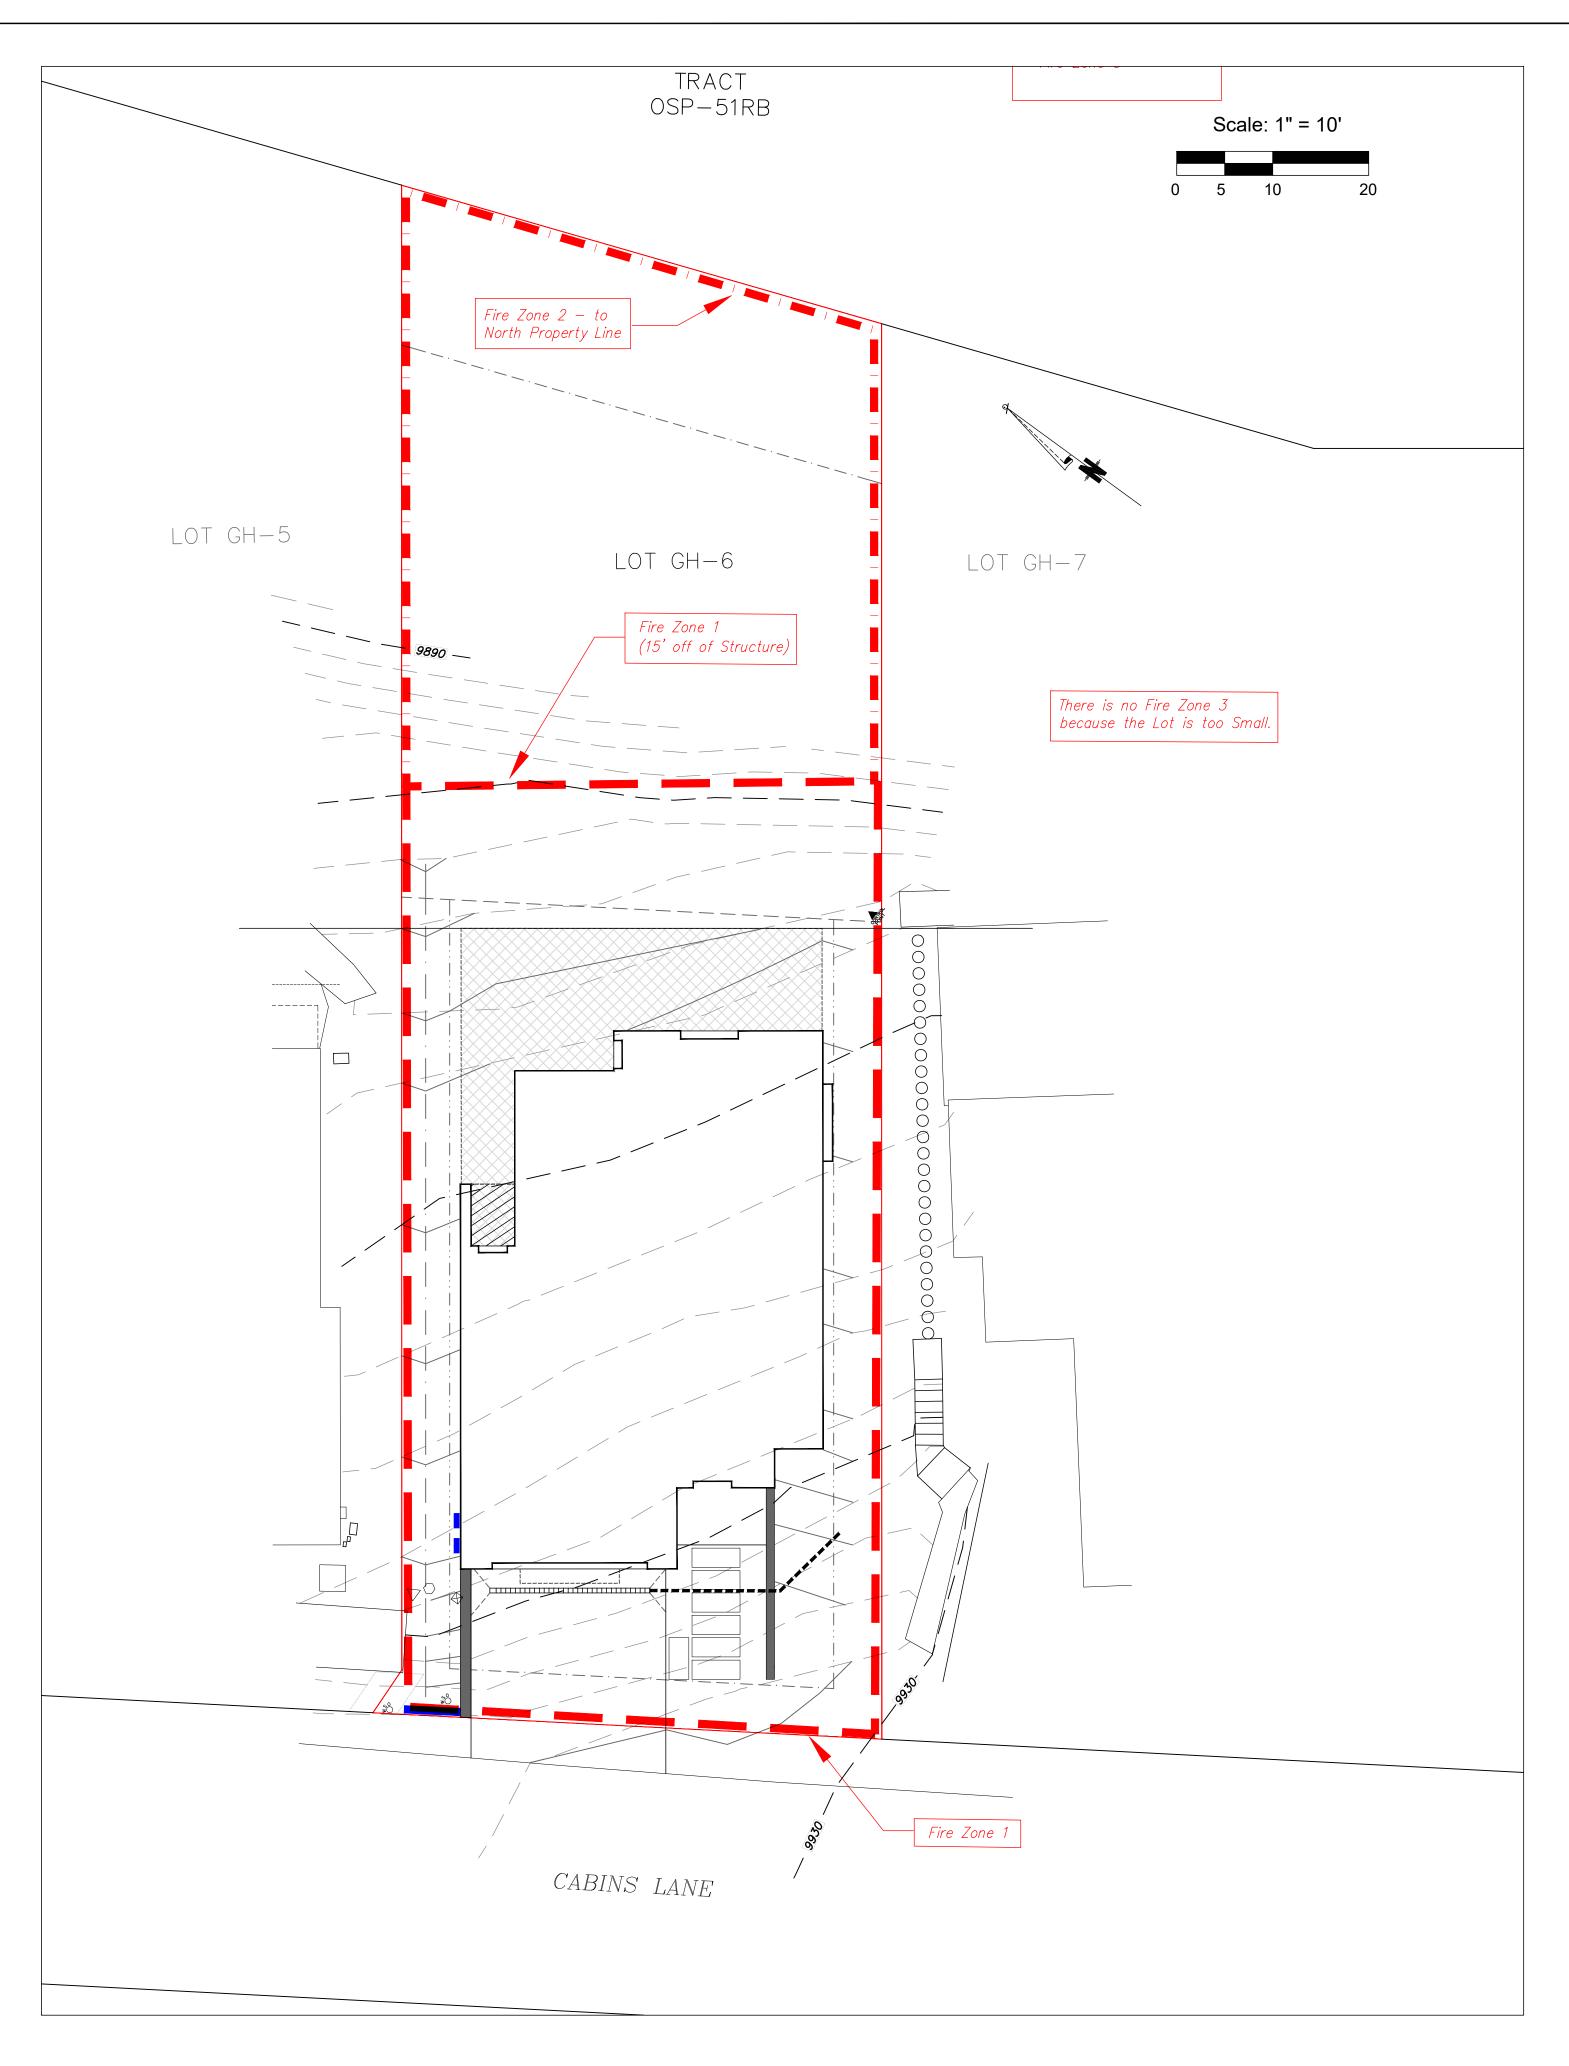
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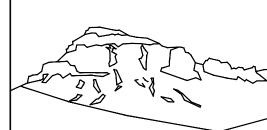
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Fire Zone 2 Chart





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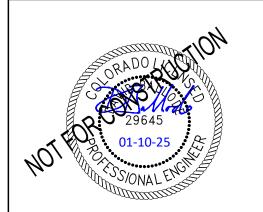
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Unit 6 Gold Hill Mtn. Village, CO

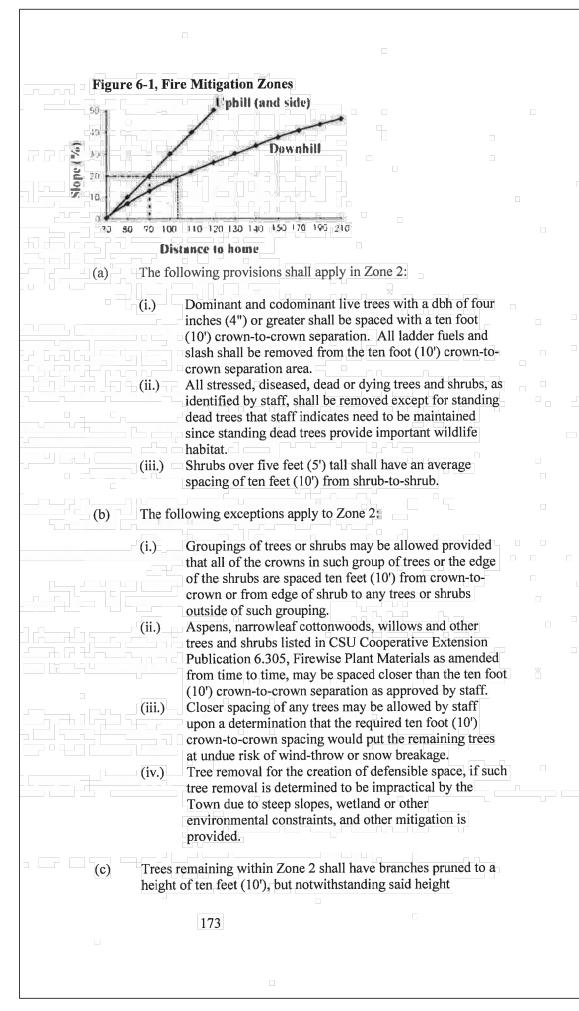

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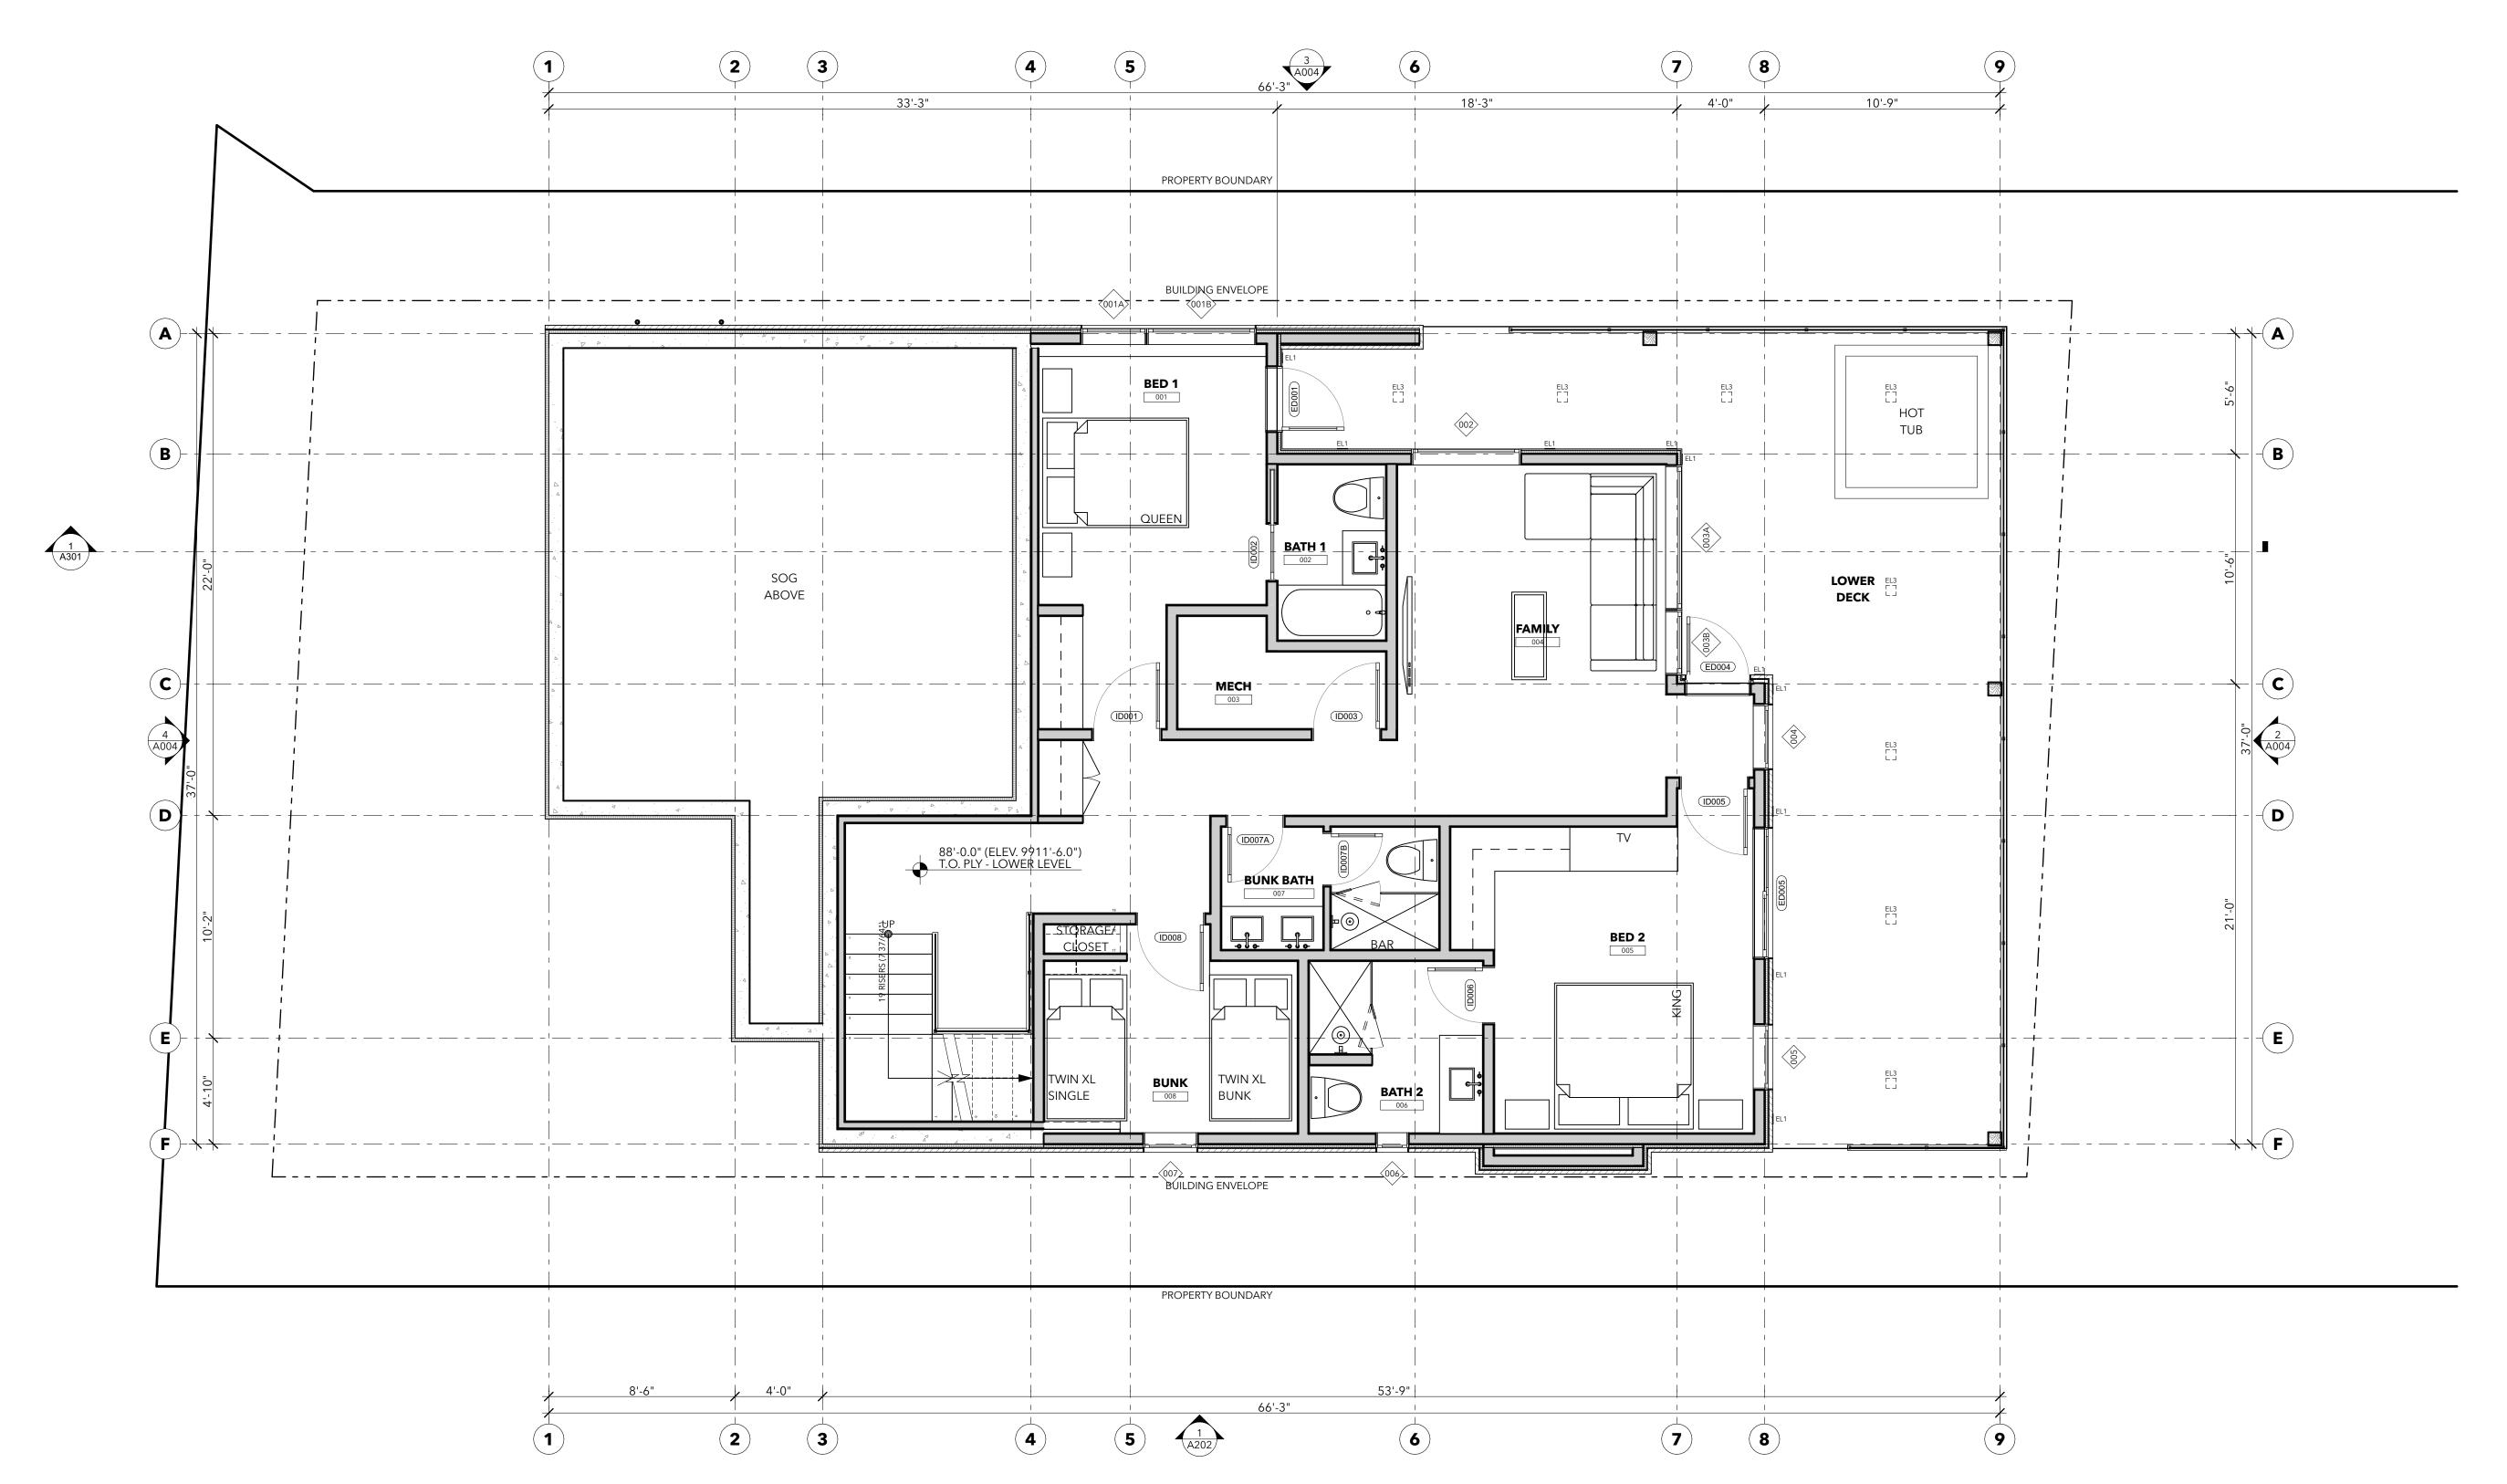
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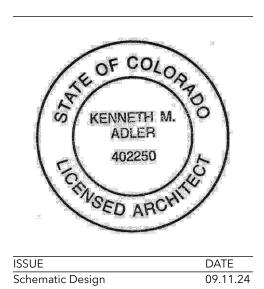
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	GROSS SQUARE FOOTAGE	
ZONE		
RESIDENCE	LOWER LEVEL	1,238
GARAGE	MAIN LEVEL	540
RESIDENCE	MAIN LEVEL	1,223
RESIDENCE	UPPER LEVEL	637
		3.638 ft²

	NET SQUARE FOOTAGE		
38	LOWER LEVEL	1,238	
10	MAIN LEVEL	1,223	
23	UPPER LEVEL	637	
37		3,098 ft²	
H 2			







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HOA Prelim #2


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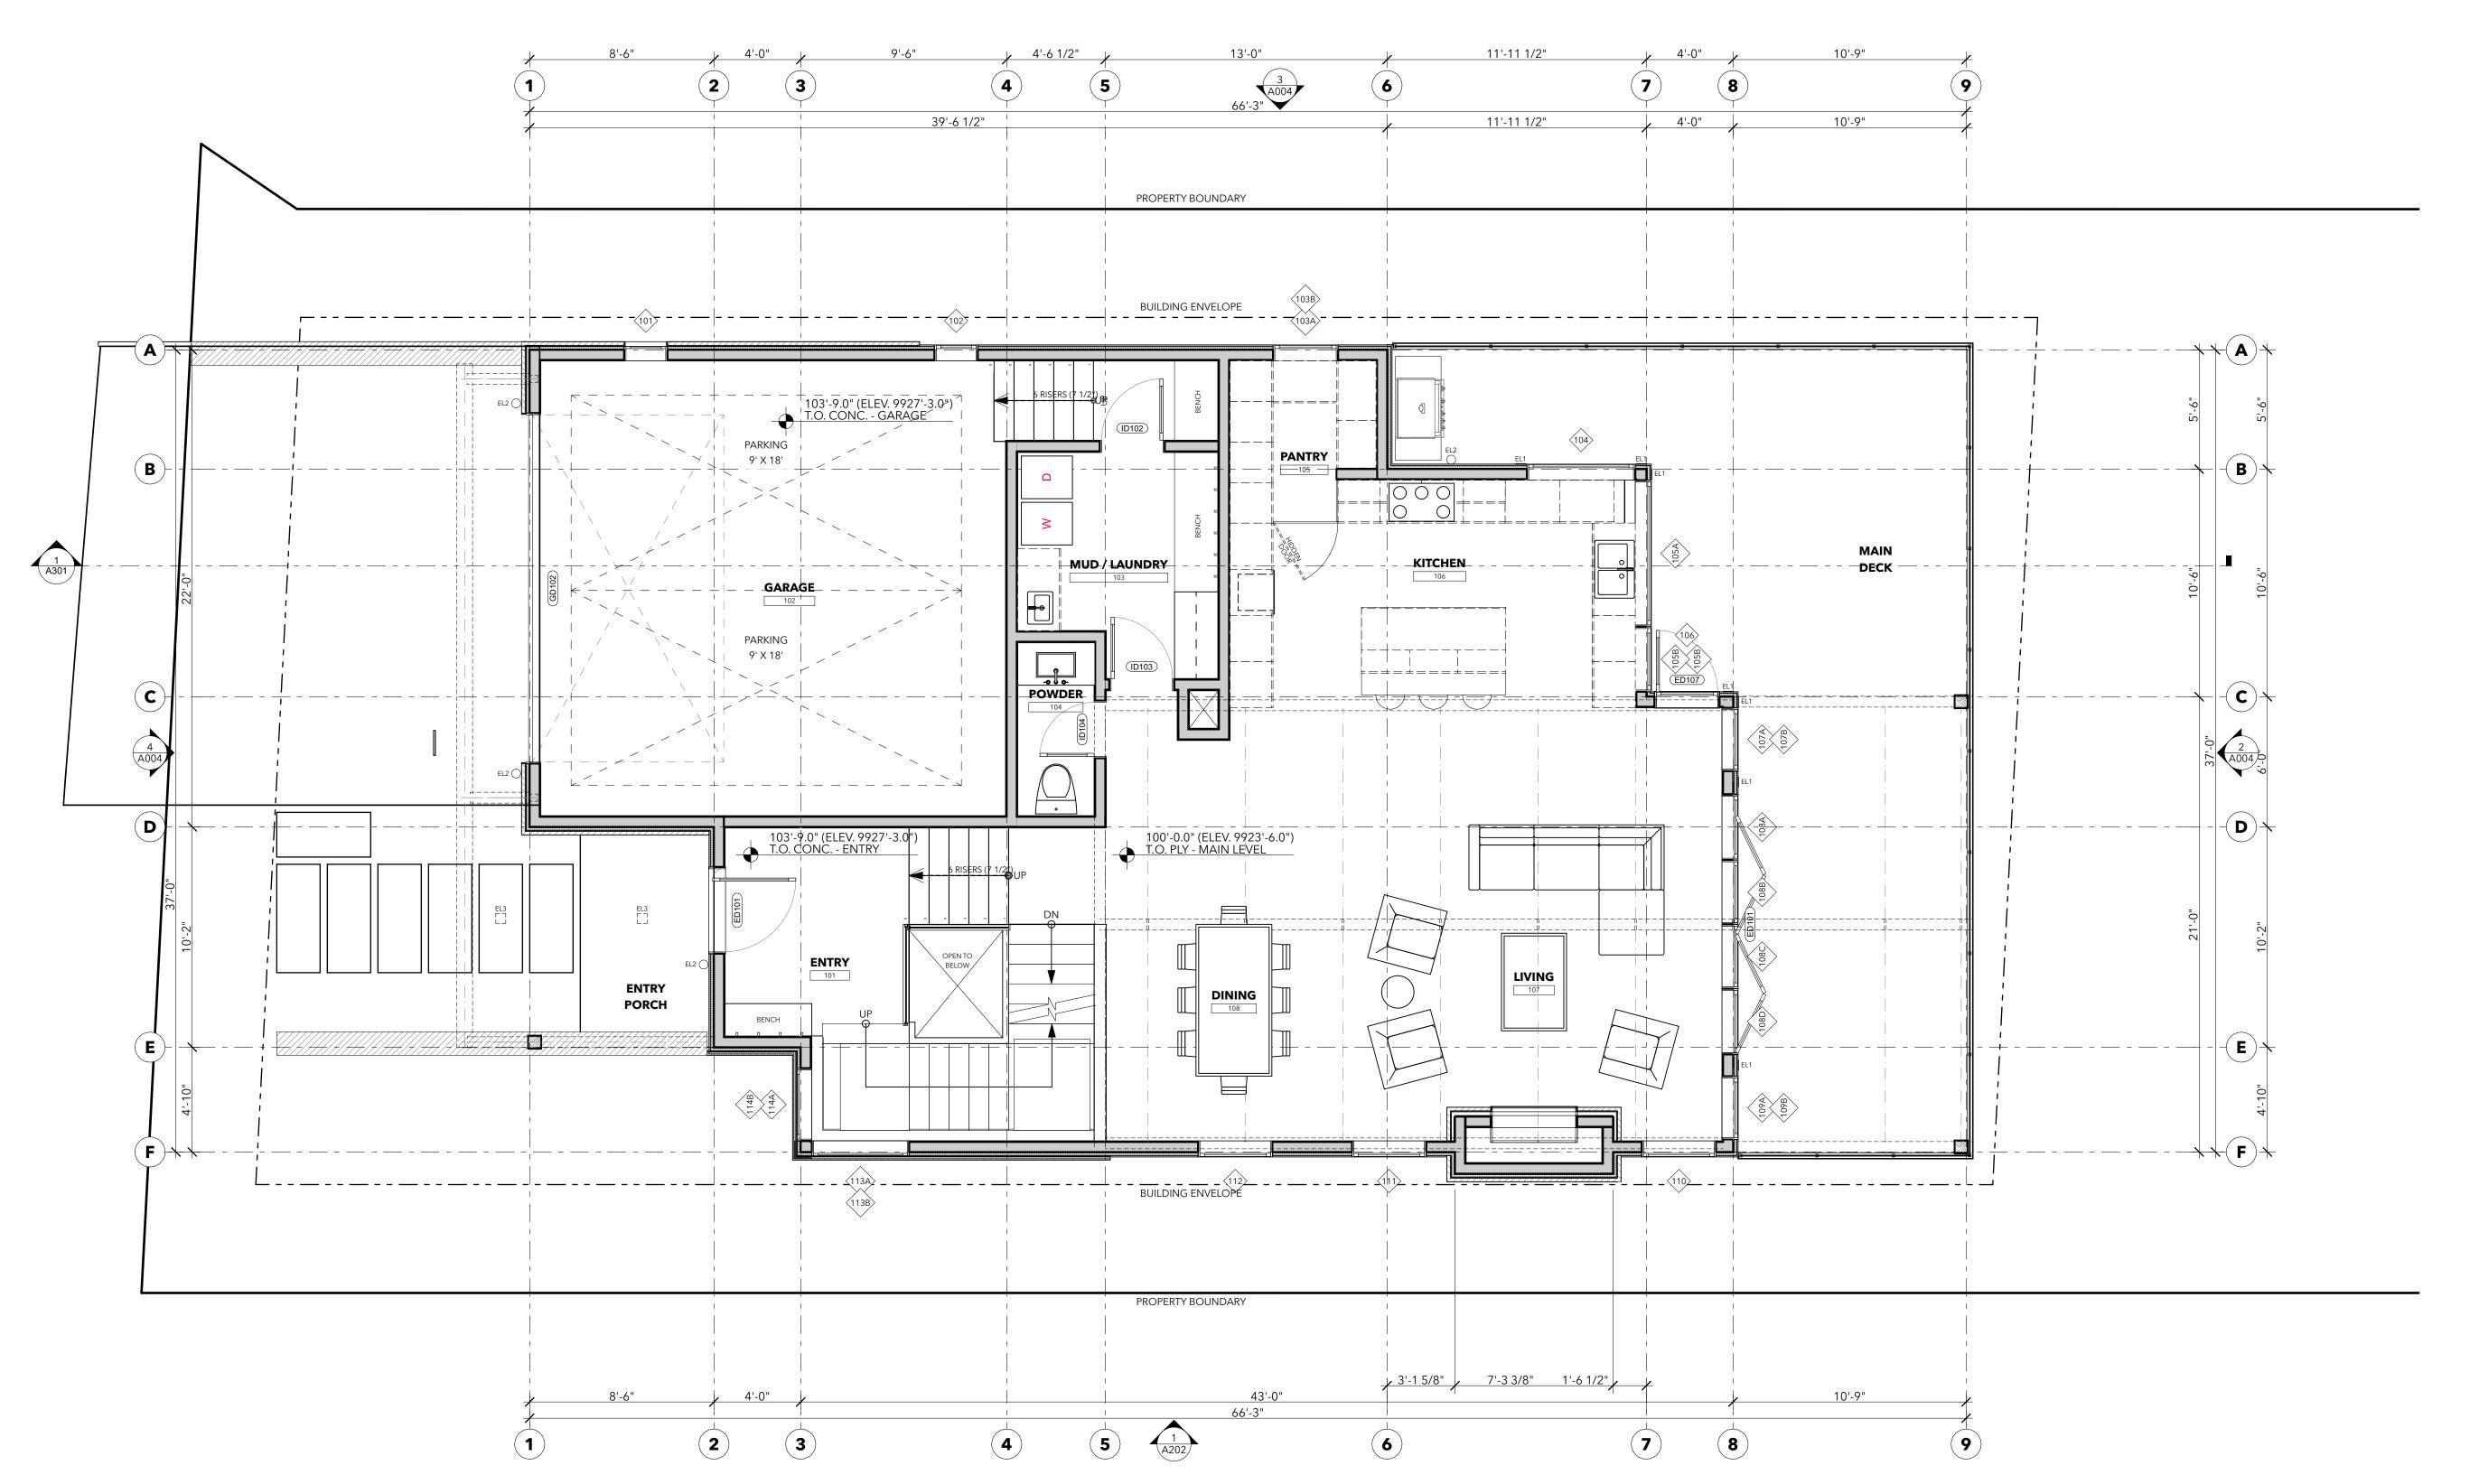
LOWER LEVEL PLAN




GROSS SQUARE FOOTAGE			
ZONE			
RESIDENCE	LOWER LEVEL	1,238	
GARAGE	MAIN LEVEL	540	
RESIDENCE	MAIN LEVEL	1,223	
RESIDENCE	UPPER LEVEL	637	
		3,638 ft ²	

NET SQUARE FOOTAGE		
LOWER LEVEL	1,238	
MAIN LEVEL	1,223	
UPPER LEVEL	637	
	3,098 ft ²	



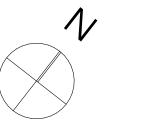

old Hill Lot 6
106 Cabins LN
of Mountain Village, CO 81435

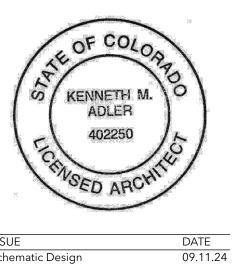

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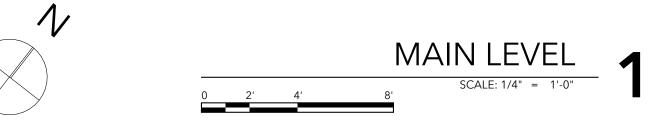
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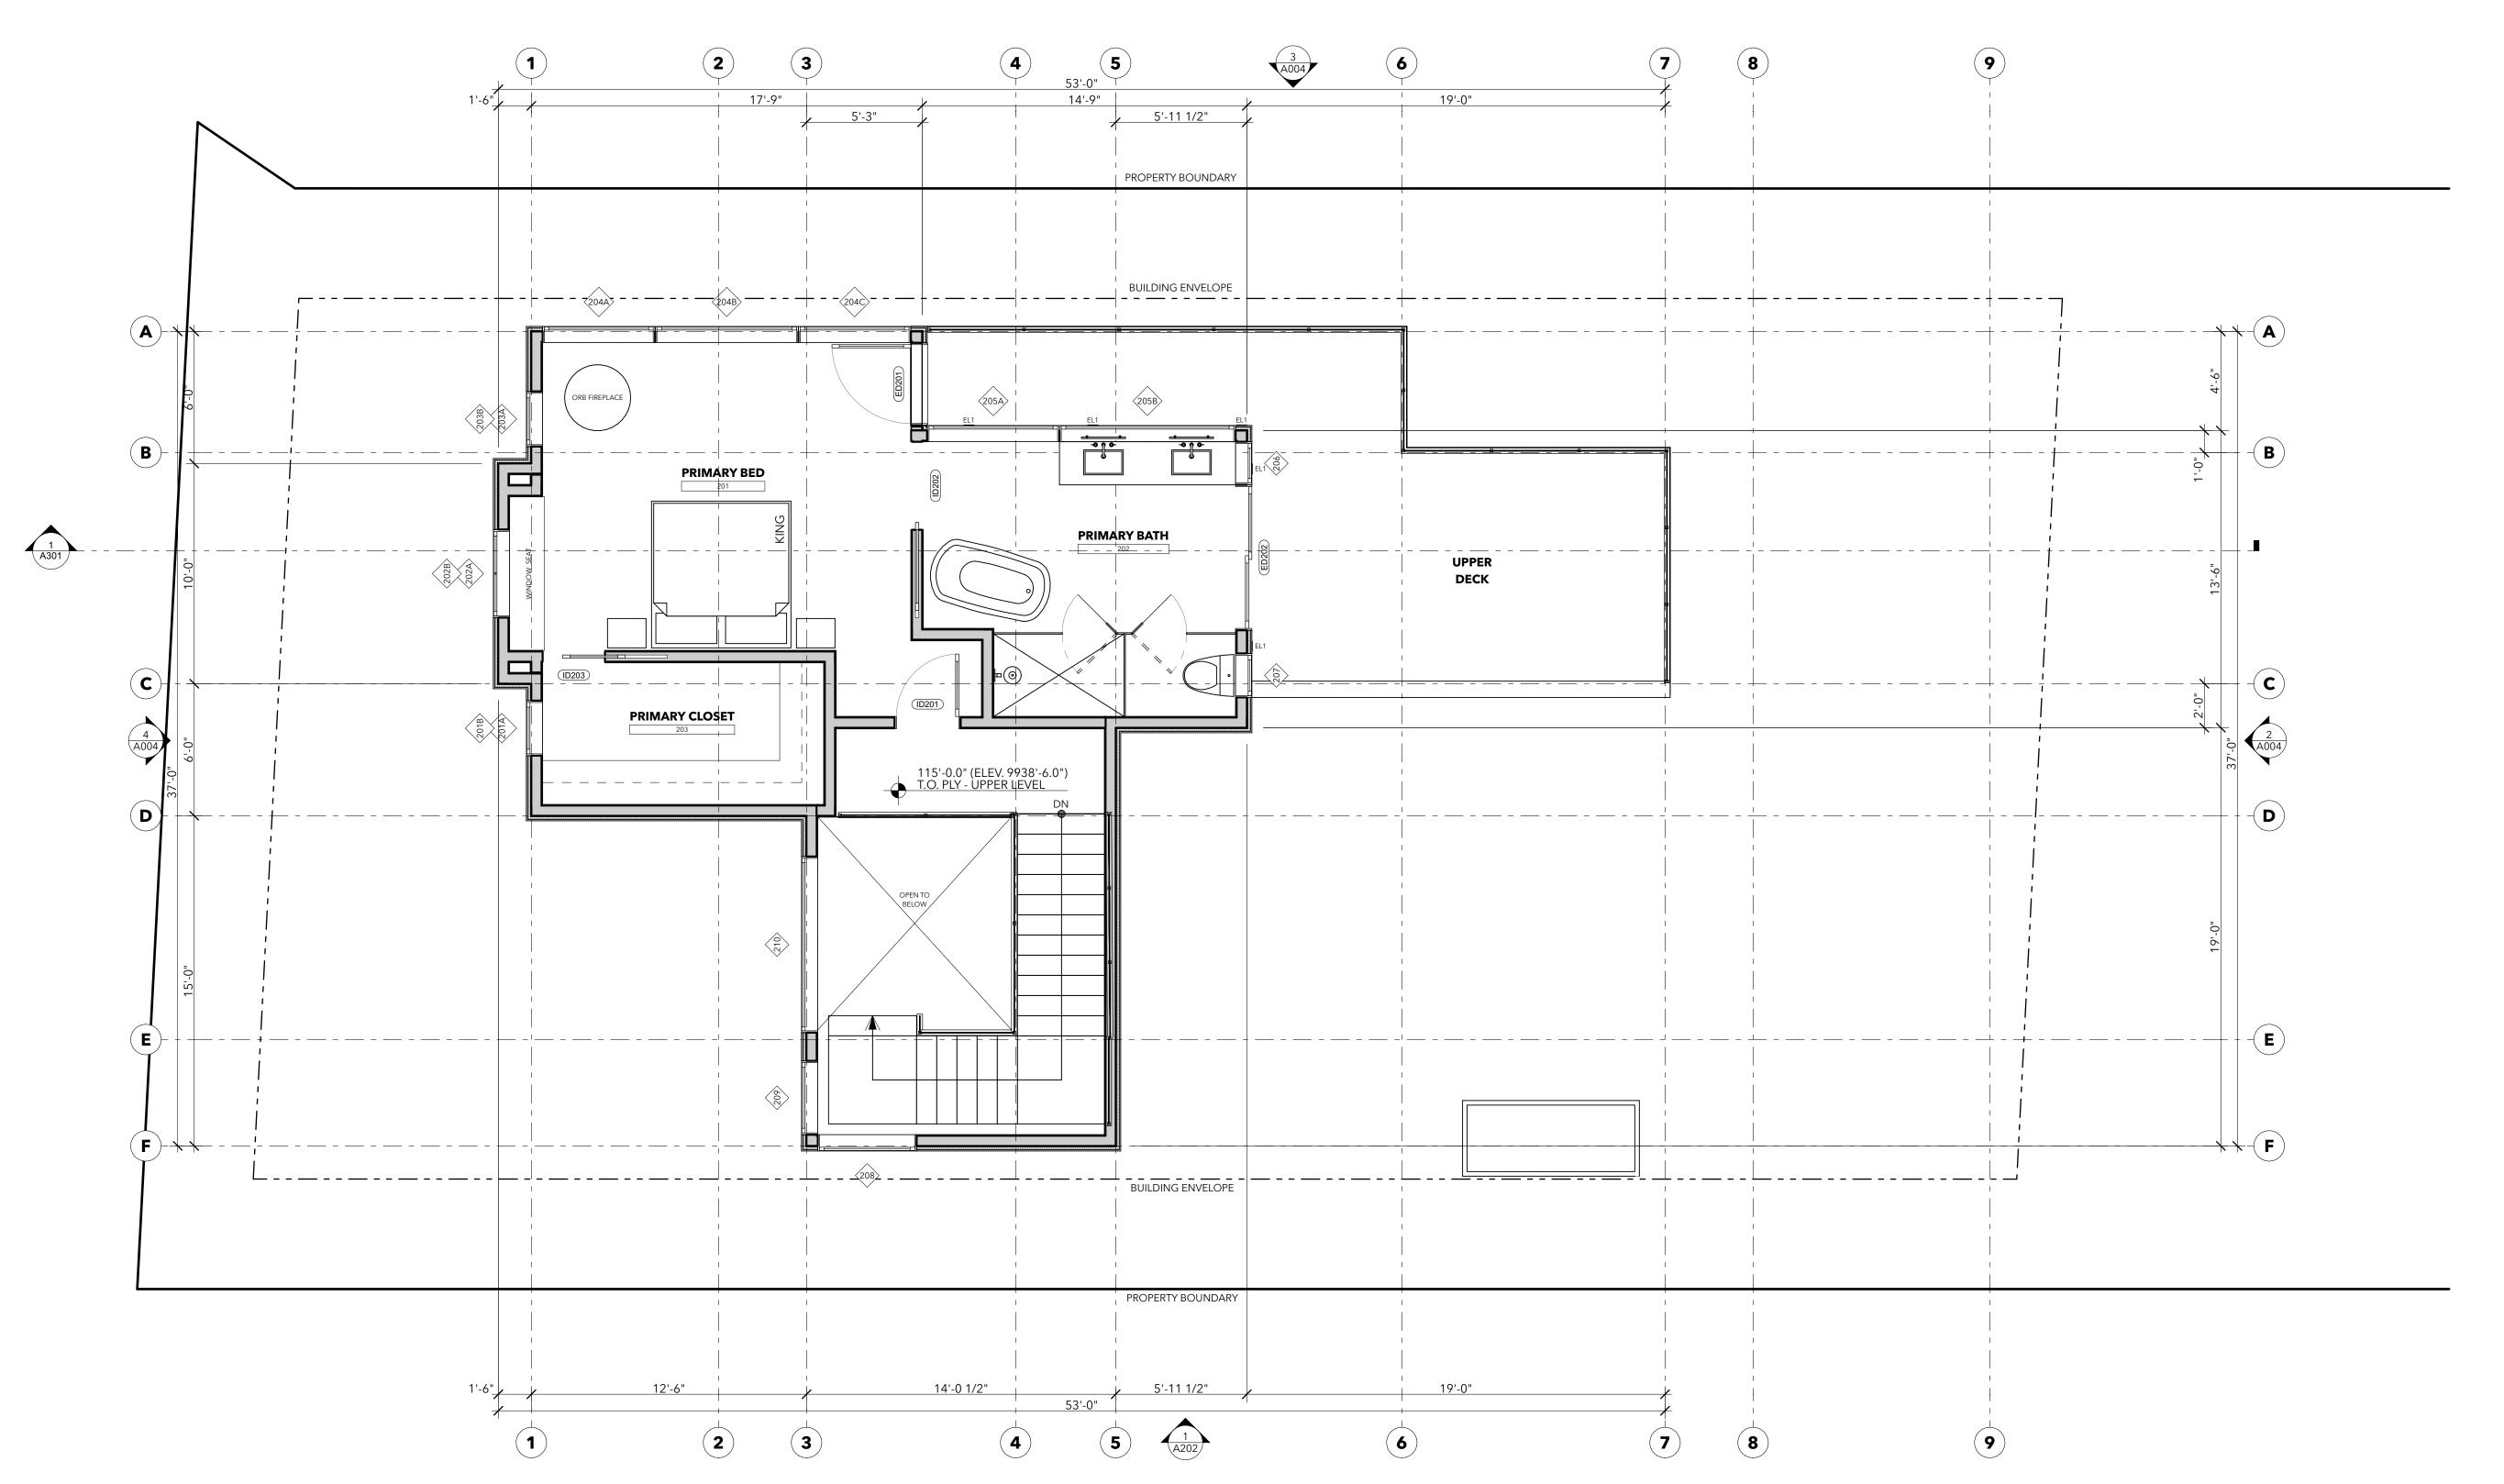
MAIN LEVEL PLAN




	GROSS SQUARE FOOTAGE	
ONE		
ESIDENCE	LOWER LEVEL	1,238
ARAGE	MAIN LEVEL	540
ESIDENCE	MAIN LEVEL	1,223
ESIDENCE	UPPER LEVEL	637
		3,638 ft ²

NET SQUARE FOOTAGE								
LOWER LEVEL	1,238							
MAIN LEVEL	1,223							
UPPER LEVEL	637							
	3,098 ft							
-								





Gold Hill Lot 6106 Cabins LN
wn of Mountain Village, CO 81435

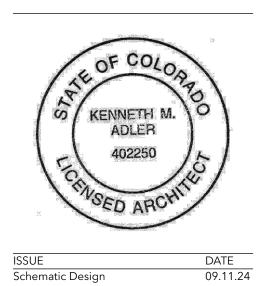

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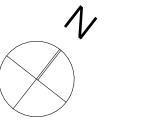
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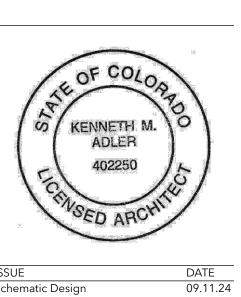
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UPPER LEVEL PLAN







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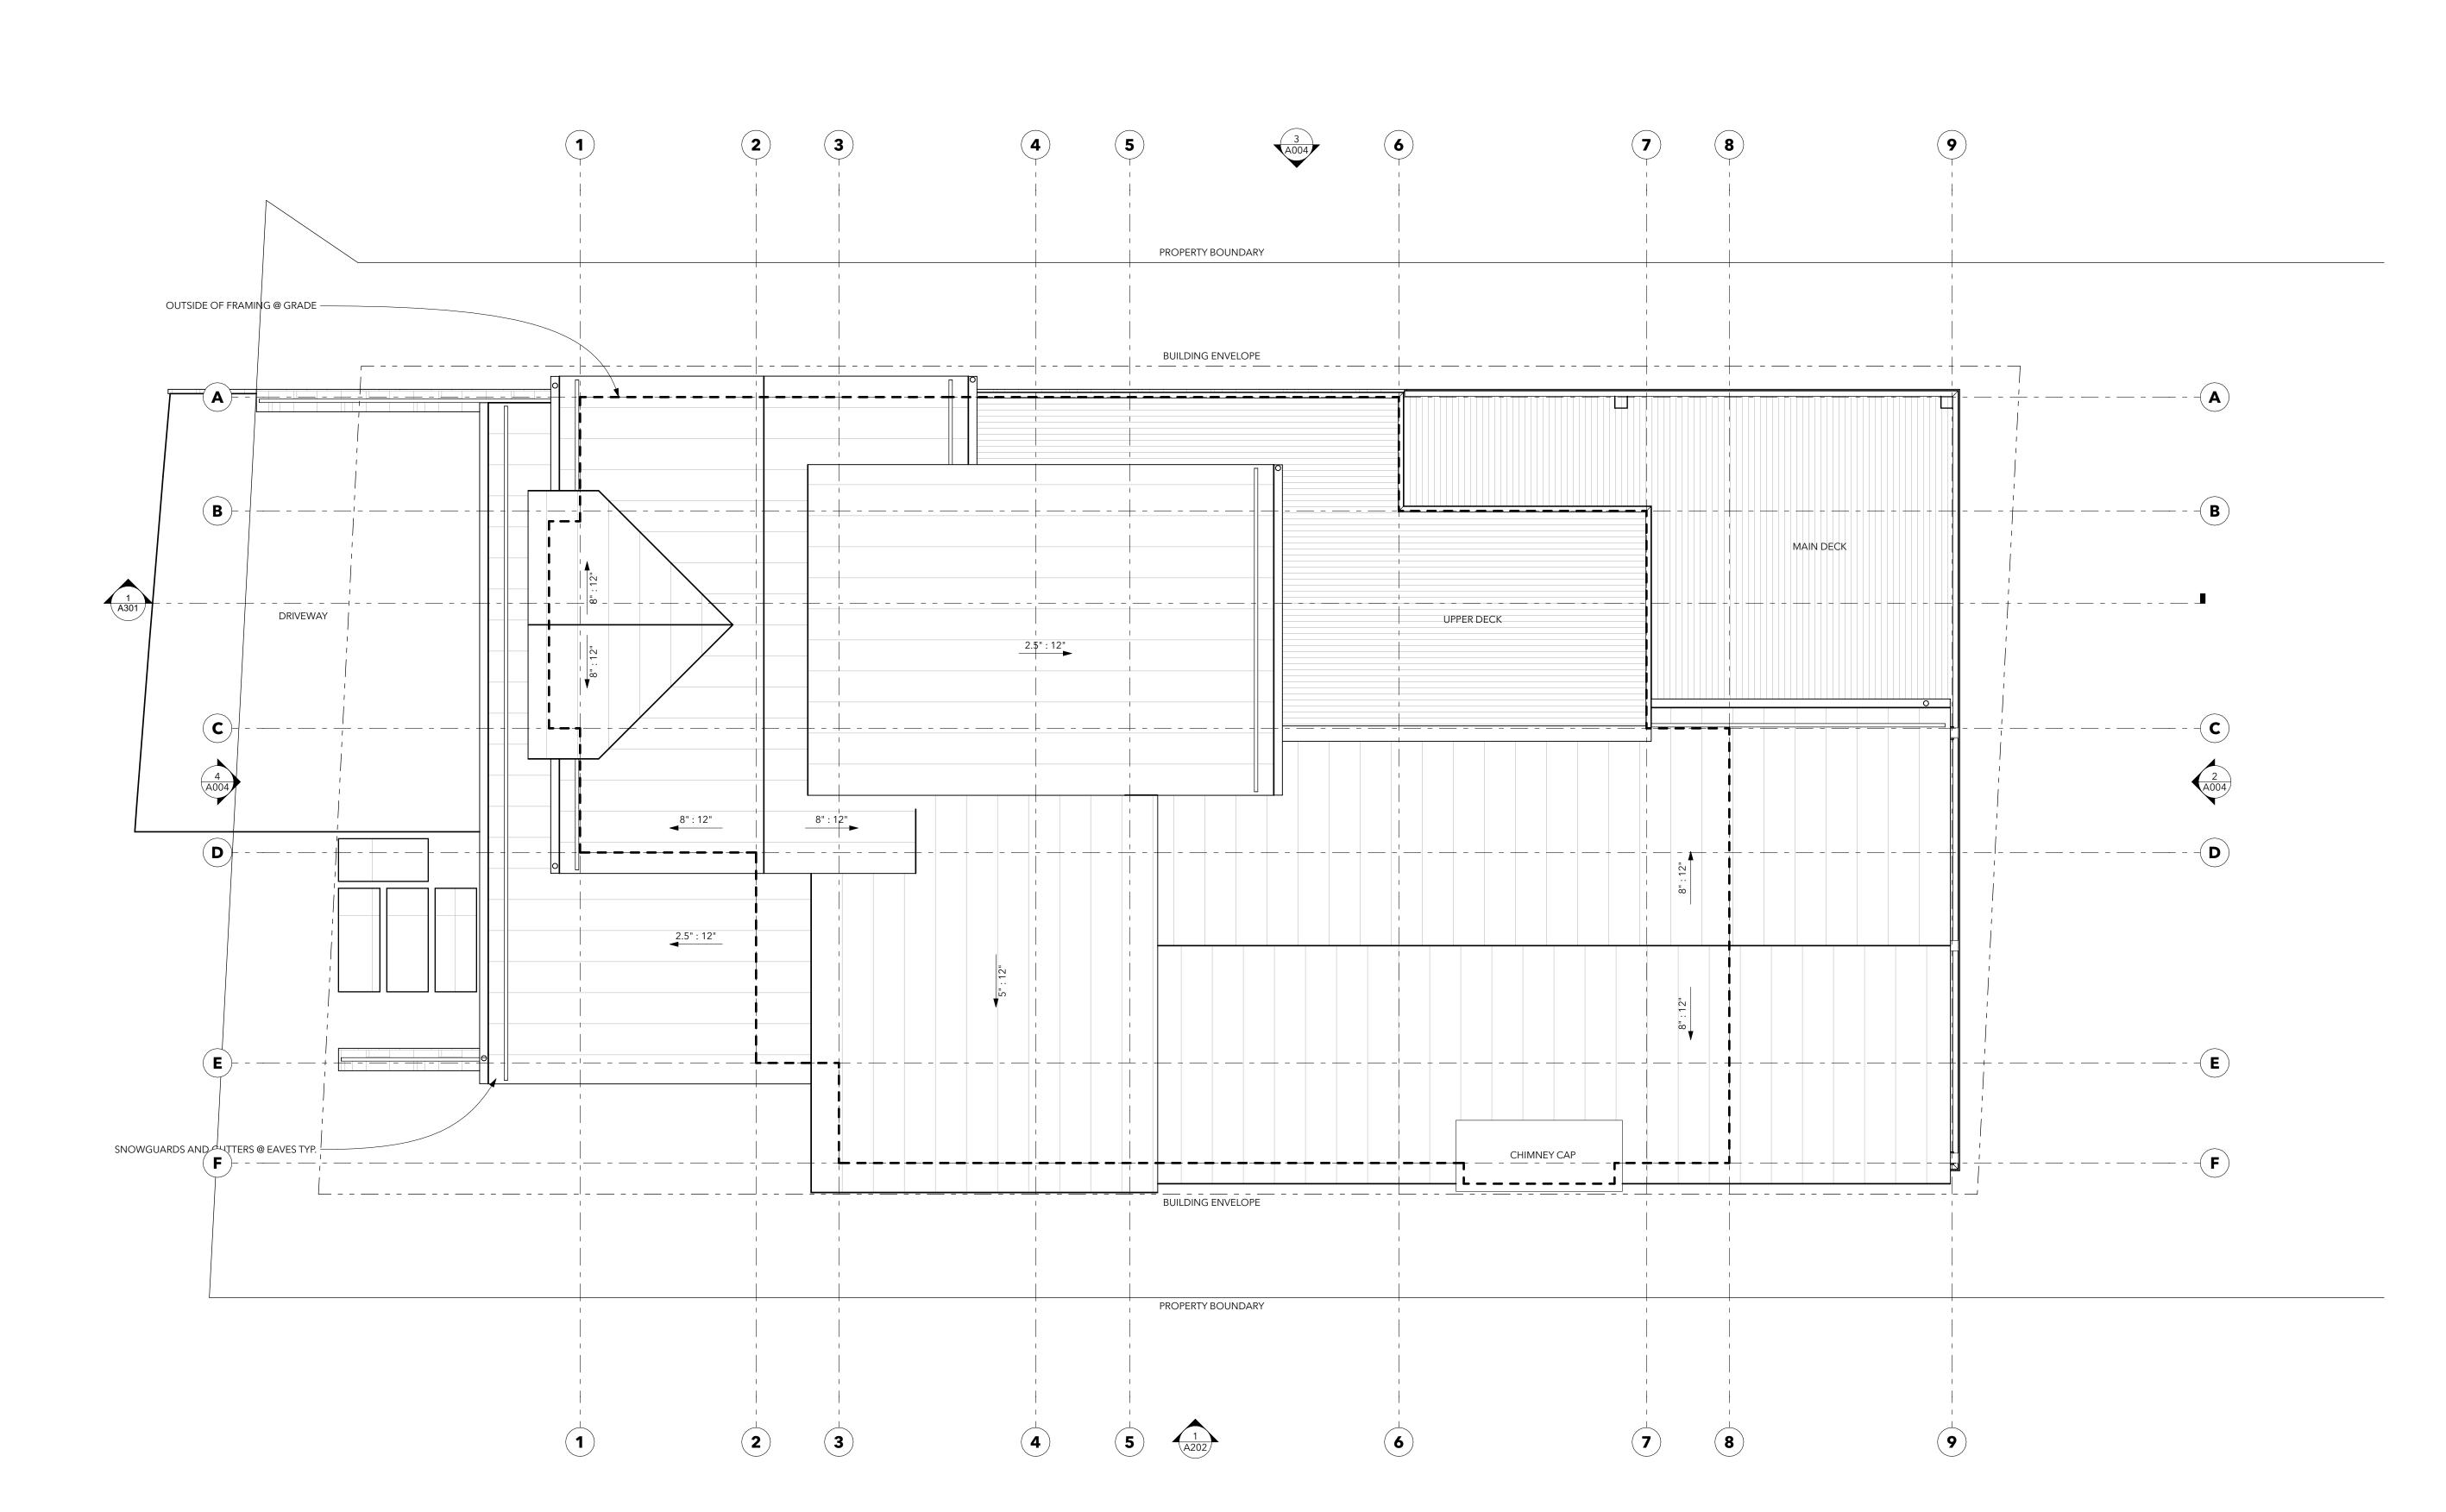
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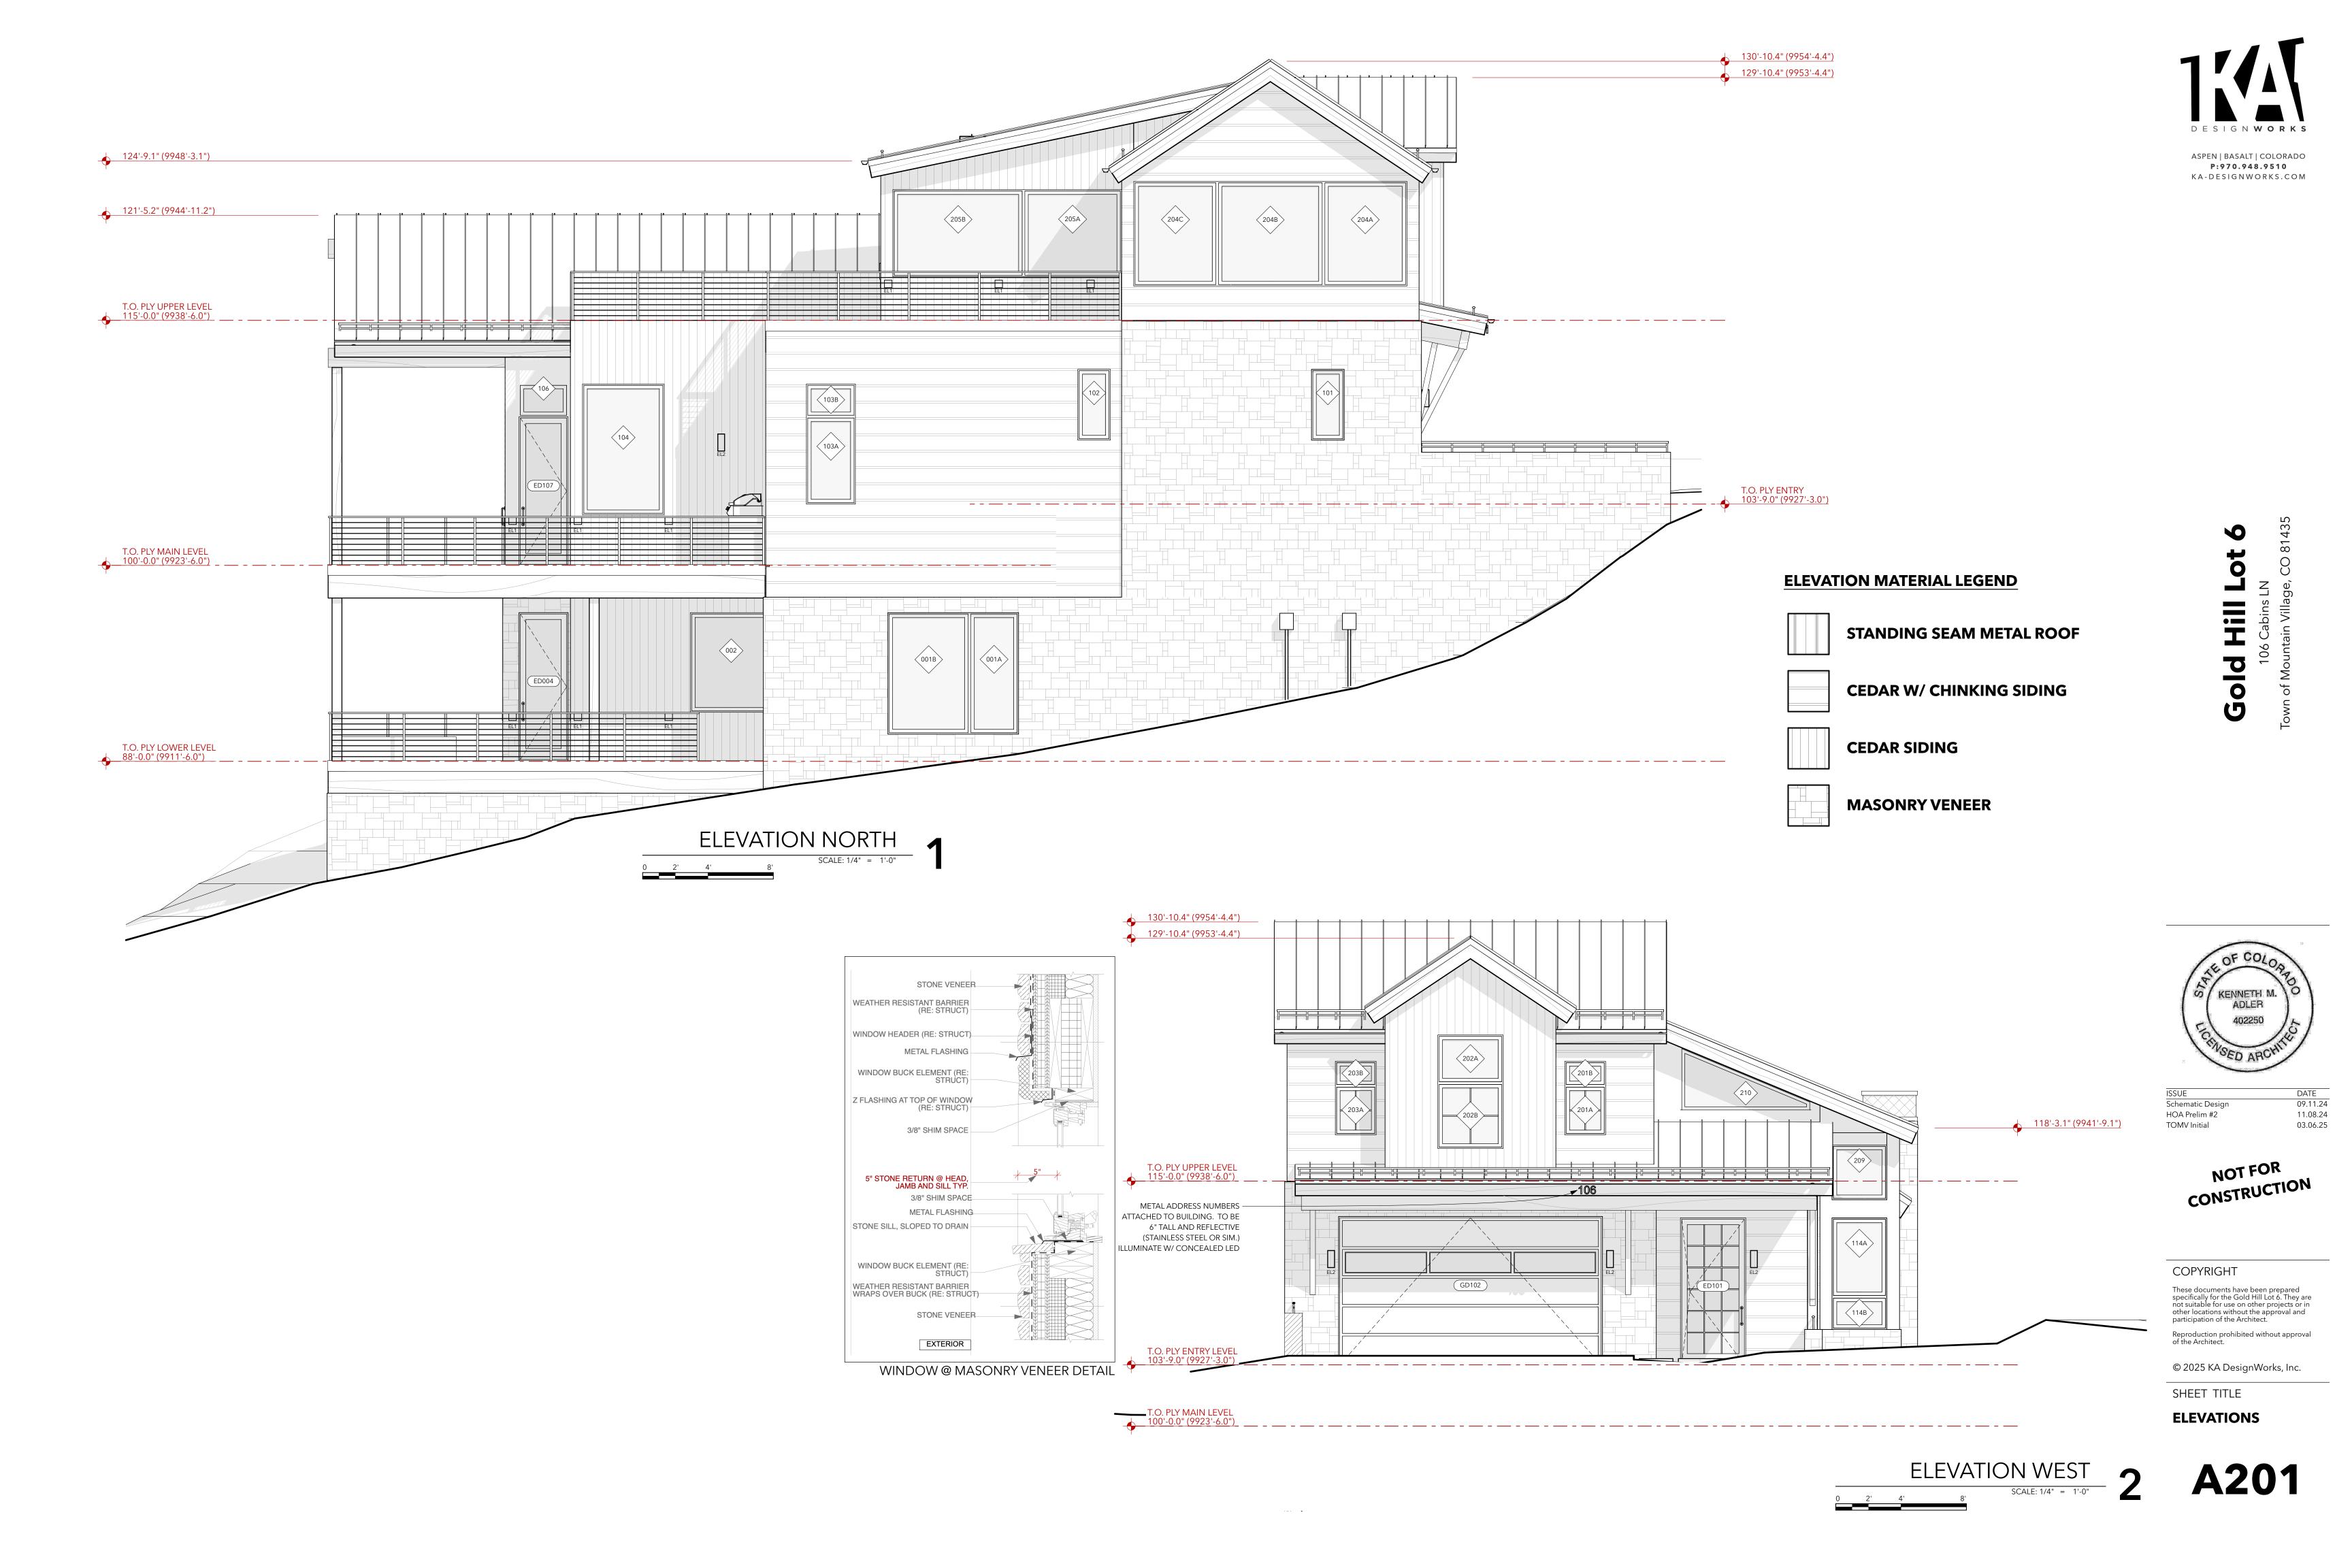
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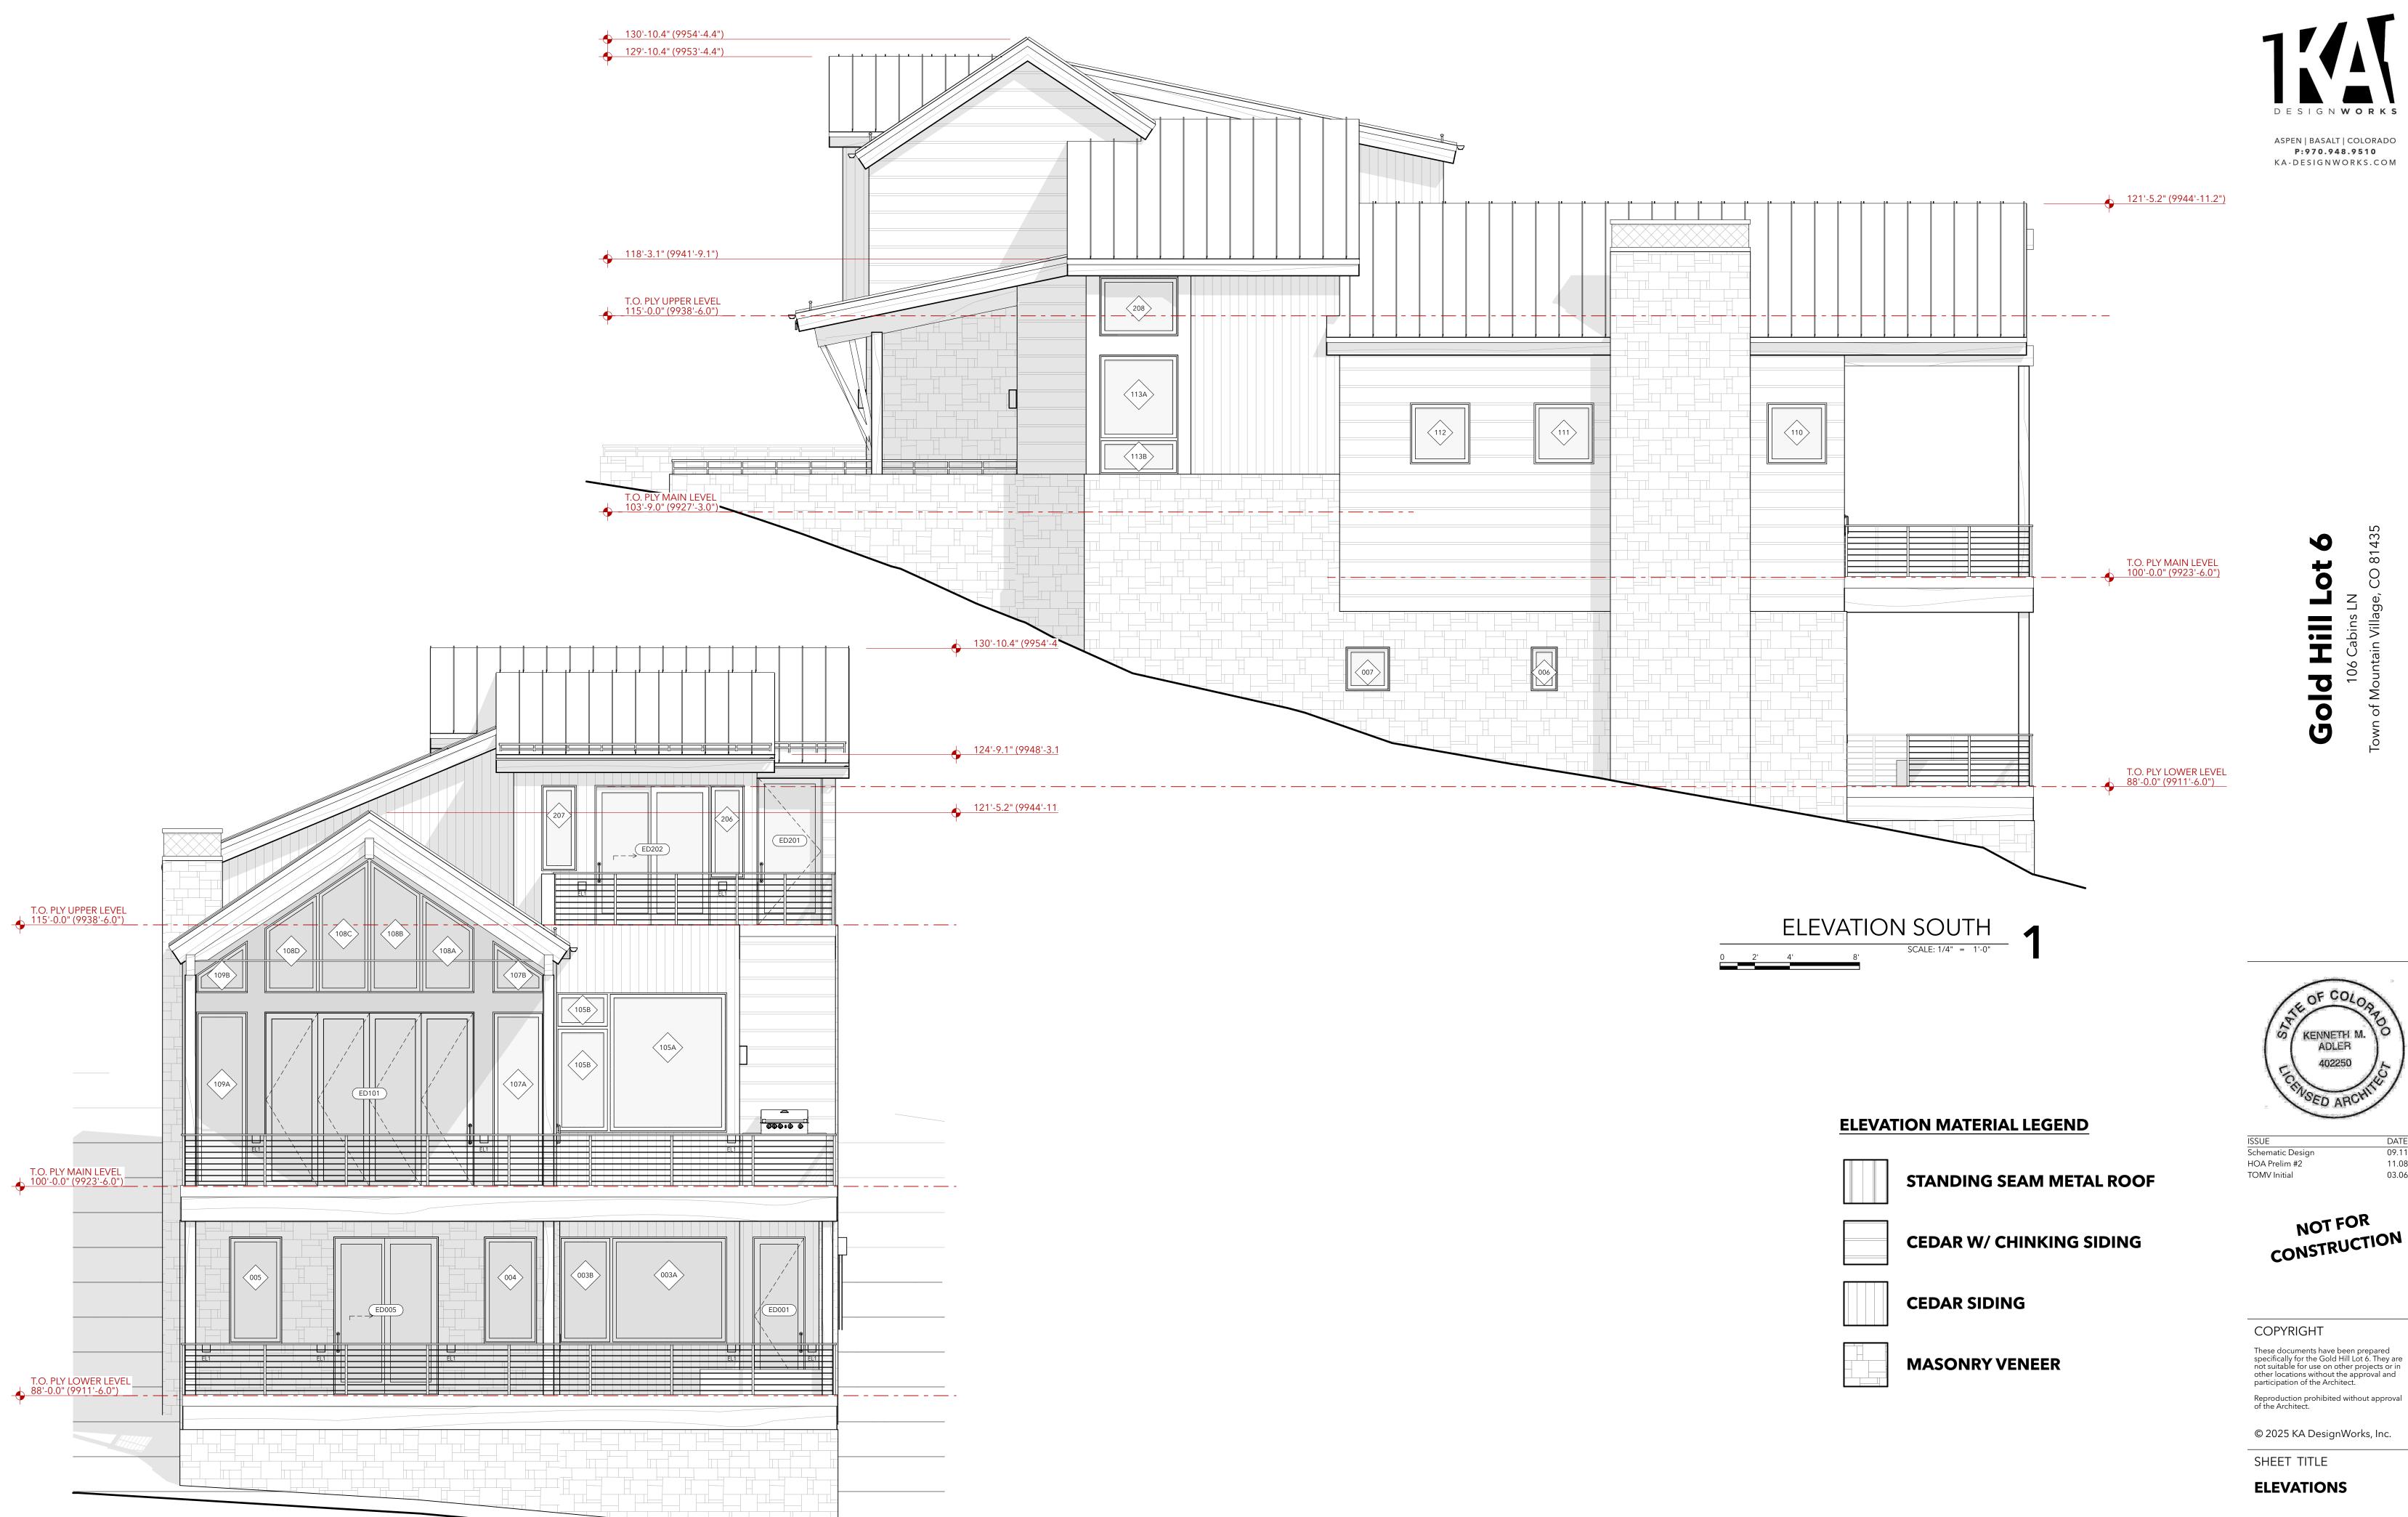
SHEET TITLE **ROOF PLAN**

ROOF PLAN

SCALE: 1/4" = 1'-0"







ELEVATION EAST

2' 4' 8' SCALE: 1/4" = 1'-0"

Gold Hill Lot

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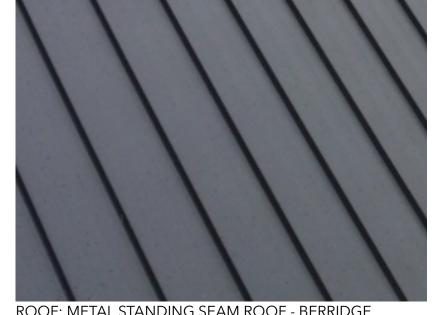
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SHEET TITLE

ELEVATIONS



ROOF: METAL STANDING SEAM ROOF - BERRIDGE




PAINTED METAL / FLASHING: CANNONBALL



HORIZONTAL SIDING: DELTA MILLWORKS WESTERN RED CEDAR, HD CLEAR W/ FLASHING



VERTICAL SIDING: DELTA MILLWORKS ACCOYA, BARNWOOD, BATTLESHIP

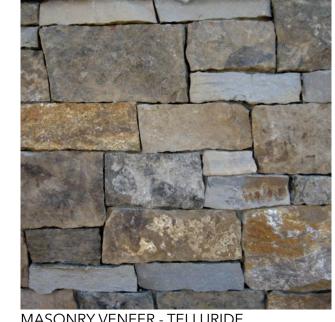

MASONRY VENEER - TELLURIDE SAGEBRUSH












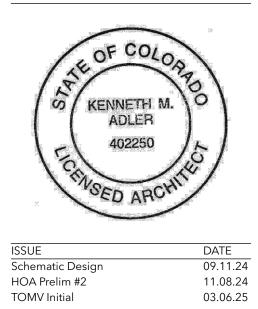

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SHEET TITLE

3D EXTERIOR 1



ROOF: METAL STANDING SEAM ROOF - BERRIDGE



PAINTED METAL / FLASHING: CANNONBALL



HORIZONTAL SIDING: DELTA MILLWORKS WESTERN RED CEDAR, HD CLEAR W/ FLASHING




VERTICAL SIDING: DELTA MILLWORKS ACCOYA, BARNWOOD, BATTLESHIP



MASONRY VENEER - TELLURIDE




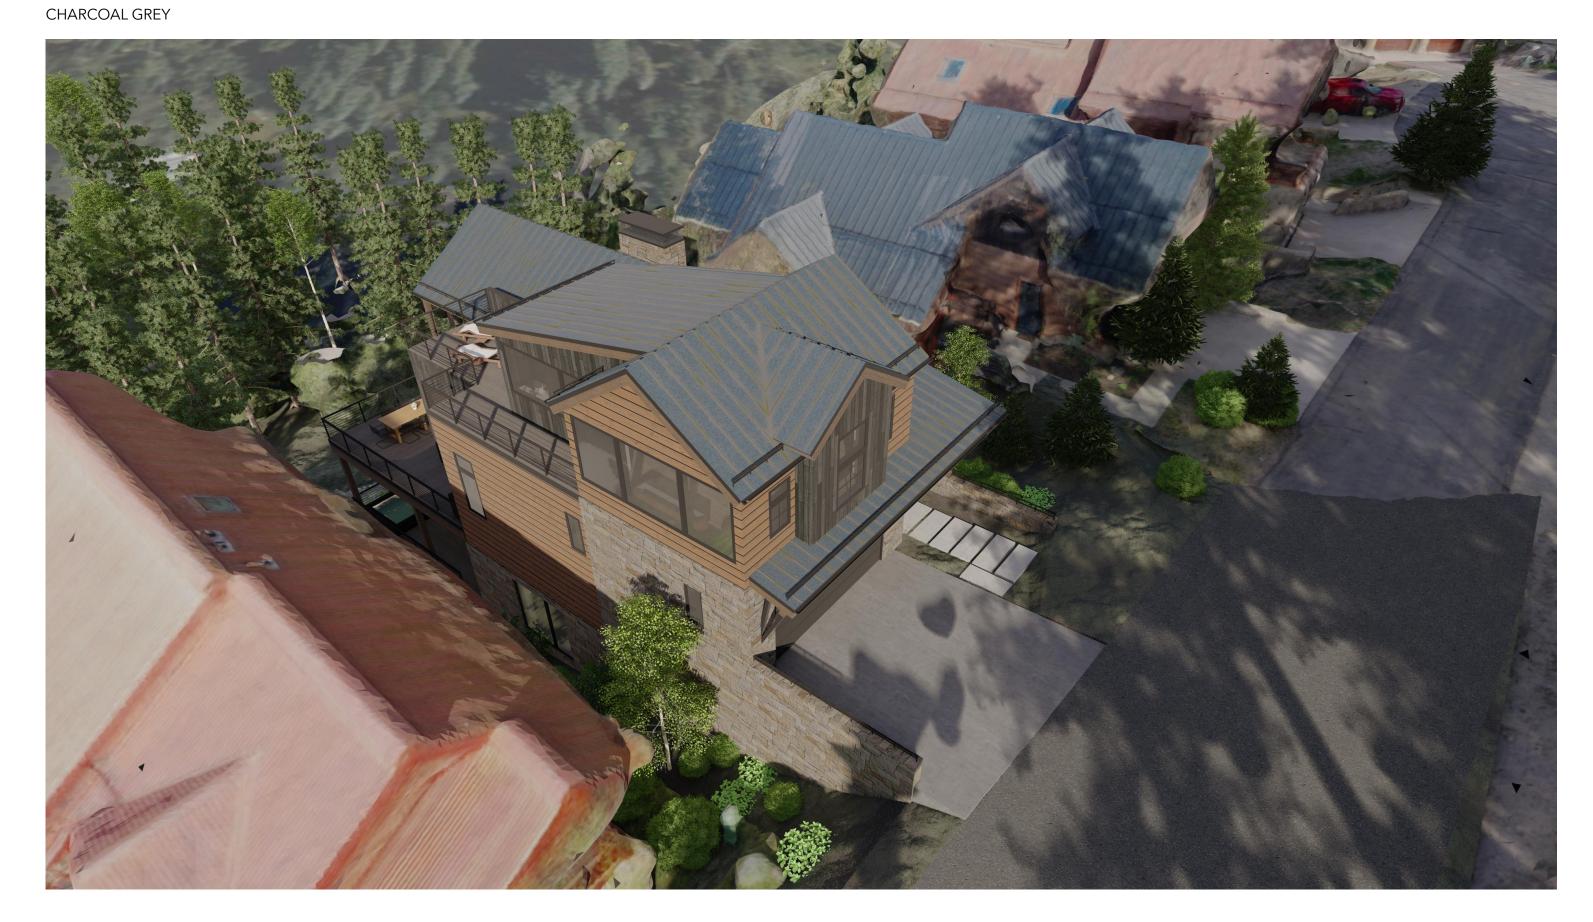







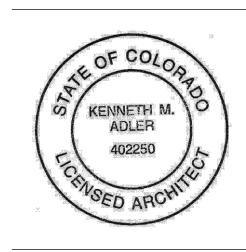

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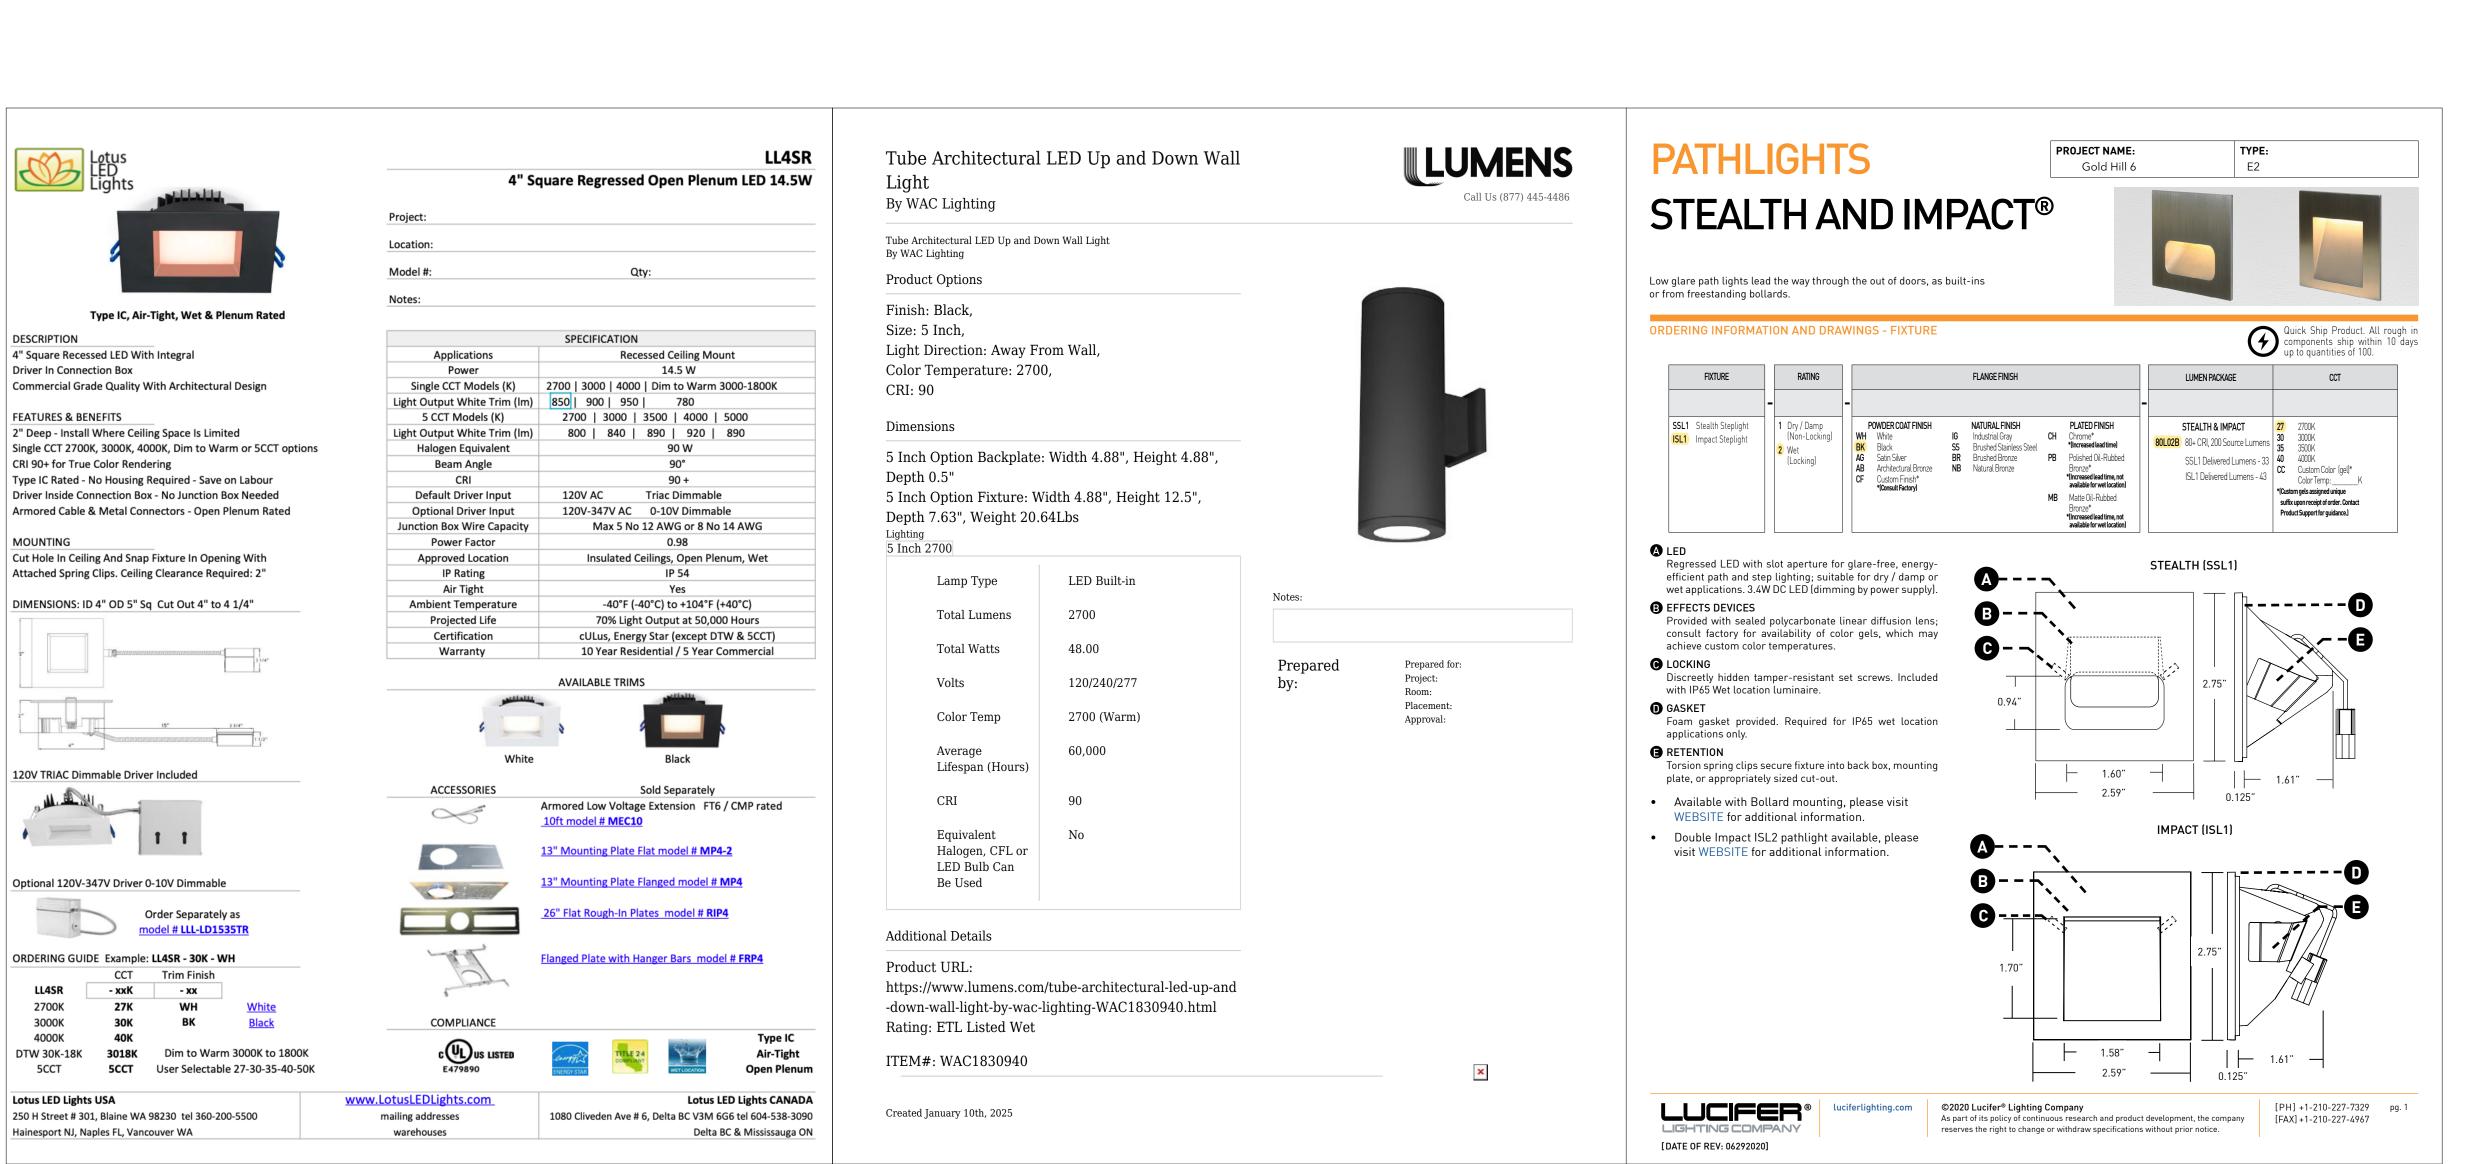
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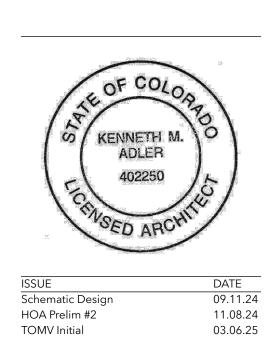
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3D EXTERIOR 2





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LIGHTING SPECS


. . . .

GENERAL NOTES

1) W1—INDICATES WALL ASSEMBLY, SEE WALL ASSEMBLIES ON A601





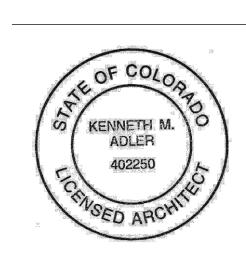

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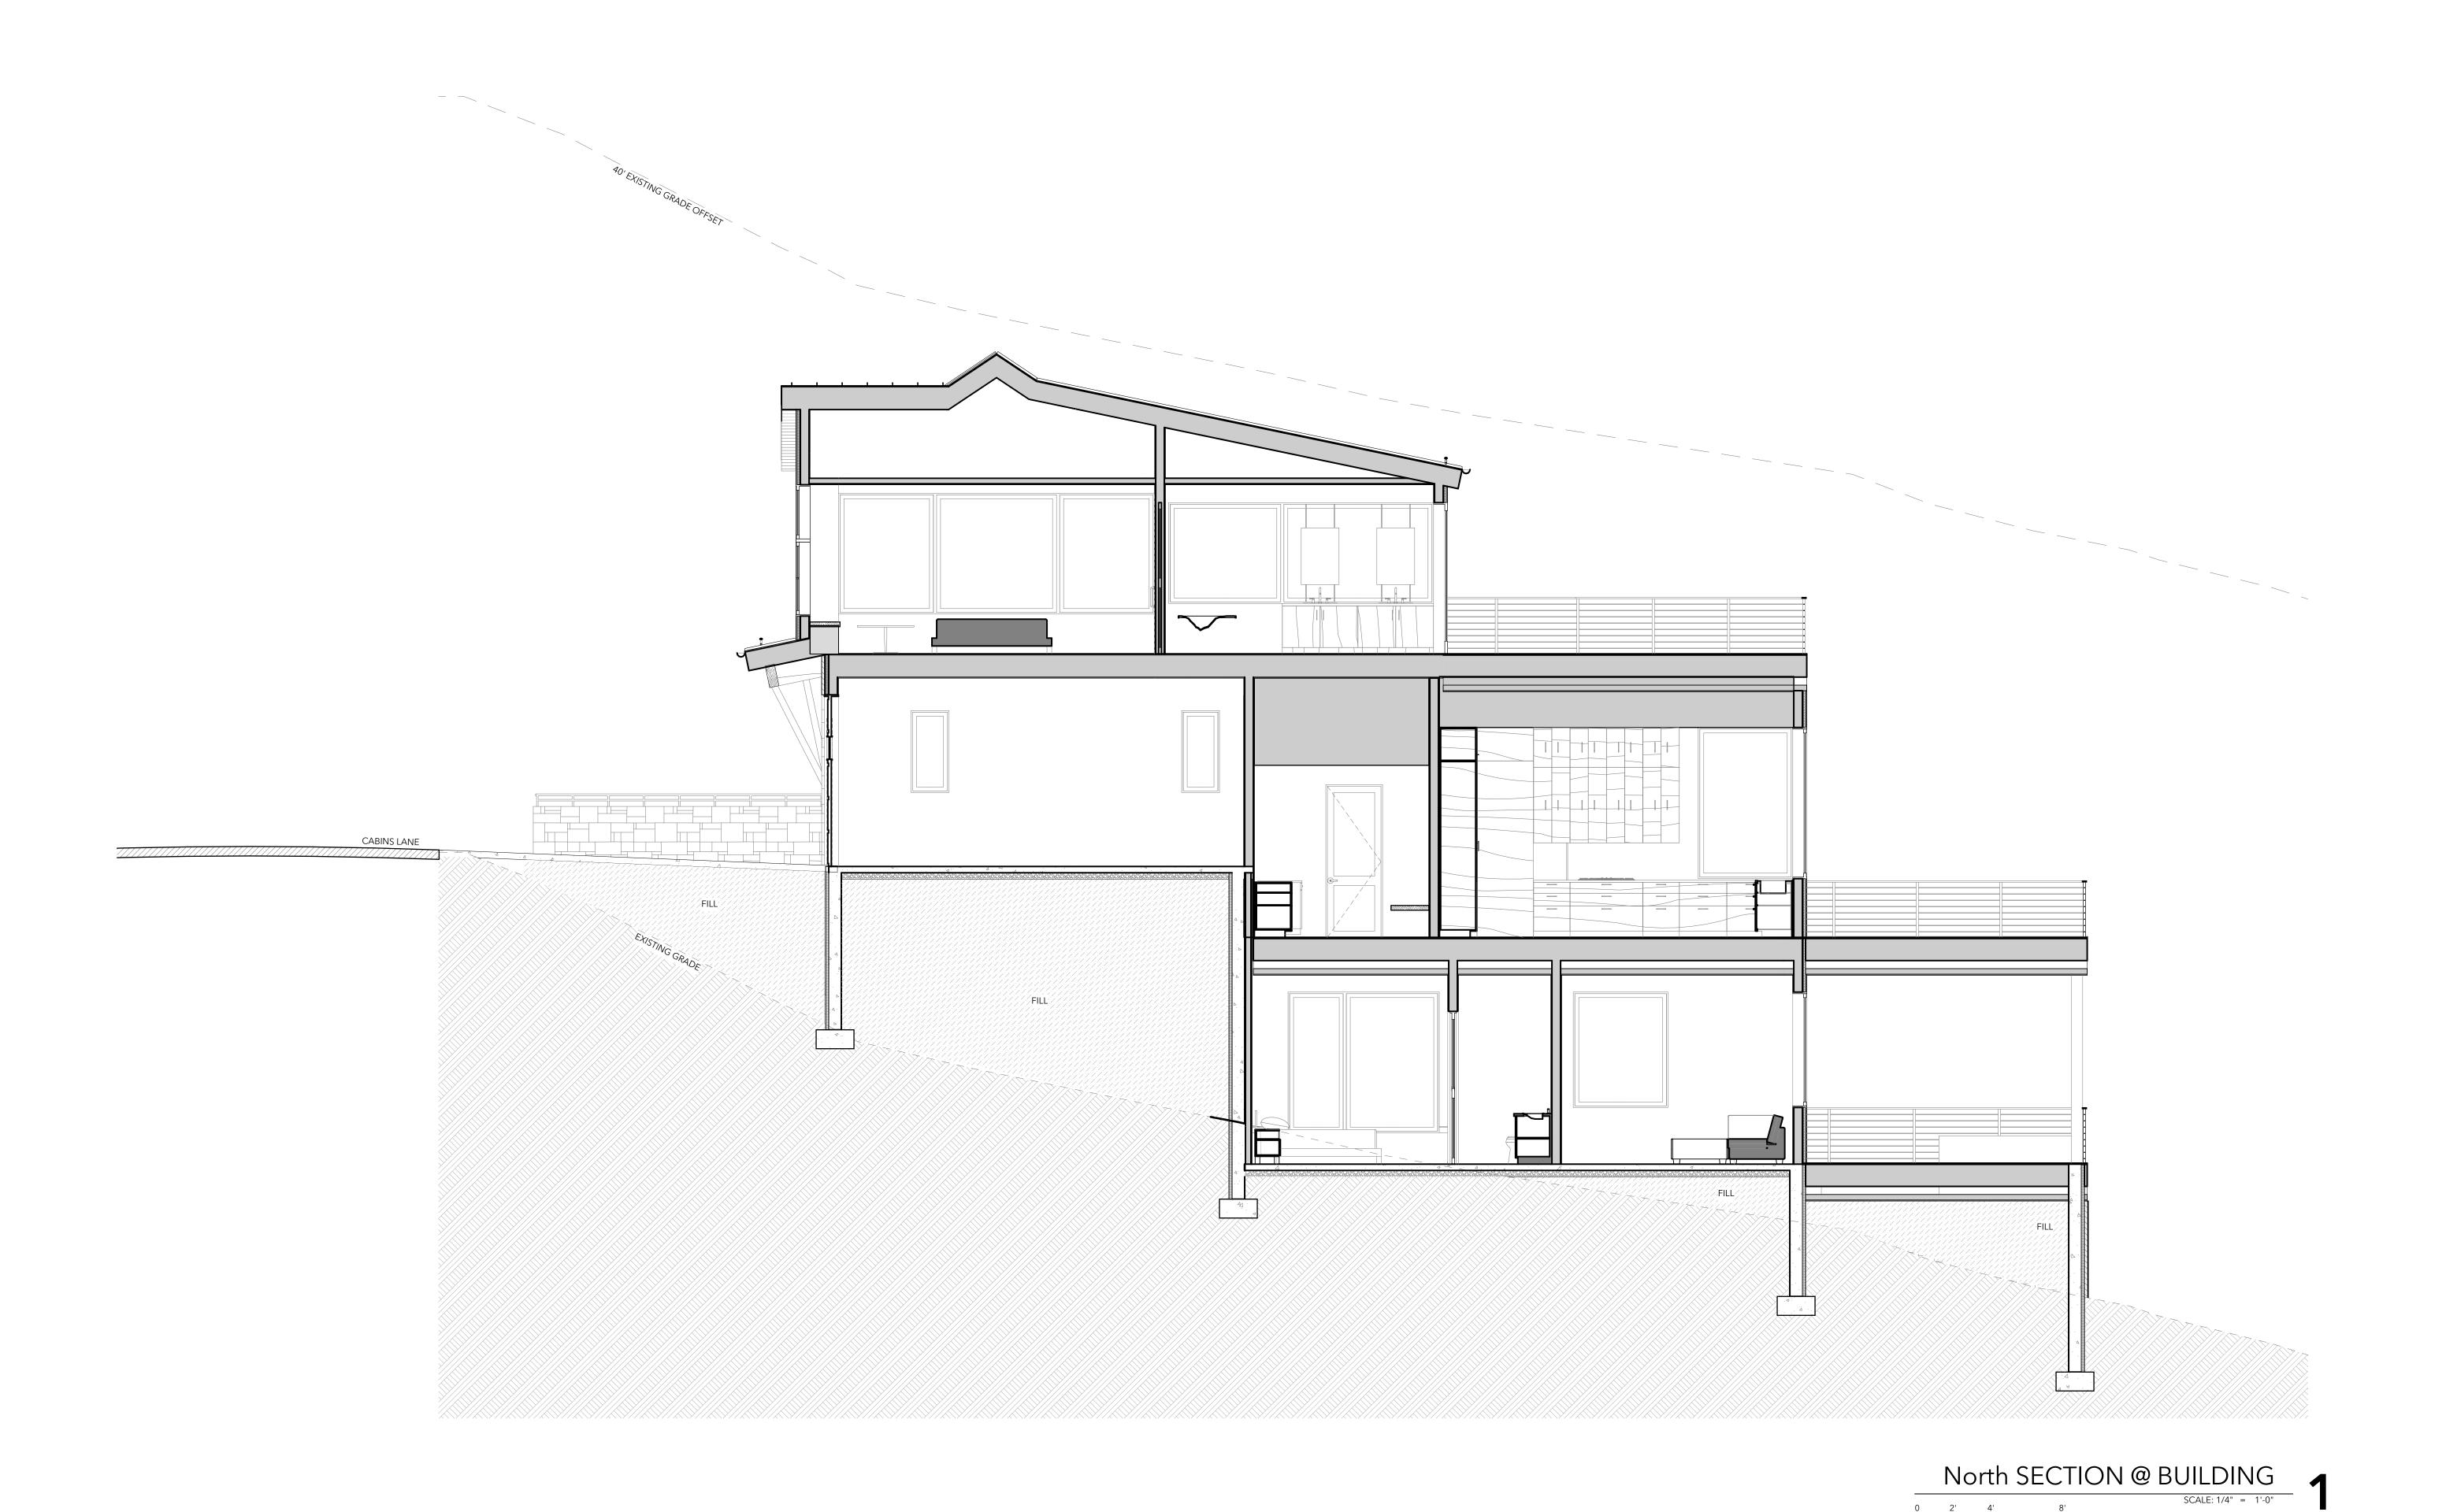
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SHEET TITLE

BUILDING SECTIONS



DOOR SCHEDU	l F
DOOK SCHEDU	ᄕ

ID	ED001	ED004	ED005	ED101	ED101	ED107	ED201	ED202	GD102	ID001	ID002	ID003	ID005	ID006	ID007A	ID007B	ID008	ID102	ID103	ID104	ID201	ID202	ID203
QTY	1	1	1	1	1	1	1	1	1	1	1	1	1	1	1	1	1	1	1	1	1	1	1
ELEV																					•		
WxH	3'-0"×9'-0 5/8"	3'-0"×9'-0 5/8"	6'-0"×9'-0 5/8"	12'-0"×10'-0"	4'-0"×9'-0"	3'-0"×9'-1 1/4"	3'-9"×8'-6"	6'-7 1/4"×8'-0"	16'-0"×9'-0"	3'-0"×8'-0"	2'-6"×8'-0"	3'-0"×8'-0"	3'-0"×8'-0"	2'-6"×8'-0"	2'-6"×8'-0"	2'-4"×8'-0"	3'-0"×8'-0"	2'-10"×8'-0"	2'-10"×8'-0"	2'-6"×8'-0"	2'-10"×8'-0"	4'-0"×8'-0"	2'-10"×8'-0
MAT.																							
TYPE																							
NOTES																							

DESIGNWORKS

ASPEN | BASALT | COLORADO
P:970.948.9510
KA-DESIGNWORKS.COM

WINDOW SCHEDULE

ID QTY	
ELEV	
W x H LEVEL TYPE NOTES	

001A 001B 002 003A 003B 004 005 006 007 101 102 103A 103B 104 105A 105B 1	105B 1	106
$3'-0.0"\times7'-5.3"$ $5'-0.0"\times7'-5.3"$ $5'-0.0"\times7'-5.3"$ $5'-0.0"\times6'-1.3"$	3'-0.0"×6'-0.0"	3'-0.0"×2'-0.0"
LOWER LEVEL MAIN LEVEL MA	MAIN LEVEL	MAIN LEVEL
W Fixed 27 W Fixed	W Fixed 27	W Fixed 27

WINDOW SCHEDULE

QTY	
ELEV	


 $W \times H$

LEVEL

TYPE

NOTES

ID

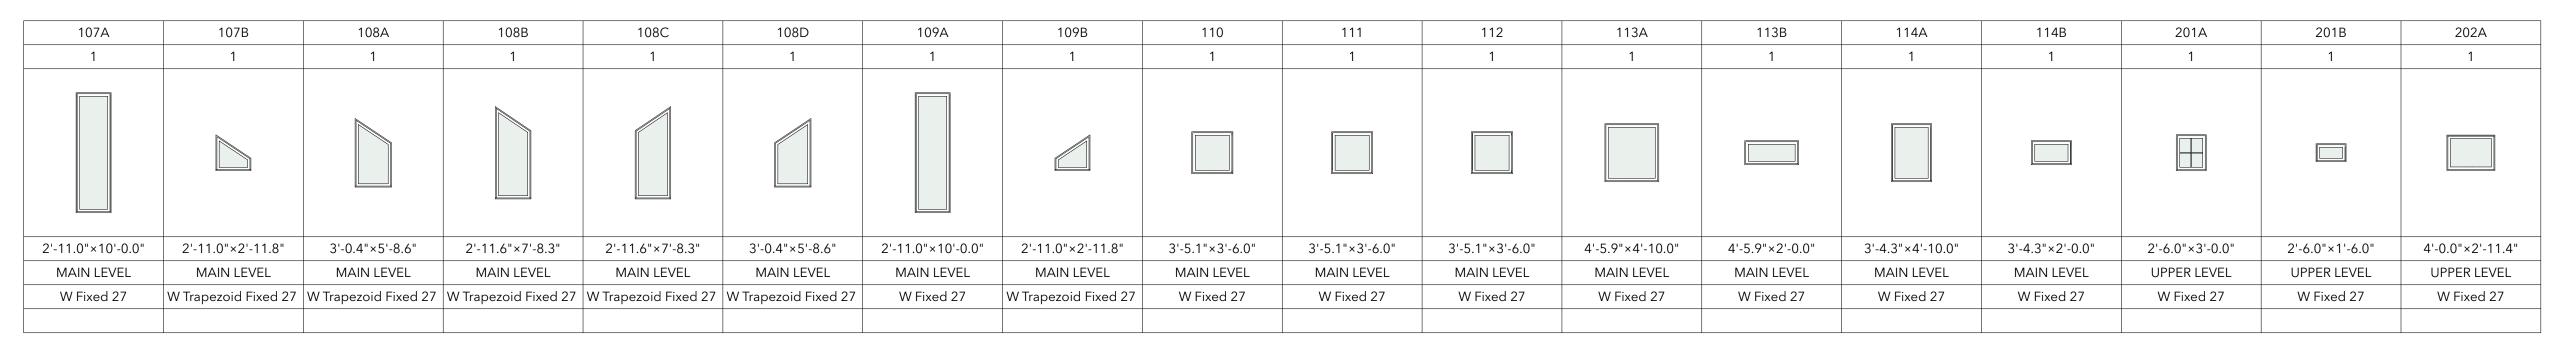

WINDOW SCHEDULE

ID QTY	
ELEV	

W x H LEVEL

TYPE NOTES

202B	203A	203B	204A	204B	204C	205A	205B	206	207	208	209	210	2000
1	1	1	1	1	1	1	1	1	1	1	1	1	1
4'-0.0"×4'-0.0"	2'-6.0"×3'-0.0"	2'-6.0"×1'-6.0"	5'-1.3"×6'-4.8"	6'-6.1"×6'-4.8"	5'-1.3"×6'-4.8"	6'-0.1"×5'-4.0"	8'-0.0"×5'-4.0"	1'-11.5"×5'-4.0"	2'-0.0"×4'-10.8"	4'-5.9"×3'-4.3"	3'-4.3"×3'-4.3"	8'-0.0"×3'-11.4"	3'-4.3"×3'-4.3"
UPPER LEVEL	UPPER LEVEL	UPPER LEVEL	UPPER LEVEL	UPPER LEVEL	UPPER LEVEL								
W Fixed 27	W Fixed 27	W Fixed 27	W Fixed 27	W Trapezoid Fixed 27	W Fixed 27								

DOOR & WINDOW NOTES

1) SEE PLAN & ELEVATIONS FOR DOOR/ WINDOW UNIT OPERATION & SWINGS

2) ALL NEW GLAZING TO BE LOW E- GLASS. MINIMUM INSULATION VALUE OF <u>U=.30 PER 2021 IECC REQUIREMENTS FOR CLIMATE ZONE 6B.</u>
(OR AS SPECIFIED IN HERS ENERGY REPORT)


3) SAFETY GLAZING TO BE INSTALLED PER IRC R308.4. SEE ELEVATIONS FOR SAFETY GLAZING (SG) LOCATIONS.

4) WINDOW MANUFACTURER TO PROVIDE SCREENS FOR ALL OPERABLE WINDOWS. DOOR MANUFACTURER TO PROVIDED SCREENS FOR ALL PROVIDED EXTERIOR DOORS.

5) WINDOW/ DOOR MULLIONS PER ELEVATIONS/ SCHEDULE.

6) ALUMINUM CLAD DOOR & WINDOW UNITS FINISH COLOR TO BE <u>DARK BRONZE</u>. **VERIFY**

7) ARCHITECTURAL INTENT ONLY. DIMENSIONS TO BE VERIFIED WITH DETAILS. SAFETY GLAZING AND OPERATIONAL LIMITERS TO BE REVIEWED. ALL INSULATED AND SOLAR HEAT GAIN RATINGS TO BE COORDINATED WITH ENERGY CODE AND VERIFIED FOR COMPLIANCE.

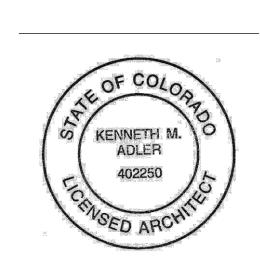

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DOOR & WINDOW SCHEDULE